	SHEET INDEX
NO	DESCRIPTION
1	TITLE SHEET
2	STORM DRAIN PROFILE AND PLAN AND PROFILE OF NATURE'S ROAD
3	GRADING AND SEDIMENT CONTROL PLAN, DRAINAGE AREA MAP AND STRUCTURE SCHEDULE
4	DETAIL SHEET

# ROADWAYS AND STORM DRAINS SMOWDEN RIDGE SECTION 1 6th ELECTION DISTRICT HOWARD COUNTY, MARYLAND

- F HOWARD COUNTY PLUS MSHA STANDARDS AND SPECIFICATIONS, IF APPLICABLE
- 2. APPROXIMATE LOCATION OF EXISTING UTILITIES ARE SHOWN. THE CONTRACTOR SHALL TAKE ALL NECCESSARY PRECAUTIONS TO PROTECT THE EXISTING UTILITIES AND MAINTAIN UNINTERRUPTED SERVICE. ANY DAMAGE INCURRED DUE TO CONTRACTOR'S OPERATION SHALL BE REPAIRED. IMMEDIATELY AT THE CONTRACTOR'S EXPENSE. EXISTING UTILITIES ARE SHOWN BASED ON THE BEST
- 3. THE CONTRACTOR SHALL TEST PIT EXISTING UTILITIES AT LEAST (5) DAYS BEFORE STARTING WORK SHOWN ON THESE DRAWINGS.
- 4. THE CONTRACTOR SHALL NOTIFY THE DEPARTMENT OF PUBLIC WORKS/CONSTRUCTION INSPECTION DIVISION AT (410) 313-1880 AT LEAST FIVE (5) WORKING DAYS PRIOR TO THE START OF WORK.
- 5. THE CONTRACTOR SHALL NOTIFY "MISS UTILITY" AT 1-800-257-7777 AY LEAST 48 HOURS PRIOR


- 6. TRAFFIC CONTROL DEVICES, MARKINGS, AND SIGNING SHALL BE IN ACCORDANCE WITH THE LATEST EDITION OF THE MANUAL ON UNIFORM TRAFFIC CONTROL DEVICES (MUTCD). ALL STREET AND REGULATORY SIGNS SHALL BE IN PLACE PRIOR TO THE PLACEMENT OF ANY ASPHALT.
- 6. ALL STREET CURB RETURNS SHALL HAVE 25' RADII UNLESS OTHERWISE NOTED.
- 7. STORM DRAIN TRENCHES WITHIN ROAD RIGHT OF WAY SHALL BE BACKFILLED AND COMPACTED IN ACCORDANCE WITH THE HOWARD COUNTY DESIGN MANUAL, VOLUME IV. I.O., STANDARD SPECIFICATIONS AND DETAILS FOR CONSTRUCTION, LATEST AMENDMENTS.
- 9. PIPE SHALL NOT BE INSTALLED BY THE CONTRACTOR UNTIL THE LENGTH CALLED FOR AT EACH STATION HAS BEEN APPROVED BY THE ENGINEER IN THE FIELD.
- 10. DESIGNED TRAFFIC SPEED IN ACCORDANCE WITH THE AMERICAN ASSOCIATION OF STATE HIGHWAY OFFICIAL STANDARD: ALL 50' RIGHT OF WAYS
- 11. ALL ELEVATIONS SHOWN ARE BASED ON THE U.S.C. AND G.S. MEAN SEA LEVEL DATUM,
- 12. ALL FILL AREAS WITHIN ROADWAY AND UNDER STRUCTURES TO BE COMPACTED TO A MINIMUM OF 95% COMPACTION OF AASHTO TIBO.
- 13. ALL PIPE ELEVATIONS SHOWN ARE INVERT CHEVATIONS.
- 14. PROFILES STATIONS SHALL BE ADJUSTED AS NECESSARY TO CONFORM TO PLAN 15. SUBJECT PROPERTY ZONED R-A-15 PER 10-18-93 COMPREHENSIVE ZONING PLAN.
- 16. NO PIPE SHALL BE LAID UNTIL LINES OF EXCAVATION HAVE BEEN BROUGHT WITHIN 6" OF FINISHED GRADE.
- 17. ALL STORM DRAIN PIPE BEDDING SHALL BE CLASS 'C' AS SHOWN IN FIG. 11.4, VOLUME 1 OF HOWARD COUNTY DESIGN MANUAL UNLESS OTHERWISE NOTED.
- 19. LIGHT POLES, ARMS AND FIXTURES FOR STREET LIGHTS SHALL BE IN ACCORDANCE WITH HOWARD COUNTY DESIGN MANUAL, VOLUME III AND GUIDELINES FOR STREET LIGHTS IN RESIDENTIAL DEVELOPMENTS, JUNE 1993.


18. SEE DEPARTMENT OF PLANNING AND ZONING FILE NO'S. SP-95-01, SP-95-09,

21. LANDSCAPING WILL BE PROVIDED IN ACCORDANCE WITH THE NEW TOWN ALTERNATIVE COMPLIANCE AND WILL BE CONSTRUCTED AND BONDED WITH THE SITE DEVELOPMENT PLANS.

20. STORMWATER QUANTITY AND QUALITY FOR THIS DEVELOPMENT IS PROVIDED UNDER F-92-1001.

- 22. TOPOGRAPHY SHOWN HEREON IS FROM MASS GRADING PLANS SDP-95-88 BY
- 23. PUBLIC WATER AND SEWER SYSTEMS AS PER CONTRACT NO. 34-3458-D ARE TO BE UTILIZED FOR THIS SITE. SEWER SERVICE DRAINAGE AREA: MIDDLE PATUXENT.
- 24. THERE IS NO 100 YEAR FLOODPLAIN ON-SITE. 25. THIS DEVELOPMENT DOES NOT HAVE ANY NON-TIDAL WETLANDS ON SITE.
- 28. ALL STREET LIGHTS SHALL BE LOCATED BETWEEN 2'-0" AND 4'-0" BEHIND FACE OF CURB.
- 27. THE COORDINATES SHOWN HEREON ARE BASE ON NAD 27, MARYLAND COORDINATE SYSTEM AS PROJECTED BY HOWARD COUNTY MONUMENT NO. 2337001, 2337002 AND 2437003.
- 28. CONTRACTOR IS SOLELY RESPONSIBLE FOR CONSTRUCTION MEANS, METHODS, TECHNIQUES, SEQUENCES, PROCEDURES, AND SAFETY PRECAUTIONS AND PROGRAMS.
- 29. A WAIVER HAS BEEN APPROVED DATED JULY 31, 1995 TO REDUCE MINIMUM ROAD RADII AND CUL-DE-SAC DESIGN STANDARDS ESTABLISHED IN TABLE 2.01.
- 30. HOME OWNERS ASSOCIATION WILL BE RESPONSIBLE FOR MAINTENANCE OF OFF-STREET
- 31. A WINIMUM SPACING OF 20' SHALL BE MAINTAINED BETWEEN ANY STREET UGHT AND ANY TREE.

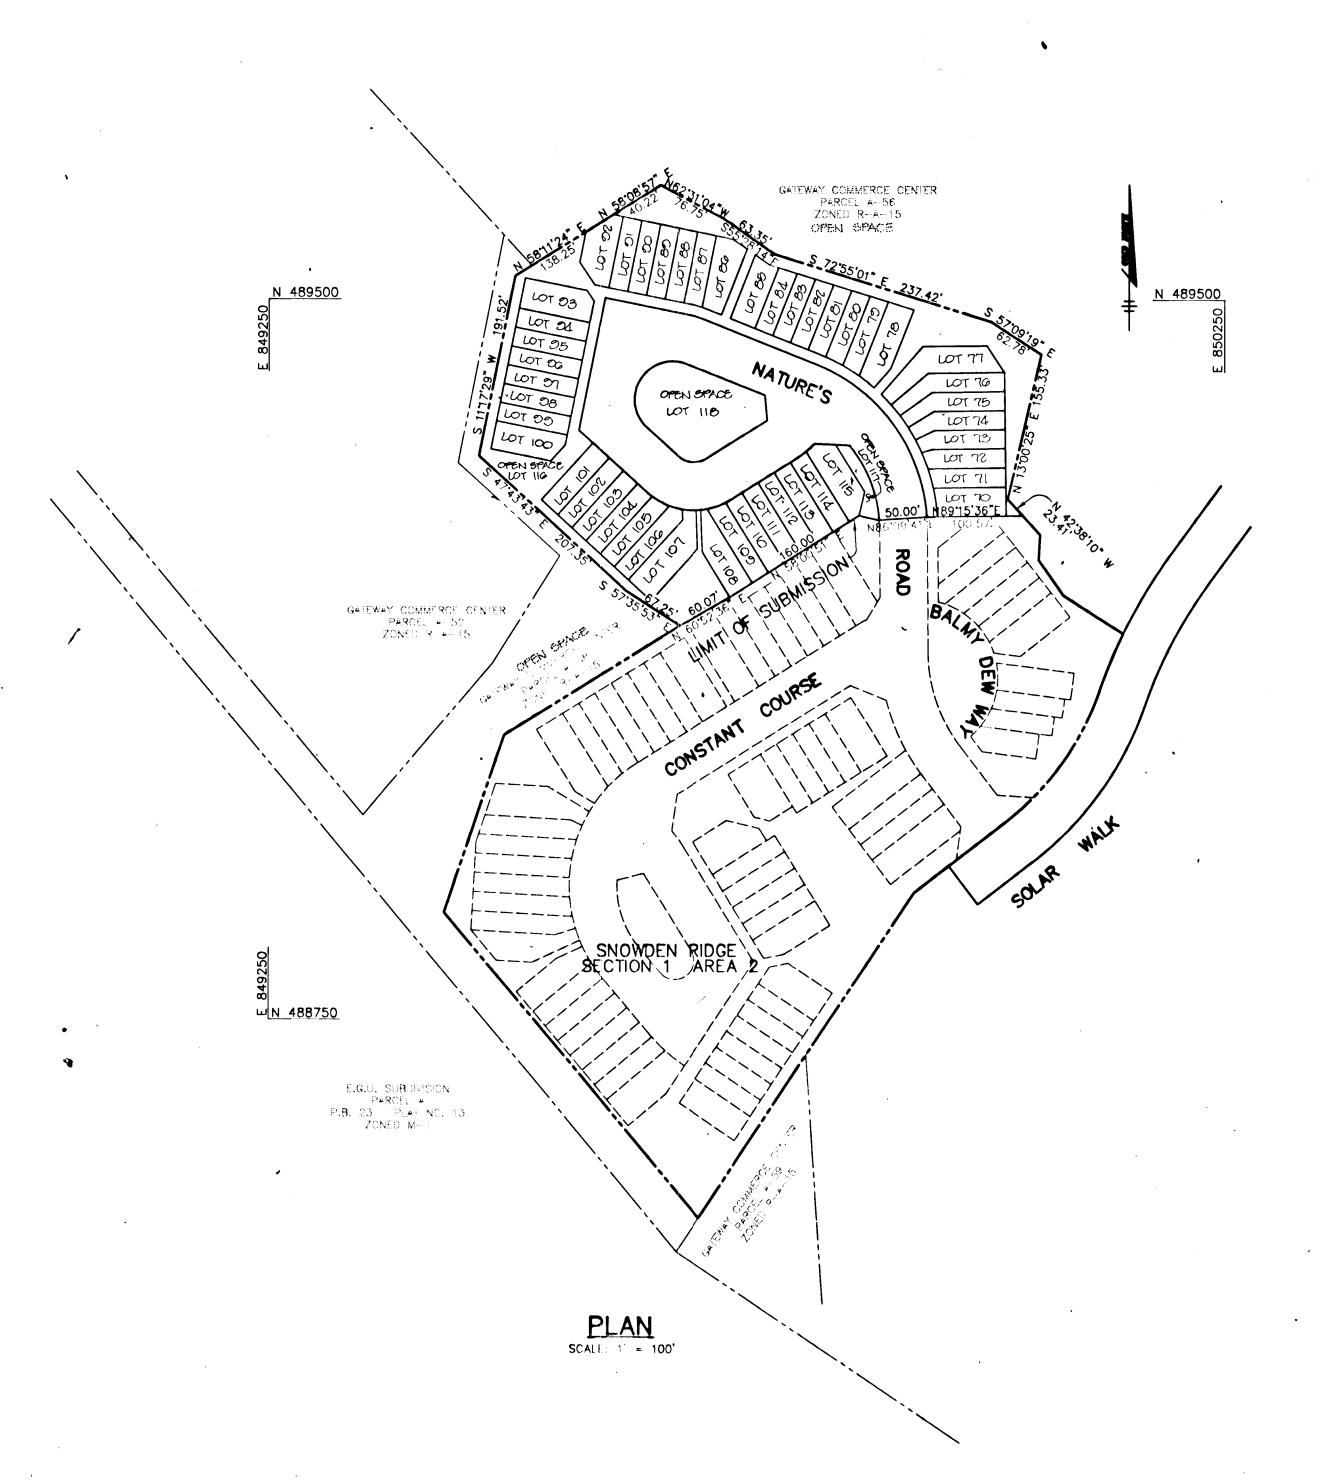

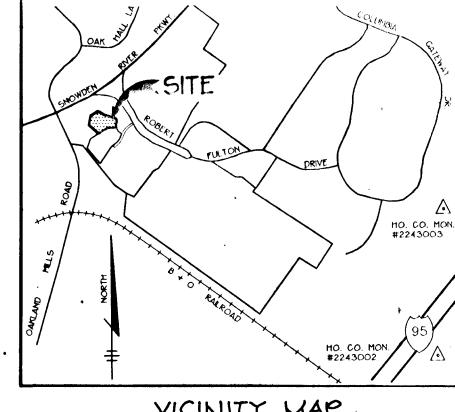

VICINITY MAP

**BENCHMARKS** 

BM#1 X-CUT IN CONCRETE BASE OF

NAIL IN BG&E POLE ELEV. 387.97

AS BUILT CERTIFICATE

APPROVED: HOWARD COUNTY DEPARTMENT OF PUBLIC

CHIEF, BUREAU OF HIGHWAYS HS

APPROVED: HOWARD COUNTY DEPARTMENT OF PLANNING AND ZONING.

GMA JUMMANION OF LAND DEVELOPMENT AND RESEARCH

CHIEF, DEVELOPMENT M.K. ENGINEERING DIVISION

REVISION

THE HOWARD RESEARCH AND DEVELOPMENT CORPORATION THE ROUSE BUILDING 10275 LITTLE PATUXENT PARKWAY

COLUMBIA, MARYLAND 21044

WESTBROOK DEVELOPMENT, INC. Court Towers Suite 300 210 West Pennsylvania Avenue Towson, Maryland 21204 (410) 823-4700 • Fax(410)823-5009 Attn: Brian Flick

DATE NO.

SNOWDEN RIDGE SECTION 1 AREA 2 LOTS 70 - 118

AREA GATEWAY COMMERCE CENTER - PARCEL 'A-53' TAX MAP NO. 42 ZONED R-A-15 6th ELECTION DISTRICT HOWARD COUNTY, MARYLAND

TITLE SHEET

Planners • Engineers • Surveyors 8818 Centre Park Drive • Suite 200 • Columbia, Md 21045 410-997-8900 FAX: 410-997-9282


11.30.95


SDP-95-88 F-95-138 SP-95-88 SP-95-09 DESIGNED BY : C.J.R. DRAWN BY : DAM

PROJECT NO : HOCO\95H10600 PH2RD1.DWG DATE: NOVEMBER 30, 1995

SCALE : AS SHOWN DRAWING NO. \_ 1 OF \_4

F-96-27

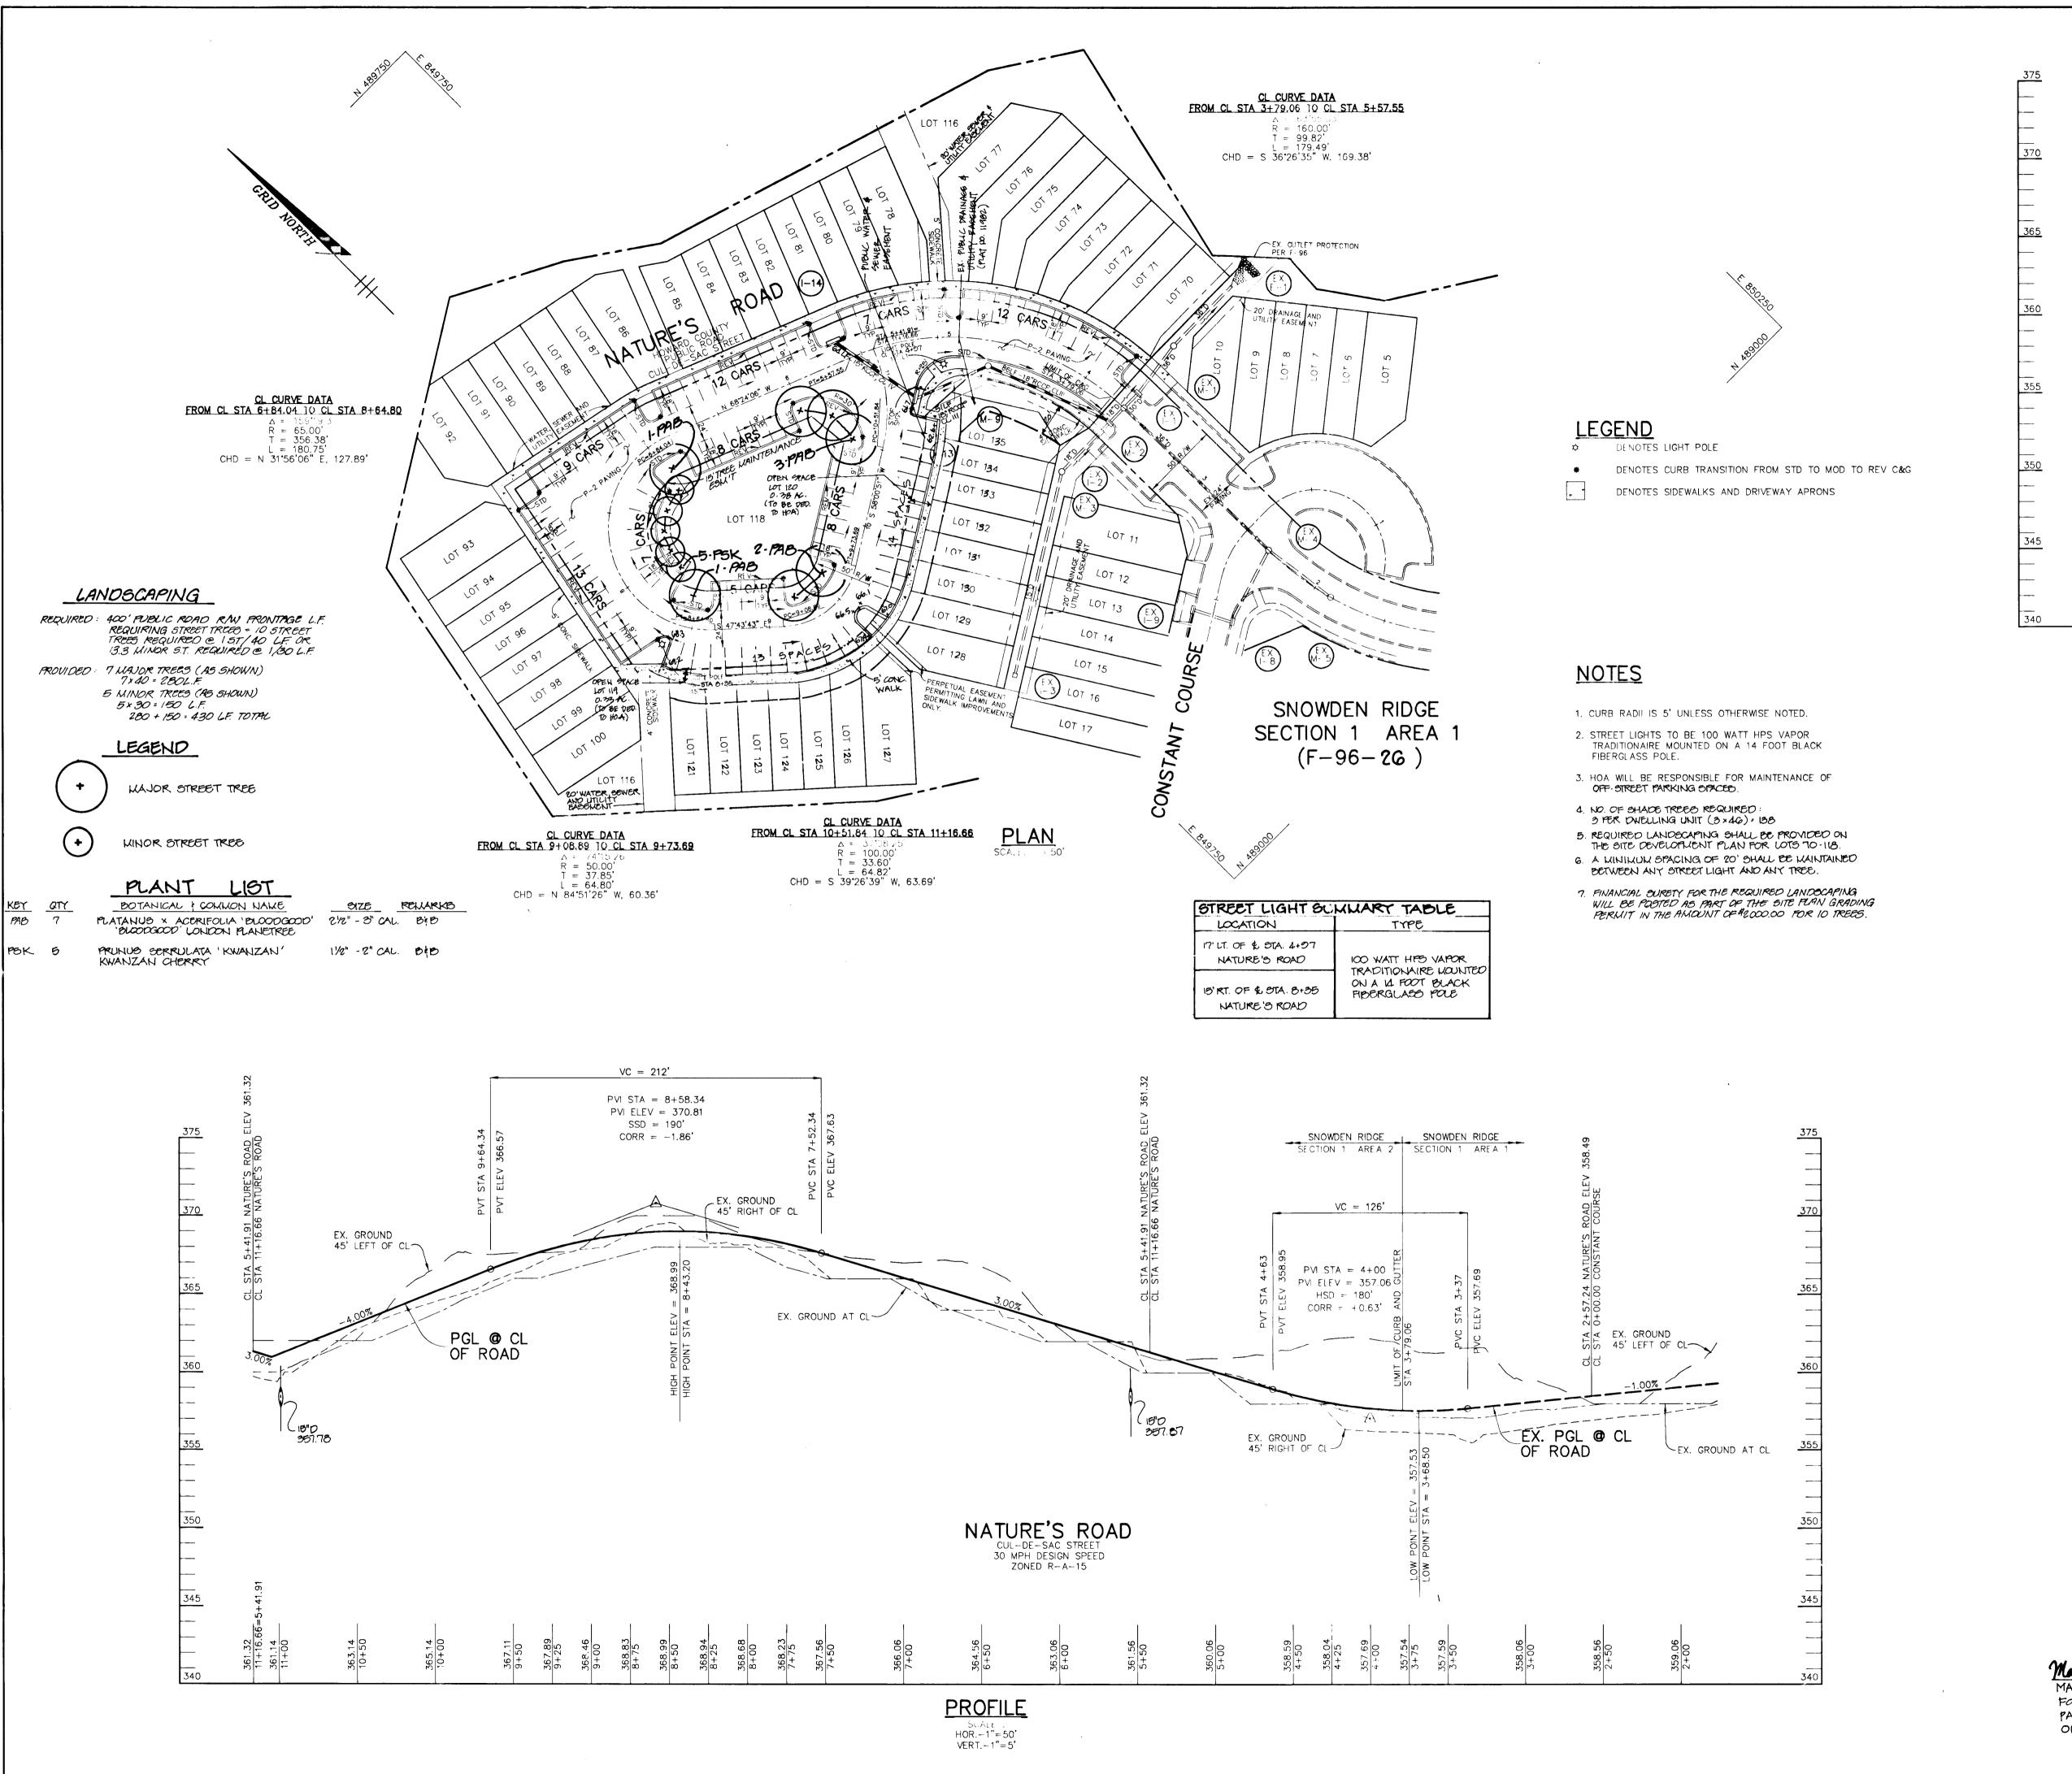

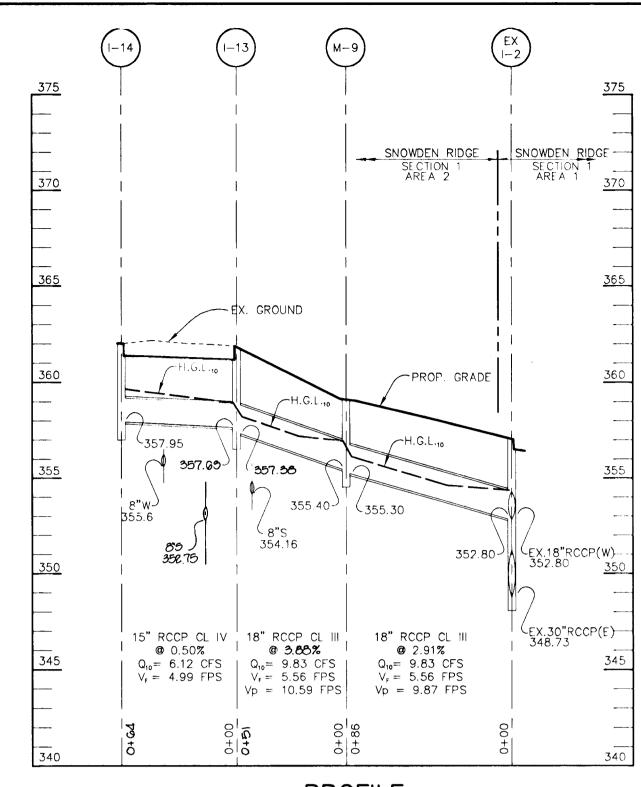

**PROFILE** SCALE: HOR.-1"=50' VERT.-1"=5'

> AS BUILT CERTIFICATE DATE APPROVED : HOWARD COUNTY DEPARTMENT OF PUBLIC CHIEF, BUREAU OF HIGHWAYS HS 12-22-95 APPROVED : HOWARD COUNTY DEPARTMENT OF PLANNING AND ZONING. Ama Svunnanji O CHIEF, DIVISION OF LAND DEVELOPMENT AND RESEARCH CHIEF, DEVELOPMENT M.K. 12/29/95 ENGINÉERING DIVISION REVISION TO LOTE # 121 TO #135 (PREVIOUSLY LOTS # 101-115) DATE NO. REVISION THE HOWARD RESEARCH AND DEVELOPMENT CORPORATION THE ROUSE BUILDING 10275 LITTLE PATUXENT PARKWAY COLUMBIA, MARYLAND 21044 WESTBROK
>
> DEVELOPMENT, INC.
>
> Court Towers Suite 300
>
> 210 West Pennsylvania Avenue
>
> Towson, Maryland 21204
>
> (410) 823-4700 • Fax(410)823-5009
>
> Attn: Brian Flick SNOWDEN RIDGE PROJECT SECTION 1 AREA 2 LOTS 70 - 100, 121-135, 116-120 AREA GATEWAY COMMERCE CENTER -- PARCEL 'A-53' TAX MAP NO. 42 ZONED  $R-\Lambda-15$ 6th ELECTION DISTRICT HOWARD COUNTY, MARYLAND PLAN AND PROFILE OF NATURE'S ROAD

8818 Centre Park Drive • Suite 200 • Columbia, Md 21045 MAX KANTZER # 16872 FOR REVISIONS TO
PARKING AT LOTS 121-135 ONLY.

10.13.97

11.30.95

410-997-8900

PROJECT NO : HOCO\95H10600 PH2RD2.DWG DATE: NOVELIBER 30, 1905 SCALE : AS SHOWN DRAWING NO. 2 OF 4

RIEMER MUEGGE & ASSOCIATES, INC.


Planners • Engineers • Surveyors

FAX: 410-997-9282

DESIGNED BY : C.J.R.

DRAWN BY : DAM

SDP--95- 88 F 95-138 SP- 95- 88 P- 95--09

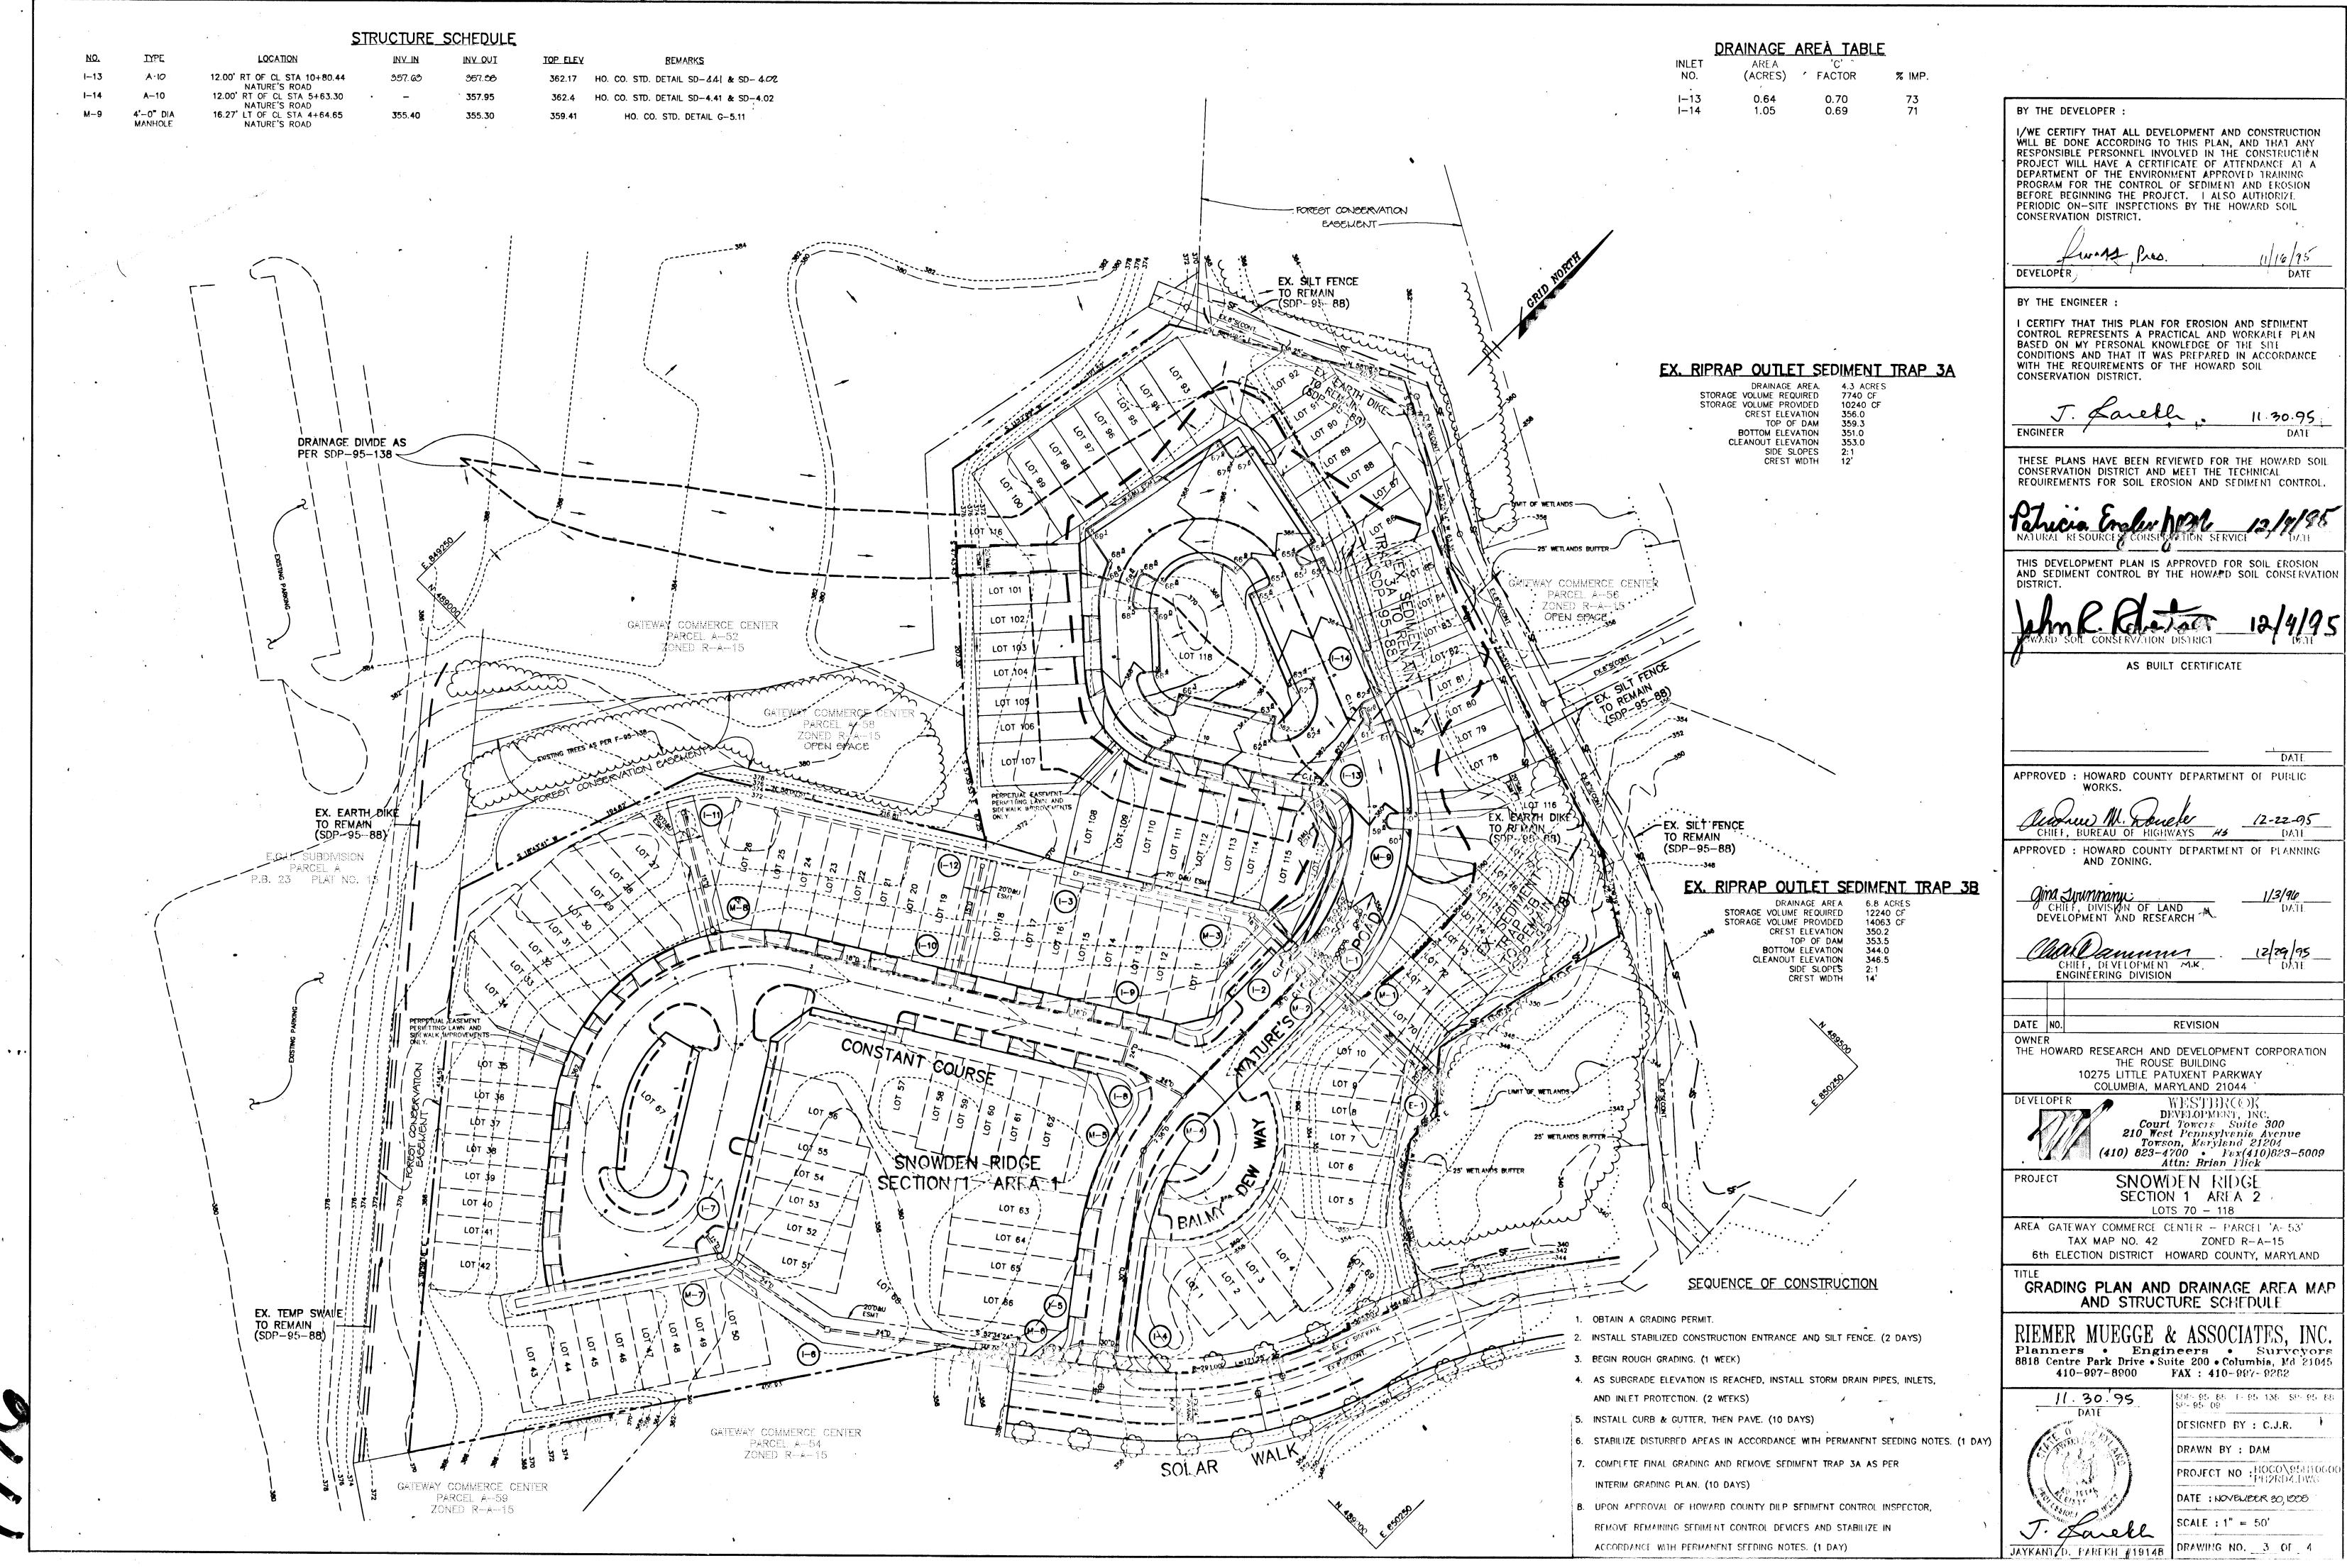

#### TEMPORARY SEEDING NOTES

Apply to graded or cleared areas likely to be redisturbed where a short-term vegetative cover is needed.

<u>Seedbed Preparation: Loosen upper three inches of soil by raking.</u> discing or other acceptable means before seeding, if not previously

Soil Amendments: Apply 600 lbs. per acre 10-10-10 fertilizer (14

Seeding: For periods March 1 thru April 30 and from August 15 thru November 15, seed with 2-1/2 bushels per acre of annual rye (3.2 lbs. per 1000 sq.ft.). For the period May 1 thru August 14, seed with 3 lbs. per acre of weeping lovegrass (0.07 lbs. per 1000 sq.ft.). For the period November 16 thru February 28, protect site by applying 2 tons per acre of well anchored straw mulch and seed as soon as possible in the spring, or use sod.

Mulching: Apply 1-1/2 to 2 tons per acre (70 to 90 lbs. per 1000 sq.ft.) of unrotted small grain straw immediately after seeding. Anchor mulch immediately after application using mulch anchoring tool or 218 gal. per acre (5 gal. per 1000 sq.ft.) of emulsified asphalt on flat areas. On slopes, 8 ft. or higher, use 347 gal. per acre (8 gal. per 1000 sq.ft.) for anchoring.

Refer to the 1983 MARYLAND STANDARDS AND SPECIFICATIONS FOR SOIL EROSION AND SEDIMENT CONTROL for rate and methods not covered.

#### PERMANENT SEEDING NOTES

Apply to graded or cleared areas not subject to immediate further disturbance where a permanent long-lived vegetative cover is needed.

Seedbed Preparation: Loosen upper three inches of soil by raking. discing or other acceptable means before seeding, if not previously

Soil Amendments: In lieu of soil test recommendations, use one of the following schedules

- 1) Preferred Apply 2 tons per acre dolomitic limestone (92 lbs. per 1000 sq.ft.) and 600 lbs. per acre 10-10-10 fertilizer (14 lbs. per 1000 sq.ft.) before seeding. Harrow or disc into upper three inches of soil. At time of seeding, apply 400 lbs. per acre 30-0-0 ureaform fertilizer (9 lbs. per 1000 sq.ft.).
- 2) Acceptable Apply 2 tons per acre dolomitic limestone (92 lbs. per 1000 sq.ft.) and 1000 lbs. per acre 10-10-10 fertilizer (23 lbs. per 1000 sq.ft.) before seeding. Harrow or disc into upper three inches of soil.

Seeding: For the period March 1 thru April 30 and from August 1 thru October 15, seed with 60 lbs. per acre (1.4 lbs. per 1000 sq.ft.) of Kentucky 31 Tall Fescue. For the period May 1 thru July 31, seed with 60 lbs. Kentucky 31 Tall Fescue per acre and 2 lbs. per acre (0.05 lbs. per 1000 sq.ft.) of weeping lovegrass. During the period October 16 thru February 28, protect site by one of the following

- 1) 2 tons per acre of well—anchored mulch straw and seed as soon as possible in the spring.
- 3) Seed with 60 lbs. per acre Kentucky 31 Tall Fescue and mulch with 2 tons per acre well anchored straw.

Mulching: Apply 1-1/2 to 2 tons per acre (70 to 90 lbs. per 1000 sq.ft.) of unrotted small grain straw immediately after seeding. Anchor mulch immediately after application using mulch anchoring tool or 218 gal. per acre (5 gal. per 1000 sq.ft.) of emulsified asphalt on flat areas. On slopes, 8 ft. or higher, use 347 gal. per acre (8 gal. per 1000 sq. (t.) for anchoring.

Maintenance: Inspect all seeded areas and make needed repairs, replacements and reseedings.

. A MINIMUM OF 48 HOURS NOTICE MUST BE GIVEN TO THE HOWARD COUNTY DEPARTMENT OF INSPECTIONS AND PERMITS PRIOR TO THE START OF ANY CONSTRUCTION (313-1855).

2. ALL VEGETATIVE AND STRUCTURAL PRACTICES ARE TO BE INSTALLED ACCORDING TO THE PROVISIONS OF THIS PLAN AND ARE TO BE IN CONFORMANCE WITH THE MARYLAND STANDARDS AND SPECIFICATIONS FOR SOIL AND EROSION CONTROL,

3. FOLLOWING INITIAL SOIL DISTURBANCE OR REDISTURBANCE, PERMANENT OR TEMPORARY STABILIZATION SHALL BE COMPLETED WITHIN: A)7 CALENDAR DAYS FOR ALL PERIMETER SEDIMENT CONTROL STRUCTURES, DIKES, PERIMETER SLOPES AND ALL SLOPES AND ALL SLOPES GREATER THAN 3:1, B) 14 DAYS AS TO OTHER DISTURBED OR GRADED AREAS ON THE PROJECT SITE

4. ALL SEDIMENT TRAPS/BASINS SHOWN MUST BE FENCED AND WARNING SIGNS POSTED AROUND THE PERIMETER IN ACCORDANCE WITH VOL. 1, CHAPTER 12, OF THE HOWARD COUNTY DESIGN MANUAL, STORM DRAINAGE.

5. ALL DISTURBED AREAS MUST BE STABILIZED WITHIN THE TIME PERIOD SPECIFIED ABOVE IN ACCORDANCE WITH THE 1991 MARYLAND STANDARDS AND SPECIFICATIONS FOR SOIL AND EROSION CONTROL FOR PERMANENT SEEDINGS (SEC. 51), SOD (SEC. 54), TEMPORARY SEEDING (SEC. 50) AND MULCHING (SEC. 52). TEMPORARY STABILIZATION WITH MULCH ALONG CAN ONLY BE DONE WHEN RECOMMENDED SEEDING DATES DO NOT ALLOW FOR PROPER GERMINATION AND ESTABLISHMENT OF GRASSES.

6. ALL SEDIMENT CONTROL STRUCTURES ARE TO REMAIN IN PLACE AND ARE TO BE MAINTAINED IN OPERATIVE CONDITION UNTIL PERMISSION FOR THEIR REMOVAL HAS BEEN OBTAINED FROM THE HOWARD COUNTY SEDIMENT CONTROL INSPECTOR 7. SITE ANALYSIS:

TOTAL AREA OF SITE AREA DISTURBED AREA TO BE ROOFED OR PAVED AREA TO BE VEGETATIVELY STABILIZED

0.76 ACRES 0.95 ACRES

TOTAL FILL E ANY SEDIMENT CONTROL PRACTICE WHICH IS DISTURBED BY GRADING ACTIVITY FOR PLACEMENT OF UTILITIES MUST BE REPAIRED ON THE SAME DAY OF

9 ADDITIONAL SEDIMENT CONTROLS MUST BE PROVIDED, IF DEEMED NECESSARY BY THE HOWARD COUNTY SEDIMENT CONTROL INSPECTOR.


. SITE GRADING WILL BEGIN ONLY AFTER ALL PERIMETER SEDIMENT CONTROL MEASURES HAVE BEEN INSTALLED AND ARE IN A FUNCTIONING CONDITION.

SEDIMENT WILL BE REMOVED FROM TRAPS WHEN ITS DEPTH REACHES CLEAN OUT ELEVATION SHOWN ON THE PLANS.

2. CUT AND FILL QUANTITIES PROVIDED UNDER SITE ANALYSIS DO NOT REPRESENT BID QUANTITIES. THESE QUANTITIES DO NOT DISTINGUISH BETWEEN TOPSOIL, STRUCTURAL FILL OR EMBANKMENT MATERIAL, NOR DO THEY REFLECT CONSIDERATION OF UNDERCUTTING OR REMOVAL OF UNSUITABLE MATERIAL. THE CONTRACTOR SHALL FAMILIARIZE HIMSELF WITH SITE CONDITIONS WHICH MAY AFFECT THE WORK.

3. ON ALL SITES WITH DISTURBED AREAS IN EXCESS OF 2 AC., APPROVAL OF THE INSPECTION AGENCY SHALL BE REQUESTED UPON COMPLETION OF INSTALLATION OF PERIMETER EROSION AND SEDIMENT CONTROLS, BUT BEFORE PROCEEDING WITH ANY OTHER EARTH DISTURBANCE OR GRADING. OTHER BUILDING OR GRADING INSPECTION APPROVALS MAY NOT BE AUTHORIZED UNTIL THIS INITIAL APPROVAL BY THE INSPECTION AGENCY IS MADE.

. TRENCHES FOR THE CONSTRUCTION OF UTILITIES IS LIMITED TO THREE PIPE LENGTHS OR THAT WHICH CAN BE BACKFILLED AND STABILIZED WITHIN ONE WORKING DAY, WHICHEVER IS SHORTER.

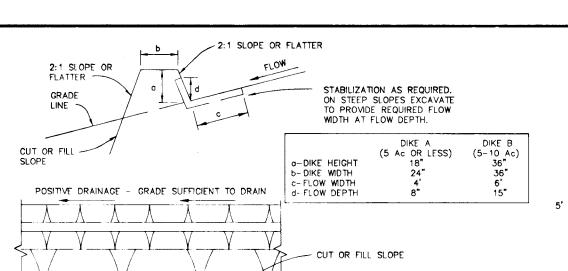


### CONSTRUCTION SPECIFICATIONS


- 1. ALL DIKES SHALL BE COMPACTED BY EARTH-MOVING EQUIPMENT. 2. ALL DIKES SHALL HAVE POSITIVE DRAINAGE TO AN OUTLET.
- 3. TOP WIDTH MAY BE WIDER AND SIDE SLOPES MAY BE FLATTER IF DESIRED TO
- 4. FIELD LOCATION SHOULD BE ADJUSTED AS NEEDED TO UTILIZE A STABILIZED SAFE
- 5 FARTH DIKES SHALL HAVE AN OUTLET THAT FUNCTIONS WITH A MINIMUM OF EROSION. RUNOFF SHALL BE CONVEYED TO A SEDIMENT TRAPPING DEVICE SUCH AS A SEDIMENT TRAP OR SEDIMENT BASIN WHERE EITHER THE DIKE CHANNEL OR THE DRAINAGE AREA ABOVE THE DIKE ARE NOT ADEQUATELY STABILIZED.

6. STABILIZATION SHALL BE: (A) IN ACCORDANCE WITH STANDARD SPECIFICATIONS FOR SEED AND STRAW MULCH OR STRAW MULCH IF NOT IN SEEDING SEASON, (B)

#### FLOW CHANNEL STABILIZATION TREATMENT GRADE SEED & STRAW MULCH SEED & STRAW MULCH SEED & STRAW MULCH 5.1-8.0% SEED WITH JUTE, OR LINED RIPRAP 4-8" 8.1-20% LINED RIPRAP 4-8" ENGINEERED DESIGN

- A. STONE TO BE 2 INCH STONE, OR RECYCLED CONCRETE EQUIVALENT, IN A LAYER AT LEAST 3 INCHES IN THICKNESS AND BE PRESSED INTO THE SOIL WITH CONSTRUCTION EQUIPMENT
- B. RIPRAP TO BE 4-8 INCHES IN A LAYER AT LEAST 8 INCHES THICKNESS AND PRESSED INTO THE SOIL
- C. APPROVED EQUIVALENTS CAN BE SUBSTITUTED FOR ANY OF THE ABOVE MATERIALS. 7. PERIODIC INSPECTION AND REQUIRED MAINTENANCE MUST BE PROVIDED AFTER EACH RAIN EVENT

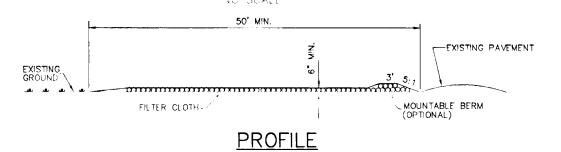

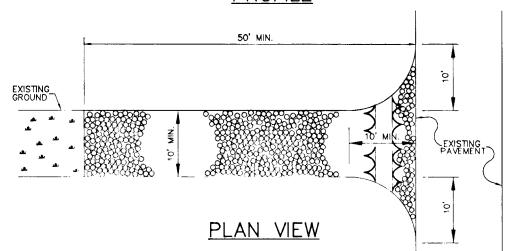

## CONSTRUCTION SPECIFICATIONS

- . STONE SIZE USE 2" STONE OR RECLAIMED OR RECYCLED CONCRETE EQUIVALENT. LENGTH AS REQUIRED, BUT NOT LESS THAN 50 FEET (EXCEPT ON A SINGLE RESIDENCE LOT WHERE A 30 FOOT MINIMUM WOULD APPLY). 3. THICKNESS - NOT LESS THAN SIX (6) INCHES.
  4. WIDTH - TEN (10) FOOT MINIMUM, BUT NOT LESS THAN THE FULL WIDTH AT POINTS WHERE INGRESS AND EGRESS OCCURS.

  5. FILTER CLOTH - WILL BE PLACED OVER THE ENTIRE AREA PRIOR TO PLACING OF STONE. FILTER CLOTH WILL NOT BE REQUIRED ON A SINGLE RESIDENCE LOT.

  6. SURFACE WATER — ALL SURFACE WATER FLOWING OR DIVERTED TOWARD CONSTRUCTION ENTRANCE SHALL BE PIPED ACROSS THE ENTRANCE. IF PIPING IS IMPRACTICAL, A MOUNTABLE BERM 5:1 SLOPES WILL BE PERMITTED. MAINTENANCE - THE ENTRANCE SHALL BE MAINTAINED IN A CONDITION WHICH WILL PREVENT TRACKING OR FLOWING OF SEDIMENT ONTO PUBLIC RIGHTS-OF-WAY THIS MAY REQUIRE PERIODIC TOP DRESSING WITH ADDITIONAL STONE AS
- CONDITIONS DEMAND AND REPAIR AND/OR CLEANOUT OF ANY MEASURES USED TO TRAP SEDIMENT. ALL SEDIMENT SPILLED, DROPPED, WASHED OR TRACKED ONTO PUBLIC RIGHTS-OF-WAY MUST BE REMOVED IMMEDIATELY.

  8. WASHING WHEELS SHALL BE CLEANED TO REMOVE SEDIMENT PRIOR TO ENTRANCE ONTO PUBLIC RIGHTS-OF-WAY. WHEN WASHING IS REQUIRED, IT SHALL BE DONE ON AN AREA STABILIZED WITH STONE AND WHICH DRAINS INTO AN APPROVED SEDIMENT TRAPPING DEVICE. 9. PERIODIC INSPECTION AND NEEDED MAINTENANCE SHALL BE PROVIDED AFTER

### STABILIZED CONSTRUCTION ENTRANCE

NO SCALE

- 6' MAX. SPACING OF

2"x4" SPACERS

# SANDBAG OR ALTERNATE WEIGHT 2' MIN. LENGTH OF 2"> OVER WIRE MESH TO PIPE

### CONSTRUCTION SPECIFICATIONS

2"x4" SPACER -

FILTER CLOS

WIRE MESH

- A. WOODEN FRAME IS TO BE CONSTRUCTED OF 2"x4" CONSTRUCTION GRADE LUMBER. B. WIRE MESH MUST BE OF SUFFICIENT STRENGTH TO SUPPORT FILTER FABRIC, AND STONE, WITH WATER FULLY IMPOUNDED AGAINST I
- C. FILTER CLOTH MUST BE OF A TYPE APPROVED FOR THIS PURPOSE; RESISTANT TO SUMLIGHT WITH A SERVE SIZE, EOS 40-85, TO ALLOW SUFFICIENT PASSAGE OF WATER AND REMOVAL OF SEDIMENT.
- D. STONE IS TO BE 2" IN SIZE AND CLEAN, SINCE FINES WOULD CLOG THE CLOTH. II. PROCEDURE (FOR CURB INLET PROTECTION)
- A. ATTACH A CONTINUOUS PIECE OF WRE MESH (30" NIN. WID'TH BY THROAT LENGTH PLUS 4') TO THE 2"x4" WEIR (MEASURING THROAT LENGTH PLUS 2') AS SHOWN ON THE STANDARD DRAWING.
- B. PLACE A PIECE OF APPROVED FILTER CLOTH (40-85 SEIVE) OF THE SAME DIMENSIONS AS THE WIPE MESH OVER THE WIRE MESH AND SECURELY ATTACH TO THE 2"x4" WEIR.
- . SECURELY NAIL THE 2"x4" WEIR TO 9" LONG VERTICAL SPACERS TO BE OCATED BETWEEN THE WEIR AND INLET FACE (MAX. 6' APART). PLACE THE ASSEMBLY AGAINST THE INLET THROAT AND NAIL (MINIMUM

4' WIDE

M.S.H.A. MIX NO. 2 CONCRETE

UNLESS OTHERWISE NOTED


SIDEWALK DETAIL

NO SCALE

- PLACE THE ASSEMBLE AGAINST THE INLET THROAT AND MAIL (MINIMOM 2' LENGTHS) OF 2"x4" TO THE TOP OF THE WER AT SPACER LOCATIONS.

  THESE 2"x4" ANCHORS SHALL EXTEND ACROSS THE INLET TOP AND BE HELD IN PLACE BY SANDBAGS OR ALTERNATE WEIGHT. . THE ASSEMBLY SHALL BE PLACED SO THAT THE END SPACERS ARE A MINIMUM
- ' BEYOND BOTH ENDS OF THE THROAT OPENING F. FORM THE WIRE MESH AND FILTER CLOTH TO THE CONCRETE GUTTER AND AGAINST THE FACE OF THE CURB ON BOTH SIDES OF THE INLET. PLACE CLEAN 2" STONE OVER THE WIRE MESH AND FILTER FABRIC IN SUCH A MANNER AS TO PREVENT WATER FROM ENTERING THE INLET UNDER OR AROUND THE
- G. THIS TYPE OF PROTECTION MUST BE INSPECTED FREQUENTLY AND THE FILTER H. ASSURE THAT STORM FLOW DOES NOT BYPASS INLET BY INSTALLING TEMPORARY

CURB INLET PROTECTION

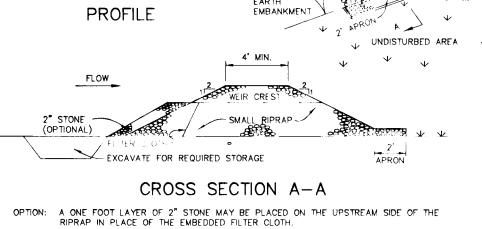



- CONSTRUCTION SPECIFICATIONS 1. AREA UNDER EMBANKMENT SHALL BE CLEARED, GRUBBED AND STRIPPED OF ANY VEGETATION AND ROOT MAT. THE POOL AREA SHALL BE CLEARED.
- 2. THE FILL MATERIAL FOR THE EMBANKMENT SHALL BE FREE OF ROOTS AND OTHER WOODY VEGETATION AS WELL AS OVER-SIZED STONES, ROCKS, ORGANIC MATERIAL OR OTHER OBJECTIONABLE MATERIAL. THE EMBANKMENT SHALL BE COMPACTED BY TRAVERSING WITH EQUIPMENT WHILE IT IS BEING CONSTRUCTED.
- 3. ALL CUT AND FILL SLOPES SHALL BE 2:1 OR FLATTER. 4. THE STONE USED IN THE OUTLET SHALL BE SMALL RIPRAP 4"-8" ALONG WITH A 1"


 $L=4 \times D.A.$ 

- THICKNESS OF 2" AGGREGATE PLACED ON THE UP-GRADE SIDE ON THE SMALL RIPRAP OR EMBEDDED FILTER CLOTH IN THE RIPRAP.
- 5. SEDIMENT SHALL BE REMOVED AND TRAP RESTORED TO ITS ORIGINAL DIMENSIONS WHEN THE SEDIMENT HAS ACCUMULATED TO 1/2 THE DESIGN DEPTH OF THE TRAP 6. THE STRUCTURE SHALL BE INSPECTED AFTER EACH RAIN AND REPAIRS MADE AS
- 7. CONSTRUCTION OPERATIONS SHALL BE CARRIED OUT IN SUCH A MANNER THAN EROSION
- AND WATER POLLUTION IS MINIMIZED
- 8. THE STRUCTURE SHALL BE REMOVED AND THE AREA STABILIZED WHEN THE DRAINAGE

#### STONE OUTLET SEDIMENT TRAP NO SCALE

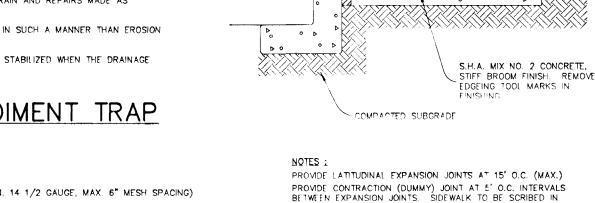

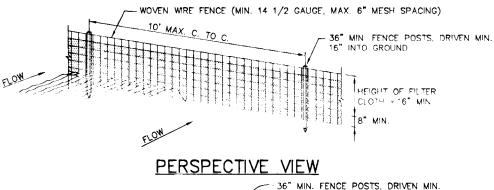

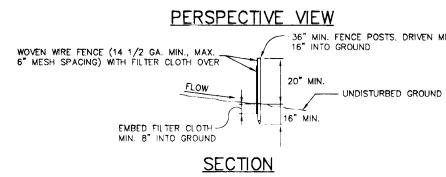


CONSTRUCTION NOTES FOR FABRICATED SILT FENCE . WOVEN WIRE FENCE TO BE FASTENED SECURELY TO FENCE POSTS WITH WIRE TIES AND STAPLES. FILTER CLOTH TO BE FASTENED TO WOVEN WIRE FENCE WITH TIES SPACED EVERY 24" AT TOP 3. WHEN TWO SECTIONS OF FILTER CLOTH ADJOIN EACH OTHER THEY SHALL BE OVERLAPPED BY SIX INCHES (6") AND FOLDED.


4. MAINTENANCE SHALL BE PERFORMED AS NEEDED AND MATERIAL REMOVED WHEN "BULDES" DEVELOP IN THE SILT FENCE.

POSTS: STEEL, EITHER T OR U TYPE OR 2" HARDWOOD. FENCE: WOVEN WIRE, 14 Go.,6" MAX. MESH OPENING. FILTER CLOTH: FILTER X, MIRAFI 100X, STABILINKA T140N OR APPROVED EQUAL.

NO SCALE

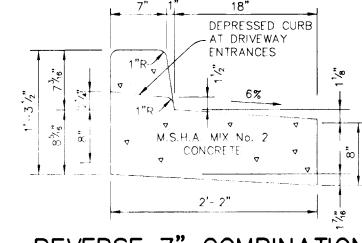

NO SCALE

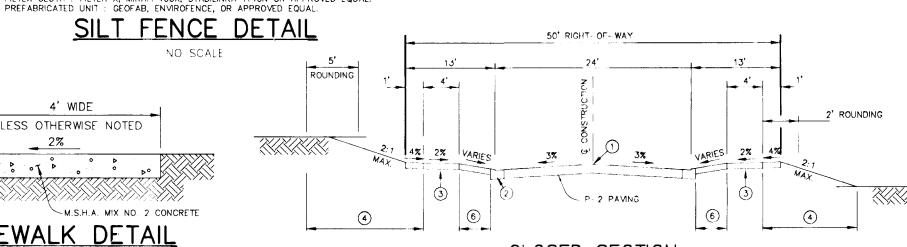


# CLOSED SECTION 1 PROFILE GRADE LINE (PGL), SEE DESIGN MANUAL.

TYPE OF CURB (MODIFIED, REVERSE COMB. AND (STANDARD COME: CURB & GUITER - SEE ROAD PLAN). (3) 4" CONCRETE SIDEWALK AS REQUIRED BY SUBDIVISION REGULATIONS. (4) INDICATES 2" TOPSOIL, SEED AND MULCH. (5) DESIGN SPEED = 25 M P H.


(6) RESIDENTIAL DRIVEWAY ENTRANCE PER HO. CO. STD DETAIL R- 6.01

TYPICAL SECTION CUL-DE-SAC STREET w/ DRIVEWAYS

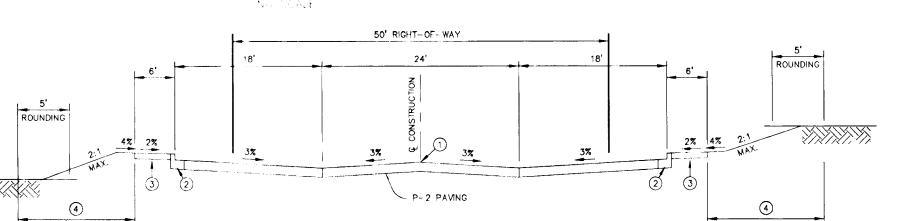


#### CLOSED SECTION

TYPICAL SECTION WITH PARKING STALLS

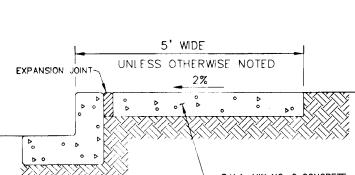

PROVIDE LATITUDINAL EXPANSION JOINTS AT 15' O.C. (MAX.) PROVIDE CONTRACTION (DUMMY) JOINT AT 5' O.C. INTERVALS BETWEEN EXPANSION JOINTS. SIDEWALK TO BE SCRIBED IN

SIDEWALK DETAIL

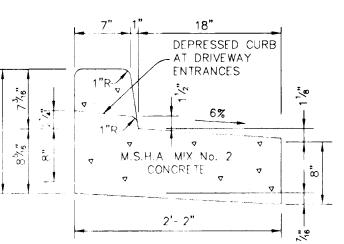

**REVERSE 7" COMBINATION** CURB AND GUTTER


> 50' RIGHT-- OF- WAY ROUNDING

### CLOSED SECTION

(1) PROFILE GRADE LINE (PGL), SEE DESIGN MANUAL 2 TYPE OF CURB (STANDARD COMB. CURB & GUTTER - SEE ROAD PLAN). (3) 4" CONCRETE SIDEWALK AS REQUIRED BY SUBDIVISION REGULATIONS. (4) INDICATES 2" TOPSOIL, SEED AND MULCH.


(5) DESIGN SPEED = 25 M.P.H.

TYPICAL SECTION CUL-DE-SAC STREET

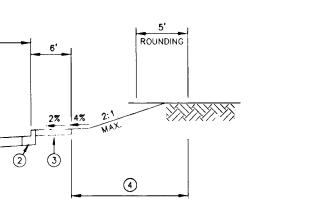

1 PROFILE GRADE LINE (PGL), SEE DESIGN MANUAL TYPE OF CURB (REVERSE COMB. CURB & GUTTER, STANDARD COMB. CURB & GUTTER - SEE ROAD PLAN). (3) 5" CONCRETE SIDEWALK AS REQUIRED BY SUBDIVISION REGULATIONS. (4) INDICATES 2" TOPSOIL, SEED AND MULCH.

(5) DESIGN SPEED = 25 M.P.H.

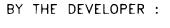

I/WE CERTIFY THAT ALL DEVELOPMENT AND CONSTRUCTION WILL BE DONE ACCORDING TO THIS PLAN, AND THAT ANY RESPONSIBLE PERSONNEL INVOLVED IN THE CONSTRUCTION PROJECT WILL HAVE A CERTIFICATE OF ATTENDANCE AT A DEPARTMENT OF THE ENVIRONMENT APPROVED TRAINING PROGRAM FOR THE CONTROL OF SEDIMENT AND EROSION BEFORE BEGINNING THE PROJECT. I ALSO AUTHORIZE PERIODIC ON-SITE INSPECTIONS BY THE HOWARD SOIL CONSERVATION DISTRICT.

DEVELOPER

#### BY THE ENGINEER :

I CERTIFY THAT THIS PLAN FOR EROSION AND SEPIMENT CONTROL REPRESENTS A PRACTICAL AND WORKABLE PLAN BASED ON MY PERSONAL KNOWLEDGE OF THE SITE CONDITIONS AND THAT IT WAS PREPARED IN ACCORDANCE WITH THE REQUIREMENTS OF THE HOWARD SOIL CONSERVATION DISTRICT.

THESE PLANS HAVE BEEN REVIEWED FOR THE HOWARD SOIL CONSERVATION DISTRICT AND MEET THE TECHNICAL REQUIREMENTS FOR SOIL EROSION AND SEDIMENT CONTROL.

11.30.95

DATE

THIS DEVELOPMENT PLAN IS APPROVED FOR SOIL EROSION AND SEDIMENT CONTROL BY THE HOWARD SOIL CONSERVATION

AS BUILT CERTIFICATE

DATE

WORKS. \_12.22-95 Cleonew M. Laucke

APPROVED : HOWARD COUNTY DEPARTMENT OF PUBLIC

CHIEF, BUREAU OF HIGHWAYS HS DATE APPROVED: HOWARD COUNTY DEPARTMENT OF PLANNING AND ZONING.

1/3/96 CHIEF, DIVISION OF LAND DEVELOPMENT AND RESEARCH

Well Lammen DEVELOPMENT M.K. ENGINÉERING DIVISION

OWNER THE HOWARD RESEARCH AND DEVELOPMENT CORPORATION THE ROUSE BUILDING 10275 LITTLE PATUXENT PARKWAY

COLUMBIA, MARYLAND 21044

REVISION

WESTBROOK DEVELOPMENT, INC. Court Towers Suite 300 210 West Pennsylvania Avenue Towson, Maryland 21204 (410) 823-4700 • Fax(410)823-5009 Attn: Brian Flick

DATE NO.

PROJECT


TITLE

SNOWDEN RIDGE SECTION 1 AREA 2

AREA GATEWAY COMMERCE CENTER - PARCEL 'A 53' TAX MAP NO. 42 ZONED R A- 15 6th ELECTION DISTRICT HOWARD COUNTY, MARYLAND

DETAIL SHEET

Planners • Engineers • Surveyors 8818 Centre Park Drive • Suite 200 • Columbia, Md 21045 410-997-8900 FAX: 410-997-9282

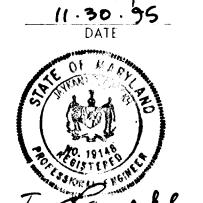

30 - 95 - 88 | F | 95 - 138 | SP - 95 | 88 | 2 - 95 - 09 DESIGNED BY : C.J.R. DRAWN ьY : DAM PROJECT NO : HOCO \95H1060 PH2RD5.DWG DATE : NOVEMBER 30, 1905

CALE : AS SHOWN

Baren DRAWING NO. 4 OF 4 D. PAREKH #19148

F-96-27