
# BALTIMORE WASHINGTON INDUSTRIAL PARK 6TH. ELECTION DISTRICT HOWARD COUNTY, MARYLAND


## GENERAL NOTES

- 1. ALL WORK SHALL BE PERFORMED IN ACCORDANCE WITH THE HOWARD COUNTY DESIGN MANUAL VOLUME IV, "STANDARD DETAILS AND SPECIFICATIONS FOR CONSTRUCTION".
- 2. APPROXIMATE LOCATION OF EXISTING UTILITIES ARE SHOWN. THE CONTRACTOR SHALL TAKE ALL NECESSARY PRECAUTIONS TO PROTECT THE EXISTING UTILITIES AND MAINTAIN UNINTERRUPTED SERVICE. ANY DAMAGE INCURRED DUE TO CONTRACTOR'S OPERATION SHALL BE REPAIRED IMMEDIATELY AT THE CONTRACTOR'S EXPENSE.
- 3. THE CONTRACTOR SHALL TEST PIT EXISTING UTILITIES, WHERE DIRECTED BY THE ENGINEER, A MINIMUM OF TWO WEEKS IN ADVANCE OF CONSTRUCTION OPERATIONS.
- 4. CONTRACTOR TO NOTIFY "MISS UTILITY" PHONE (1) 539-0100 AT LEAST THREE (3) DAYS BEFORE STARTING WORK SHOWN ON THIS/THESE DRAWING(S).
- 5. INSTALLATION OF TRAFFIC CONTROL DEVICES, MARKING AND SIGNING SHALL BE IN ACCORDANCE WITH THE MANUAL OF UNIFORM TRAFFIC CONTROL DEVICES 1978 OR LATEST REVISION.
- 6. DESIGNED TRAFFIC SPEED IN ACCORDANCE WITH THE HOWARD COUNTY DESIGN MANUAL VOLUME III STANDARDS. 35 MPH.
- 7. ALL ELEVATIONS SHOWN ARE BASED ON U.S.C. AND G.S. MEAN SEA LEVEL DATUM 1929.
- 8. ALL COORDINATES BASED ON MARYLAND STATE GRID SYSTEM.
- 9. PIPE SHALL NOT BE INSTALLED BY THE CONTRACTOR UNTIL THE LENGTH CALLED FOR AT EACH STATION HAS BEEN APPROVED BY THE ENGINEER IN THE FIELD.
- 10. BRICK BULKHEADS SHALL BE INSTALLED IN ALL STORM DRAIN STUBS.
- 11. CONTRACTOR TO RESTORE ALL EXISTING PAVING, SIDEWALKS OR LAWNS AFFECTED BY THE CONSTRUCTION SHOWN HEREON TO A CONDITION COMPARABLE TO THAT EXISTING PRIOR TO CONSTRUCTION.
- 12. REFER TO APPROVED GP 85-76, FOR SEDIMENT CONTROL DEVICES THAT ARE TO BE MAINTAINED DURING CONSTRUCTION OF THIS CONTRACT. SEE DRAWINGS 7 THRU 11 FOR ANY REVISIONS REQUIRED BY THIS WORK.
- 13. ALL STORM DRAIN BEDDING TO BE CLASS C EXCEPT WHERE OTHERWISE NOTED.

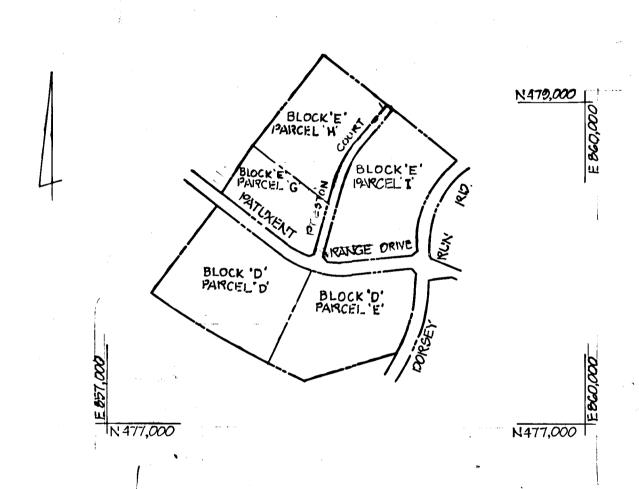

PLAN SCALE: 1" = 600'

NO.	INDEX OF SHEETS			
1	TITLE SHEET			
2	TYPICAL SECTIONS AND MISCELLANEOUS DETAILS			
3	ROADWAY PLAN AND PROFILE: DORSEY RUN ROAD STA. 94+00 TO 98+30			
4	ROADWAY PLAN AND PROFILE: STA. 101+58 TO 106+78.87			
5	ROADWAY PLAN AND PROFILE: PRESTON COURT			
6	STORM DRAIN PROFILES			
7	DRAINAGE AREA MAP, SEDIMENT CONTROL AND GRADING PLAN: PARCEL E			
-8	DRAINAGE AREA MAP, SEDIMENT CONTROL AND GRADING PLAN: PARCEL O			
8	DRAINAGE AREA MAP, SEDIMENT CONTROL AND GRADING PLAN: PARCELGSH			
9	DRAINAGE AREA MAP, SEDIMENT CONTROL AND GRADING PLAN: PARCEL I			
10	SEDIMENT CONTROL DETAILS			

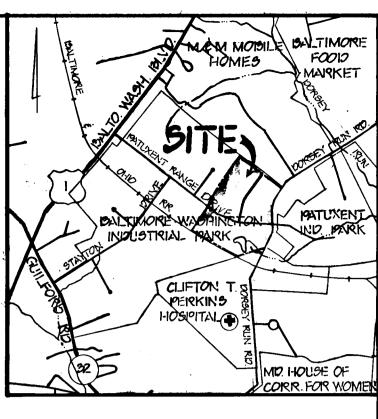

VICINITY MAP

SCALE: 1" = 2000'

### BENCH MARKS

P. & J. B.M. #4 ELEV. 211.79

R.R. SPIKE SET IN C&P POLE #26,

G&E POLE #263656, S. SIDE DORSEY

BUN ROAD

P. & J. B.M. #7

ELEV. 177.244

R.R. SPIKE SET IN G&E POLE #263650, S. SIDE DORSEY RUN ROAD.

WORIZONTAL & VERTICAL CONTROLS REFERENCED TO BERKE AZIMUTH MARK - 1964"

DEPARTMENT OF PUBLIC WORKS

CHIEF, BUREAU OF ENGINEERING STATE

DEPARTMENT OF PLANNING AND ZONING

CHEF, DIV. OF LAND DEVELOP. & ZONING ADM. DATF

10/8/85 | COUNTY COMMENTS

Date No Revision Description

OWNER AND DEVELOPER

R. W. T. D. TNC

B.W.I.P. INC.

110 WEST RD. TOWSON, MARYLAND 21204

# CENTURY ENGINEERING, INC.

PARCELS D,E,G,H&I TAX MAP 48
6TH ELECTION DISTRICT HOWARD CO., MD.

PRESTON COURT & DORSEY RUN ROAD

CONSULTING ENGINEERS • PLANNERS

32 WEST ROAD

TOWSON, MARYLAND 21204

ARE

C. ROBERT SHINHAM, MD. REG.

6-5-85


P.E. No. 87/7


ROAD AND STORM DRAIN
CONSTRUCTION PLANS AND DETAILS FOR


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Drn By A.E.B. Date JUNE 85


Drawing No. 10 OF 10




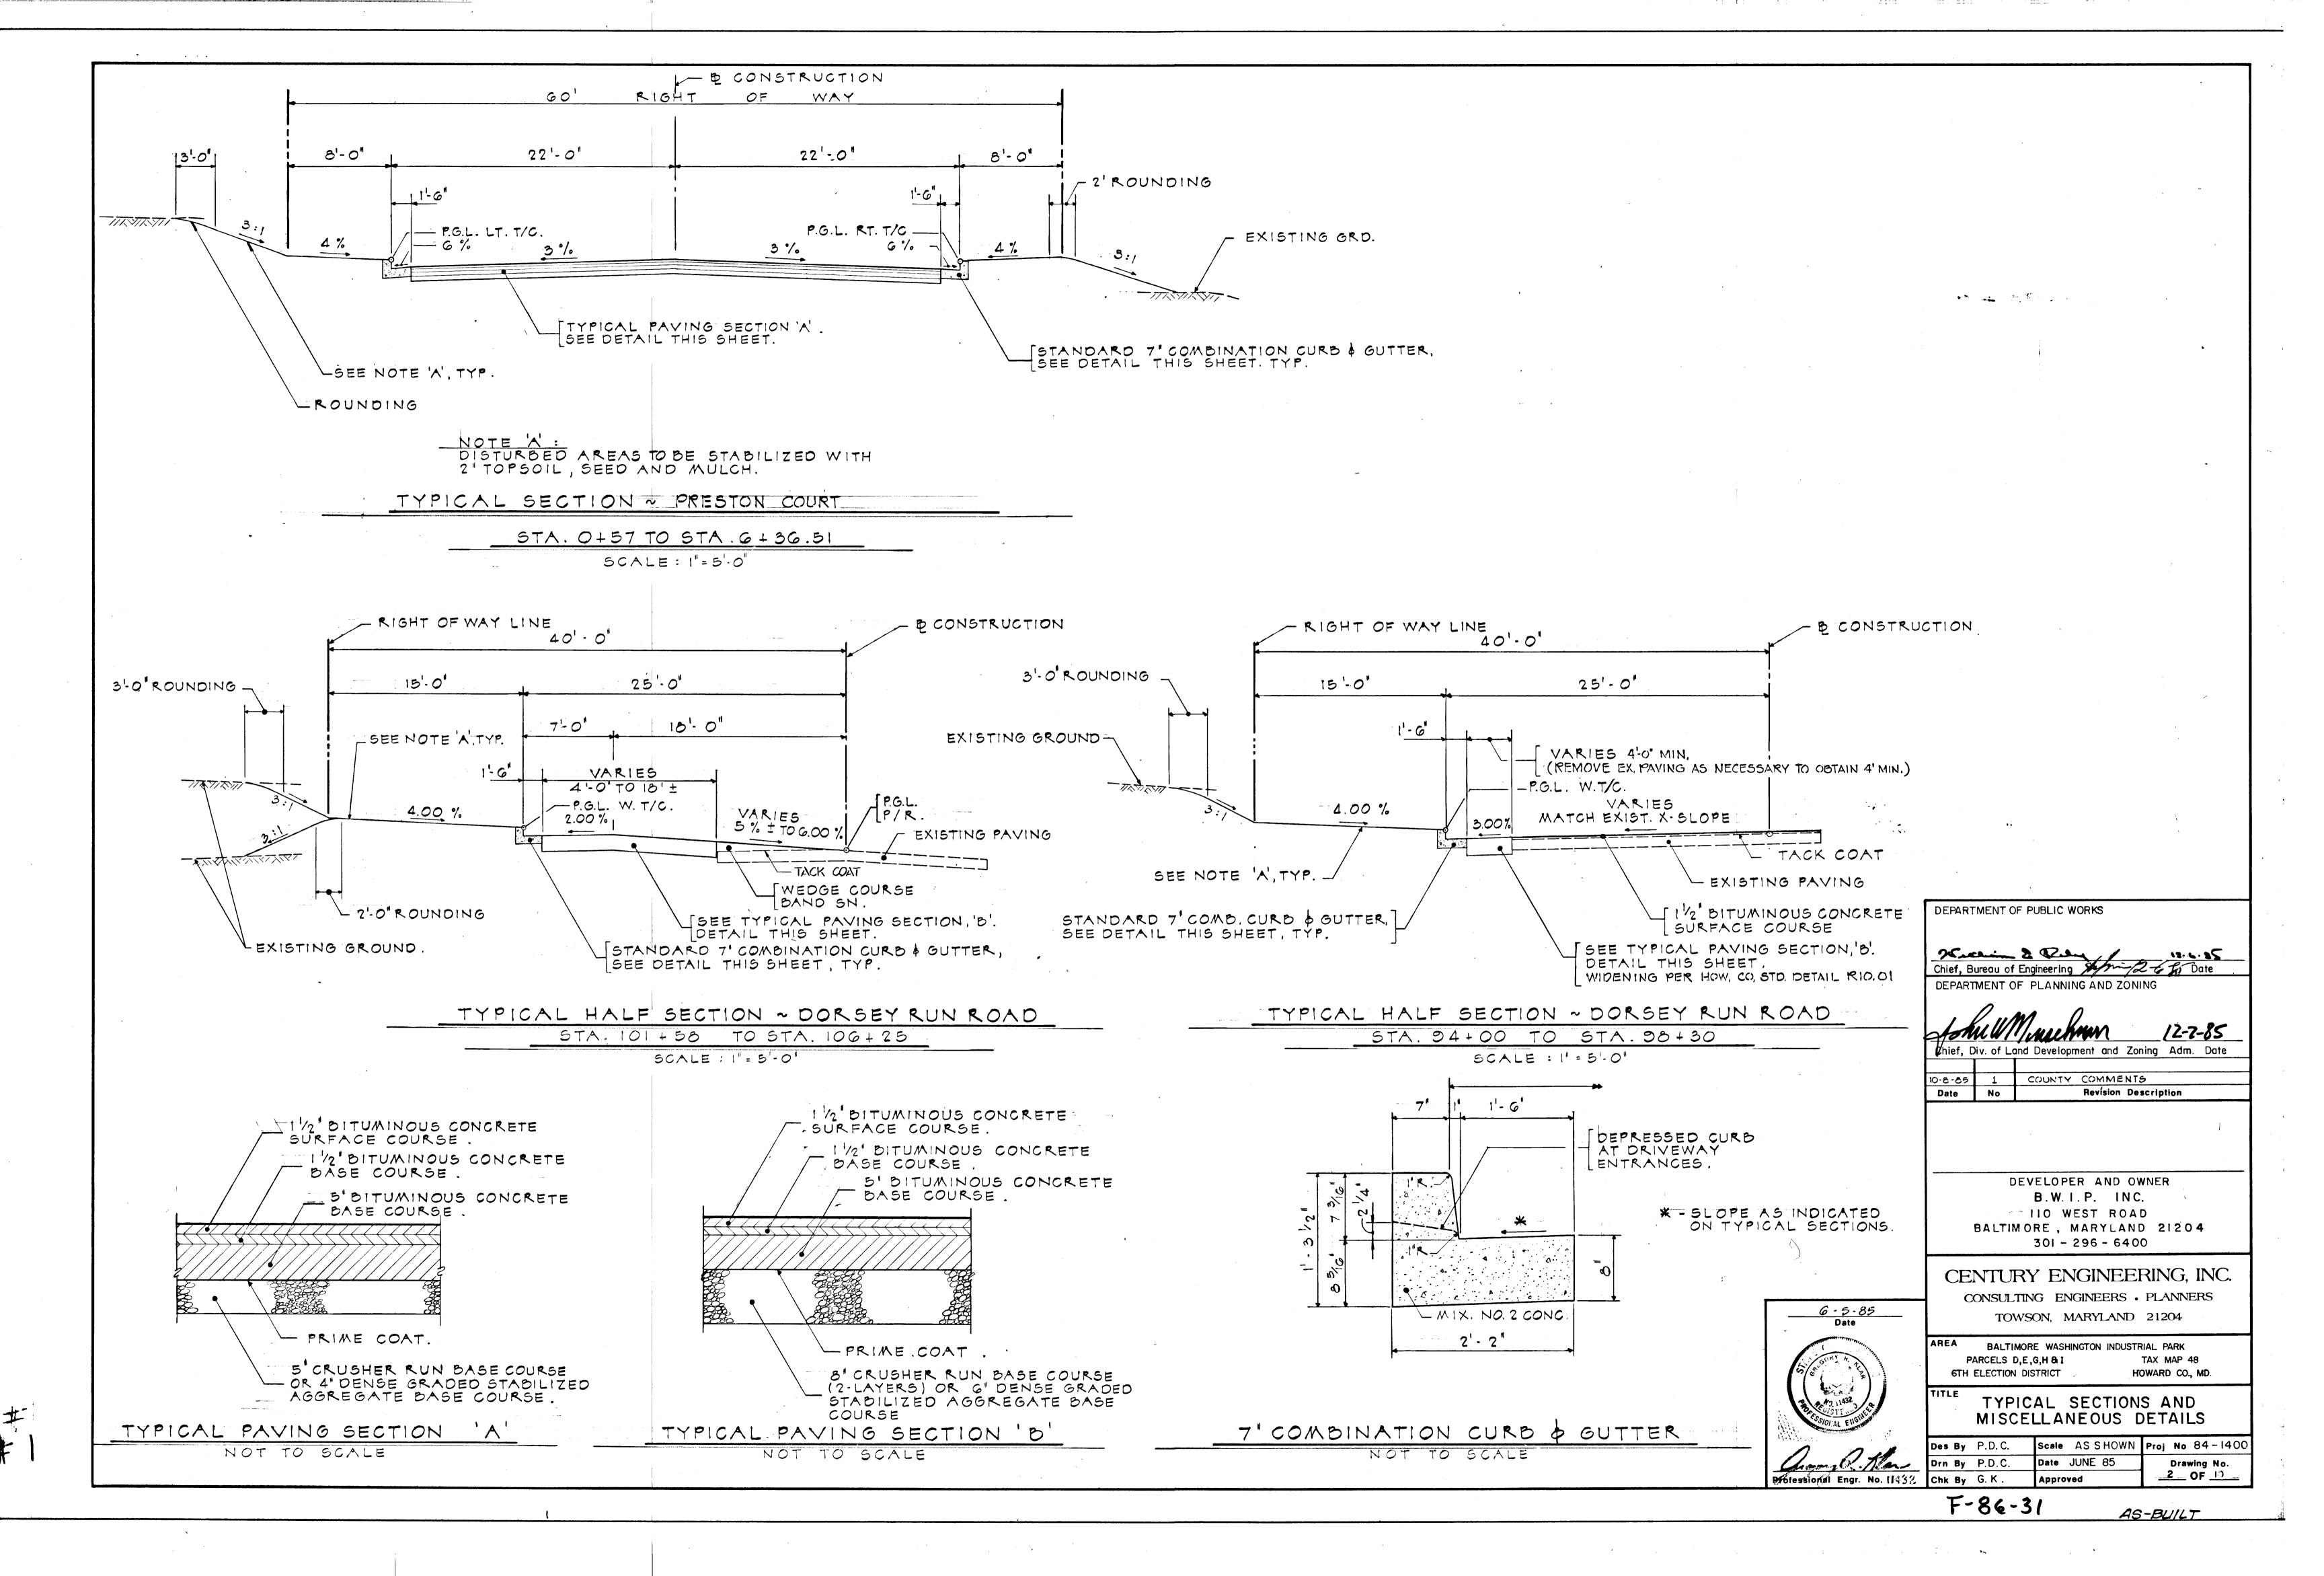

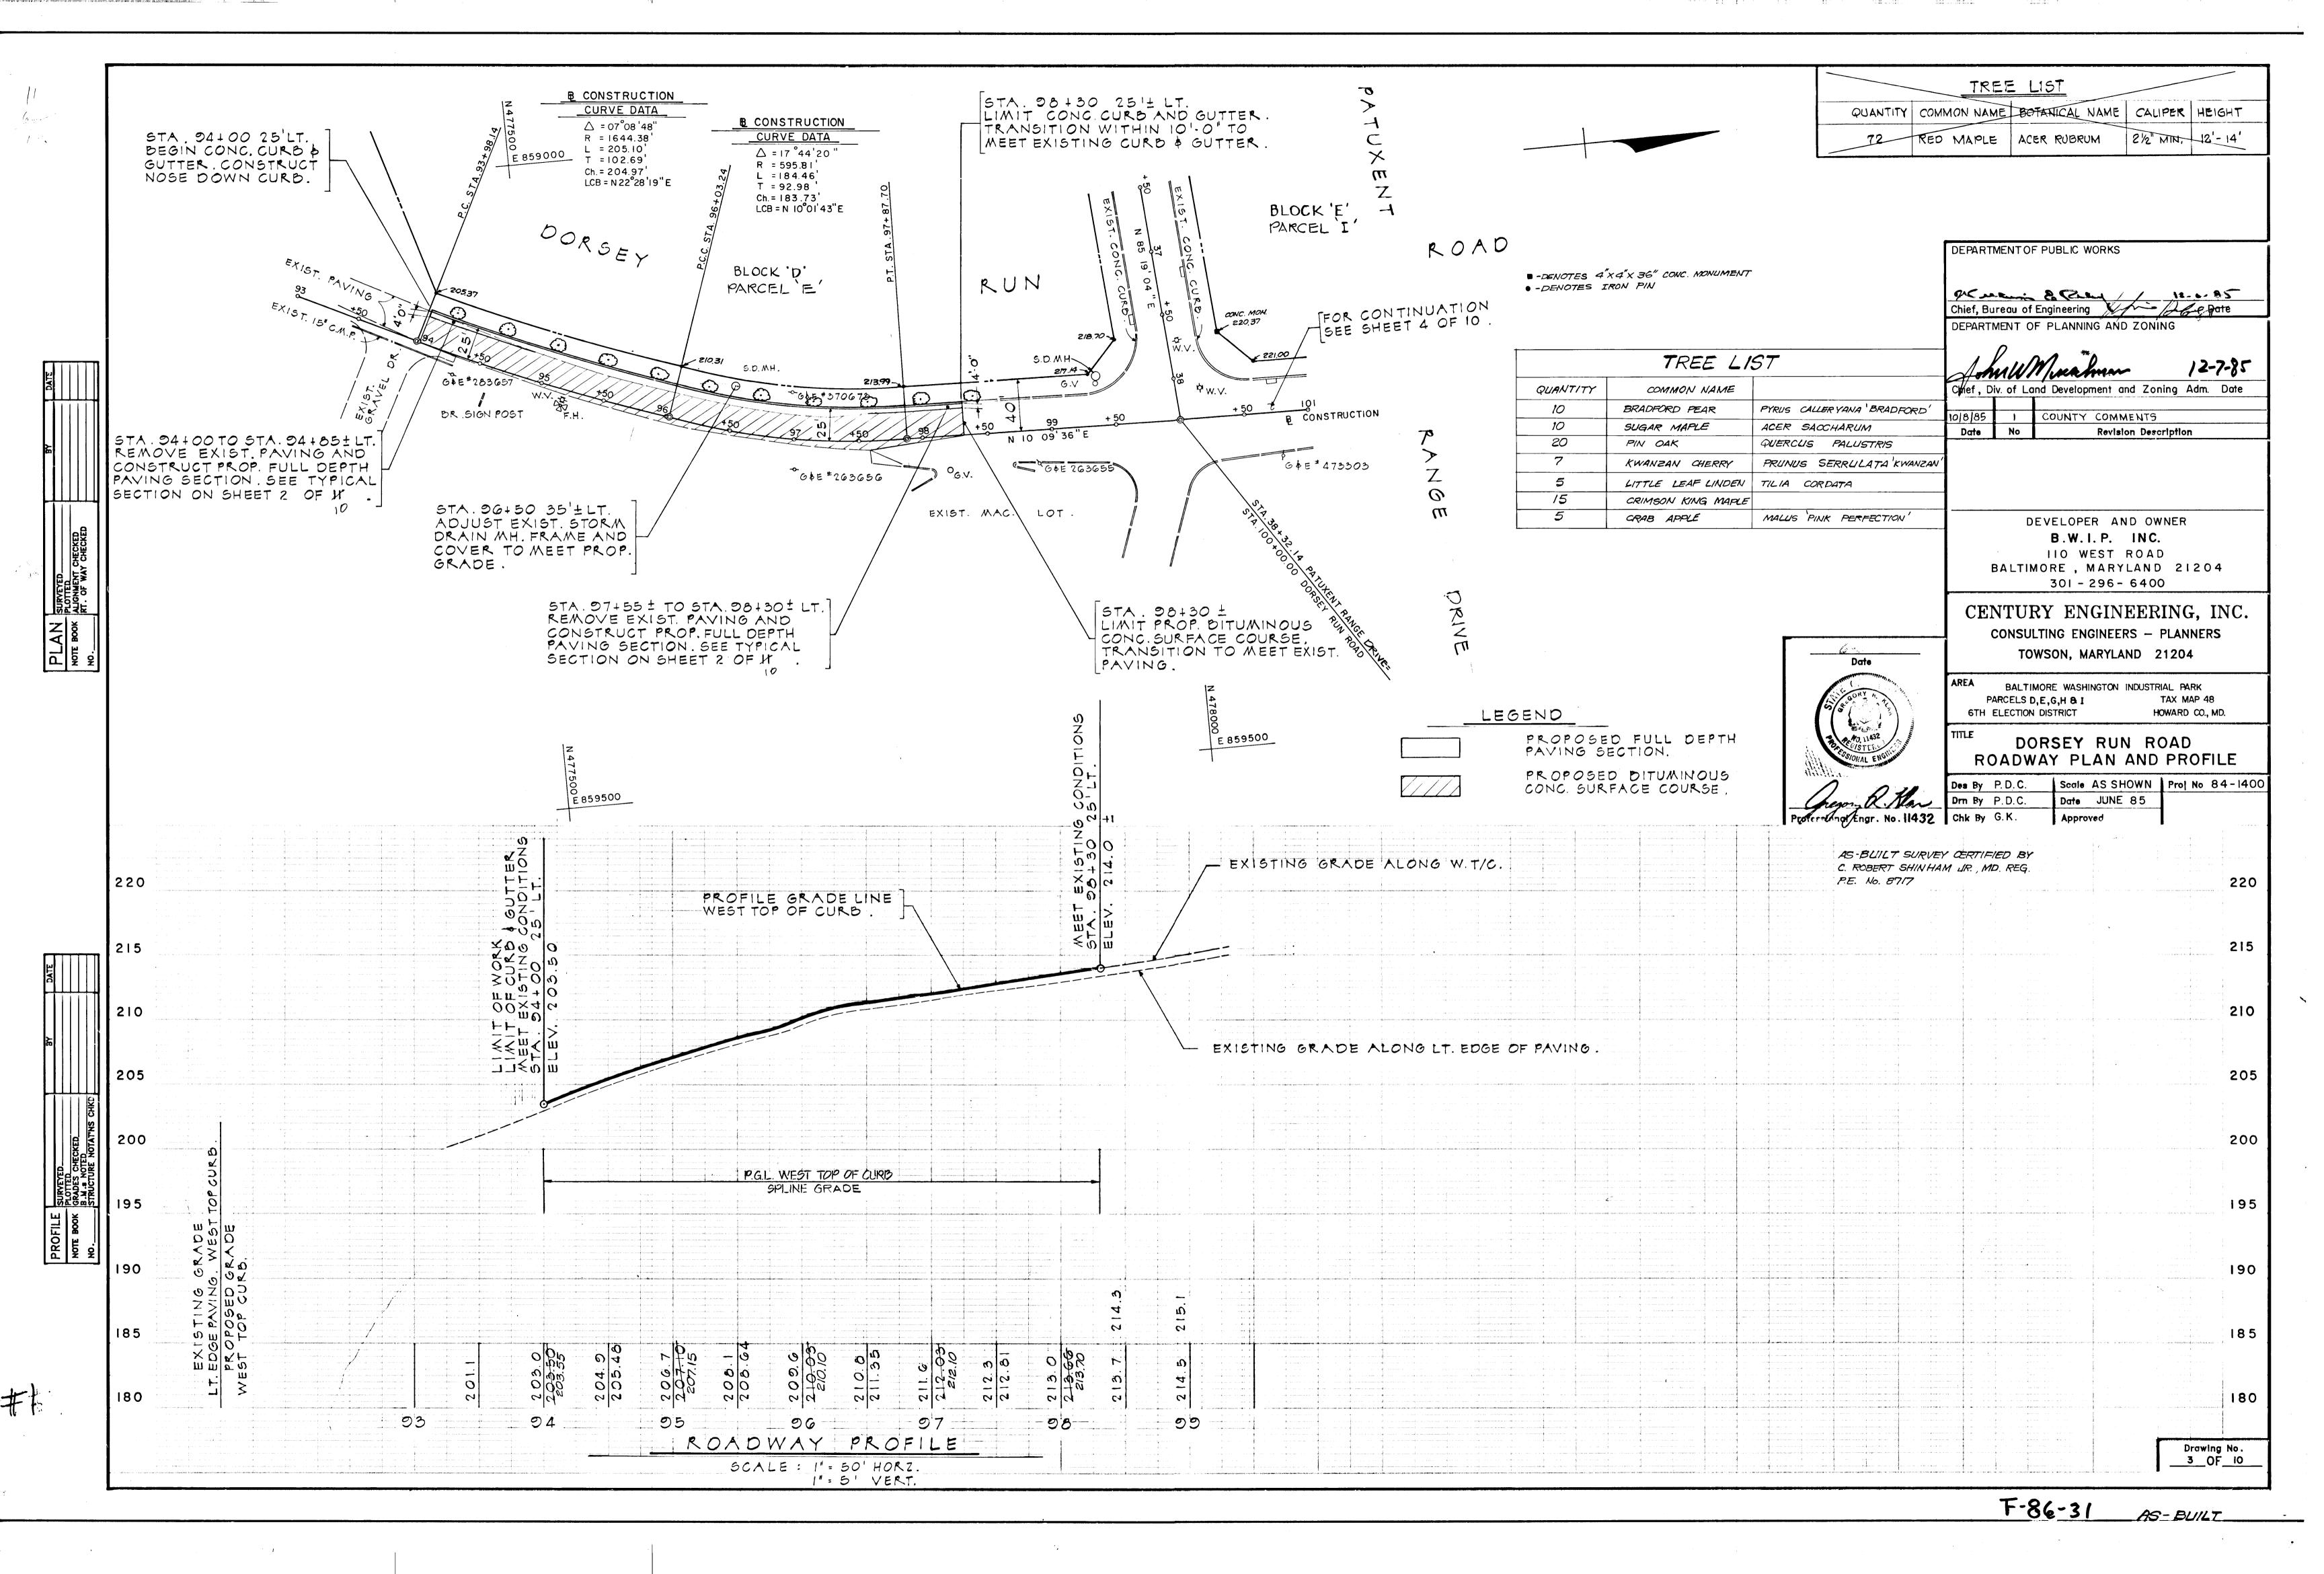


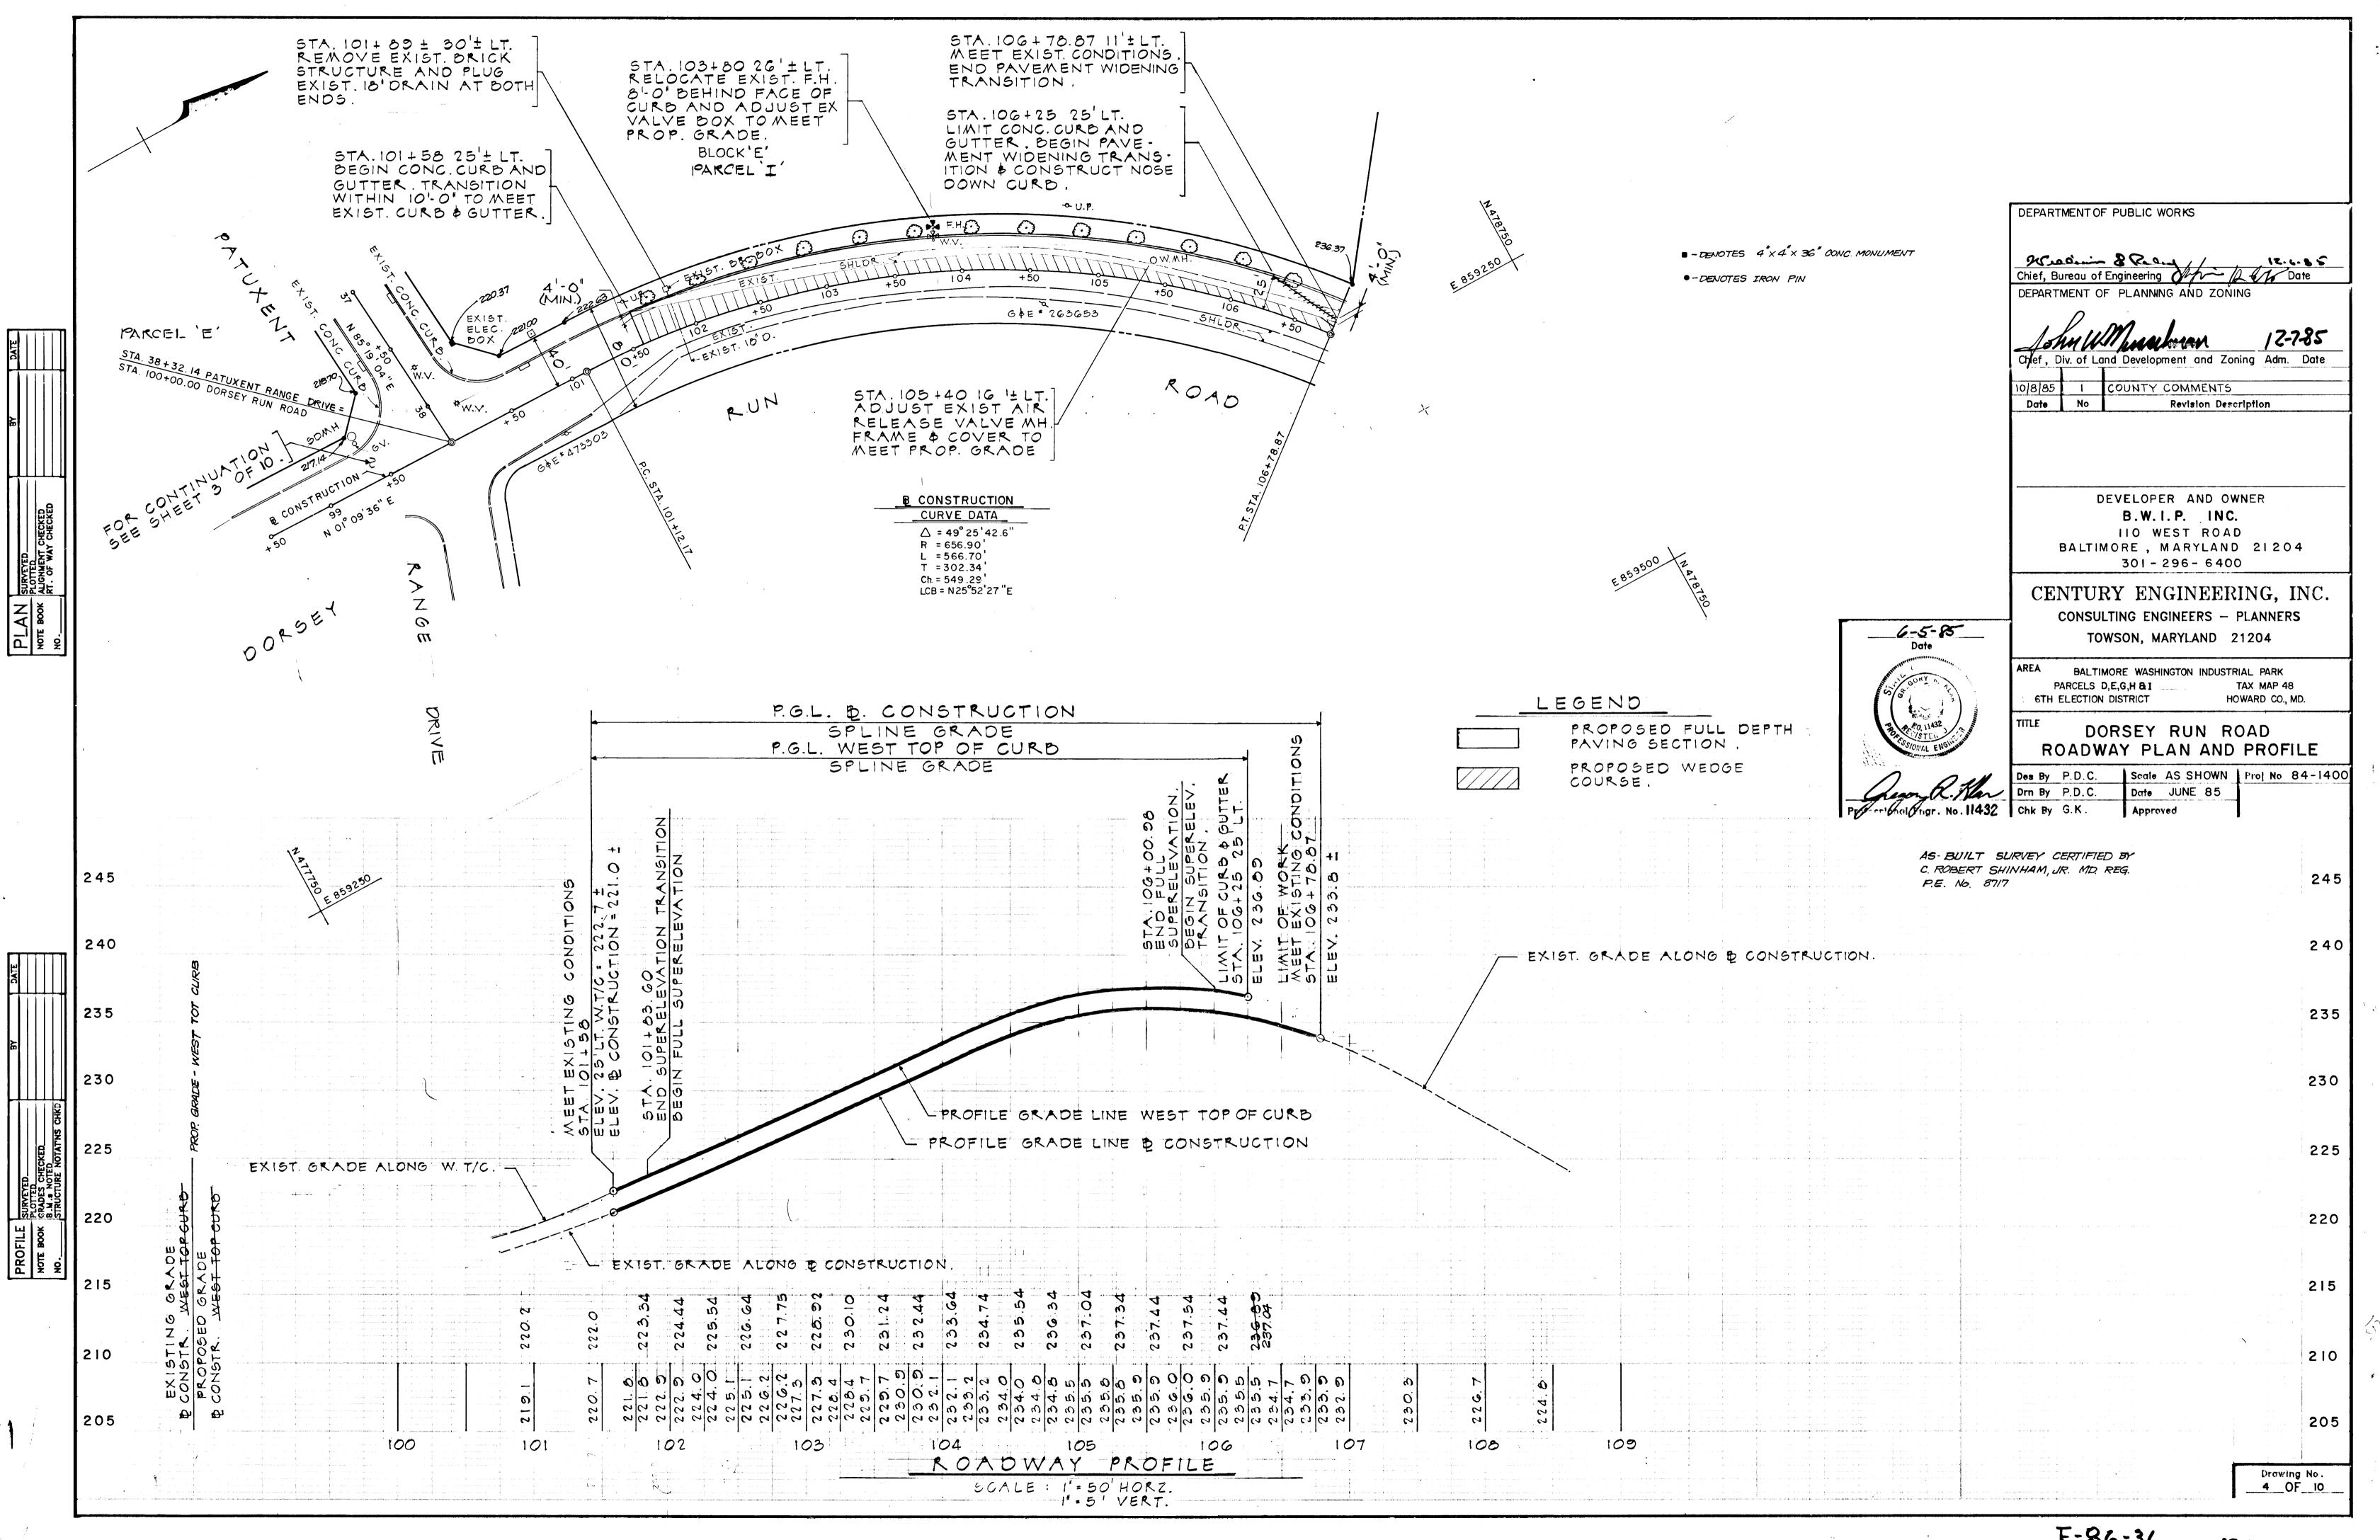F-86-31

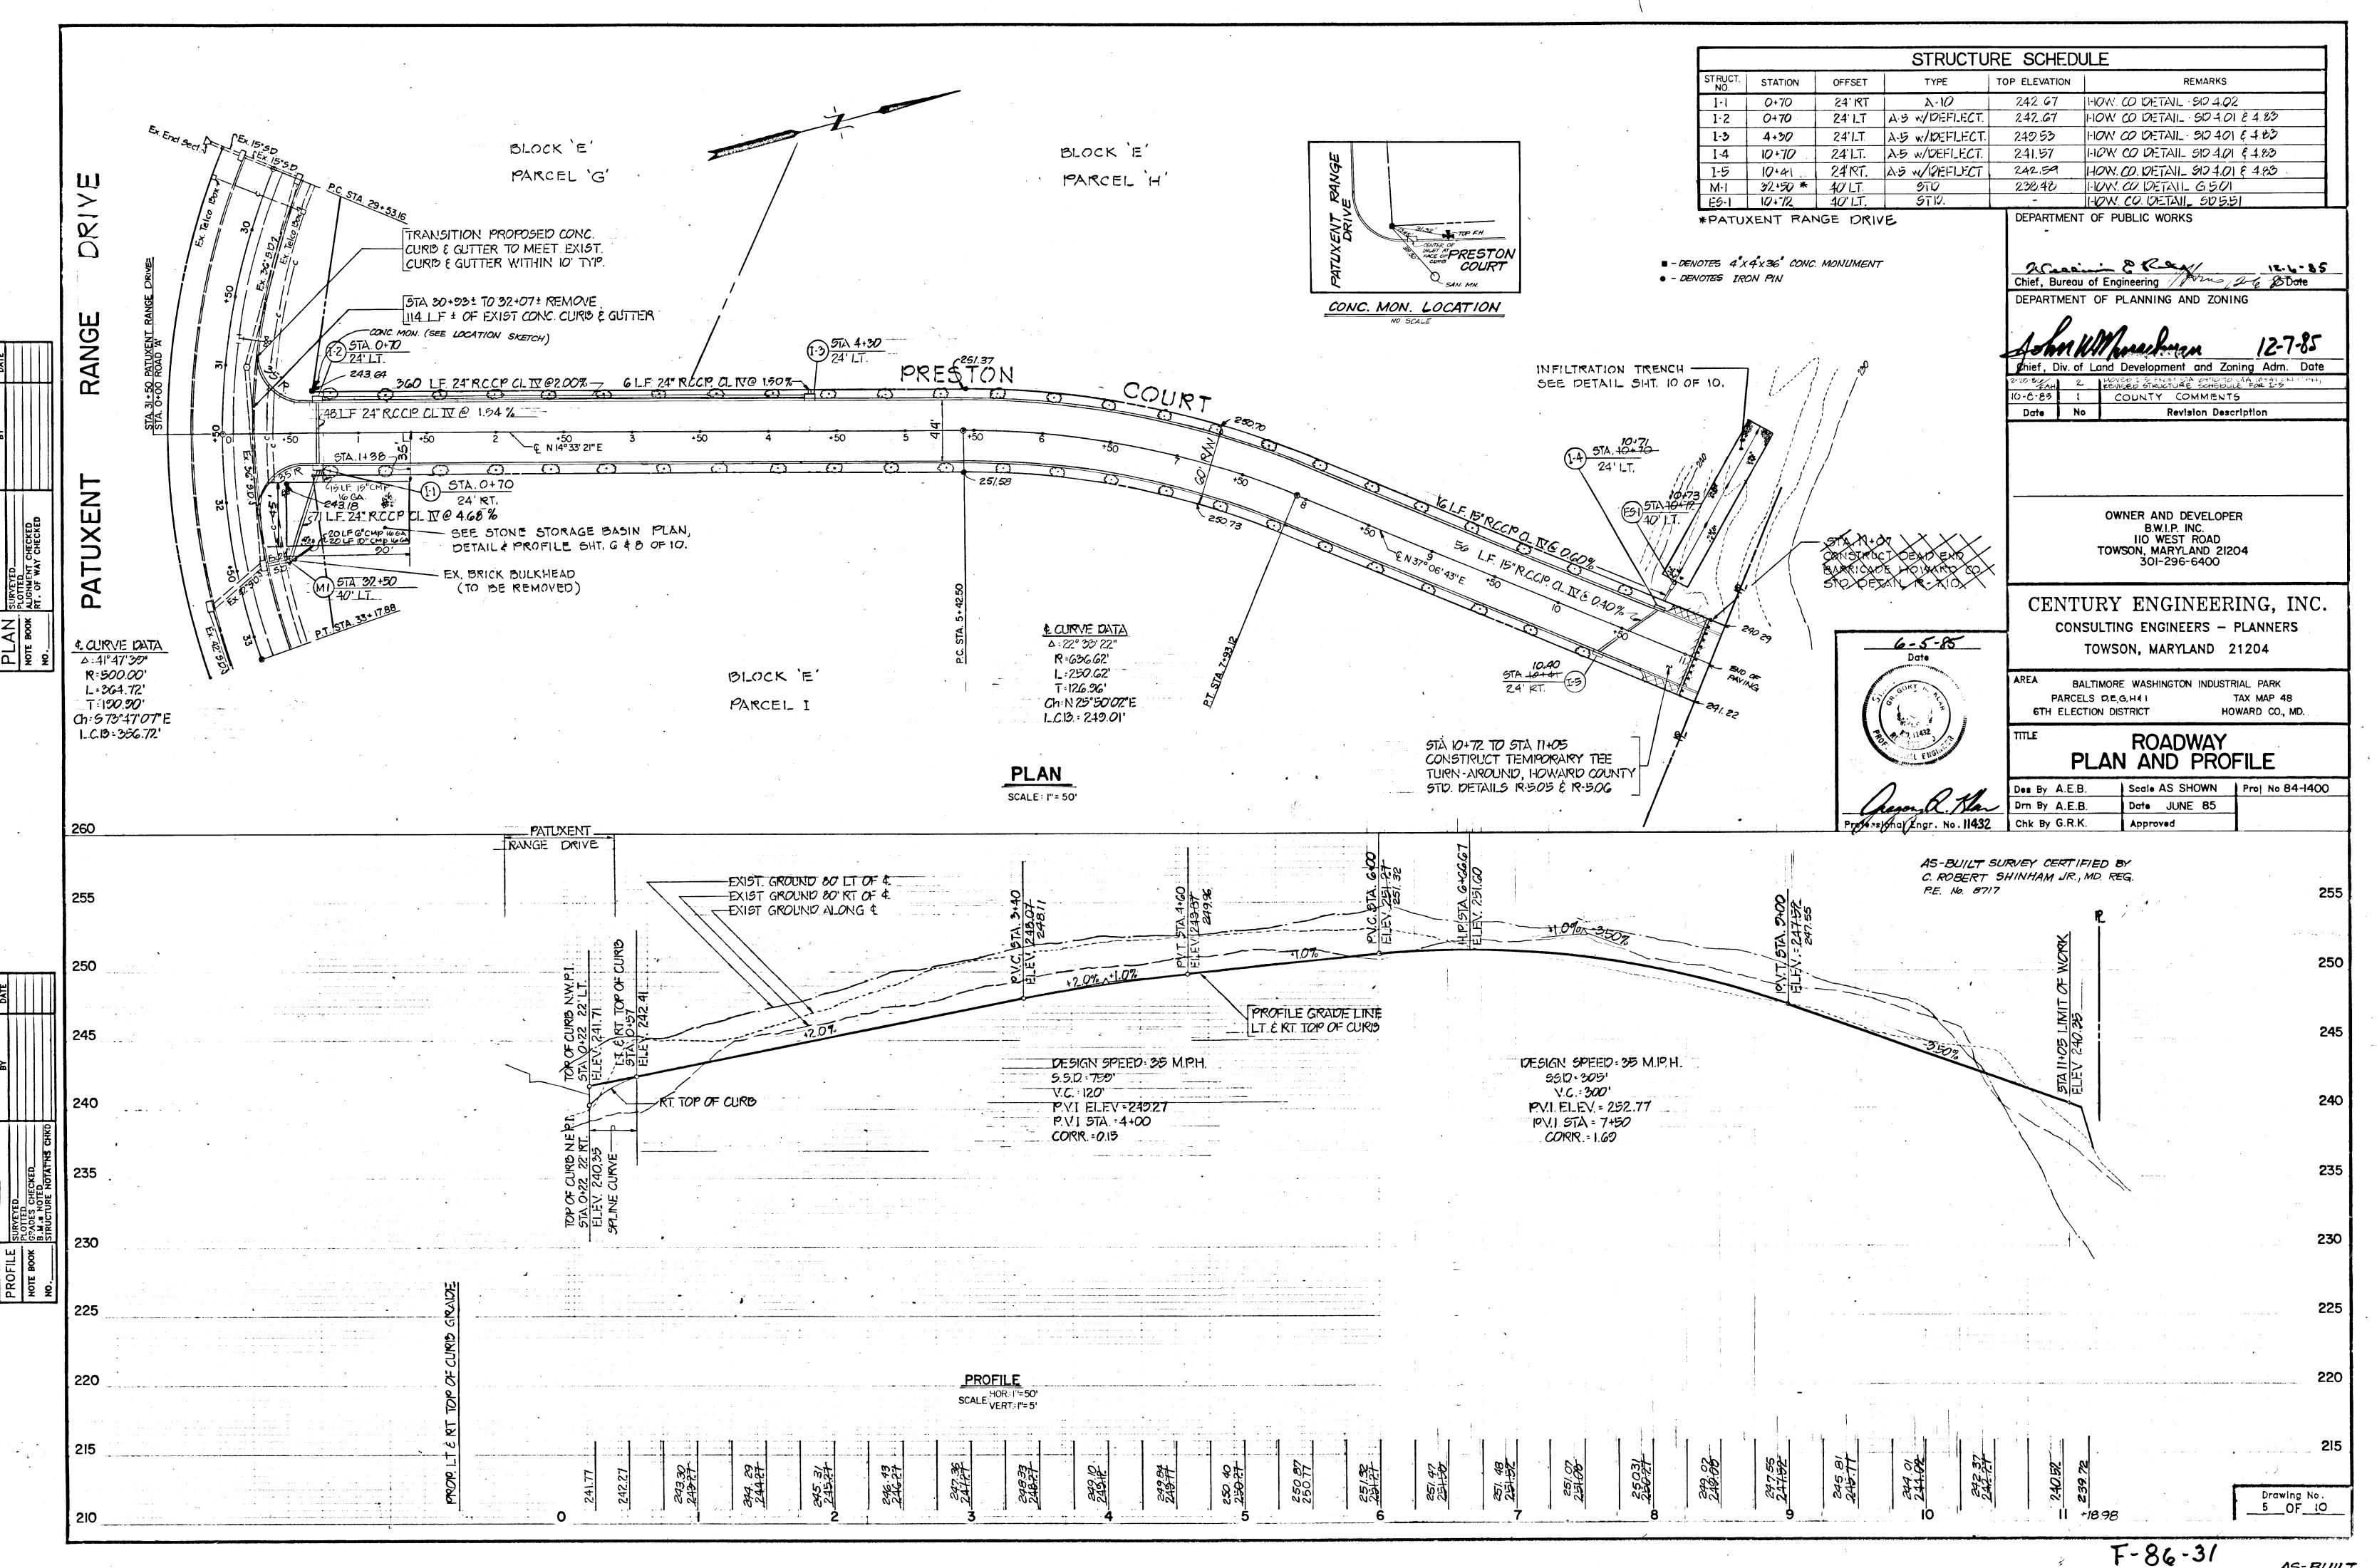

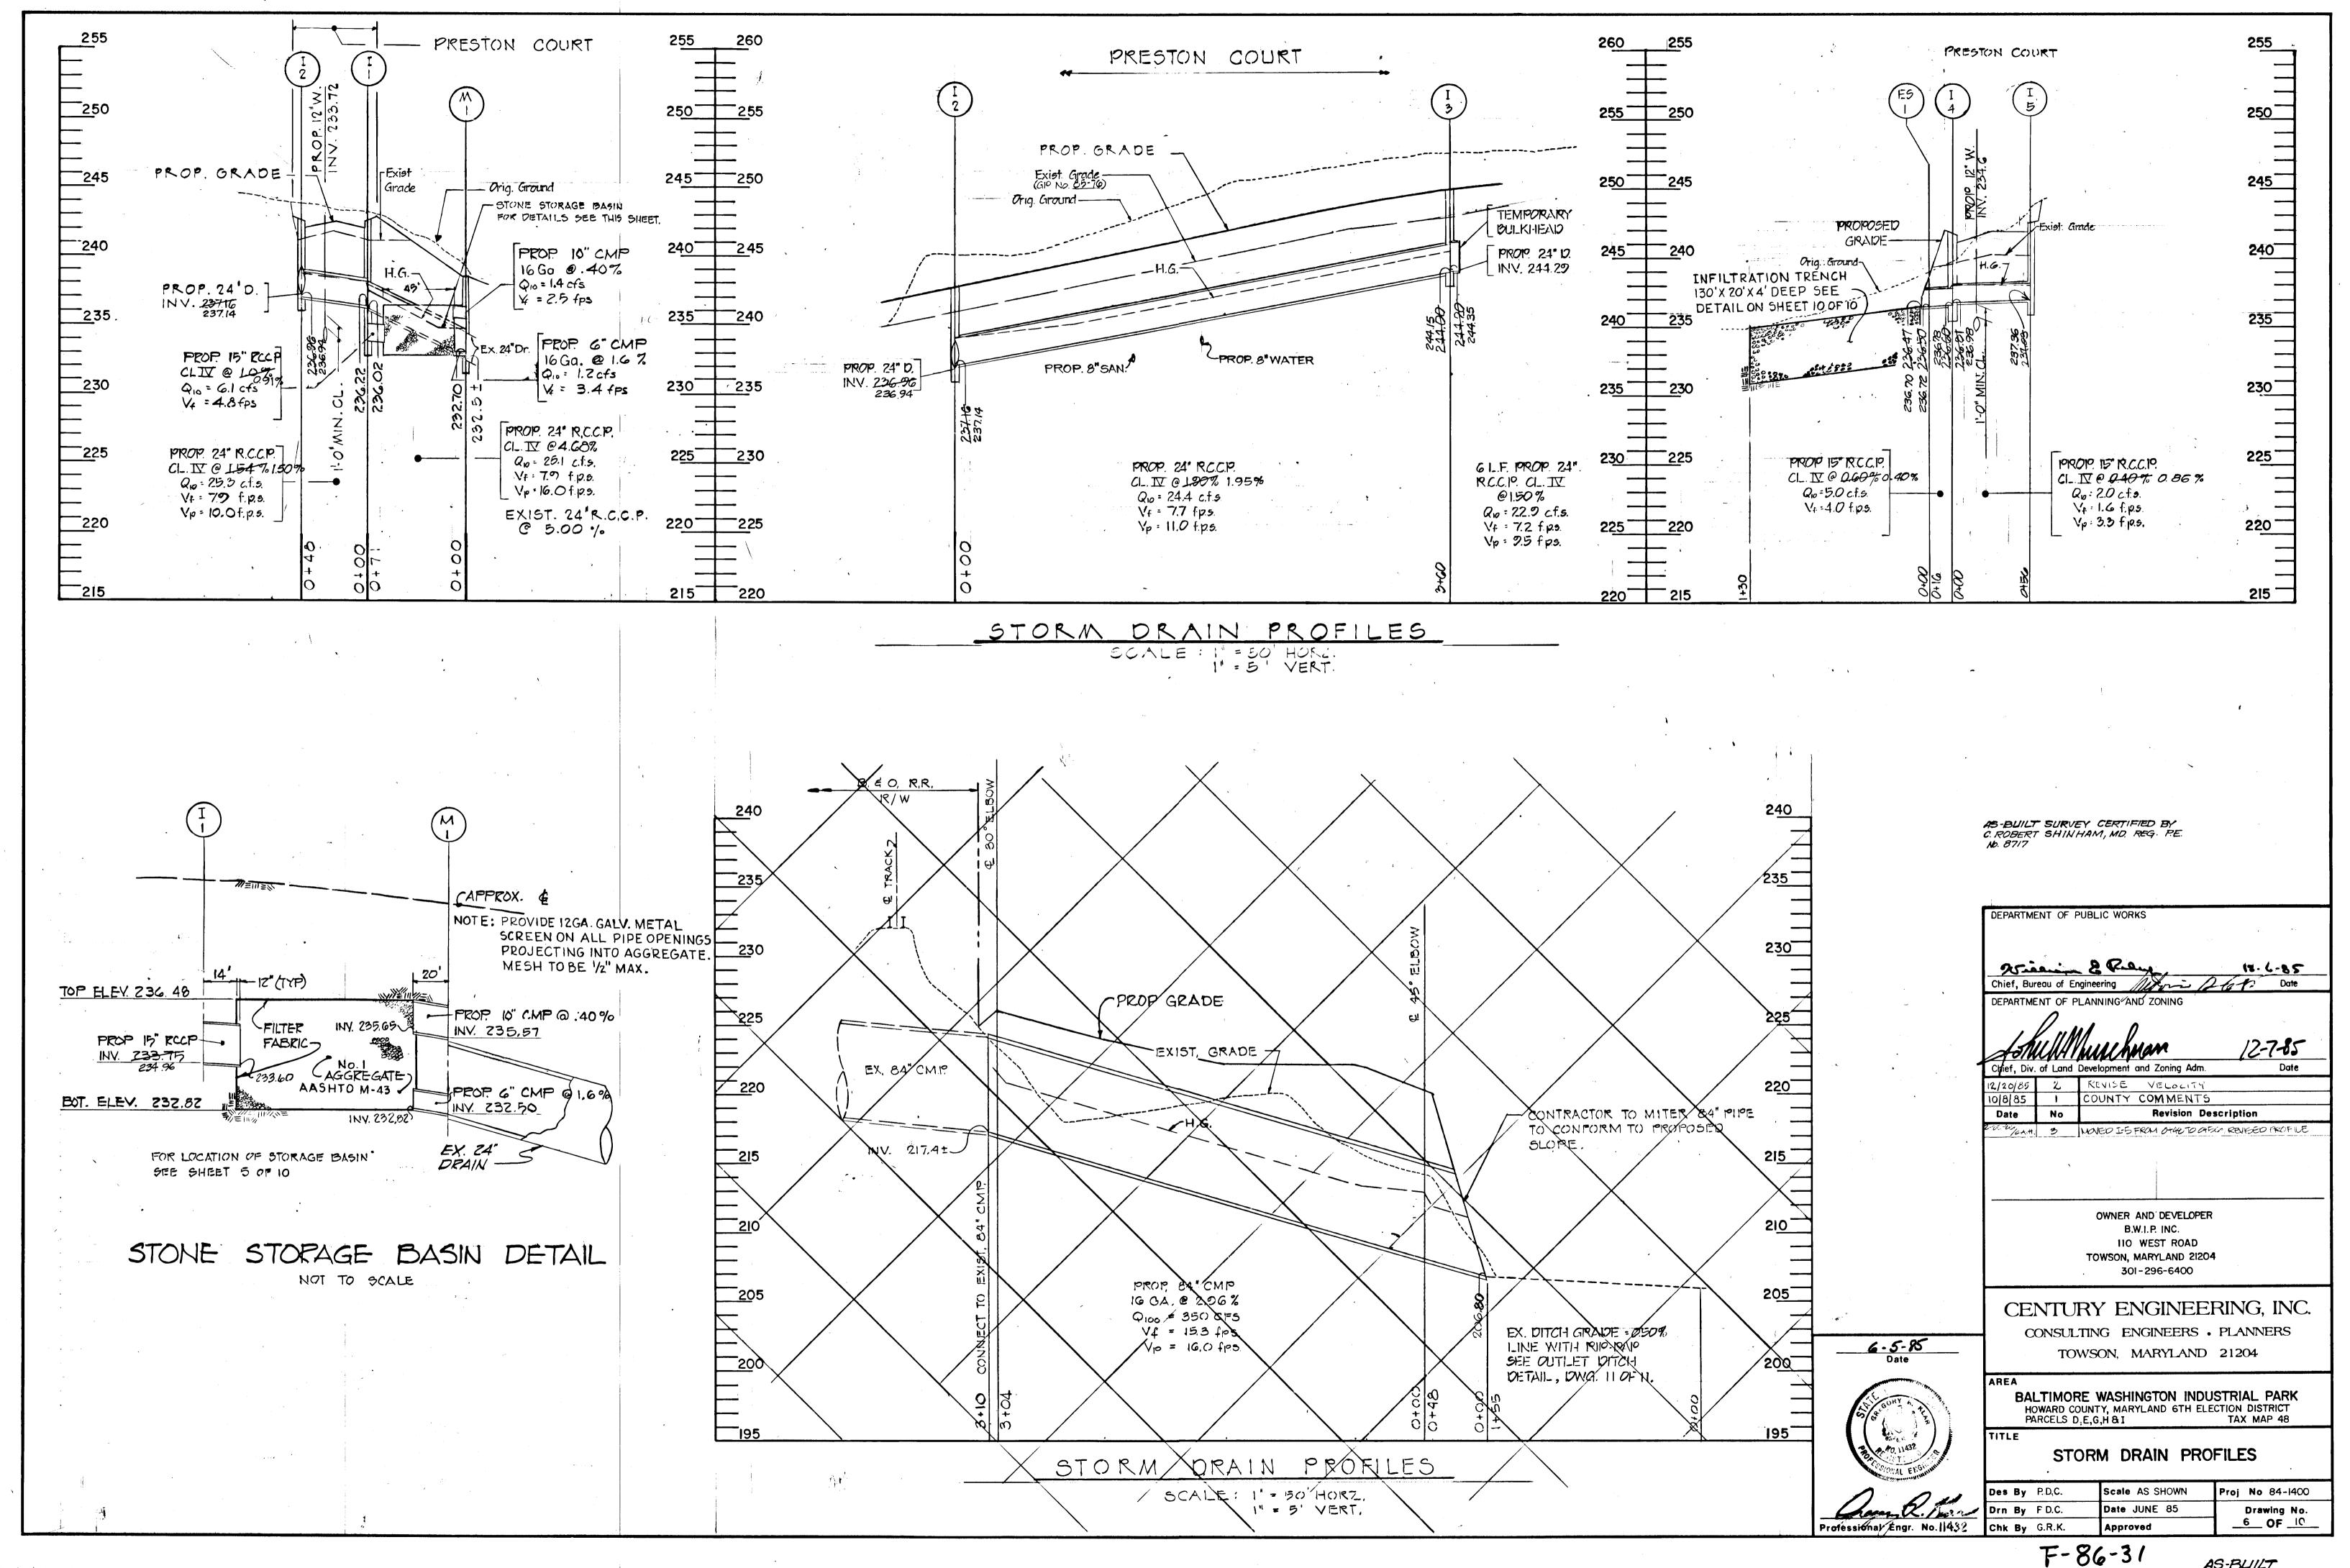



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AS-BUILT

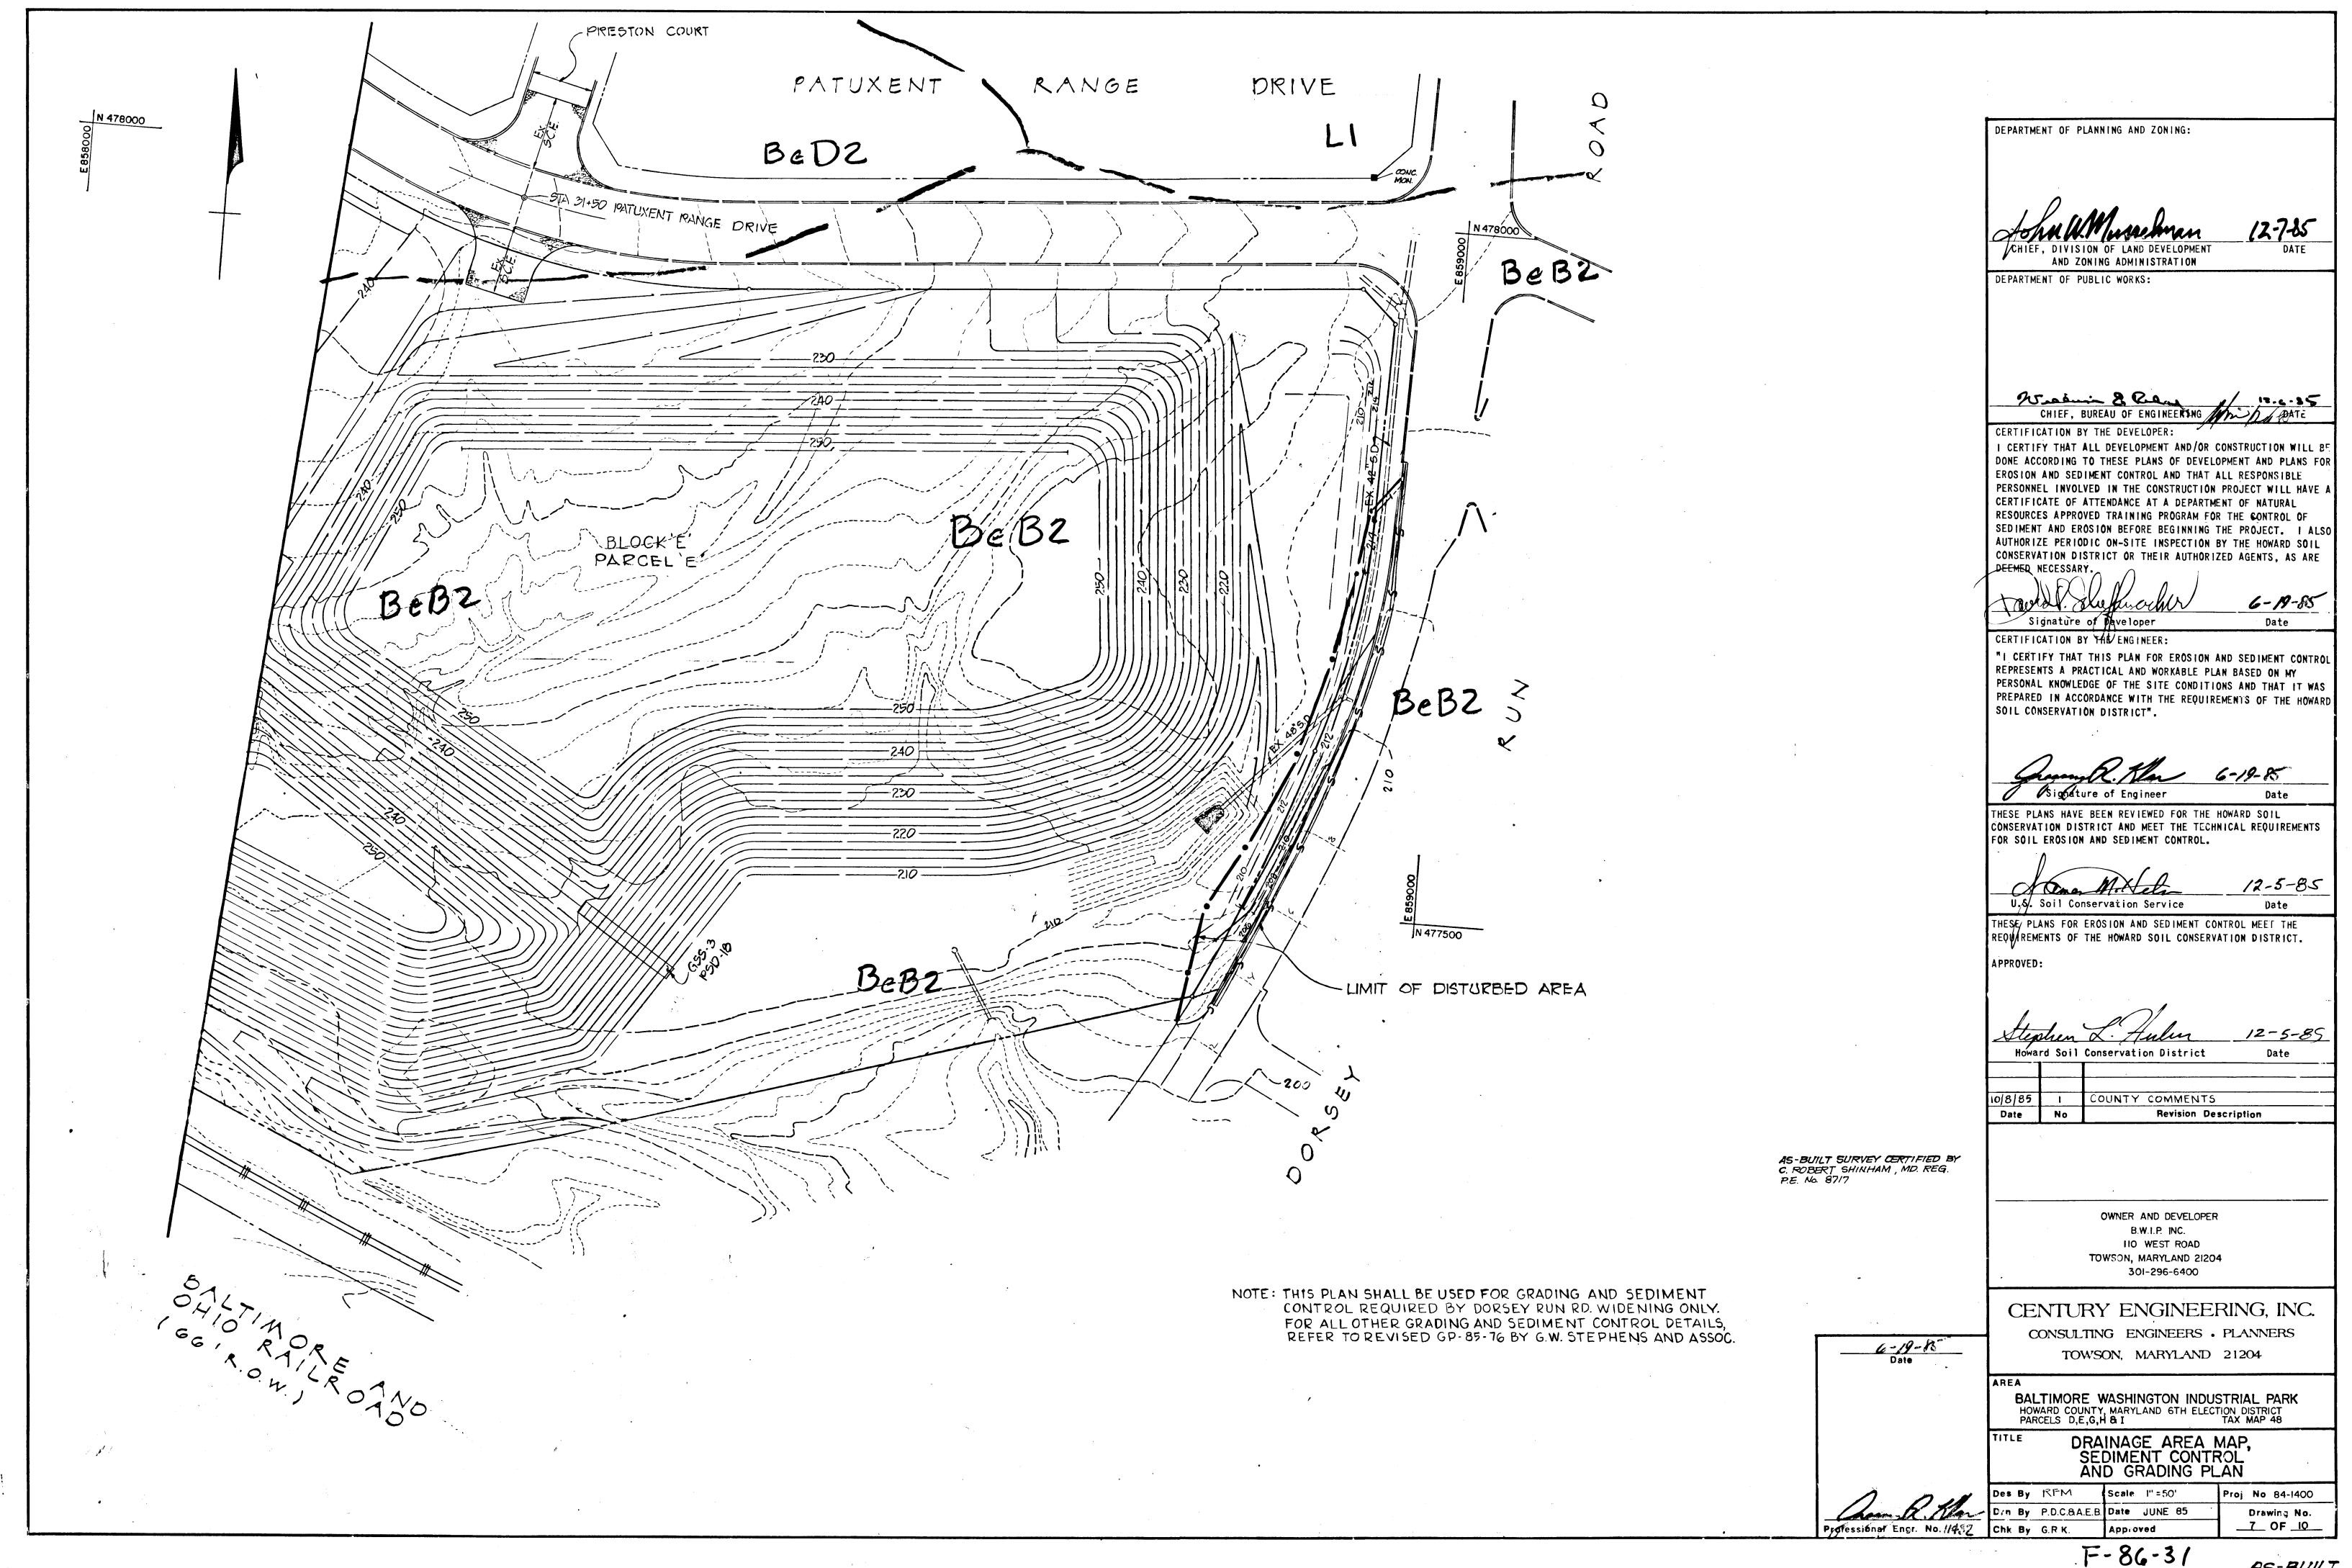
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AS-BUILT



### CONSTRUCTION NOTES FOR FABRICATED SILT FENCE

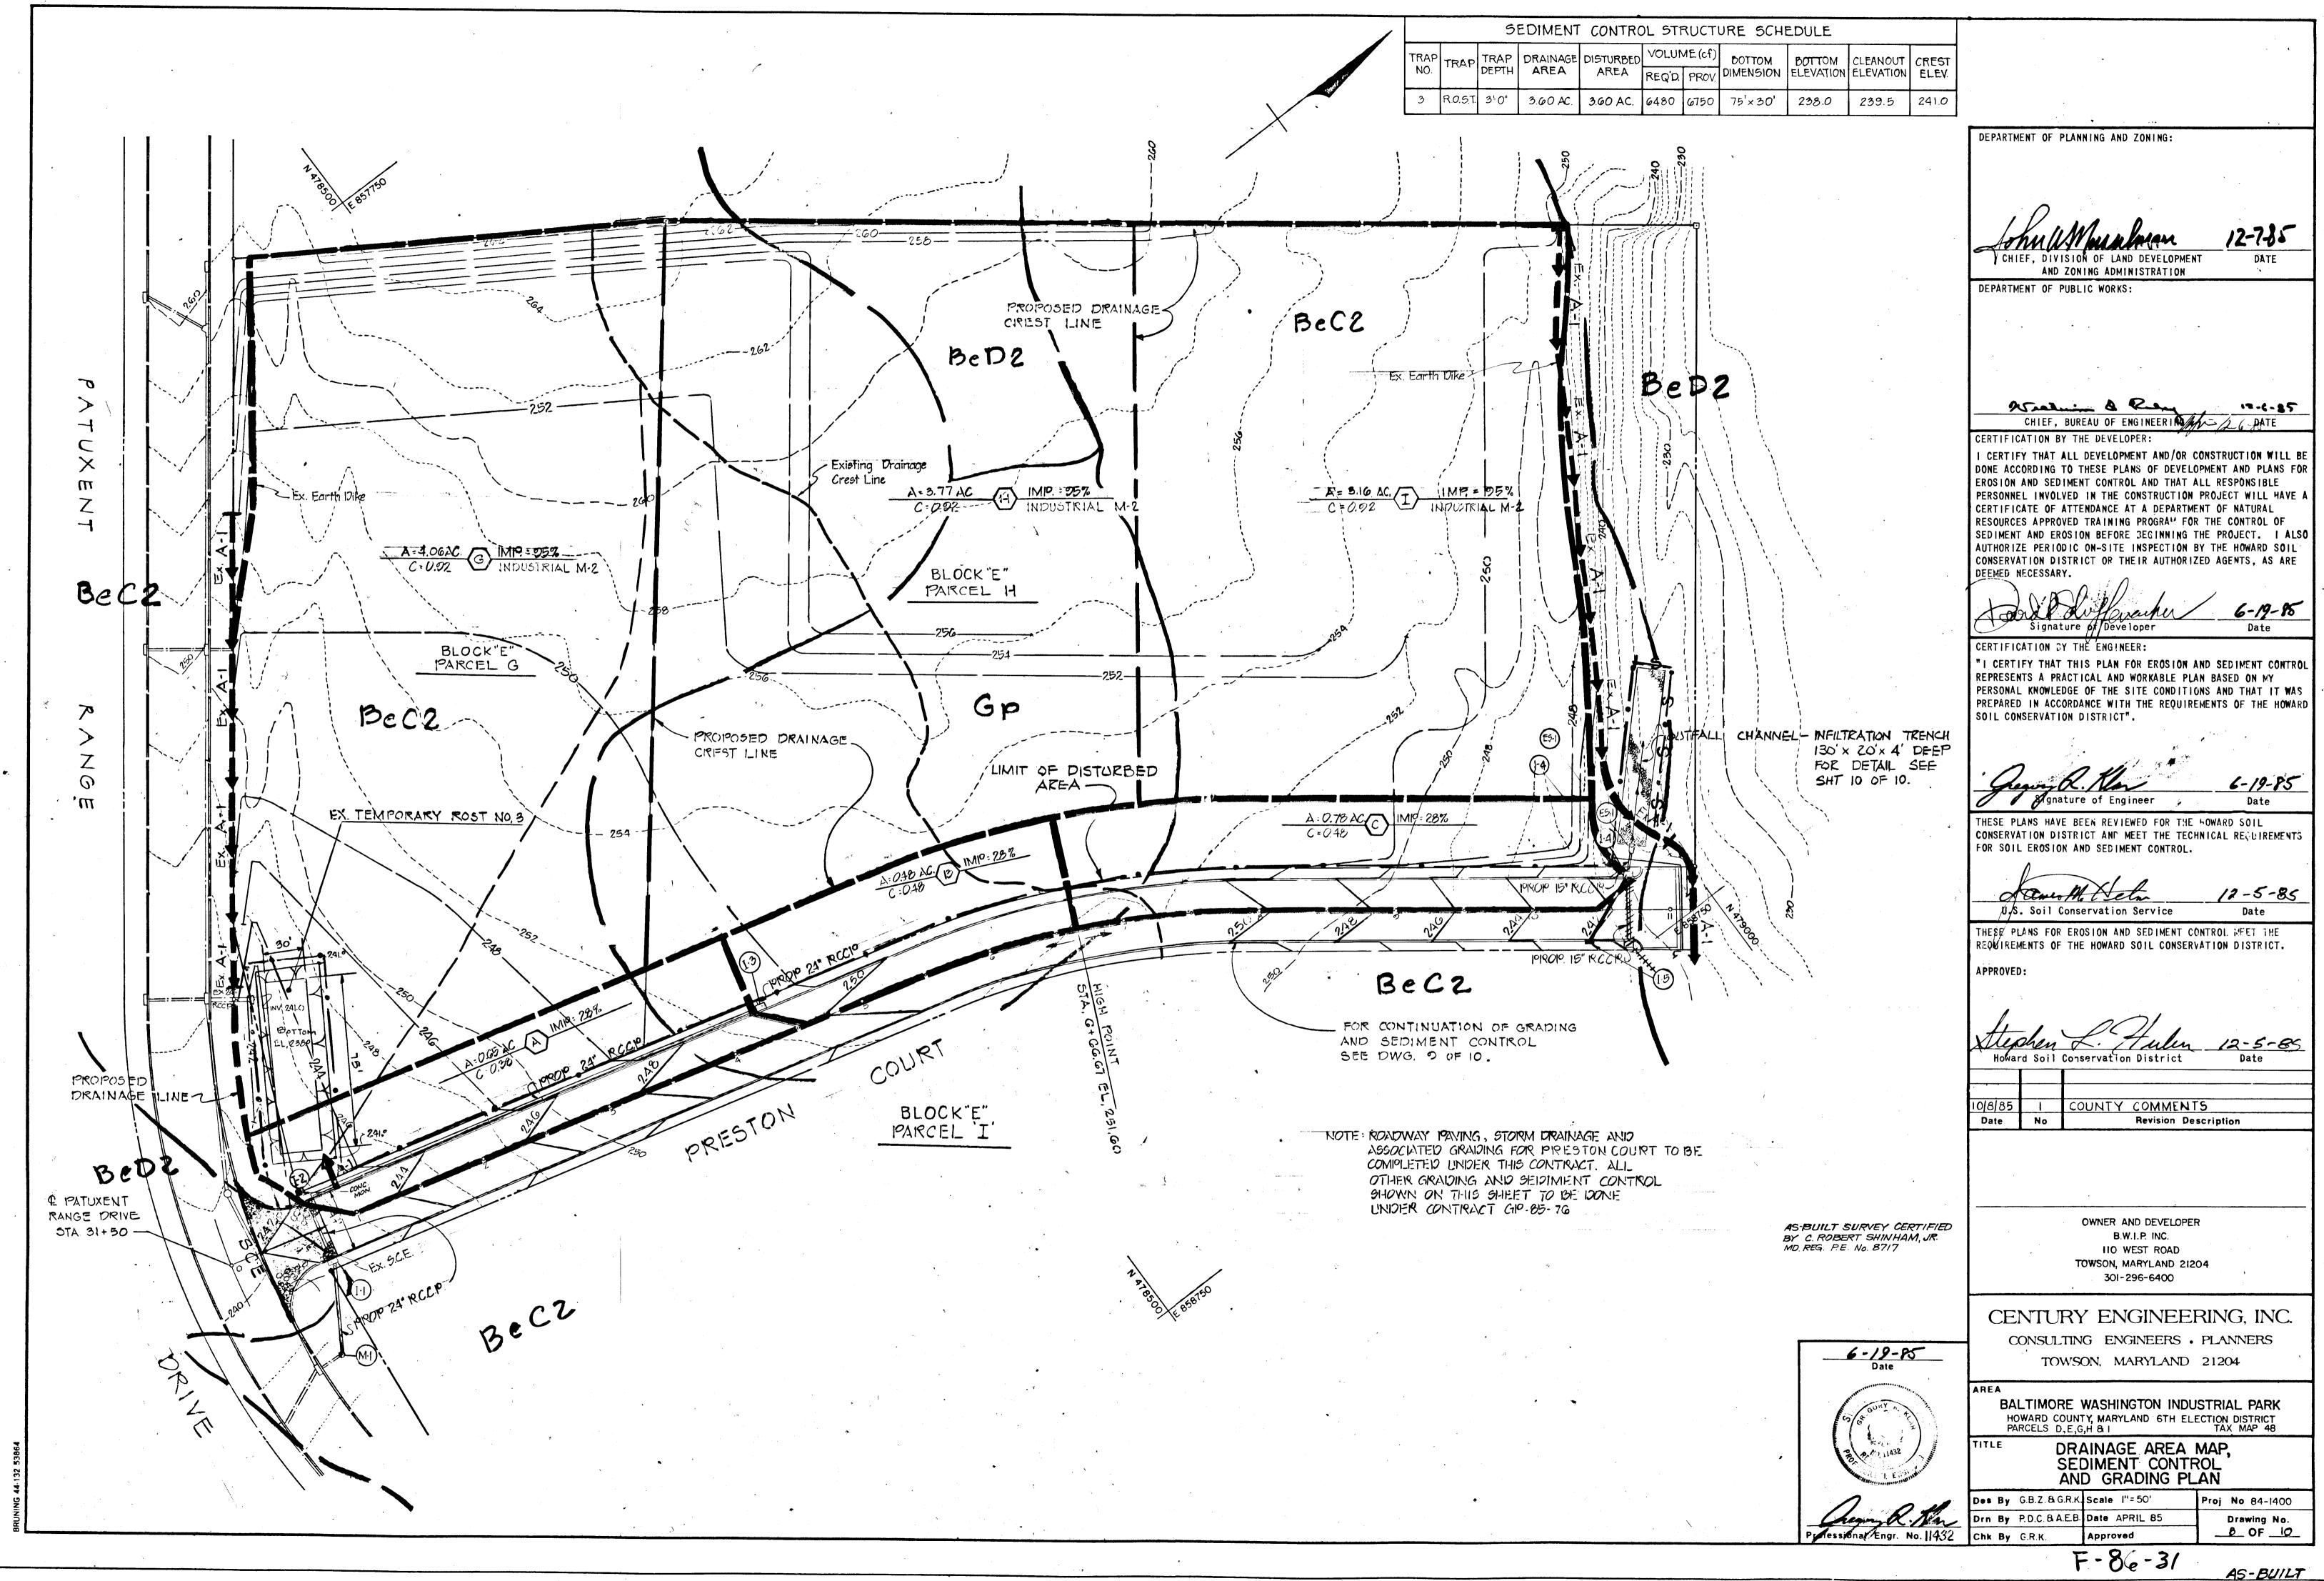- 1. Noven wire fence to be fastened securely to fence posts with wire ties or staples.
  - ES.
- 2. FILTER CLOTH TO BE FASTENED SECURELY TO WOVEN WIRE FENCE WITH TIES SPACED EVERY 24" AT TOP AND MID SECTION.
- FENCE: Moven wire, 14: Ga. 6" Max. Mesh Opening

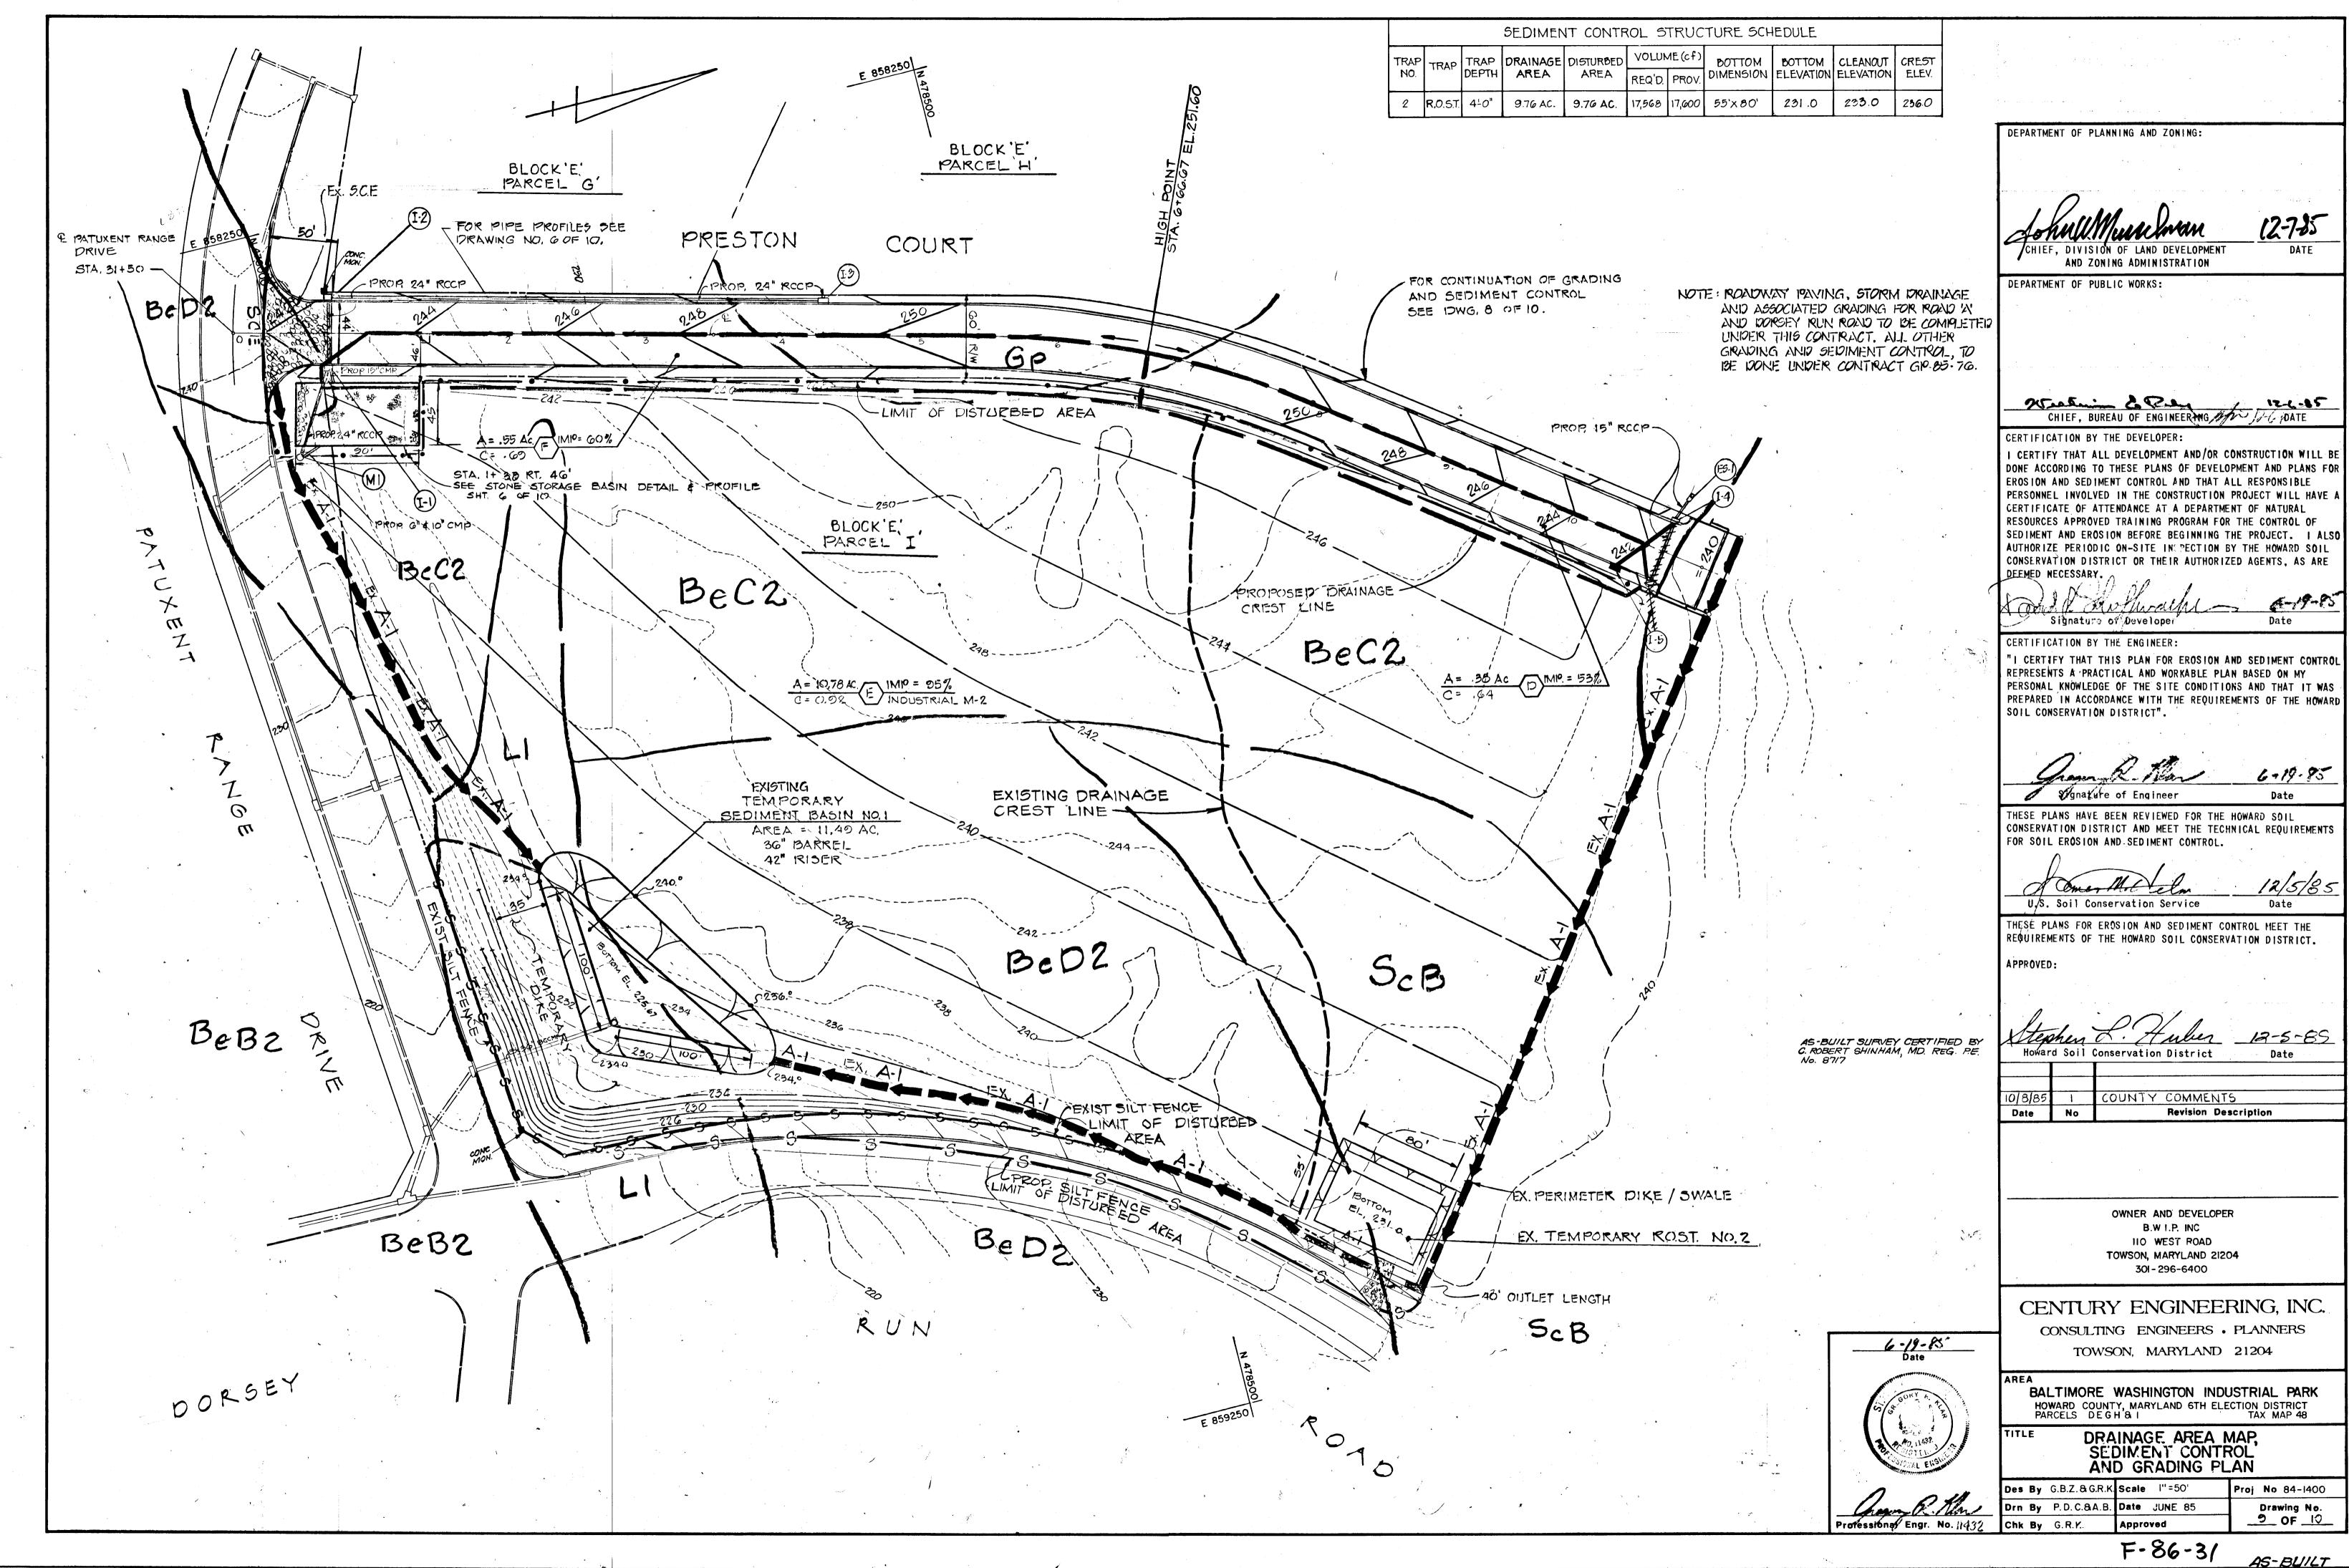POSTS: STEEL EITHER T OR U
TYPE OR 2" HARDWOOD

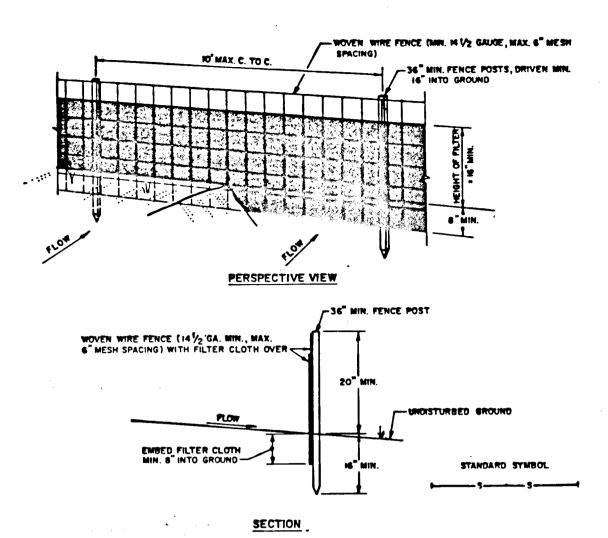- WHEN TWO SECTIONS OF FILTER CLOTH ADJOIN EACH OTHER THEY SHALL BE OVER-LAPPED BY SIX INCHES AND FOLDED.
- MIRAFI 100X, STABI-LINKA 1140N OR APPROVE EQUAL
- 4. Maintenance shall be performed as NEEDED AND MATERIAL REMOVED WHEN BULGES DEVELOP IN THE SILT FENCE.
- PREFABRICATED UNIT: GEOFAB, ENVIROFENCE, OR APPROVED

SILT FENCE DETAIL

NO SCALE

# TEMPORARY SEEDING

APPLY TO GRADED OR CLEARED AREAS LIKELY TO BE REDISTURBED WHERE A SHORT-TERM VEGETATIVE COVER IS NEEDED.

SEEDBED PREPARATION: LOOSEN UPPER THREE INCHES OF SOIL BY RAKING, DISCING OR OTHER ACCEPTABLE MEANS BEFORE SEEDING.

SOIL AMENDMENTS: APPLY 600 LBS. PER ACRE 10-10-10 FERTILIZER (14 LBS./1000 SQ. FT.)

SEEDING: FOR PERIODS MARCH I THRU APRIL 30 AND FROM AUGUST 15 THRU NOVEMBER 15, SEED WITH 2-1/2 BUSHEL PER ACRE OF ANNUAL RYE (3.2 LBS/1000 SQ.FT.). FOR THE PERIOD MAY I THRU AUGUST 14, SEED WITH 3 LBS. PER ACRE OF WEEPING LOVEGRASS (.07 LBS/1000 SQ. FT.) FOR THE PERIOD NOVEMBER 16 THRU FEBRUARY 28, PROTECT SITE BY APPLYING 2 TONS PER ACRE OF WELL ANCHORED STRAW MULCH AND SEED AS SOON AS POSSIBLE IN THE SPRING, OR USE SOD.

MULCHING: APPLY 1-1/2 TO 2 TONS PER ACRE (70 TO 90 LBS./1000 SQ.FT.) OF UNROTTED SMALL GRAIN STRAW IMMEDIATELY AFTER SEEDING. ANCHOR MULCH IMMEDIATELY AFTER APPLICATION USING MULCH ANCHORING TOOL OR 218 GAL. PER ACRE (5 GAL./1000 SQ.FT.) OF EMULSIFIED ASPHALT ON FLAT AREAS. ON SLOPES, 8 FT. OR HIGHER, USE 348 GAL. PER ACRE (8 GAL./1000 SQ.FT.) FOR ANCHORING.

REFER TO THE 1983 MARYLAND STANDARDS AND SPECIFICATIONS FOR SOIL EROSION AND SEDIMENT CONTROL FOR RATE AND METHODS NOT COVERED.

## PERMANENT SEEDING

APPLY TO GRADED OR CLEARED AREAS NOT SUBJECT TO IMMEDIATE FURTHER DISTURBANCE WHERE A PERMANENT LONG-LIVED VEGETATIVE COVER IS NEEDED.

SEEDBED PREPARATION: LOOSEN UPPER THREE INCHES OF SOIL BY RAKING, DISCING OR OTHER ACCEPTABLE MEANS BEFORE SEEDING.

SOIL AMENDMENTS: IN LIEU OF SOIL TEST RECOMMENDATIONS, USE ONE OF THE FOLLOWING SCHEDULES:


- 1. PREFERRED APPLY 2 TONS PER ACRE DOLOMITIC LIMESTONE (92 LBS./1000 SQ.FT.) AND 600 LBS. PER ACRE 10-10-10 FERTILIZER (14 LBS./1000 SQ.FT.) BEFORE SEEDING. BARROW OR DISC INTO UPPER THREE INCHES OF SOIL. AT TIME OF SEEDING, APPLY 400 LBS. PER ACRE 30-0-0 UREAFORM FERTILIZER (9 LBS./1000 SQ.FT.).
- 2. ACCEPTABLE APPLY 2 TONS PER ACRE DOLOMITIC LIMESTONE (92 LBS./1000 SQ.FT.) AND 1000 LBS. PER ACRE 10-10-10 FERTILIZER (23 LBS./1000 SQ.FT.) BEFORE SEEDING. BARROW OR DISC INTO UPPER THREE INCHES OF SOIL.

SEEDING - FOR THE PERIODS MARCH I THRU APRIL 30, AND AUGUST I THRU OCTOBER 15, SEED WITH 60 LBS. PER ACRE (I.4 LBS./1000 SQ.FT.) OF KENTUCKY 31 TALL FESCUE. FOR THE PERIOD MAY I THRU JULY 31, SEED WITH 60 LBS. KENTUCKY 31 TALL FESCUE PER ACRE AND 2 LBS. PER ACRE (.05 LBS./1000 SQ.FT.) OF WEEPING LOVEGRASS. DURING THE PERIOD OF OCTOBER 16 THRU FEBRUARY 28, PROTECT SITE BY: OPTION (I) 2 TONS PER ACRE OF WELL ANCHORED STRAW MULCH AND SEED AS SOON AS POSSIBLE IN THE SPRING. OPTION (2) USE SOD. OPTION (3) SEED WITH 60 LBS./ACRE KENTUCKY 31 TALL FESCUE AND MULCH WITH 2 TONS/ACRE WELL ANCHORED STRAW.

MULCHING - APPLY I-1/2 TO 2 TONS PER ACRE (70 TO 90 LBS./1000 SQ.FT.) OF UNROTTED SMALL GRAIN ANCHOR MULCH IMMEDIATELY AFTER APPLICATION USING MULCH

MULCHING - APPLY 1-1/2 TO 2 TONS PER ACRE (70 TO 90 LBS./1000 SQ.FT.) OF UNROTTED SMALL GRAIN STRAW IMMEDIATELY AFTER SEEDING. ANCHOR MULCH IMMEDIATELY AFTER APPLICATION USING MULCH ANCHORING TOOL OR 218 GALLONS PER ACRE (5 GAL./1000 SQ.FT.) OF EMULSIFIED ASPHALT ON FLAT AREAS. ON SLOPES 8 FT. OR HIGHER, USE 348 GALS. PER ACRE (8 GAL./1000 SQ.FT.) FOR ANCHORING.

MAINTENANCE - INSPECT ALL SEEDED AREAS AND MAKE NEEDED REPAIRS, REPLACEMENTS AND RESEEDINGS.

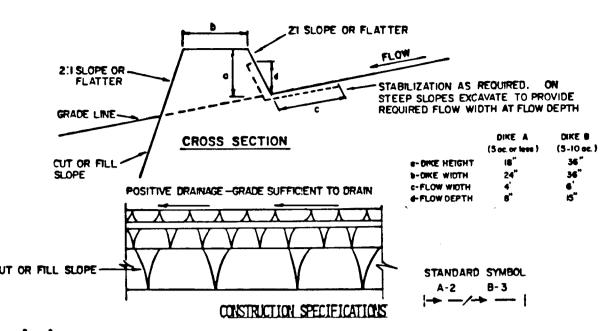

1. ALL DIKES SHALL BE COMPACTED BY EARTH-MOVING EQUIPMENT.
2. ALL DIKES SHALL HAVE POSITIVE DRAINAGE TO AN OUTLET.
3. TOP WIDTH MAY BE WIDER AND SIDE SLOPES MAY BE FLATTER IF DESIRED TO FACILITATE CROSSING BY CONSTRUCTION TRAFFIC

- CROSSING BY CONSTRUCTION TRAFFIC.

  4. FIELD LOCATION SHOULD BE ADJUSTED AS NEEDED TO UTILIZE A STABILIZED SAFE OUTLET.

  5. EARTH DIKES SHALL HAVE AN OUTLET THAT FUNCTIONS WITH A MINIMUM OF EROSION. PUNOFF SHALL BE CONVEYED TO A SEDIMENT TRAPPING DEVICE SUCH AS A SEDIMENT TRAP OR SEDIMENT BASIN WHERE EITHER THE DIKE CHANNEL OR THE DRAINAGE AREA ABOVE THE DIKE ARE NOT
- 6. STABILIZATION SHALL BE: (A) IN ACCORDANCE WITH STANDARD SPECIFICATIONS FOR SEED AND STRAW MULCH OR STRAW MULCH IF NOT IN SEEDING SEASON, (B) FLOW CHANNEL AS PER

### FLOW CHANNEL STABILIZATION

IVPE OF IREAIMENT	CHANNEL GRADE	DIKE A	DIKE B
1	.5-3.07	SEED AND STRAW MULCH	SEED AND STRAW MULCH
2	3.1-5.0%	SEED AND STRAW MULCH	SEED USING JUTE, OR EXCELSION; SOD; 2" STONE
3 .	5.1-8.0%	SEED WITH JUTE, OR SOD; 2" STONE	LINED RIP-RAP 4-8"
4	8.1-20%	LINED RIP-RAP 4-8"	ENGINEERING DESIGN
A. STONE TO	BE 2 INCH STONE.	OR RECYCLED CONCRETE EQUIVALENT.	IN A LAYER AT LEAST 3

- A. STONE TO BE 2 INCH STONE, OR RECYCLED CONCRETE EQUIVALENT, IN A LAYER AT LEAST 3 INCHES IN THICKNESS AND BE PRESSED INTO THE SOIL WITH CONSTRUCTION EQUIPMENT.

  B. RIP-RAP TO BE 4-8 INCHES IN A LAYER AT LEAST 8 INCHES THICKNESS AND PRESSED INTO
- C. APPROVED EQUIVALENTS CAN BE SUBSTITUTED FOR ANY OF THE ABOVE MATERIALS.

EARTH DIKE DETAIL

NO SCALE


## SEDIMENT CONTROL NOTES

- 1. A MINIMUM OF 24 HOURS NOTICE MUST BE GIVEN TO THE HOWARD COUNTY OFFICE OF INSPECTIONS AND PERMITS PRIOR TO THE START OF ANY CONSTRUCTION (992-2437).
- 2. ALL VEGETATIVE AND STRUCTURAL PRACTICES ARE TO BE INSTALLED ACCORDING TO THE PROVISIONS OF THIS PLAN AND ARE TO BE IN CONFORMANCE WITH THE 1983 MARYLAND STANDARDS AND SPECIFICATIONS FOR SOIL EROSION AND SEDIMENT CONTROL.
- 3. FOLLOWING INITIAL SOIL DISTURBANCE OR REDISTURBANCE, PERMANENT OR TEMPORARY STABILIZATION SHALL BE COMPLETED WITHIN: a) 7 CALENDAR DAYS FOR ALL PERIMETER SEDIMENT CONTROL
  STRUCTURES, DIKES, PERIMETER SLOPES AND ALL SLOPES GREATER THAN 3:1, b) 14 DAYS AS TO
  ALL OTHER DISTURBED OR GRADED AREAS ON THE PROJECT SITE.
- 4. ALL SEDIMENT TRAPS/BASINS SHOWN MUST BE FENCED AND WARNING SIGNS POSTED AROUND THEIR PERIMETER IN ACCORDANCE WITH VOL. 1, CHAPTER 12, OF THE HOWARD COUNTY DESIGN MANUAL, STORM DRAINAGE.
- 5. ALL DISTURBED AREAS MUST BE STABILIZED WITHIN THE TIME PERIOD SPECIFIED ABOVE IN ACCORDANCE WITH THE 1983 MARYLAND STANDARDS AND SPECIFICATIONS FOR SOIL EROSION AND SEDIMENT CONTROL FOR PERMANENT SEEDINGS (SEC. 51) SOD (SEC. 54), TEMPORARY SEEDING (SEC. 50) AND MULCHING (SEC. 52). TEMPORARY STABILIZATION WITH MULCH ALONE CAN ONLY BE DONE WHEN RECOMMENDED SEEDING DATES DO NOT ALLOW FOR PROPER GERMINATION AND ESTABLISHMENT OF GRASSES.
- 6. ALL SEDIMENT CONTROL STRUCTURES ARE TO REMAIN IN PLACE AND ARE TO BE MAINTAINED IN OPERATIVE CONDITION UNTIL PERMISSION FOR THEIR REMOVAL HAS BEEN OBTAINED FROM THE HOWARD COUNTY SEDIMENT CONTROL INSPECTOR.
- 7. SITE ANALYSIS:

OTTE ANALISTO.	
TOTAL AREA OF SITE	2.02 ACRES
AREA DISTURBED	
AREA TO BE ROOFED OR PAVED	<u></u> _ Acres
AREA TO BE VEGETATIVELY STABILIZED	1.00 ACRES
TOTAL CUT	1015 CU.YDS
TOTAL FILL	

- OFFSITE WASTE/BORROW AREA LOCATION

  8. ANY SEDIMENT CONTROL PRACTICE WHICH IS DISTURBED BY GRADING ACTIVITY FOR PLACEMENT OF UTILITIES MUST BE REPAIRED ON THE SAME DAY OF DISTURBANCE.
- 9. ADDITIONAL SEDIMENT CONTROLS MUST BE PROVIDED, IF DEEMED NECESSARY BY THE HOWARD COUNTY DPW SEDIMENT CONTROL INSPECTOR.

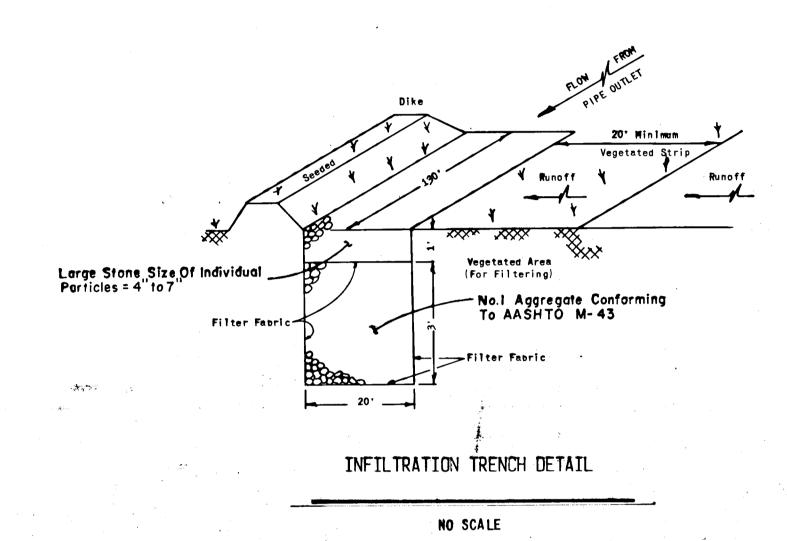


# SEQUENCE OF CONSTRUCTION

- I. OBTAIN GRADING PERMIT.
- 2. NOTIFY THE DPW SEDIMENT CONTROL INSPECTOR FOR HOWARD COUNTY 48 HOURS PRIOR TO THE START OF ANY CONSTRUCTION.
- 3. REFER TO APPROVED GP 85-76, FOR SEDIMENT CONTROL DEVICES THAT ARE TO BE MAINTAINED DURING CONSTRUCTION OF THIS CONTRACT.
- 4. FOR PROPOSED IMPROVEMENTS ALONG DORSEY RUN ROAD:
  - A. INSTALL SILT FENCE AS INDICATED ON THE PLANS.
  - B. PRIOR TO BEGINNING GRADING OPERATIONS ON DORSEY RUN ROAD BETWEEN STATIONS 101+ AND 106+ THE EARTH DIKE, TEMPORARY R.O.S.T. NO. 2, TEMPORARY SEDIMENT BASIN NO. 1 AND SILT FENCE INDICATED TO BE INSTALLED UNDER CONTRACT GP 85-76 SHALL BE IN PLACE.
  - C. PERFORM GRADING OPERATIONS AND STABILIZE ALL DISTURBED AREAS NOT TO BE PAVED.
- D. REMOVE SILT FENCE AND CONSTRUCT CURB & GUTTER AND PAVING.
- 5. FOR PROPOSED IMPROVEMENTS ALONG PRESTON COURT
  - A. PRIOR TO BEGINNING WORK ON PRESTON COURT, PERIMETER CONTROLS, TRAPS, BASINS AND SILT FENCES FOR PARCELS G,H & I INDICATED TO BE INSTALLED UNDER CONTRACT GP 85-76 SHALL BE IN PLACE.
  - B. INSTALL PROPOSED STORM DRAINAGE. PROTECT PROPOSED INLETS AND PIPES FROM RECEIVING STORMWATER UNTIL PARCEL G,H & PRESTON COURT RIGHT OF WAY IS STABILIZED.
  - C. FINE GRADE, CONSTRUCT CURB & GUTTER AND PAVE ROAD

6. \ FOR XPROPOSED / IMPROVEMENTS WITHIN PARCEL 'BY: / \ X X X
or your not observe that not called a server of the server
A. REGRADE PROPOSED DITCH AND INSTALL BYPRAP PROVIDE TEMPORARY STREAM
THE PART OF THE CONSTRUCT ON
X X DIVERBION DURING CONSTRUCTION. X X X X X X X
M. INSTALL 24" O.M. D. AT CONNECTION TO EXISTING EULVERT, MAINTAIN
A. MISSALL OF E.M. J. A. CONNECTION TO SEA 131 ING COLLEGE, INVANIATION
TEMPORARY STREAM DIVERSION WHILL CONNECTION IS COMPLETED.
XC. XLNSTALL/SULT/PENCE. XXXXXXXXXXXXXXXXXXXXXXXXXXXXXXXXXXXX
O. GRADE PARCEL TO AS SHOWN AND INSTALL EARTH OIKE, FULL TEMP STREAM DIVERSION

7. STABILIZE ALL INACTIVE BUT DISTURBED OR FINISH GRADED AREAS WITHIN 14 DAYS. CONTRACTOR SHALL STABILIZE SUCH AREAS IN ACCORDANCE WITH THE TEMPORARY OR PERMANENT SEEDING NOTES AS APPROPRIATE.

8. UPON STABILIZATION OF ALL DISTURBED AREAS AND AUTHORIZATION BY THE SEDIMENT CONTROL INSPECTOR, REMOVE REMAINING SEDIMENT CONTROL DEVICES.

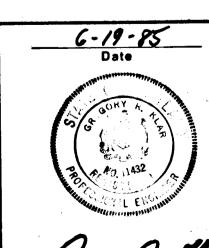

AND ZONING ADMINISTRATION DEPARTMENT OF PUBLIC WORKS: CHIEF. BUREAU OF ENGINEERING CERTIFICATION BY THE DEVELOPER: CERTIFY THAT ALL DEVELOPMENT AND/OR CONSTRUCTION WILL B OONE ACCORDING TO THESE PLANS OF DEVELOPMENT AND PLANS FOR PERSONNEL INVOLVED IN THE CONSTRUCTION PROJECT WILL HAVE A ERTIFICATE OF ATTENDANCE AT A DEPARTMENT OF NATURAL ESOURCES APPROVED TRAINING PROGRAM FOR THE CONTROL OF SEDIMENT AND EROSION BEFORE BEGINNING THE PROJECT. I ALSO UTHORIZE PERIODIC ON-SITE INSPECTION BY THE HOWARD SOIL CONSERVATION DISTRICT OR THEIR AUTHORIZED AGENTS, AS ARE DEEMED NECESSARY. Signature Tof Developer Date I CERTIFY THAT THIS PLAN FOR EROSION AND SEDIMENT CONTROL REPRESENTS A PRACTICAL AND WORKABLE PLAN BASED ON MY PERSONAL KNOWLEDGE OF THE SITE CONDITIONS AND THAT IT WAS PREPARED IN ACCORDANCE WITH THE REQUIREMENTS OF THE HOWARD SOIL CONSERVATION DISTRICT". 6-19-85 Date THESE PLANS HAVE BEEN REVIEWED FOR THE HOWARD SOIL CONSERVATION DISTRICT AND MEET THE TECHNICAL REQUIREMENTS FOR SOIL EROSION AND SEDIMENT CONTROL. 12-5-85 // U.S. Soil Conservation Service Date THESE PLANS FOR EROSION AND SEDIMENT CONTROL MEET THE REQUIREMENTS OF THE HOWARD SOIL CONSERVATION DISTRICT. Howard Soil Conservation District COUNTY COMMENTS Revision Description Date

Company and the contract of th

EPARTMENT OF PLANNING AND ZONING:

F-86-31

OWNER AND DEVELOPER

B.W.I.P. INC.

110 WEST ROAD

TOWSON, MARYLAND 21204

301-296-6400

CENTURY ENGINEERING, INC.

CONSULTING ENGINEERS • PLANNERS

TOWSON, MARYLAND 21204

SEDIMENT CONTROL DETAILS

Scale AS SHOWN

Date JUNE 85

PARCELS D,E,G,H&I

TITLE

Des By G.B.Z.

Drn By A.E.B.

Chk By G.R.K.

BALTIMORE WASHINGTON INDUSTRIAL PARK

HOWARD COUNTY, MARYLAND 6TH ELECTION DISTRICT

AS-BUILT

TAX MAP 48

Proj No 84-1400

Drawing No.

\_10\_ OF \_10\_