


| SHEET INDEX |                                                    |
|-------------|----------------------------------------------------|
| NO.         | DESCRIPTION                                        |
| 1           | TITLE SHEET                                        |
| 2           | PLAN AND PROFILE OF ATHENA DRIVE                   |
| 3           | PLAN OF MANOR LANE, DETAILS & STORM DRAIN PROFILES |
| 4           | GRADING, SEDIMENT CONTROL & DRAINAGE AREA MAP      |
| 5           | SEDIMENT CONTROL DETAILS                           |

# ROADWAY & STORM DRAIN

# CARTHAGE MANOR

## 2 ND ELECTION DISTRICT

## HOWARD COUNTY, MARYLAND

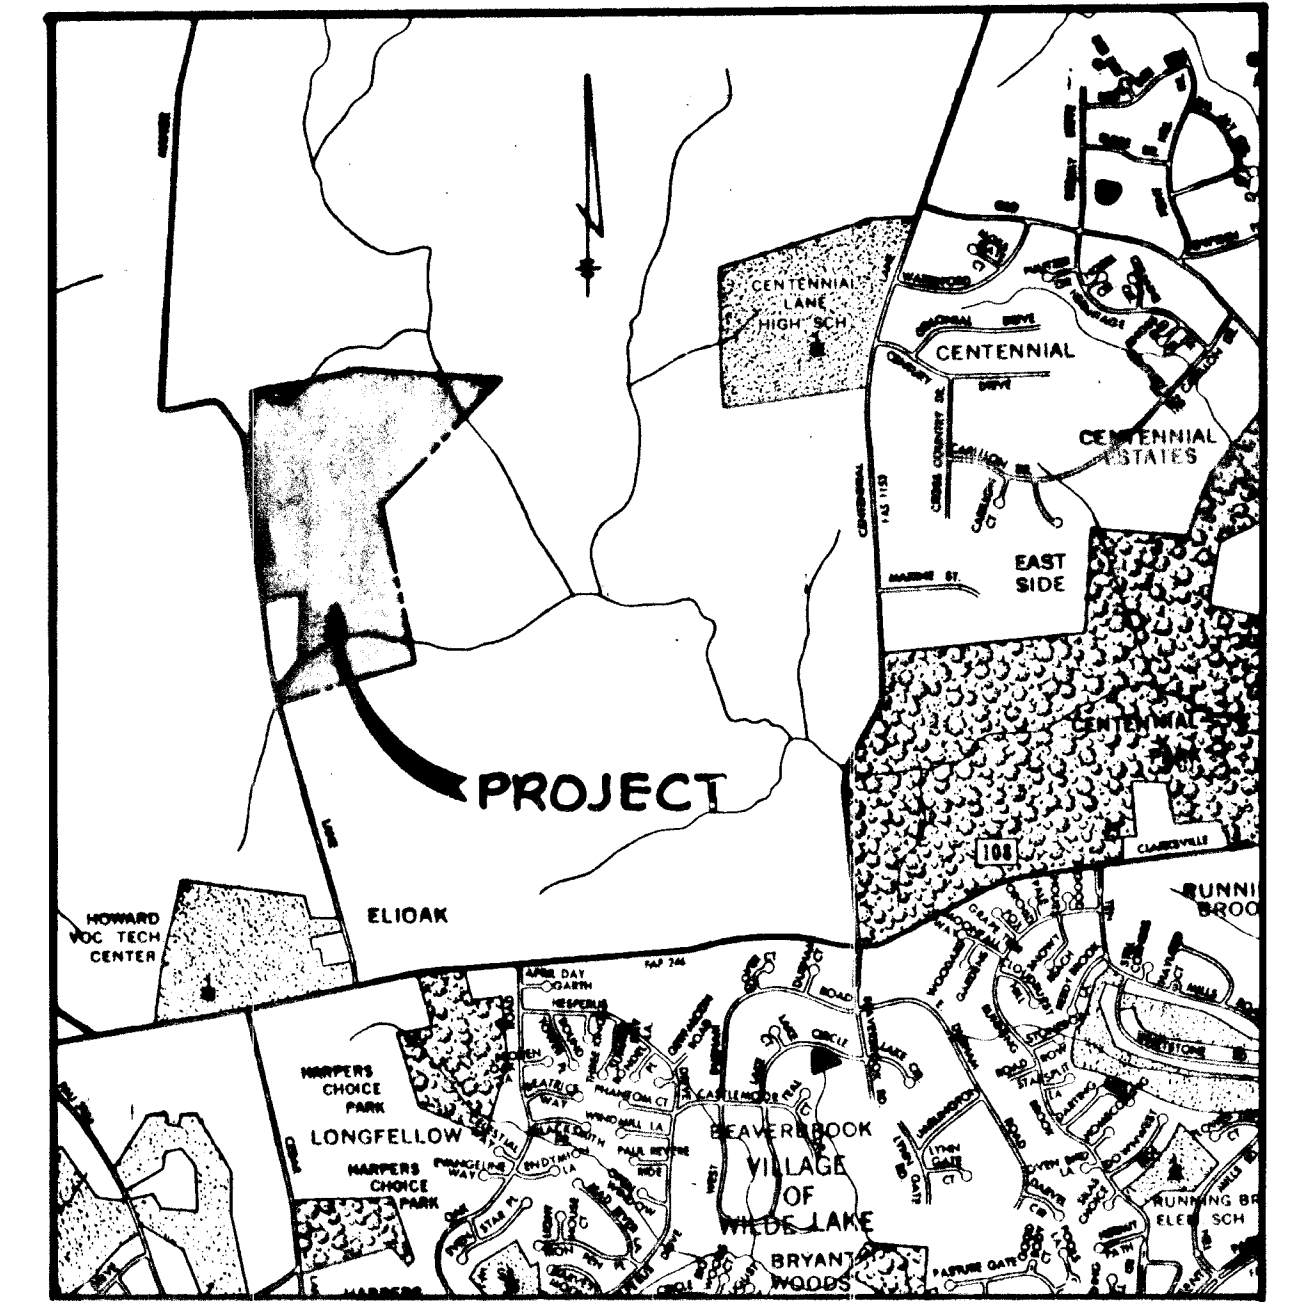


**VICINITY MAP**  
SCALE: 1" = 2,000'

**GENERAL NOTES**

1. ALL WORK SHALL BE PERFORMED IN ACCORDANCE WITH THE HOWARD COUNTY ROAD CONSTRUCTION CODE STANDARD SPECIFICATIONS.
2. APPROXIMATE LOCATION OF EXISTING UTILITIES ARE SHOWN. THE CONTRACTOR SHALL TAKE ALL NECESSARY PRECAUTIONS TO PROTECT THE EXISTING UTILITIES AND MAINTAIN UNINTERRUPTED SERVICE. ANY DAMAGE INCURRED DUE TO CONTRACTOR'S OPERATION SHALL BE REPAIRED IMMEDIATELY AT THE CONTRACTOR'S EXPENSE.
3. THE CONTRACTOR SHALL TEST PIT EXISTING UTILITIES, WHERE DIRECTED BY THE ENGINEER, A MINIMUM OF TWO (2) WEEKS IN ADVANCE OF CONSTRUCTION OPERATIONS.
4. CONTRACTOR TO NOTIFY THE FOLLOWING UTILITIES AT LEAST FIVE (5) DAYS BEFORE STARTING WORK SHOWN ON THESE DRAWINGS.

|                                                       |                    |
|-------------------------------------------------------|--------------------|
| BELL TELEPHONE SYSTEM                                 | 393-3649           |
| LONG DISTANCE CABLE DIVISION                          | 393-3553 OR 3554   |
| BALTIMORE GAS AND ELECTRIC COMPANY                    | 539-8000, EXT. 691 |
| HOWARD COUNTY BUREAU OF UTILITIES                     | 992-2366           |
| HOWARD COUNTY CONSTRUCTION/INSPECTION SURVEY DIVISION | 992-2417/2418      |
5. INSTALLATION OF TRAFFIC CONTROL DEVICES, MARKING, AND SIGNING SHALL BE IN ACCORDANCE WITH THE MANUAL OF UNIFORM TRAFFIC CONTROL DEVICES 1971 EDITION.
6. PIPE SHALL NOT BE INSTALLED BY THE CONTRACTOR UNTIL THE LENGTH CALLED FOR AT EACH STATION HAS BEEN APPROVED BY THE ENGINEER IN THE FIELD.
7. DESIGNED TRAFFIC SPEED IN ACCORDANCE WITH THE AMERICAN ASSOCIATION OF STATE HIGHWAY OFFICIAL STANDARDS: ATHENA DRIVE: 30 M.P.H.
8. ALL ELEVATIONS SHOWN ARE BASED ON U.S.C. AND G.S. MEAN SEA LEVEL DATUM 1929.
9. ALL FILL AREAS WITHIN ROADWAYS AND UNDER STRUCTURES TO BE COMPACTED TO A MINIMUM 95% COMPACTION.
10. ALL PIPE ELEVATIONS SHOWN ARE INVERT ELEVATIONS.
11. PROFILE STATIONS SHALL BE ADJUSTED AS NECESSARY TO CONFORM TO PLAN DIMENSIONS.
12. SUBJECT PROPERTY ZONED R PER 10-03-77 COMPREHENSIVE ZONING PLAN.

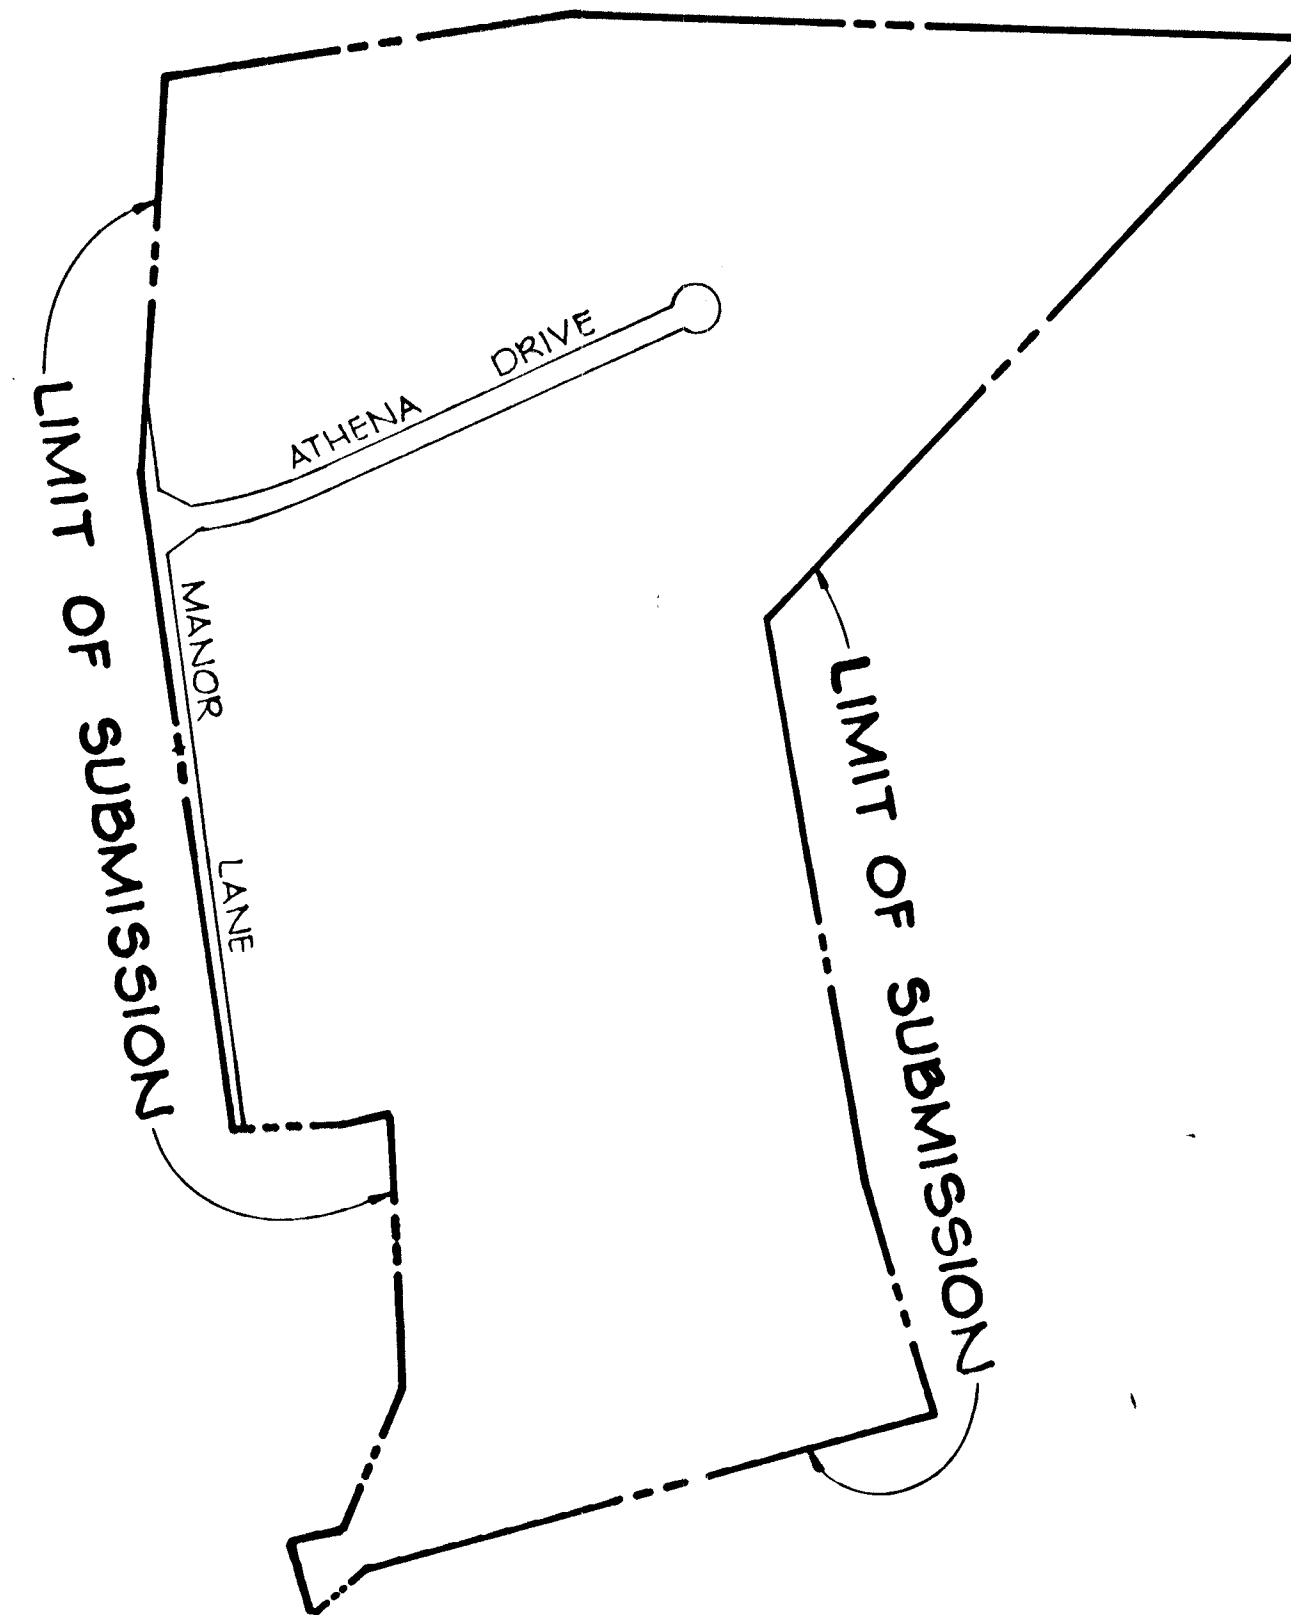

**PLAN**  
SCALE: 1" = 400'

APPROVED: HOWARD COUNTY DEPARTMENT OF PUBLIC WORKS  
 CHIEF, DIVISION OF LAND DEVELOPMENT AND ZONING ADMINISTRATION  
*John M. Mason* 4-28-81  
 DATE

APPROVED: HOWARD COUNTY DEPARTMENT OF PUBLIC WORKS  
 CHIEF, BUREAU OF ENGINEERING  
*William E. Ryan* 5/13/81  
 DATE

| DATE    | NO. | REVISION                                   |
|---------|-----|--------------------------------------------|
| 4-24-81 | 1   | REVISED AS PER H.C. COMMENTS DATED 5-25-81 |

OWNER/DEVELOPER  
 MANOR LANE ASSOCIATES  
 3606 BELAIR ROAD  
 BALTIMORE, MARYLAND 21236

PROJECT:  
**CARTHAGE MANOR**

AREA:  
 2<sup>ND</sup> ELECTION DISTRICT HOWARD COUNTY, MD  
 TAX MAP N<sup>o</sup> 23 PARCEL 2

TITLE:  
 TITLE SHEET

**Riemer - Tracy & Associates, Inc.**  
 8659 Baltimore National Pike  
 Ellicott City, Maryland 21043  
 (301) 481-2690  
 Land Planning, Design & Civil Engineering

DESIGNED BY: L.J.D.  
 DRAWN BY: T.E.S.  
 PROJECT NO: 0980  
 DATE: 1-30-81  
 SCALE: 1" = 400'  
 DRAWING NO. 1 OF 5

PROFESSIONAL ENGR. NO. 9566  
**F-81-80** APRIL 24, 1981

MARYLAND BLUEPRINT CO., INC.

# 900

**CURVE DATA**  
 FROM STA. 1+15.00 TO STA. 3+45.17  
 $\Delta = 17^\circ 35' 00''$   
 $R = 750.00'$   
 $L = 730.17'$   
 $T = 115.99'$   
 $Chd = N 72^\circ 02' 45'' E, 229.26'$

**CURVE(1) DATA**  
 $\Delta = 57^\circ 10' 00''$   
 $R = 35.00'$   
 $L = 31.87'$   
 $T = 17.14'$   
 $Chd = N 39^\circ 10' 10'' E, 30.70'$

**CURVE(2) DATA**  
 $\Delta = 284^\circ 20' 18''$   
 $R = 40.00'$   
 $L = 198.51'$   
 $T = 17.14'$   
 $Chd = N 24^\circ 44' 45'' W, 49.07'$

**CURVE(3) DATA**  
 $\Delta = 57^\circ 10' 00''$   
 $R = 35.00'$   
 $L = 31.87'$   
 $T = 17.14'$   
 $Chd = N 88^\circ 32' 41'' W, 30.70'$

NOTE:  
 RESIDENTIAL DRIVEWAY ENTRANCES SHALL BE INSTALLED IN ACCORDANCE WITH HOWARD COUNTY STANDARD DETAIL R-2.05

NOTE:  
 SLOPE PAVING AND GRADE AREA ALONG NORTHEAST EDGE TO PROVIDE POSITIVE DRAINAGE ACROSS INTERSECTION.

NOTE:  
 FOR CONTINUATION OF MANOR LANE WIDENING SEE SHEET NO. 3

MANOR LANE

ATHENA DRIVE

DRIVE

30' DRAINAGE, UTILITY AND FLOODPLAIN ACCESS EASEMENT



3'-0" GRASSSED SWALE

RIPRAP SEE DETAIL DRAWING NO. 3

28'-20" BCCMPA 16 Ga.

10' DRAINAGE EASEMENT

PLAN  
 Scale: 1"=50'

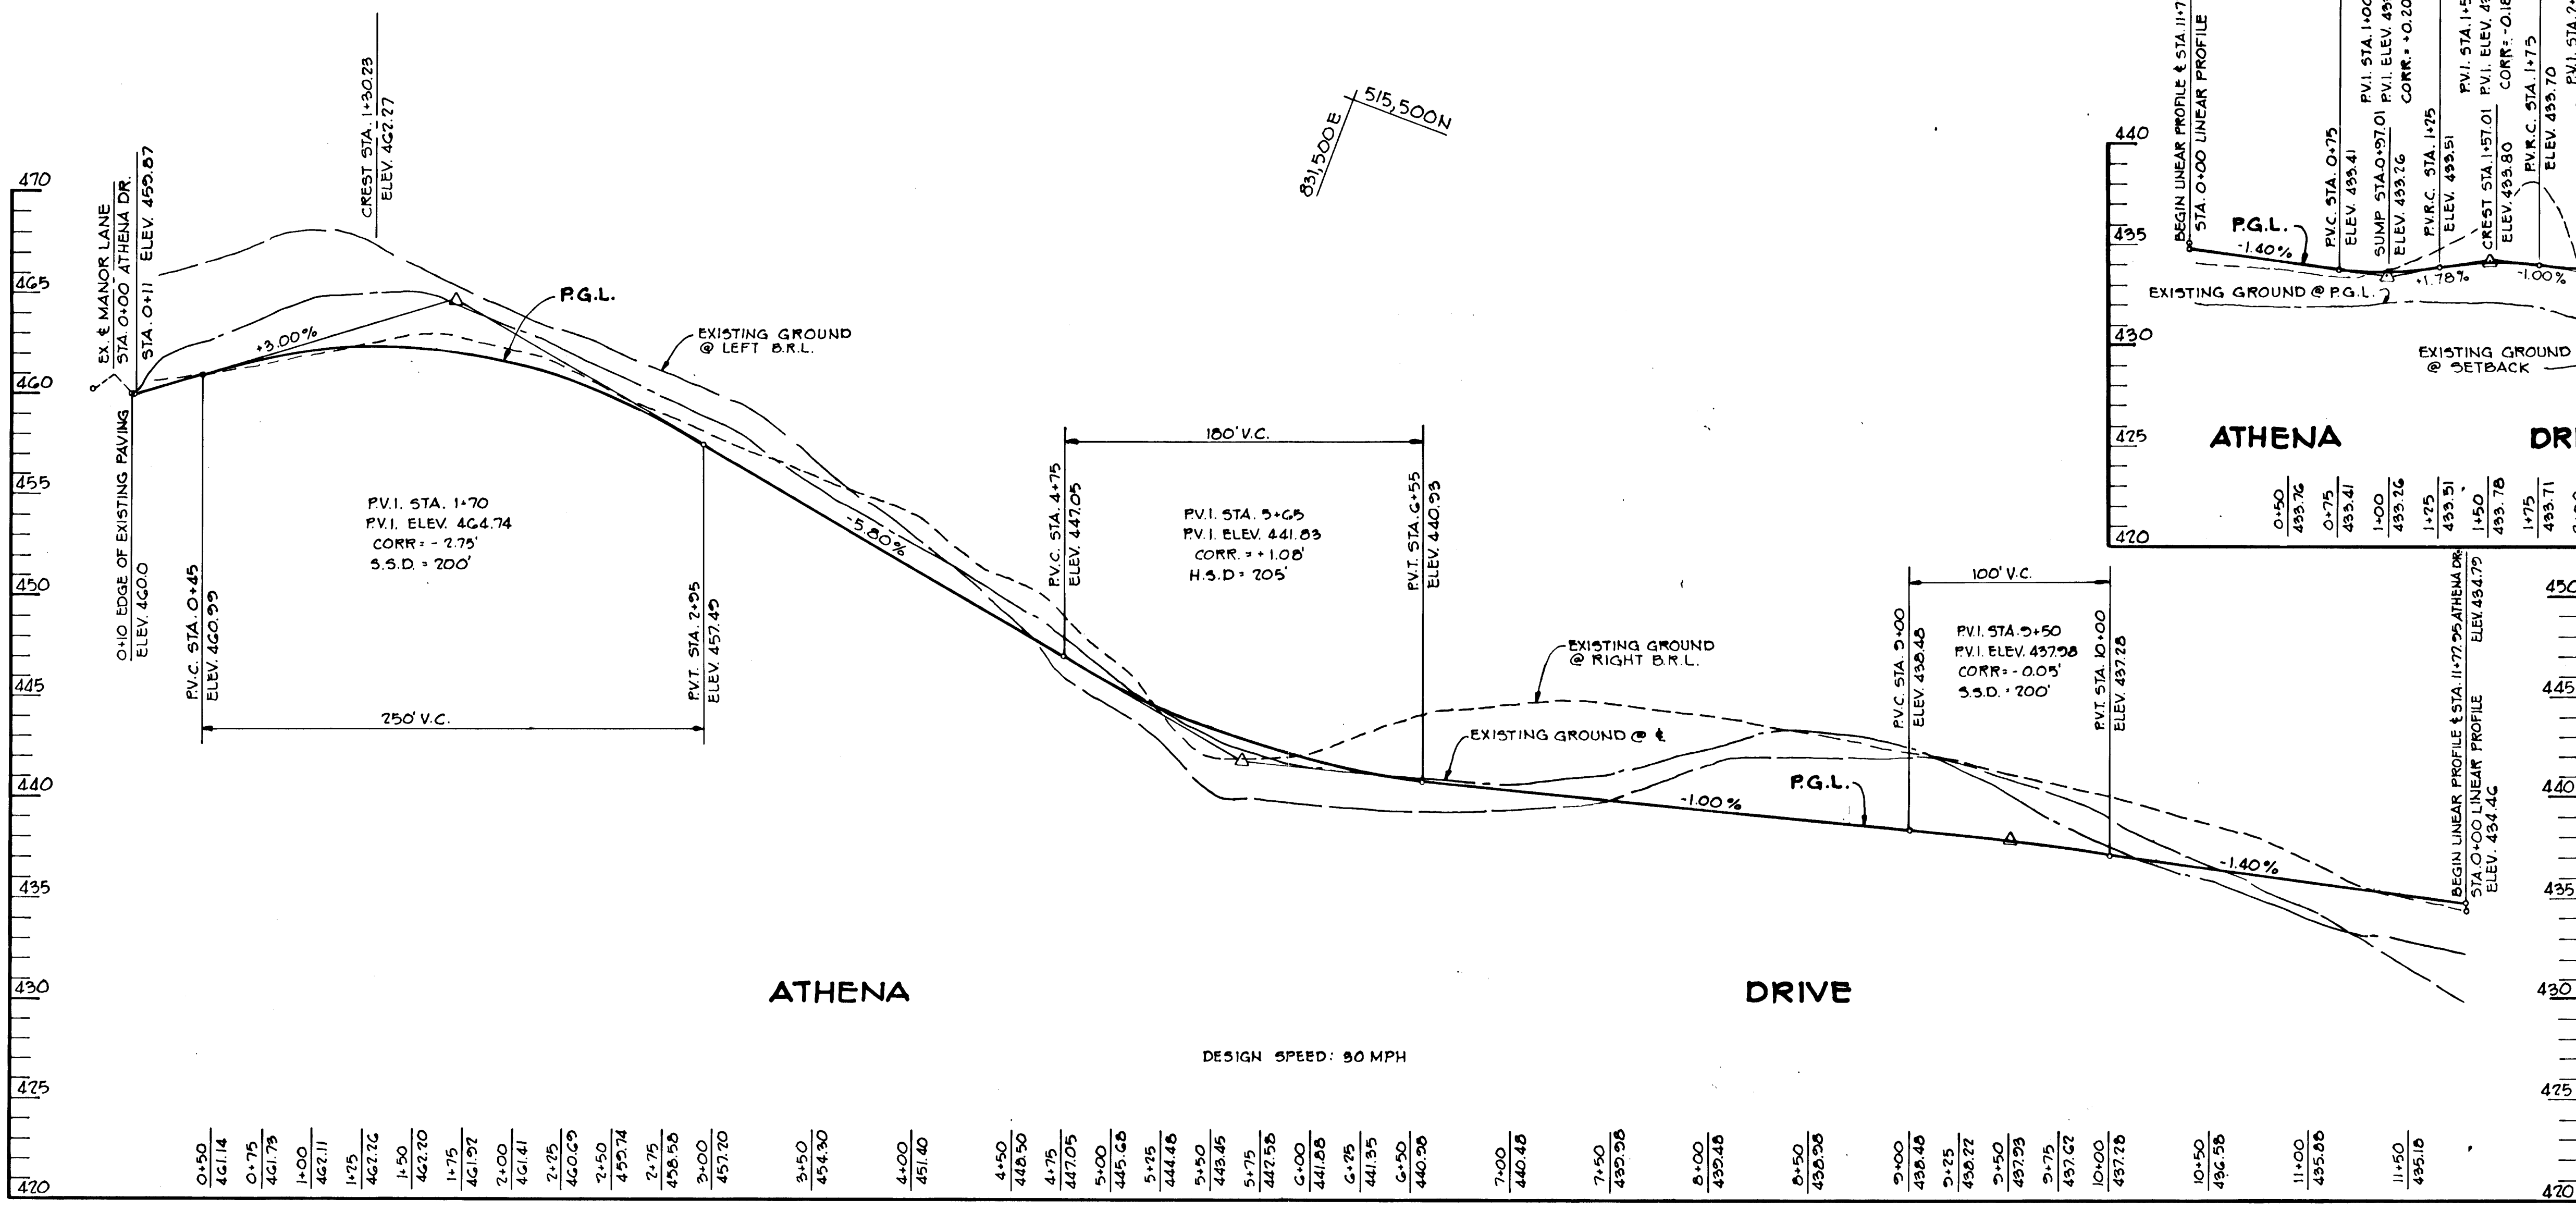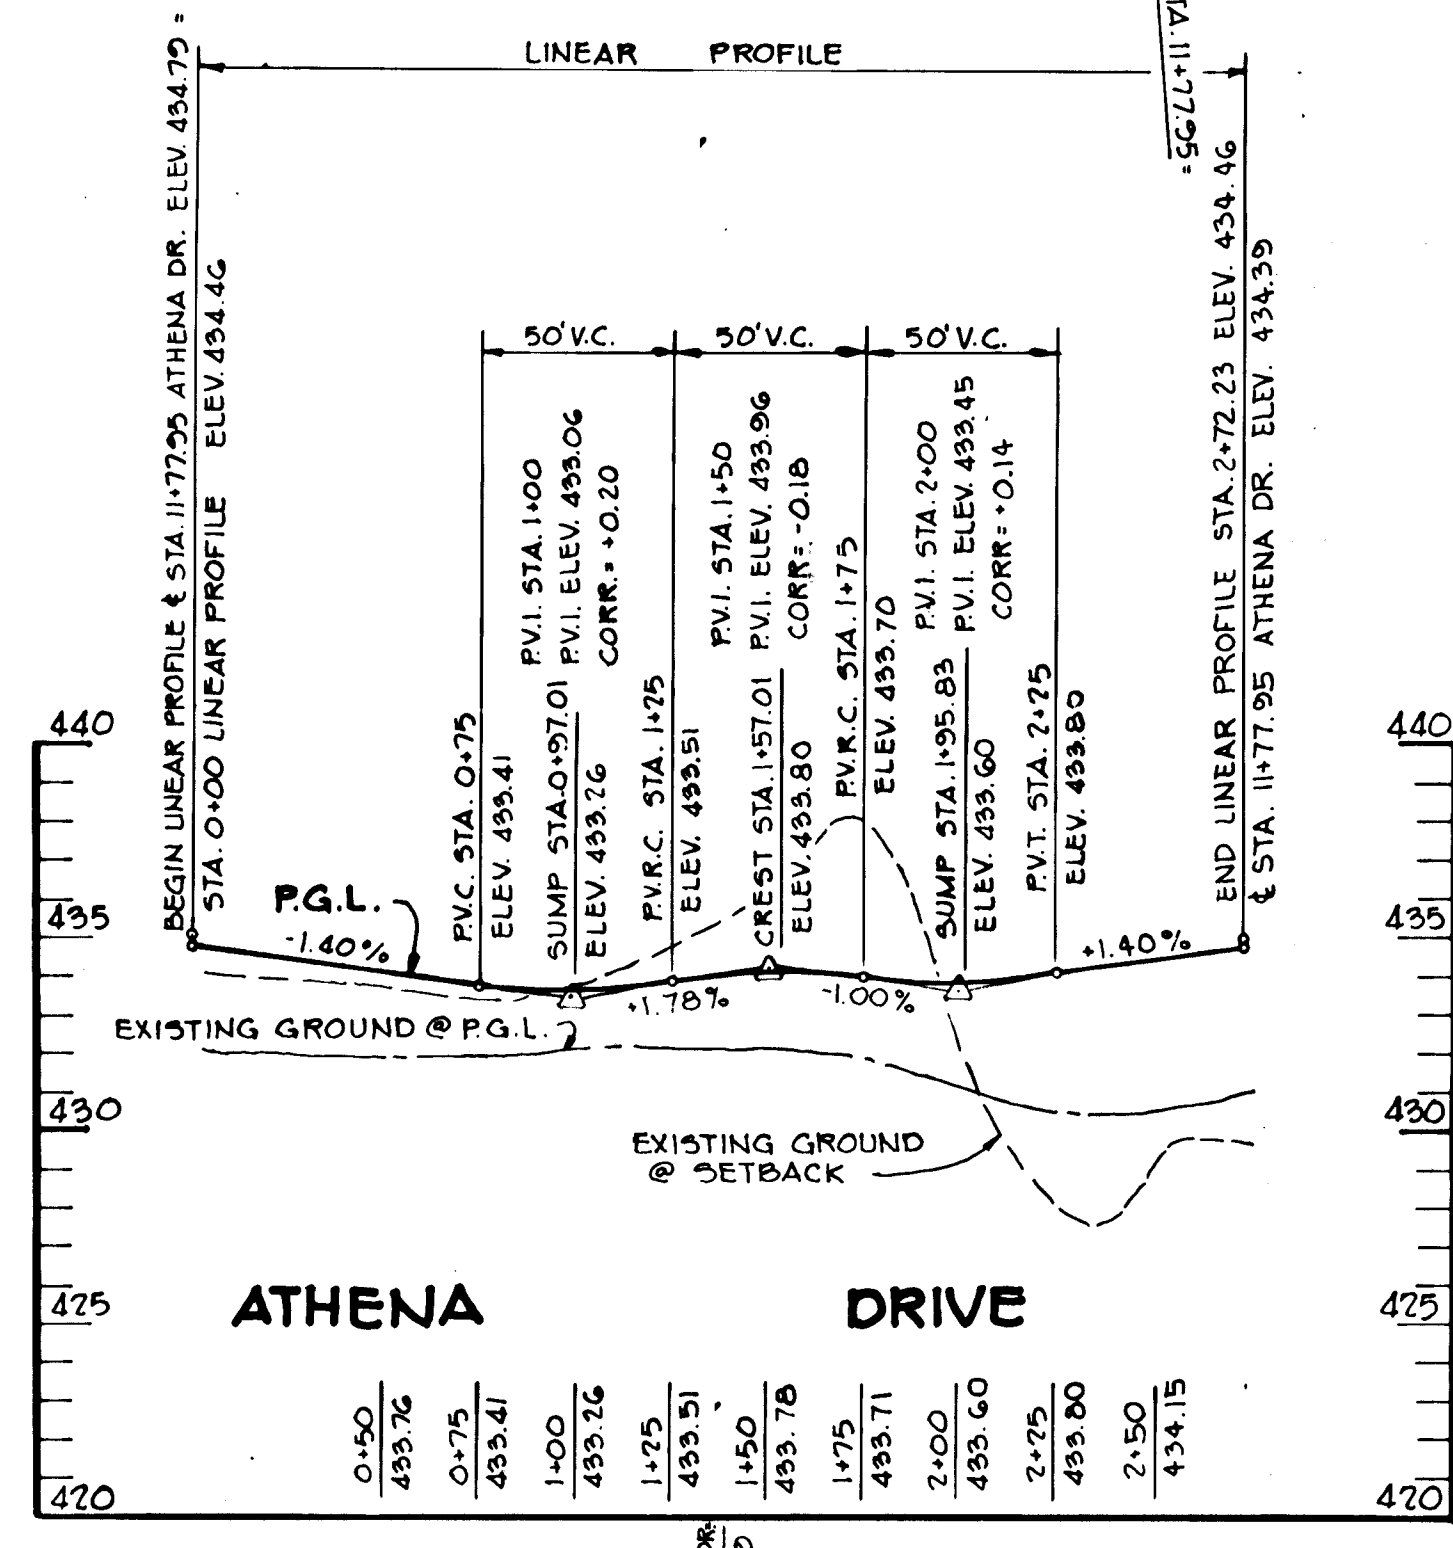

APPROVED: HOWARD COUNTY OFFICE OF PLANNING AND ZONING  
 CHIEF, DIVISION OF LAND DEVELOPMENT AND ZONING ADMINISTRATION  
 DATE: 4-28-81

APPROVED: HOWARD COUNTY DEPARTMENT OF PUBLIC WORKS  
 CHIEF, BUREAU OF ENGINEERING  
 DATE: 5-13-81

REVISED AS PER H.C. COMMENTS DATED 3-25-81

OWNER/DEVELOPER: MANOR LANE ASSOCIATES, 2606 BELAIR ROAD, BALTIMORE, MARYLAND 21236

PROJECT: CARTHAGE MANOR

AREA: 2<sup>ND</sup> ELECTION DISTRICT, HOWARD COUNTY, MD, TAX MAP N<sup>0</sup> 23, PARCEL 2


TITLE: PLAN AND PROFILE OF ATHENA DRIVE

Riemer - Tracy & Associates, Inc.  
 8659 Baltimore National Pike, Ellicott City, Maryland 21043, (301) 461-2690


DESIGNED BY: L.J.D.  
 DRAWN BY: T.E.S.  
 PROJECT NO: 0000  
 DATE: 1-30-81  
 SCALE: AS SHOWN  
 DRAWING NO. 2 OF 5

PROFESSIONAL ENGR. NO. 9566



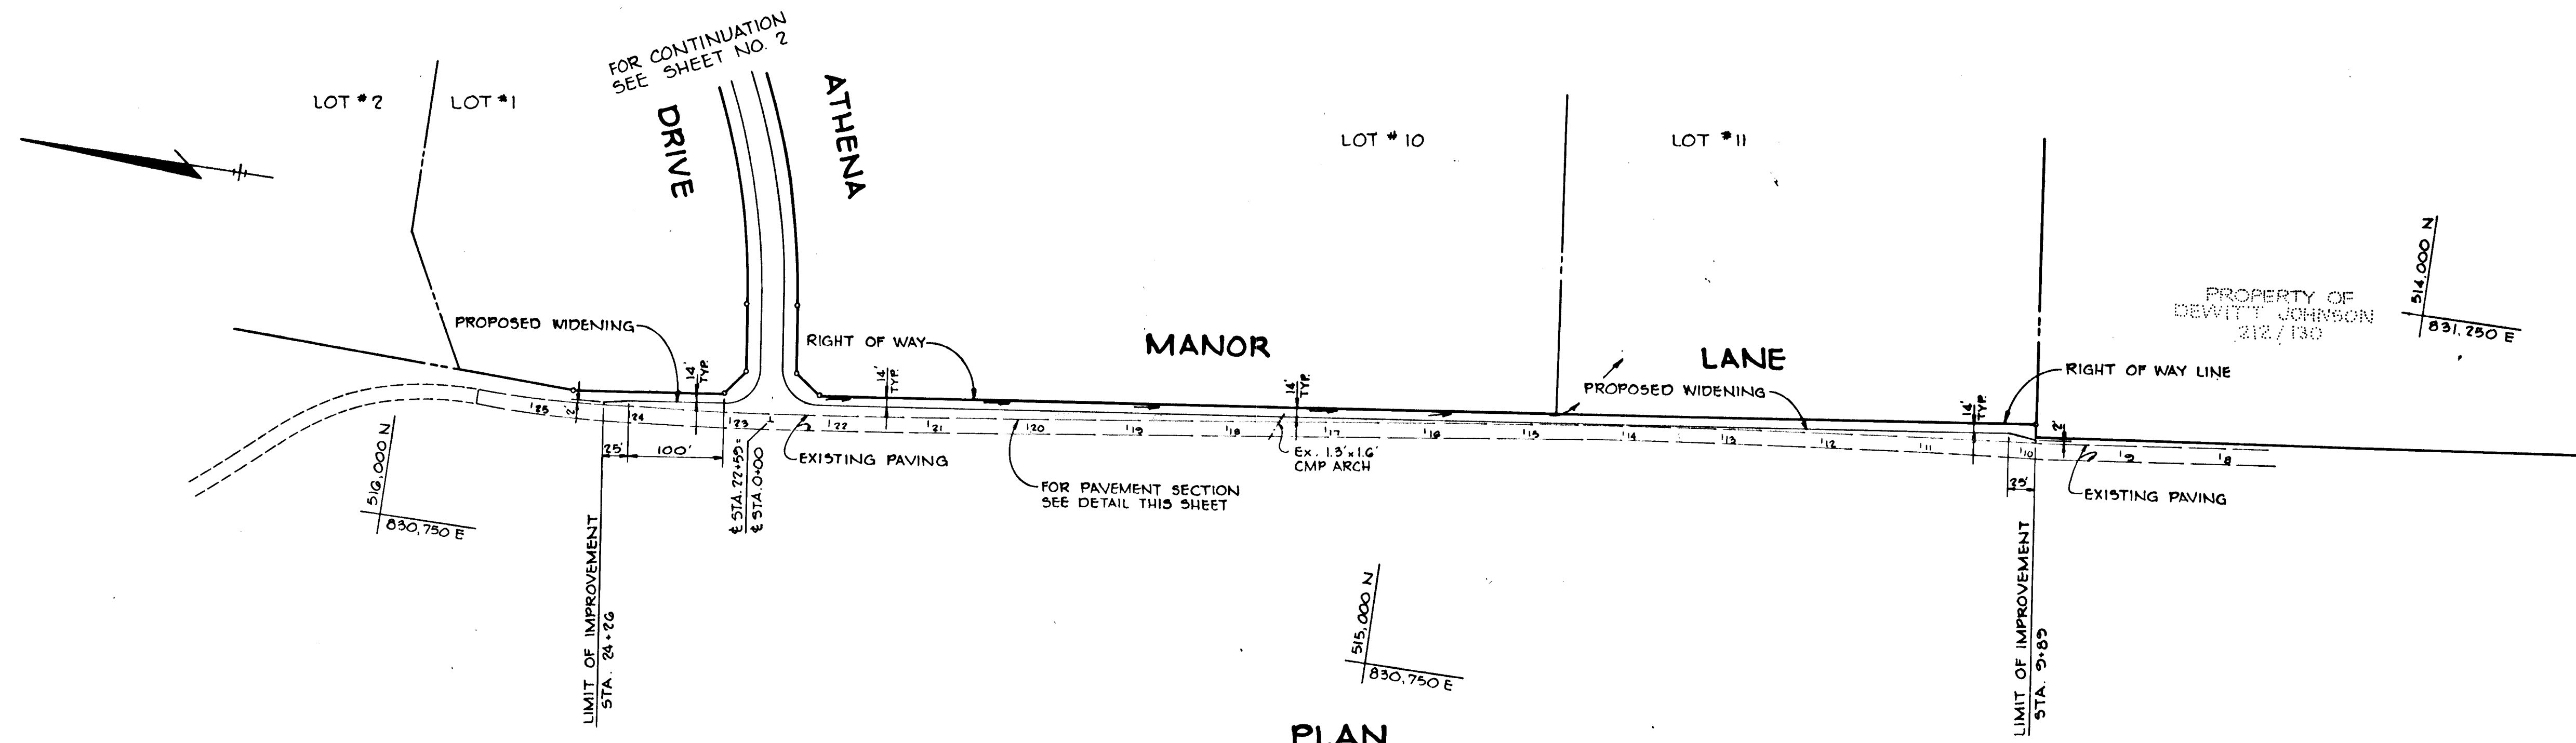


**PLAN**  
Scale: 1"=100'

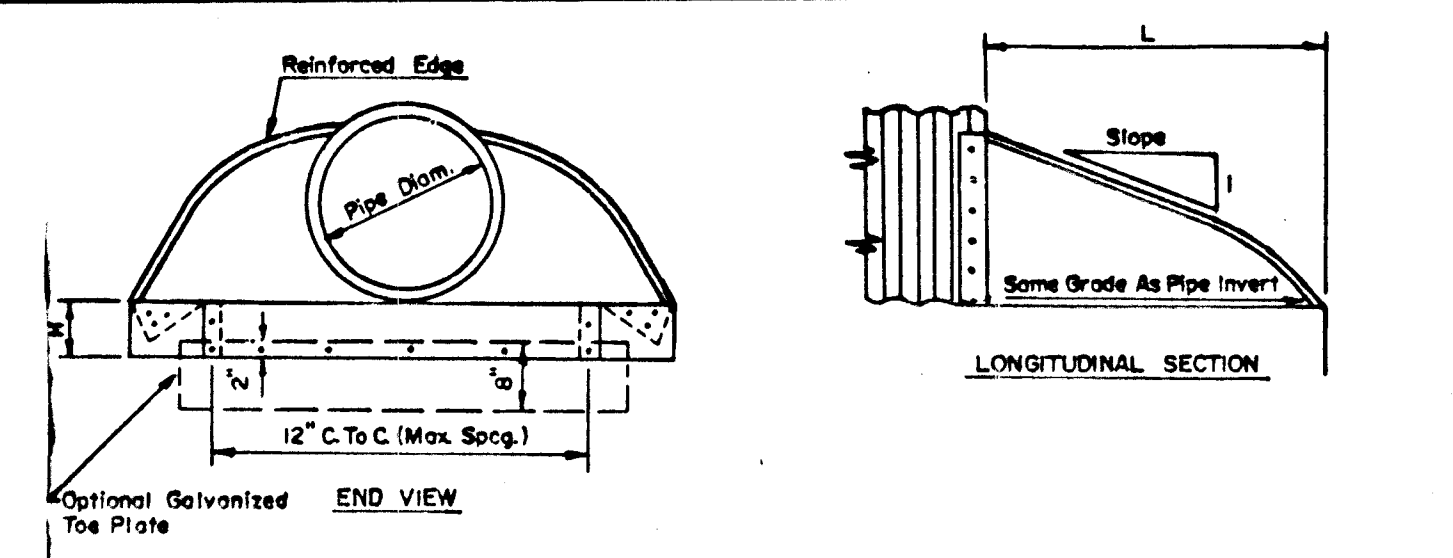


**TABLE OF DIMENSIONS**

| Pipe Diam. | Ga. | A  | B   | H  | L  | W   | Approx Slope | Body |
|------------|-----|----|-----|----|----|-----|--------------|------|
| 18"        | 14  | 8" | 10" | 6" | 3' | 36" | 2%           | 1P2  |

**TYPICAL METAL END SECTION**  
No Scale

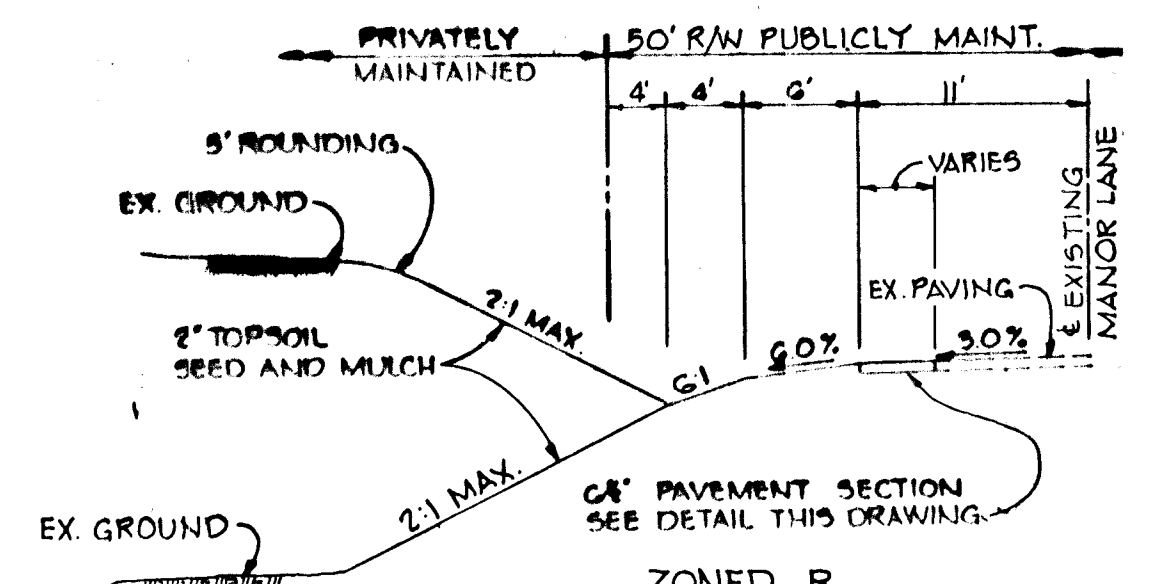


**TYPICAL SECTION**  
No Scale

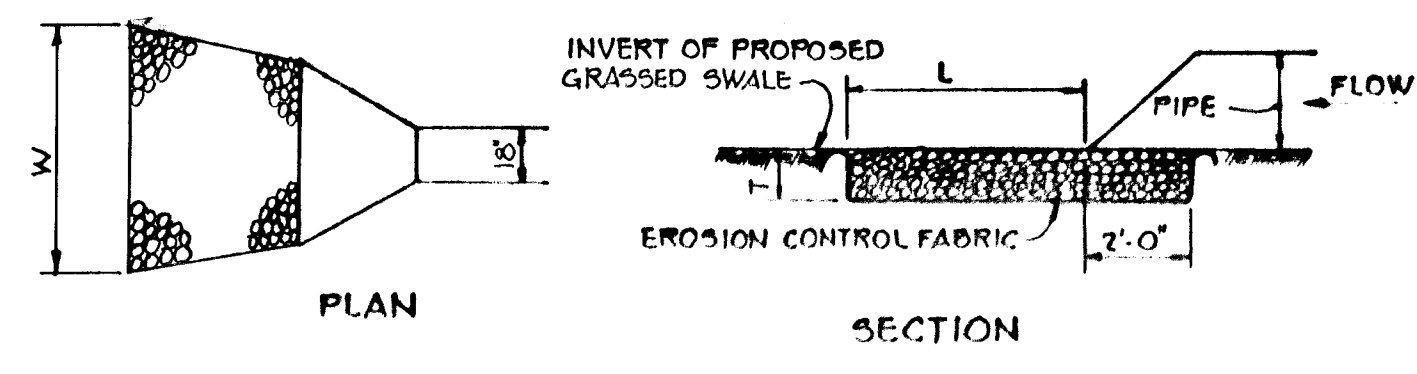

| STRUCTURE | MEDIUM STONE DIA. | LENGTH (L) | WIDTH (W) | THICKNESS (T) |
|-----------|-------------------|------------|-----------|---------------|
| E-1       | 5"                | 20'        | 3'        | 3"            |


**RIPRAP DETAIL**  
No Scale

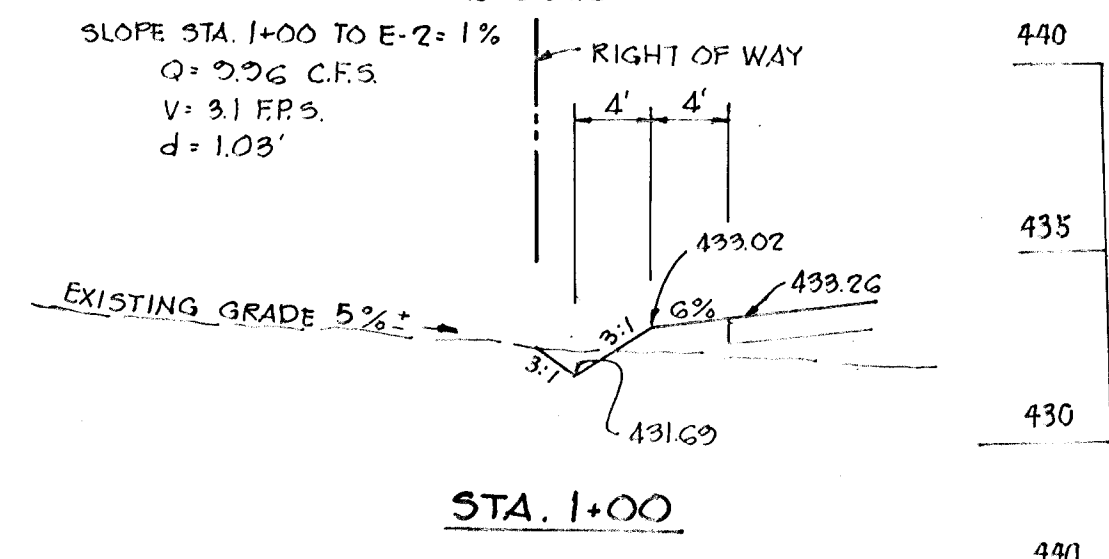

STA. 1+00  
 Q = 3.96 cfs  
 V = 3.1 FPS  
 d = 1.03'


STA. 0+75  
 Q = 5.02 cfs  
 V = 2.97 cfs  
 d = 0.75'

**CUL-DE-SAC SECTIONS**  
SCALE: H: 1"=10' V: 1"=5'

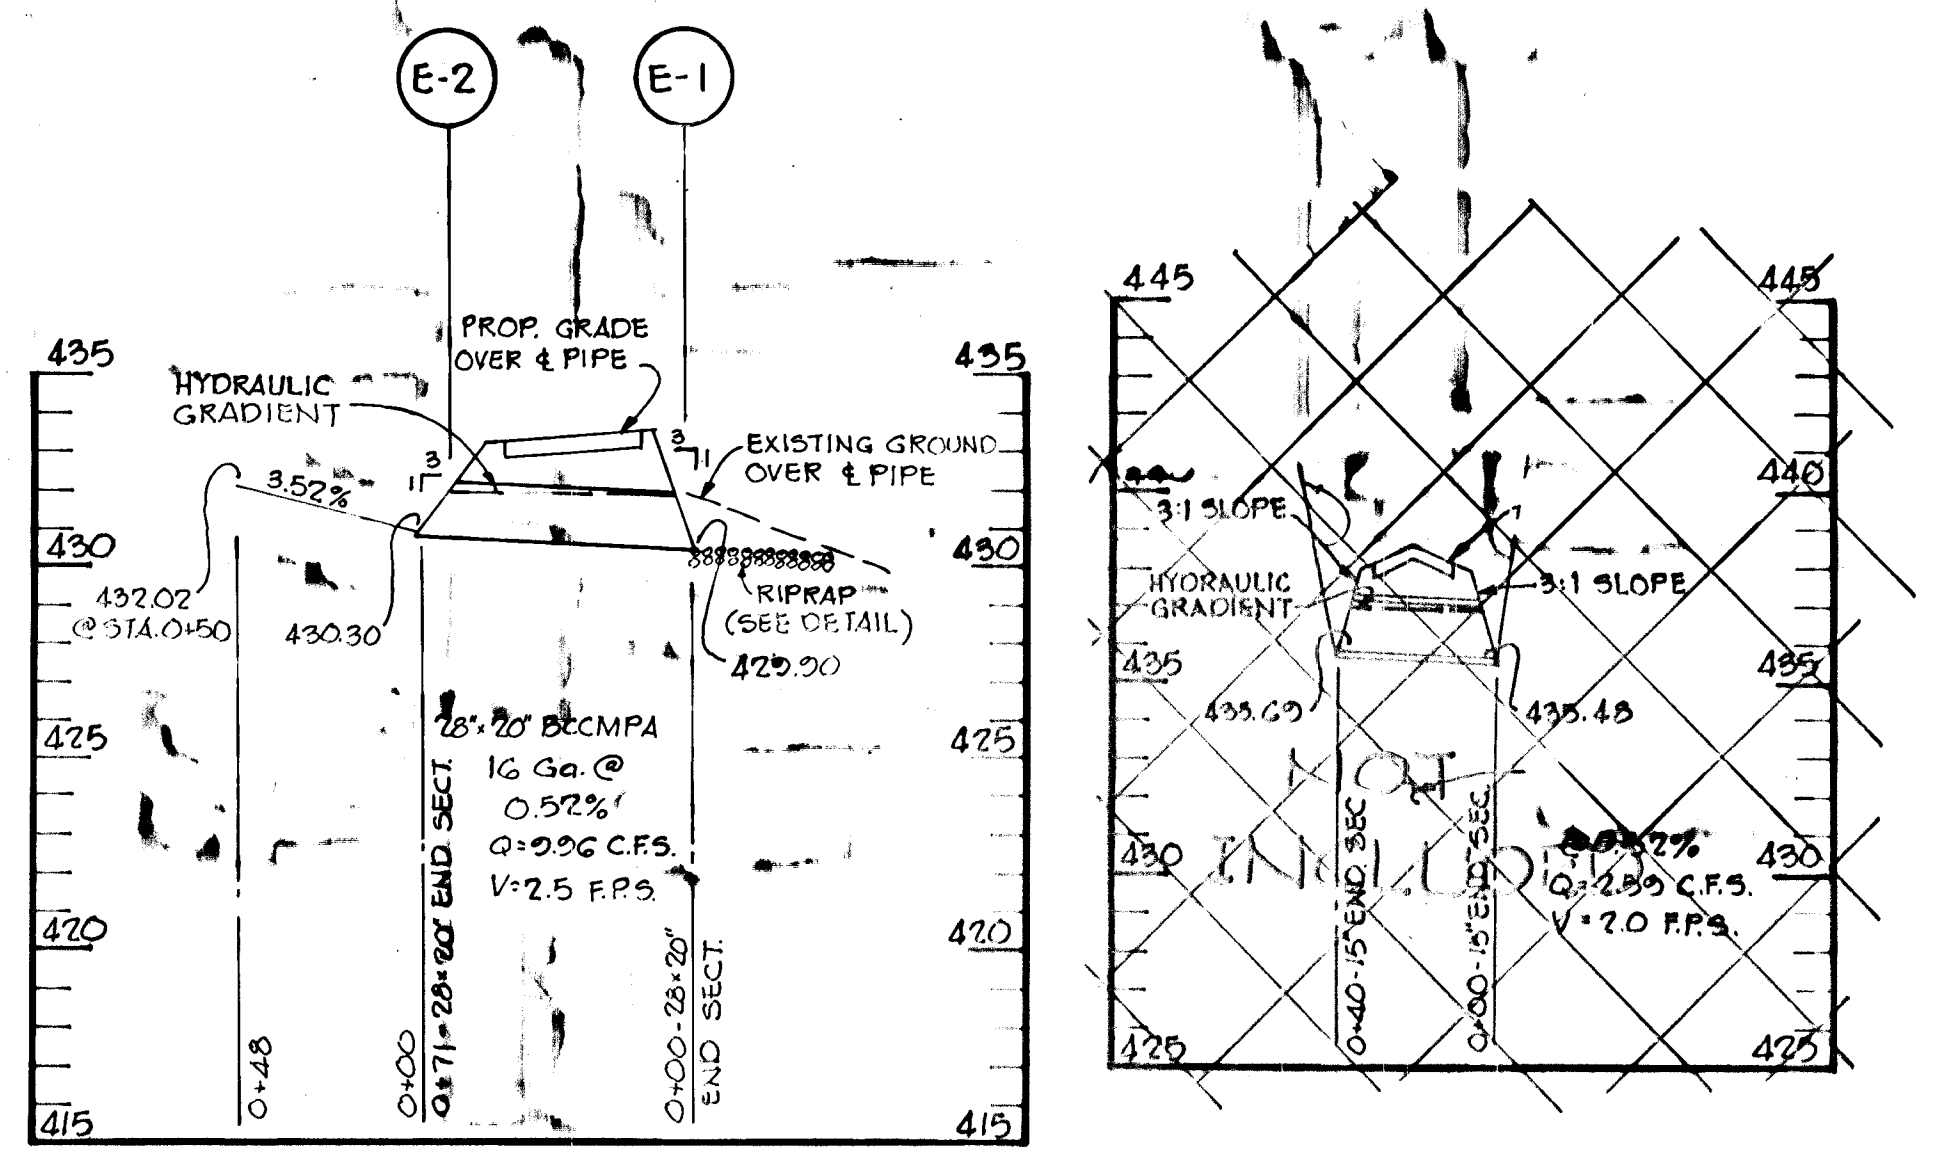


**PROFILE**  
Scale: 1"=5'


ALL BEDDING SHALL BE CLASS 'C' UNLESS OTHERWISE SPECIFIED

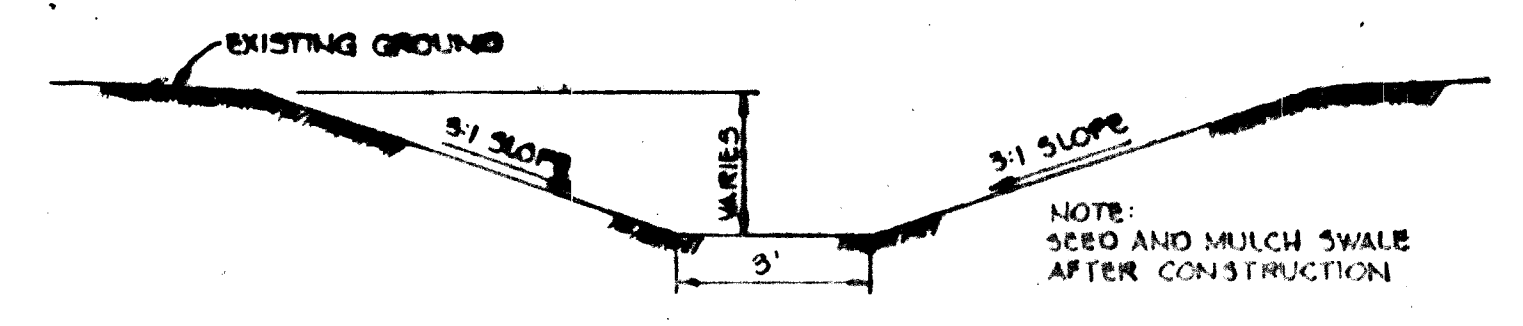

**GRASSED SWALE**  
NO SCALE

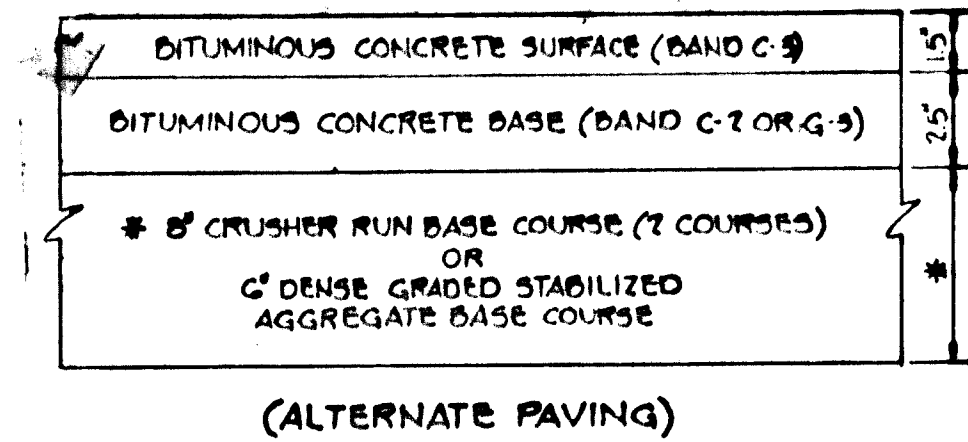

(ALTERNATE PAVING)

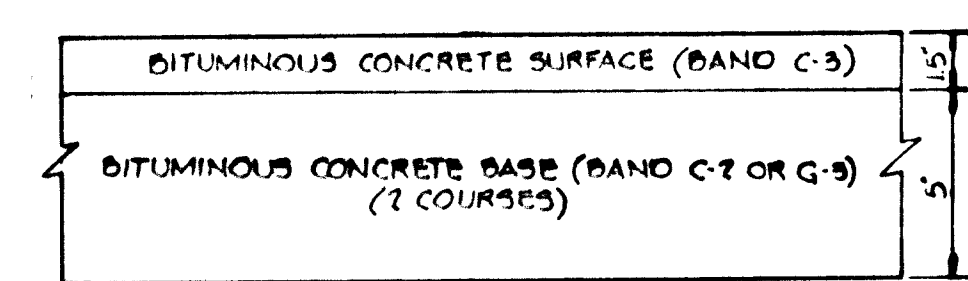


(C 1/2 PAVING)

HOWARD COUNTY STANDARD (DRAWING NO. 6)  
 CLEARING AND GRADING ARTICLE C-1  
 SUBGRADE ARTICLE C-2  
 BASE COURSE ARTICLE C-31 OR C-35  
 SURFACE COURSE ARTICLE C-31

- NOTES:**
1. A TACK COAT IS REQUIRED IN ACCORDANCE WITH SECTION C-31.4 OF THE HOWARD COUNTY ROAD CONSTRUCTION CODE AND SPECIFICATIONS.
  2. BASE WILL BE PRIMED IN ACCORDANCE WITH SECTION C-30.3 OF THE HOWARD COUNTY ROAD CONSTRUCTION CODE AND SPECIFICATIONS.
  3. TO BE CONSTRUCTED IN ACCORDANCE WITH THE HOWARD COUNTY ROAD CONSTRUCTION CODE AND SPECIFICATIONS.

**TYPICAL PAVING SECTION**  
No Scale

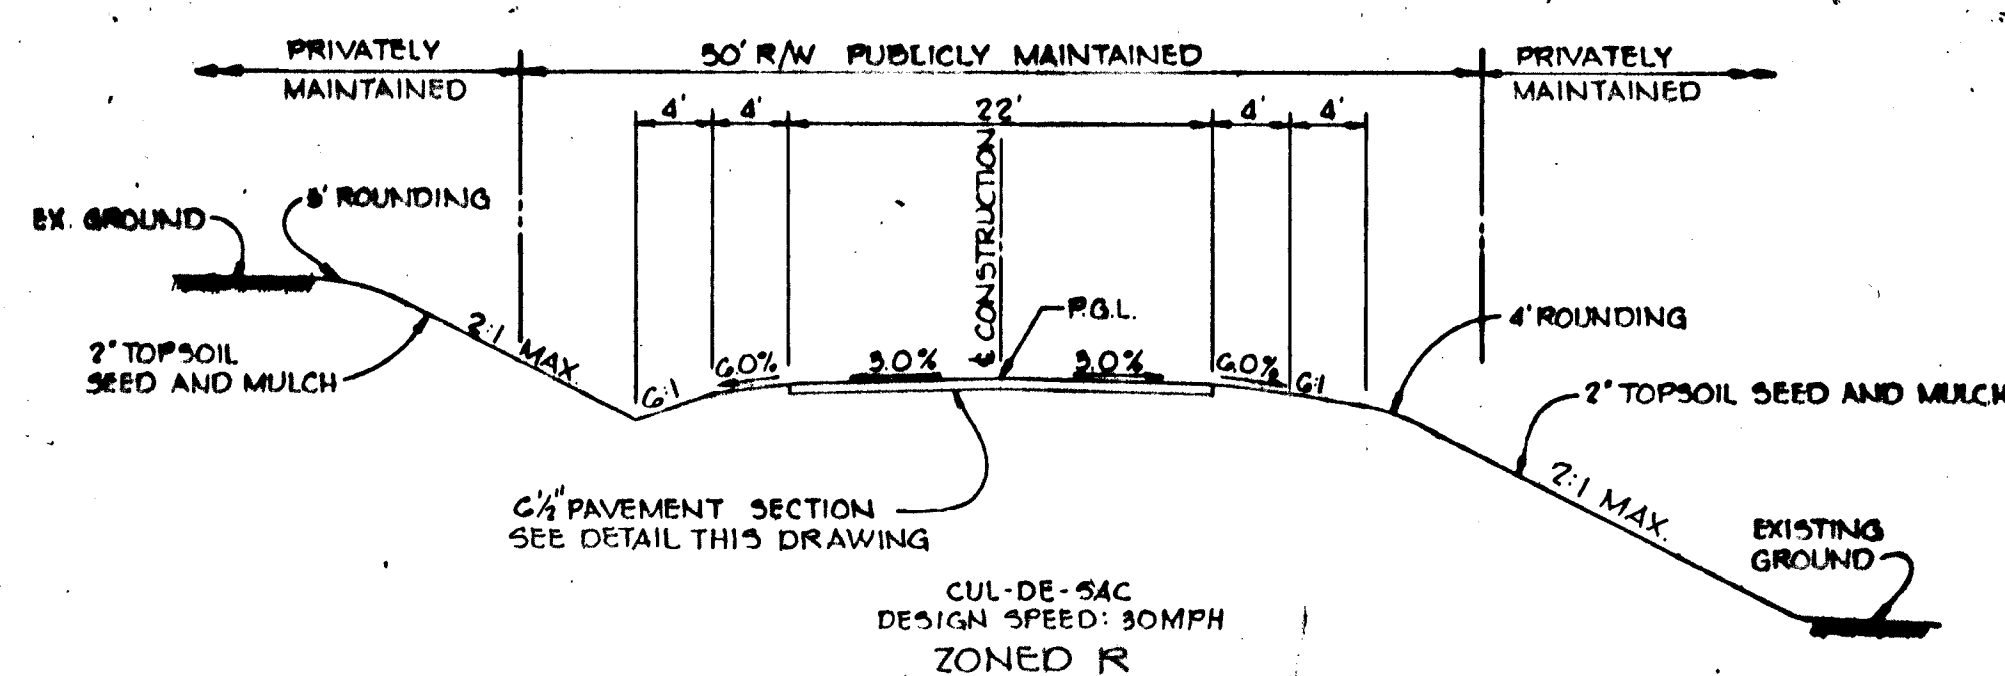

**TYPICAL SECTION - 50' R/W**  
No Scale

APPROVED: HOWARD COUNTY DEPARTMENT OF PUBLIC WORKS

CHIEF, BUREAU OF ENGINEERING  
 DATE: 5/13/81

APPROVED: HOWARD COUNTY OFFICE OF PLANNING AND ZONING

CHIEF, DIVISION OF LAND DEVELOPMENT AND ZONING ADMINISTRATION  
 DATE: 4-28-81

4-24-81 REVISED AS PER H.C. COMMENTS DATED 3-25-81

OWNER/DEVELOPER  
 MANOR LANE ASSOCIATES  
 3606 BELAIR ROAD  
 BALTIMORE, MARYLAND 21236

PROJECT: **CARTHAGE MANOR**

AREA 2<sup>ND</sup> ELECTION DISTRICT HOWARD COUNTY, MD.  
 TAX MAP N# 29 PARCEL 2

TITLE: **PLAN OF MANOR LANE, DETAILS AND STORM DRAIN PROFILES**

**Riemer - Tracy & Associates, Inc.**  
 8659 Baltimore National Pike  
 Ellicott City, Maryland 21043  
 (301) 461-2690  
 Land Planning, Design & Civil Engineering

DATE: 1-27-81  
 DESIGNED BY: R/JW  
 DRAWN BY: R/JW  
 PROJECT NO: 0080  
 DATE: 1-30-80  
 SCALE: AS SHOWN  
 DRAWING NO. 3 OF 5

SEQUENCE OF CONSTRUCTION

1. OBTAIN GRADING PERMIT.
2. INSTALL STABILIZED CONSTRUCTION ENTRANCE.
3. INSTALL PERIMETER DIKES, SILT FENCES AND SEDIMENT TRAPS NO. 1 AND 2 AND SEED AS PER TEMPORARY SEEDING NOTES.
4. GRADE SITE, MAINTAINING POSITIVE DRAINAGE ALONG PERIMETER DIKES AND STABILIZE IN ACCORDANCE WITH TEMPORARY SEEDING NOTES.
5. CONSTRUCT STORM DRAINS AND PAVING AND SEED DISTURBED AREAS IN ACCORDANCE WITH PERMANENT SEEDING NOTES.
6. UPON APPROVAL OF THE HOWARD SOIL CONSERVATION DISTRICT, REMOVE ALL SEDIMENT CONTROL DEVICES AND SEED PER PERMANENT SEEDING NOTES.


SEDIMENT TRAP NO. 1 WITH STONE OUTLET STRUCTURE

TOTAL DRAINAGE AREA 1.73 ACRES; IMPERVIOUS AREA = 40%  
 DISTURBED AREA 0.45 ACRES; AREA TO BE REVEGETATED = 22%  
 VOLUME REQUIRED 115.9 CUBIC YARDS  
 CLEANOUT ELEVATION 442.6  
 DEPTH OF CREST 3.2  
 BOTTOM ELEVATION 441.0  
 BOTTOM DIMENSIONS 30' x 35'

SEDIMENT TRAP NO. 2 WITH STONE OUTLET STRUCTURE

TOTAL DRAINAGE AREA 10.08 ACRES; IMPERVIOUS AREA = 26%  
 DISTURBED AREA 1.92 ACRES; AREA TO BE REVEGETATED = 85%  
 VOLUME REQUIRED 675.3 CUBIC YARDS  
 CLEANOUT ELEVATION 428.5  
 DEPTH OF CREST 2.5  
 BOTTOM ELEVATION 427.0  
 BOTTOM DIMENSIONS 75' x 27'

| STRUCTURE SCHEDULE |                             |          |         |          |           |                     |
|--------------------|-----------------------------|----------|---------|----------|-----------|---------------------|
| NO.                | TYPE                        | LOCATION | INV. IN | INV. OUT | TOP ELEV. | DESCRIPTION         |
| E-1                | 28" x 20" METAL END SECTION | SEE PLAN | —       | 422.20   | —         | SEE DETAIL SHEET #3 |
| E-2                | 28" x 20" METAL END SECTION | SEE PLAN | 430.30  | —        | —         | SEE DETAIL SHEET #3 |

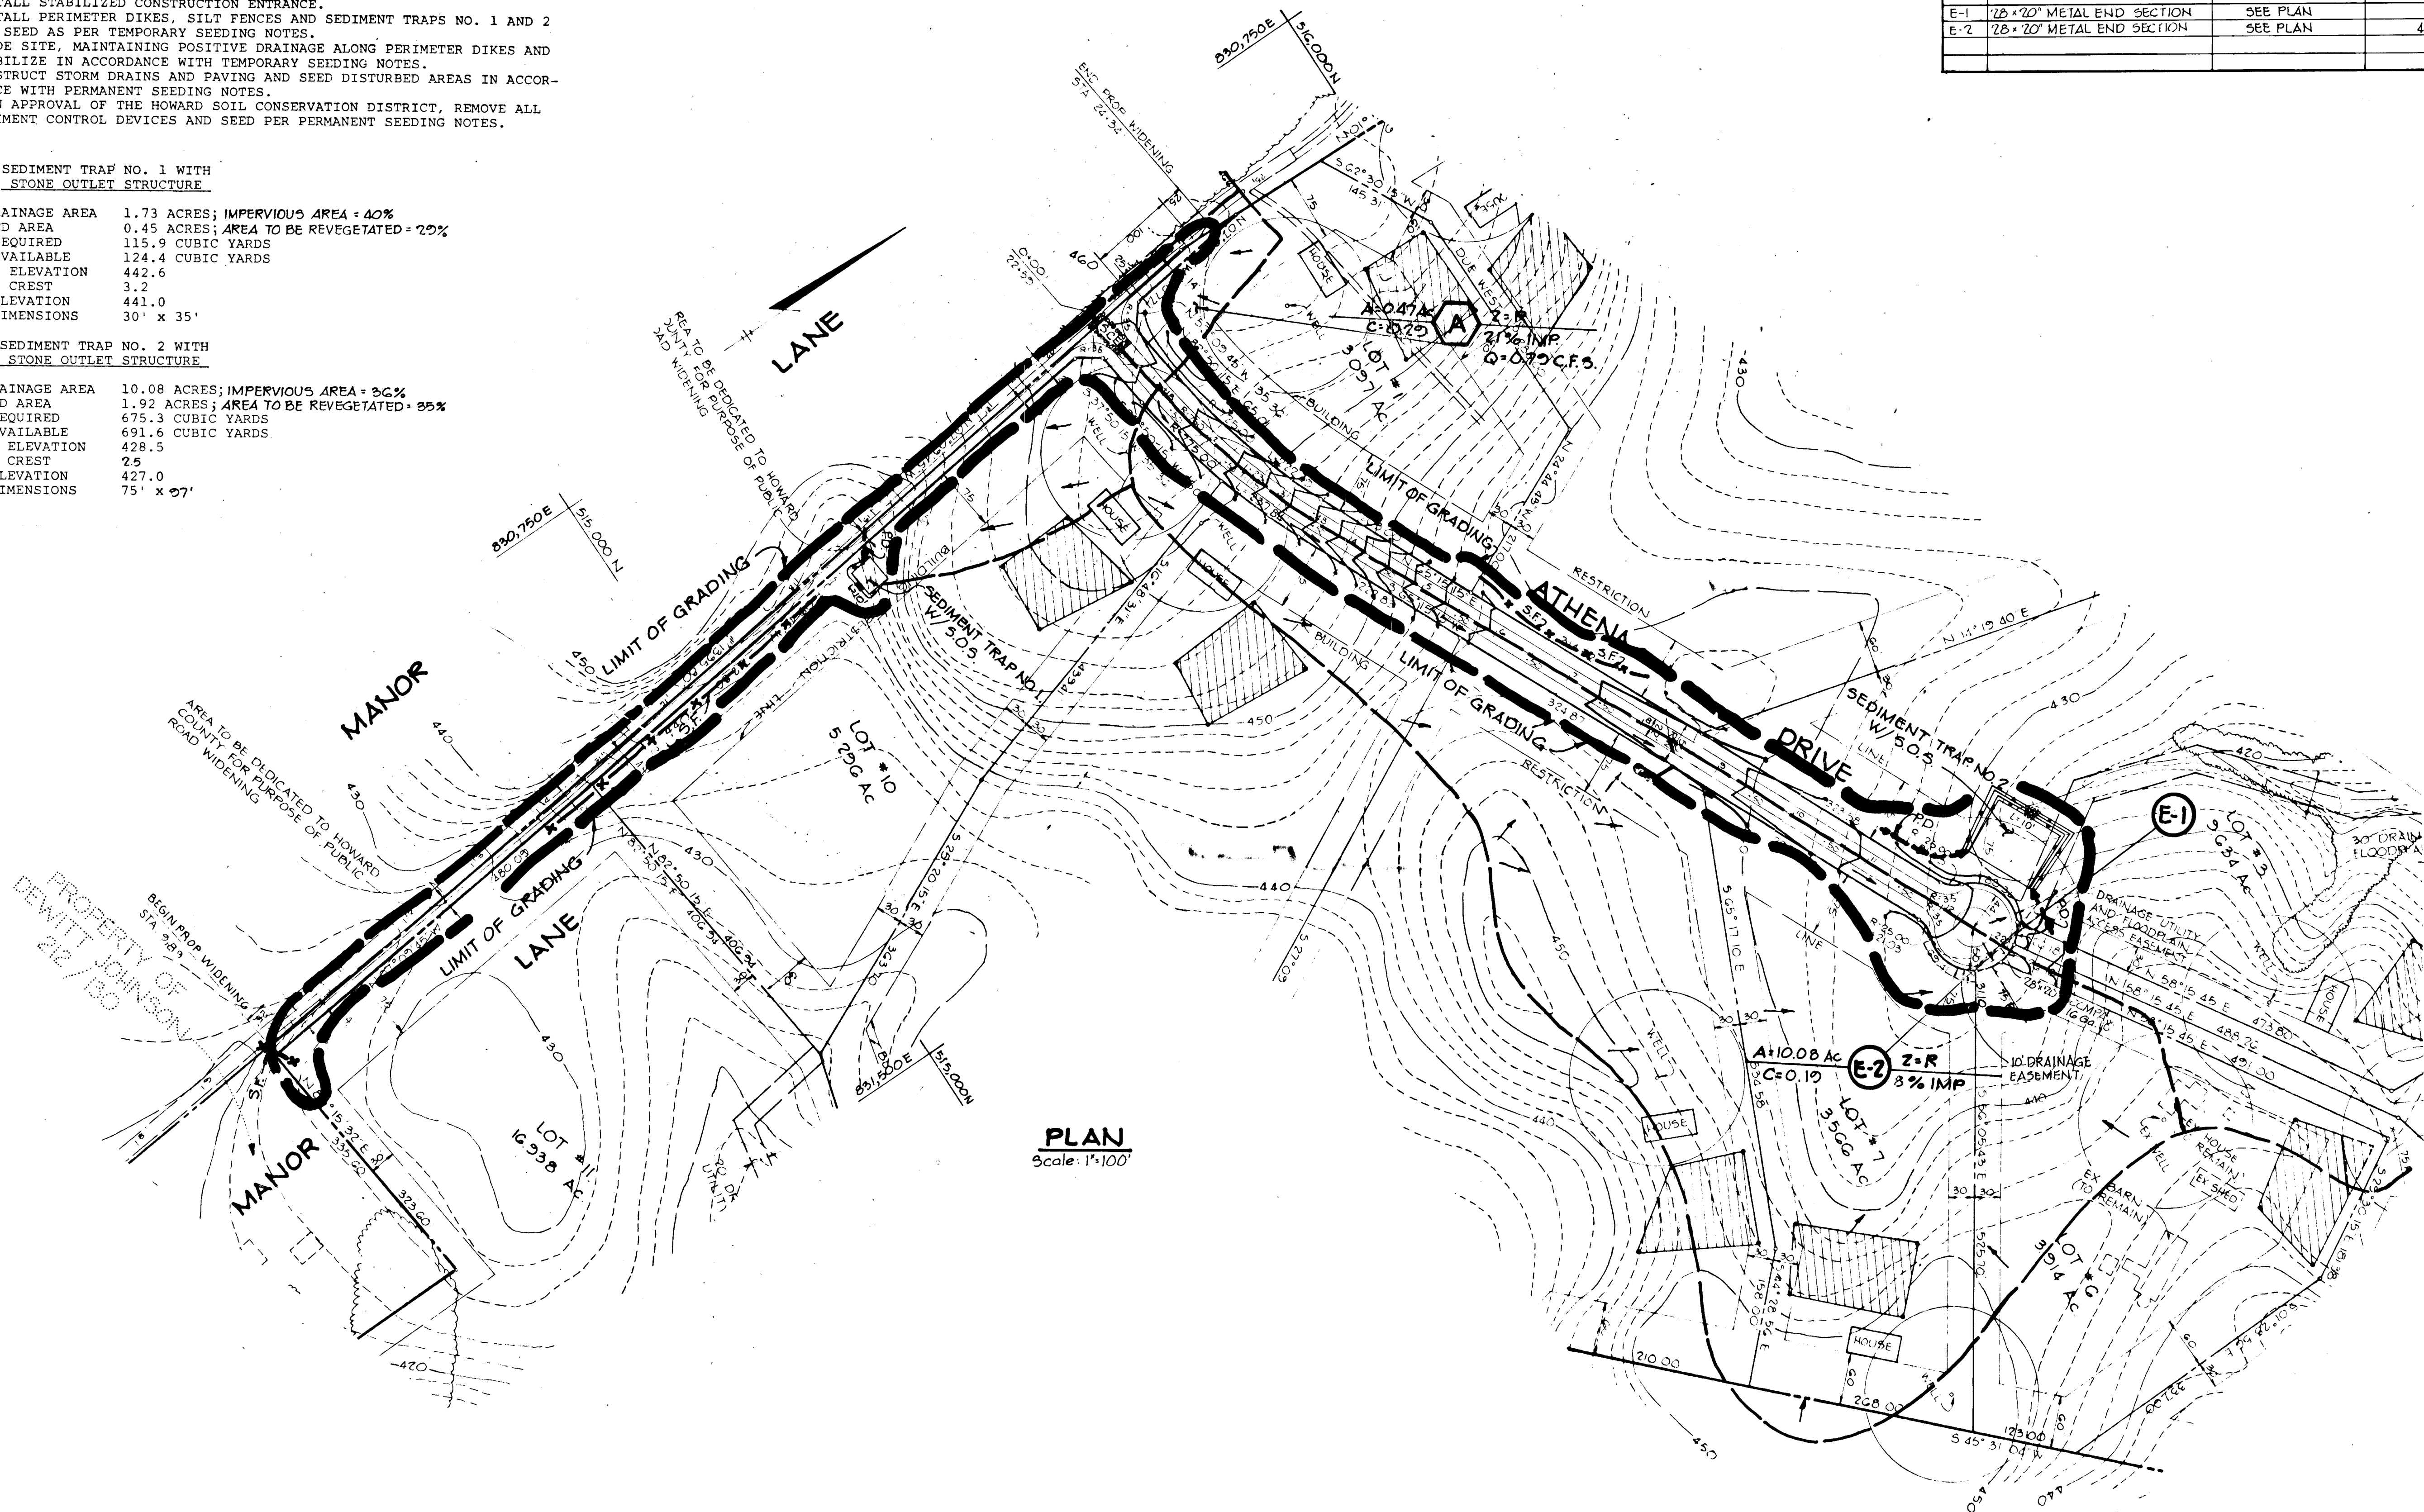

PLAN  
Scale: 1"=100'

THE DEVELOPER:

"I WE CERTIFY THAT ALL DEVELOPMENT AND CONSTRUCTION WILL BE DONE ACCORDING TO THIS PLAN, AND THAT ANY RESPONSIBLE PERSONNEL INVOLVED IN THE CONSTRUCTION PROJECT WILL HAVE A CERTIFICATE OF ATTENDANCE AT A DEPARTMENT OF NATURAL RESOURCES APPROVED TRAINING PROGRAM FOR THE CONTROL OF SEDIMENT AND EROSION BEFORE BEGINNING THE PROJECT."

*Jack T. Gibson* 1-29-81  
 JACK T. GIBSON DATE

BY THE ENGINEER:

"I CERTIFY THAT THIS PLAN FOR EROSION AND SEDIMENT CONTROL REPRESENTS A PRACTICAL AND WORKABLE PLAN BASED ON MY PERSONAL KNOWLEDGE OF THE SITE CONDITIONS AND THAT IT WAS PREPARED IN ACCORDANCE WITH THE REQUIREMENTS OF THE HOWARD SOIL CONSERVATION DISTRICT."

*James K. Tracy* 1-30-81  
 JAMES K. TRACY DATE

REVIEWED FOR HOWARD COUNTY S.C.D. NAME AND MEETS TECHNICAL REQUIREMENTS

*William V. Rowe* 4-28-81  
 U.S. SOIL CONSERVATION SERVICE DATE

THIS DEVELOPMENT PLAN IS APPROVED FOR SOIL EROSION AND SEDIMENT CONTROL BY THE HOWARD SOIL CONSERVATION DISTRICT

*William V. Rowe* 4-28-81  
 HOWARD S.C.D. DATE

APPROVED: HOWARD COUNTY OFFICE OF PLANNING AND ZONING

*William V. Rowe* 4-28-81  
 CHIEF DIVISION OF LAND DEVELOPMENT AND ZONING ADMINISTRATION DATE

APPROVED: HOWARD COUNTY DEPARTMENT OF PUBLIC WORKS

*William S. Ryan* 5/13/81  
 CHIEF, BUREAU OF ENGINEERING DATE

4-24-81 REVISOR AS PER H.C. COMMENTS DATED 3-25-81

DATE NO. REVISION

OWNER/DEVELOPER  
 MANOR LANE ASSOCIATES  
 3606 BELAIR ROAD  
 BALTIMORE, MARYLAND 21236

PROJECT:  
**CARTHAGE MANOR**

AREA  
 2ND ELECTION DISTRICT HOWARD COUNTY, MD  
 TAX MAP NO. 23 PARCEL 2

TITLE:  
 GRADING, SEDIMENT CONTROL  
 AND DRAINAGE AREA MAP

**RT** **Rierner · Tracy & Associates, Inc.**  
 8659 Baltimore National Pike  
 Ellicott City, Maryland 21043  
 (301) 461-2690  
 Land Planning · Design & Civil Engineering

1-30-81  
 DATE

DESIGNED BY: L.J.D.  
 DRAWN BY: T.E.S.  
 PROJECT NO: 0980  
 DATE: 1-30-81  
 SCALE: 1"=100'  
 DRAWING NO. 4 OF 5

*James K. Tracy*  
 PROFESSIONAL ENGR. NO. 9566

F-81-80 APRIL 24, 1981

MARYLAND BLUEPRINT CO. INC.



**SEDIMENT CONTROL CONSTRUCTION NOTES**  
GENERAL NOTES

1. A MINIMUM OF 24 HOURS NOTICE MUST BE GIVEN TO THE HOWARD COUNTY OFFICE OF INSPECTION AND PERMITS PRIOR TO THE START OF ANY CONSTRUCTION (922-2670).
  2. ALL SEDIMENT CONTROL STRUCTURES WILL BE INSTALLED IN ACCORDANCE WITH "THE STANDARDS AND SPECIFICATIONS FOR SOIL EROSION AND SEDIMENT CONTROL IN DEVELOPING AREAS" AS PREPARED BY THE U.S. DEPARTMENT OF AGRICULTURE SOIL CONSERVATION SERVICE.
  3. SITE GRADING WILL BEGIN ONLY AFTER ALL PERIMETER SEDIMENT CONTROL MEASURES HAVE BEEN INSTALLED AND ARE IN A FUNCTIONING CONDITION.
  4. ALL DISTURBED AREAS ARE TO BE DRESSED AND STABILIZED ACCORDING TO THE TEMPORARY OR PERMANENT SEEDING SCHEDULES AS SOON AS PROPER WEATHER CONDITIONS EXIST FOR THE ESTABLISHMENT OF A PERMANENT VEGETATIVE COVER.
  5. SEDIMENT WILL BE REMOVED FROM TRAPS WHEN THE DEPTH REACHES THE CLEAN OUT ELEVATION SHOWN ON THE PLANS.
  6. FERTILIZER AND LIME RATES MAY BE CHANGED THROUGH AUTHORIZATION BY THE HOWARD SOIL CONSERVATION DISTRICT IF SOIL TESTS DETERMINE A REDUCTION IN THE SPECIFIED RATES IS JUSTIFIED.
  7. ALL SEDIMENT CONTROL STRUCTURES ARE TO REMAIN IN PLACE AND ARE TO BE MAINTAINED IN OPERATIVE CONDITION UNTIL PERMISSION FOR THEIR REMOVAL HAS BEEN OBTAINED FROM THE HOWARD COUNTY SEDIMENT CONTROL INSPECTOR.
  8. REFERENCES CALLED FOR ON THE SEDIMENT CONTROL CONSTRUCTION PLAN AND DETAILS ARE MADE TO "THE STANDARDS AND SPECIFICATIONS FOR SOIL EROSION AND SEDIMENT CONTROL IN DEVELOPING AREAS".
- SEDIMENT CONTROL WILL BE INSTALLED BEFORE CLEARING AND GRUBBING REMAINDER OF SITE.

**TEMPORARY SEEDING**


AREA TO BE SEEDING SHALL BE RECENTLY LOOSENEED. IF THE GROUND IS PACKED, CRUSTED OR HARD, THE TOP LAYER OF SOIL SHALL BE LOOSENEED BY DISCING, RACKING OR OTHER ACCEPTABLE MEANS.

1. APPLY 10-20-10 FERTILIZER (OR EQUIVALENT) AT THE RATE OF 600 LBS. PER ACRE OR 15 LBS. PER 1000 SQ. FT.
2. WHERE SOIL IS KNOWN TO BE HIGHLY ACID, APPLY DOLOMITIC LIMESTONE AT THE RATE OF 1 TON PER ACRE.
3. WORK BOTH INTO SOIL AND SEED WITH CYCLONE SEEDER, DRILL, CULTIPAKER SEEDER OR HYDROSEEDER (SLURRY WILL INCLUDE SEED AND FERTILIZER) AT THE RATE OF 40 LBS. PER ACRE OF ITALIAN OR PERENNIAL RYEGRASS.
4. MULCH WITH UNWEATHERED SMALL GRAIN STRAW AT THE RATE OF 1 1/2 TO 2 TONS PER ACRE AND ANCHOR WITH A CUTBACK ASPHALT OR EMULSIFIED ASPHALT AT THE RATE OF 5 GAL. PER 1000 SQ. FT.

**PERMANENT SEEDING**


FIRM STABILIZATION WILL TAKE PLACE AS SOON AS POSSIBLE AS WEATHER CONDITIONS PERMIT, AS FOLLOWS:

1. APPLY DOLOMITIC LIMESTONE AT THE RATE OF 2 TONS PER ACRE (ONE TON PER ACRE IF APPLICATION OF TON PER ACRE WAS MADE FOR TEMPORARY SEEDING).
2. APPLY 0-20-20 FERTILIZER AT THE RATE OF 600 LBS. PER ACRE HARROW OR DISC LIME AND 0-20-20 FERTILIZER INTO THE SOIL TO A MINIMUM DEPTH OF 3" LAWNS OR HIGH MAINTENANCE AREAS WILL BE DRAGGED AND LEVELED WITH A YORK RAKE. AT THE TIME OF SEEDING APPLY 400 POUNDS OF 38-0-0 UREAFORM FERTILIZER AND 500 LBS. OF 10-20-20 OR EQUIVALENT FERTILIZER PER ACRE.
3. SEED WITH A MIXTURE OF CERTIFIED "MERION" KENTUCKY BLUEGRASS - 40 LBS. PER ACRE; COMMON KENTUCKY BLUEGRASS @ 40 LBS. PER ACRE; RED FESCUE, PENNLAWN OR JAMESTOWN @ 20 LBS. PER ACRE.
4. MULCH WITH UNWEATHERED SMALL GRAIN STRAW AT THE RATE OF 1 1/2 TO 2 TONS PER ACRE AND ANCHOR WITH A CUTBACK ASPHALT OR EMULSIFIED ASPHALT AT THE RATE OF 5 GAL. PER 1000 SQ. FT.
5. SEED ALL SLOPES WITH A MIXTURE OF CERTIFIED KENTUCKY 31 TALL FESCUE @ 30 LBS. PER ACRE AND INOCULATED KOREAN LESPEDEZA @ 15 LBS. PER ACRE.

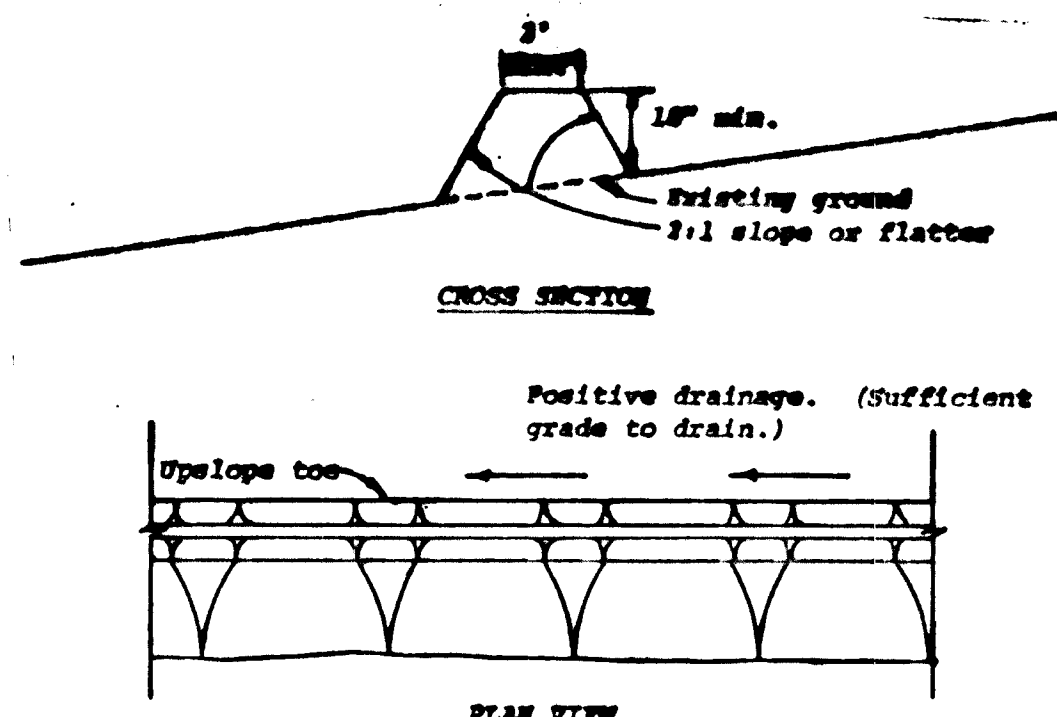


- Construction Specifications**
1. All dikes shall be machine compacted.
  2. All perimeter dikes shall have positive drainage to an outlet.
  3. A. Diverted runoff from a protected or stabilized upland area shall outlet directly onto an undisturbed stabilized area or into a level spreader or grade stabilization structure.  
B. Diverted runoff from a disturbed or exposed upland area shall be conveyed to a sediment trapping device such as sediment trap or a sediment basin or to an area protected by any of these practices.
  4. Stabilization, when required, shall be done in accordance with Standard and Specifications for Grassed Waterway. The minimum area to be stabilized shall be the channel flow area.
  5. Periodic inspection and required maintenance shall be provided.

**PERIMETER DIKE**  
No Scale

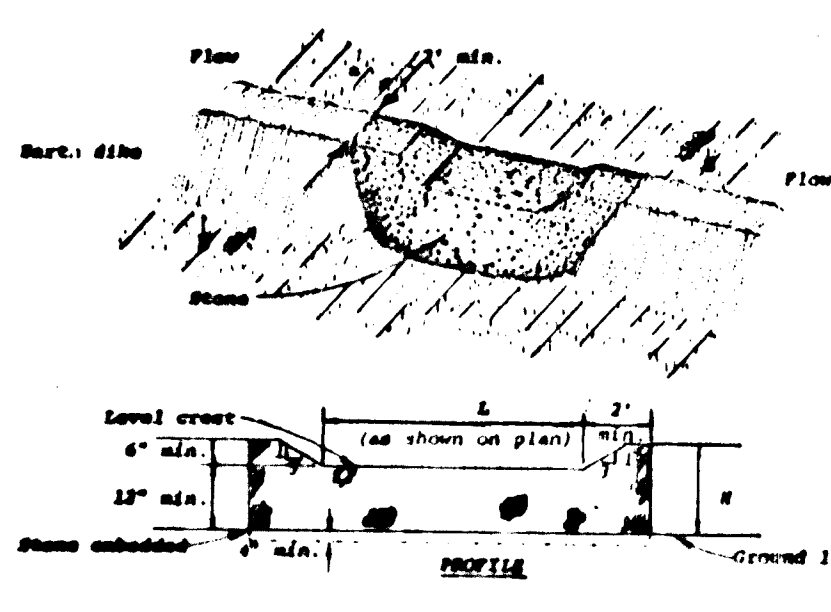


- Construction Specifications**
1. The stone shall be crushed stone. Gravel may be used if crushed stone is not available. The stone shall meet NSMA Size No. 2 or ASTM designation No. 2 or 24.
  2. The crest of the stone dike shall be at least six inches lower than the lowest elevation of the top of the marsh dike and shall be level.
  3. The stone outlet structure shall be embedded into the soil a minimum of four inches.
  4. The minimum length, in feet, of the crest of the stone outlet structure shall be equal to six times the number of acres of contributing drainage area.
  5. The stone outlet structure shall be inspected after each rain, and the stone shall be replaced when the structure ceases to function as intended due to silt accumulation among the stone, washout, construction traffic damage, etc.

**STONE OUTLET STRUCTURE FOR SEDIMENT TRAP NO. 1**  
No Scale

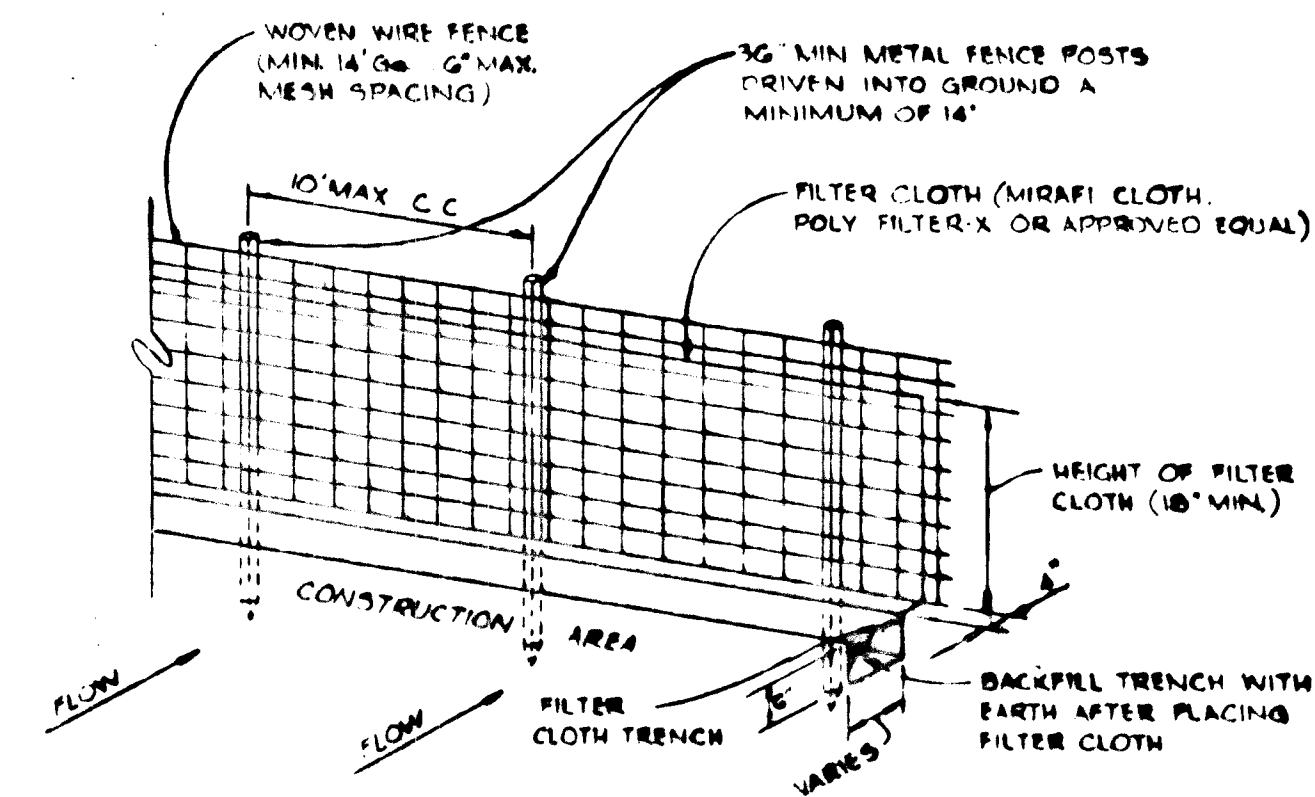


- NOTES:**
1. WOVEN WIRE FENCE TO BE FASTENED SECURELY TO FENCE POSTS BY USE OF WIRE TIES.
  2. FILTER CLOTH TO BE FASTENED SECURELY TO WOVEN WIRE FENCE BY USE OF WIRE TIES SPACED EVERY 24\"/>
  - 3. SILT FENCE TO BE PLACED IN LIEU OF STRAW BALES AND/OR CONVERSION DIKES AT THE OPTION OF THE DEVELOPER.

**SILT FENCE**  
No Scale

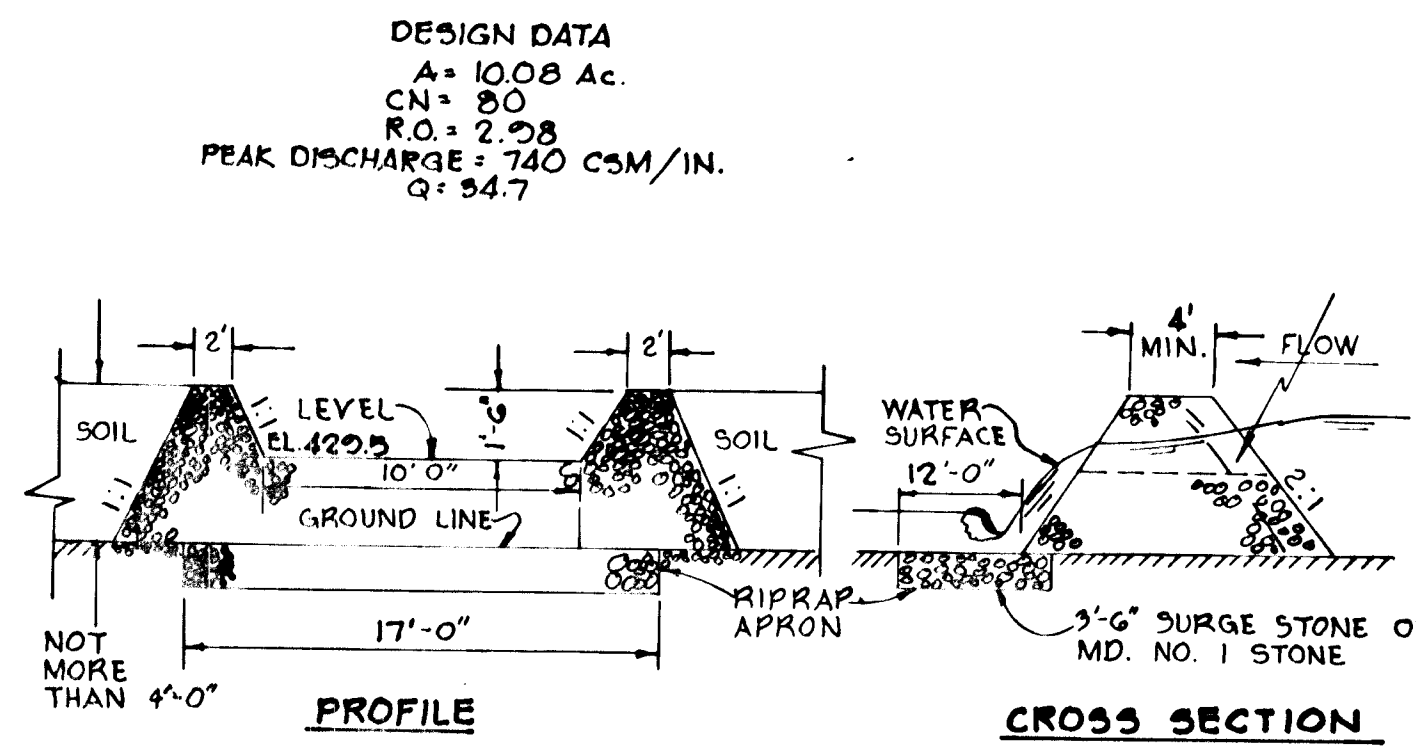

**DESIGN DATA**  
A = 10.08 Ac.  
CN = 80  
R.O. = 2.28  
PEAK DISCHARGE = 740 CSM/IN.  
Q = 54.7

**STONE OUTLET STRUCTURE FOR SEDIMENT TRAP NO. 2**  
No Scale

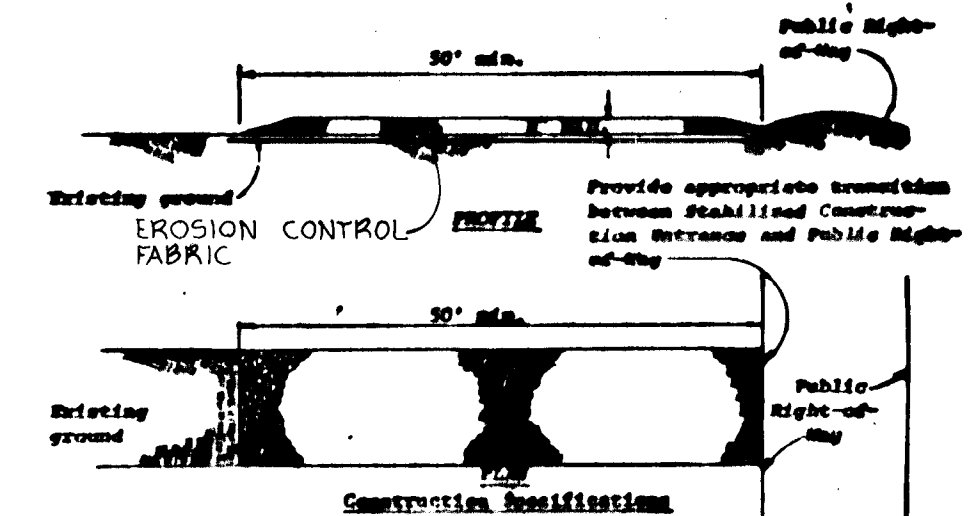

- Construction Specifications**
1. Stone size - See NSMA size No. 2 (3-1/2\"/>
  - 2. Length - An effective, but not less than 50 feet.
  - 3. Thickness - Not less than eight (8) inches.
  - 4. Width - Not less than full width of all portion of ingress or egress.
  - 5. Washing - When necessary, wheels shall be cleaned to remove sediment prior to entrance into public right-of-way. When washing is required, it shall be done on an area stabilized with crushed stone which drains into an approved sediment trap or sediment basin. All sediment shall be prevented from entering any storm drain, ditch, or watercourse through use of sand bags, gravel, boards or other approved methods.
  - 6. Maintenance - The entrance shall be maintained in a condition which will prevent tracking or flowing of sediment onto public right-of-way. This may require periodic top dressing with additional stone as conditions demand and repair and/or placement of any measures used to trap sediment. All sediment spilled, dropped, washed or tracked onto public right-of-way must be removed immediately.

**STABILIZED CONSTRUCTION ENTRANCE**  
No Scale

BY THE DEVELOPER:  
*Jack T. Gibson* 1-30-81  
JACK T. GIBSON DATE

BY THE ENGINEER:  
"I CERTIFY THAT THIS PLAN FOR EROSION AND SEDIMENT CONTROL REPRESENTS A PRACTICAL AND WORKABLE PLAN BASED ON MY PERSONAL KNOWLEDGE OF THE SITE CONDITIONS AND THAT IT WAS PREPARED IN ACCORDANCE WITH THE REQUIREMENTS OF THE HOWARD SOIL CONSERVATION DISTRICT."  
*James K. Tracy* 1-30-81  
JAMES K. TRACY DATE

THESE PLANS HAVE BEEN REVIEWED FOR THE HOWARD SOIL CONSERVATION DISTRICT AND MEET THE TECHNICAL REQUIREMENTS FOR SOIL EROSION AND SEDIMENT CONTROL.  
*William T. Rowe* 4-28-81  
HOWARD S.C.D. DATE

APPROVED: *William T. Rowe* 4-28-81  
HOWARD S.C.D. DATE

APPROVED: HOWARD COUNTY OFFICE OF PLANNING AND ZONING  
*William T. Rowe* 4-28-81  
CHIEF, DIVISION OF LAND DEVELOPMENT AND ZONING ADMINISTRATION DATE

APPROVED: HOWARD COUNTY DEPARTMENT OF PUBLIC WORKS  
*William T. Rowe* 5-13-81  
CHIEF, BUREAU OF ENGINEERING DATE

4-24-81 REVISIONS AS PER H.C. COMMENTS DATED 3-25-81  
DATE NO REVISION

OWNER/DEVELOPER  
MANOR LANE ASSOCIATES  
2606 BELAIR ROAD  
BALTIMORE, MARYLAND 21236

PROJECT:  
**CARTHAGE MANOR**

AREA  
2<sup>ND</sup> ELECTION DISTRICT HOWARD COUNTY, MD  
TAX MAP NO. 23 PARCEL 2

TITLE:  
SEDIMENT CONTROL DETAILS

**Riemer - Tracy & Associates, Inc.**  
8659 Baltimore National Pike  
Ellicott City, Maryland 21043  
(301) 461-2690  
Land Planning, Design & Civil Engineering

1-30-81 DATE  
DESIGNED BY: L.J.D.  
DRAWN BY: D.A.M.  
PROJECT NO: 0980  
DATE: 1-30-81  
SCALE: AS SHOWN  
DRAWING NO. 5 OF 5

F-81-80 APRIL 24, 1981