
	SHEET INDEX
SHEET NO.	DESCRIPTION
	COVER SHEET
2	ROAD PLAN & PROFILE
3	GRADING PLAN
4	SWM PLAN, DETAILS, & STORM DRAIN PROFILE
5	SEDIMENT CONTROL PLAN
6	LANDSCAPE / FOREST CONSERVATION PLAN

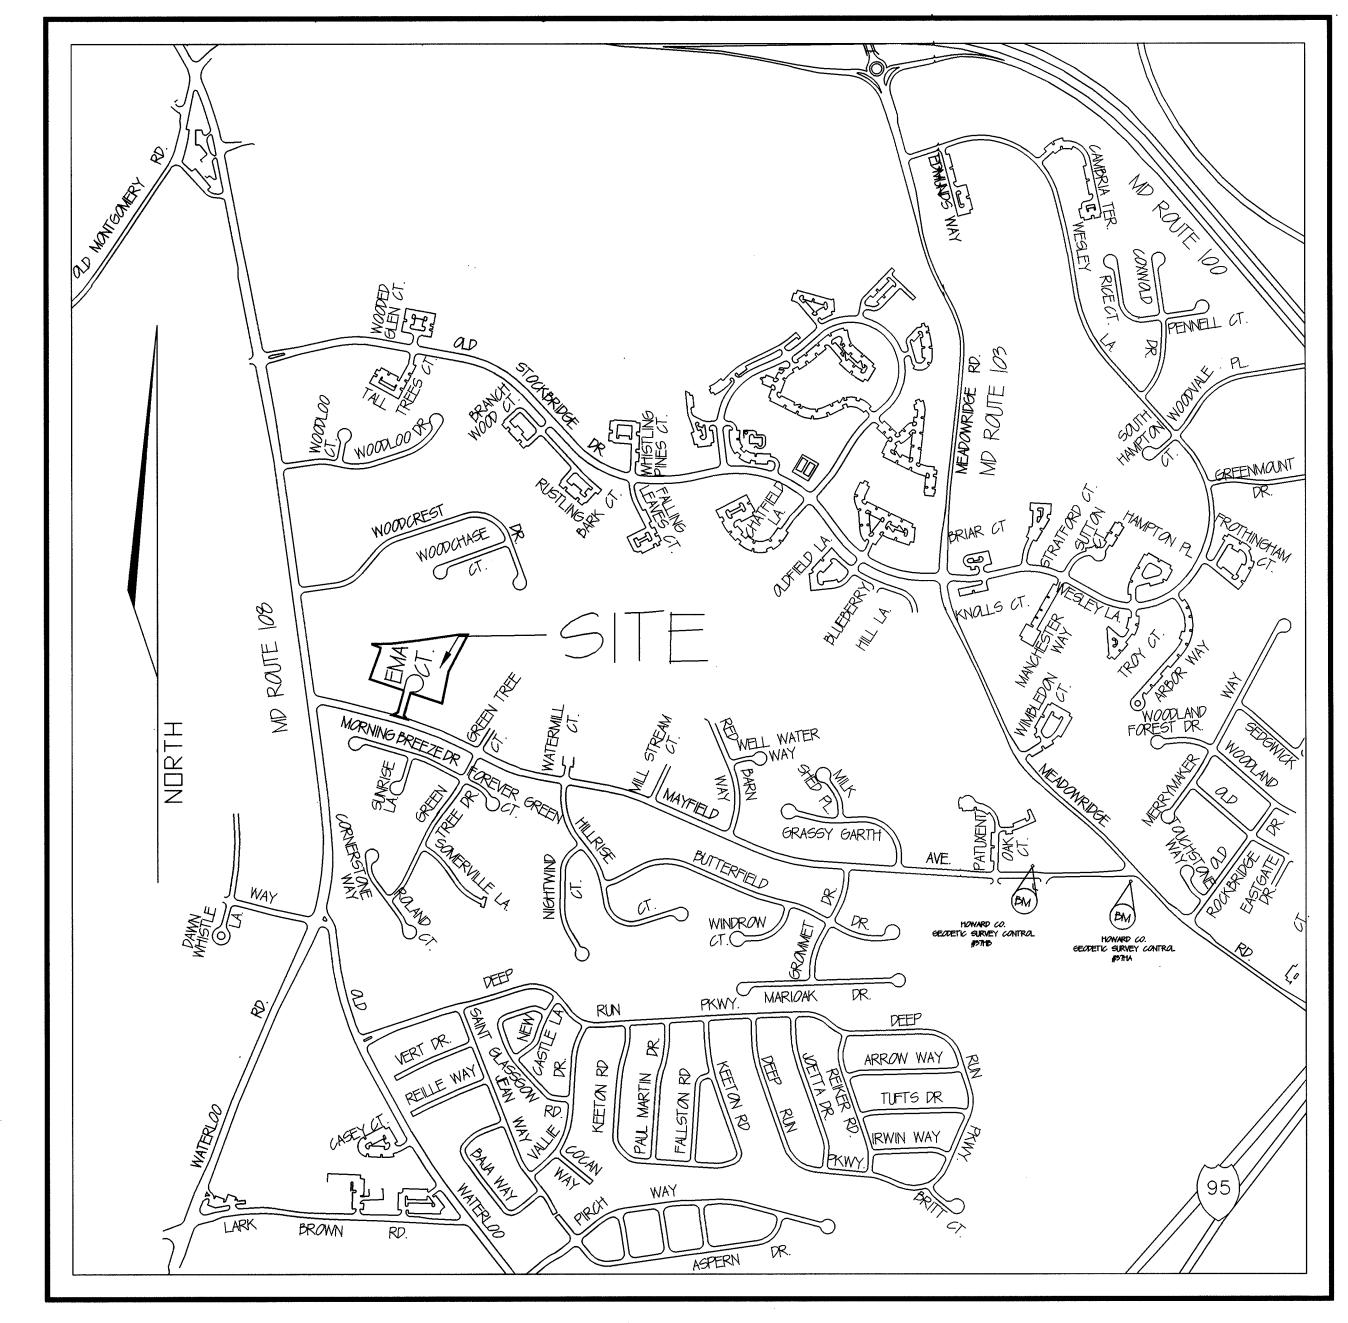

VICINITY MAP SCALE: |"=600"

# AS-BUILT FINAL CONSTRUCTION PLAN EMA'S MANOR

AS-BUILT LEGEND AS- BUILT ELEV. = 325.25 V = SATISFACTORY



REVISION

LOTS 1-9 A SUBDIVISION OF PARCEL 143 & P/O PARCEL IST ELECTION DISTRICT, TAX MAP 37, GRID 14 HOWARD COUNTY, MARYLAND

GENERAL NOTES

- I. ALL WORK SHALL BE PERFORMED IN ACCORDANCE WITH THE HOWARD COUNTY DESIGN MANUAL, VOL. IV (STANDARD SPECIFICATIONS AND DETAILS FOR CONSTRUCTION).
- 2. APPROXIMATE LOCATIONS OF EXISTING UTILITIES ARE SHOWN. THE CONTRACTOR SHALL TAKE ALL NECESSARY PRECAUTIONS TO PROTECT THE EXISTING UTILITIES AND MAINTAIN UNINTERRUPTED SERVICE. ANY DAMAGE INCURRED DUE TO CONTRACTOR'S OPERATION SHALL BE REPAIRED IMMEDIATELY AT THE CONTRACTOR'S EXPENSE.
- 3. THE CONTRACTOR SHALL TEST PIT UTILITIES AT LEAST FIVE (5) DAYS BEFORE STARTING WORK SHOWN ON THESE DRAWINGS.
- 4. CONTRACTOR SHALL NOTIFY THE FOLLOWING UTILITIES AT LEAST FIVE (5) DAYS BEFORE STARTING WORK SHOWN ON THESE DRAWINGS:
- MISS UTILITY BELL TELEPHONE SYSTEM 410-393-3649 LONG DISTANCE CABLE DIVISION 410-393-3553 BALTIMORE GAS & ELECTRIC CO. 410-539-8000 x691 COLONIAL PIPELINE 410-795-1390 HOWARD COUNTY BUREAU OF UTILITIES 410-992-2366 HOWARD COUNTY CONSTRUCTION INSPECTION DIVISION
  (24 HR NOTICE BEFORE COMMENCEMENT OF WORK) 410-313-1872
- 5. ALL INLETS SHALL BE CONSTRUCTED IN ACCORDANCE WITH HOWARD COUNTY STANDARDS.
- 6. ALL STREET CURB RETURNS SHALL HAVE A 35' RADIUS UNLESS OTHERWISE NOTED.
- 7. STORM DRAIN TRENCHES WITHIN THE ROAD RIGHT-OF-WAY SHALL BE BACKFILLED AND COMPACTED IN ACCORDANCE WITH HOWARD COUNTY DESIGN MANUAL VOL. IV (STANDARD SPECIFICATIONS AND DETAILS FOR CONSTRUCTION).
- 8. INSTALLATION OF TRAFFIC CONTROL DEVICES, MARKING, AND SIGNAGE SHALL BE IN ACCORDANCE WITH THE MOST CURRENT EDITION OF THE MUTCO.
- 9. THE CONTRACTOR SHALL NOT INSTALL PIPE UNTIL THE LENGTH CALLED FOR AT EACH STATION HAS BEEN APPROVED BY THE ENGINEER IN THE FIELD.
- 10. DESIGNED TRAFFIC SPEED IS IN ACCORDANCE WITH THE AMERICAN ASSOCIATION OF STATE HIGHWAY OFFICIAL STANDARDS.
- II. ALL ELEVATIONS SHOWN ARE BASED ON U.S.C. AND G.S. MEAN SEA LEVEL, DATUM, 1929.
- 12. ALL FILL AREAS WITHIN THE ROADWAY AND UNDER STRUCTURES ARE TO BE COMPACTED TO A MINIMUM OF 95% COMPACTION IN ACCORDANCE WITH AASHTO T-180.
- 13. ALL PIPE ELEVATIONS SHOWN ARE INVERT ELEVATIONS.
- 14. PROFILE STATION SHALL BE ADJUSTED AS NECESSARY TO CONFORM TO PLAN
- 15. SUBJECT PROPERTY ZONED R-SC PER 10/18/93 COMPREHENSIVE ZONING PLAN. 16. THE PROJECT BOUNDARY IS BASED ON A BOUNDARY SURVEY PERFORMED BY
- FREDERICK WARD ASSOCIATES IN APRIL, 2001. 17. THE TOPOGRAPHY SHOWN IS BASED ON A SURVEY PERFORMED BY FREDERICK WARD
- ASSOCIATES IN DECEMBER, 2000. 18. COORDINATE DATUM IS BASED ON THE MARYLAND STATE PLANE COORDINATE SYSTEM
- (NAD 83) AS PROJECTED BY THE FOLLOWING HOWARD COUNTY GEODETIC CONTROL STATIONS: 37HA & 37HB.
- 19. NO PIPE SHALL BE LAID UNTIL LINES OF EXCAVATION HAVE BEEN BROUGHT TO WITHIN 6'' OF FINISHED GRADE.
- 20. ALL STORM DRAIN PIPE BEDDING SHALL BE AS SHOWN IN FIG 11.4, VOL. I OF THE HOWARD COUNTY DESIGN MANUAL UNLESS OTHERWISE NOTED.
- 21. NO CLEARING, GRADING & CONSTRUCTION WILL OCCUR OR IS PERMITTED WITHIN THE WETLAND BUFFER & 75' STREAM BUFFER.
- 22. THE FOREST CONSERVATION OBLIGATION FOR REFORESTATION AND AFFORESTATION, INCURRED BY THE SUBDIVISION SHOWN HEREON, 133 ACRES HAS BEEN SATISFIED BY THE AQUISITION OF 1.20 ACRES OF FOREST MITIGATION CREDITS FROM ENVIRONMENTAL BANC & EXCHANGE LLC. (EXB) BY EMA'S MANOR LLC. (EXB) SHALL DELIVER TO HOWARD COUNTY ANY AND ALL DOCUMENTS RELATING TO THE FOREST MITIGATION. AND THAT THE OUTSTANDING REFORESTATION OPLIGATION OF 0.13 ACRES HAS BEEN MET BY A FEE-IN-LIEU PAYMENT OF \$2,831.40 TO THE HOWARD CO. FOREST CONSERVATION FUND.
- 23. AS A RESULT OF THE PRELIMINARY PLAN FOR THIS SUBDIVISION, P-OI-18, BEING SUBMITTED TO THE COUNTY FOR REVIEW PRIOR TO 11/15/01, IT IS SUBJECT TO COMPLIANCE WITH THE FOURTH EDITION OF THE SUBDIVISION AND LAND DEVELOPMENT REGULATIONS. IN ADDITION , BECAUSE THE PRELIMINARY PLAN FOR THIS SUBDIVISION DID OBTAIN SIGNATURE APPROVAL PRIOR TO 11/01/01, ON 06/23/01, THIS SUBDIVISION IS SUBJECT TO COMPLIANCE WITH ZONING REGULATIONS ADOPTED ON 10/18/93 AND AMENDED ON 07/12/01.
- 26. HOWARD COUNTY FILE NO.'S: F- 02-54, DPZ NO. S-00-11, P-01-18, WP-02-62 & WP-02-120
- 27. THE SCHOOL BUS PAD IS TO BE OWNED AND MAINTAINED BY THE HOME OWNER ASSOCIATION
- 28. PLAN OF THE SUPPIVISION SHOWN HEREON IS SUBJECT TO A WAIVER FROM THE REQUIREMENTS OF SECTION 16.192(a)(3)(i)(b) TO CONSTRUCT IMPROVEMENTS TO A MAJOR COLLECTOR ROAD, SPECIFICALLY TO CONSTRUCT ACCEL/DECEL LANES ALONG THE NORTHSIDE OF MAYFIELD AVENUE AT THE INTERSECTION OF EMAS COURT. WP-02-62 APPROVED MARCH 4, 2002
- 29. PLAN OF THE SUPPIVISION SHOWN HEREON IS SUBJECT TO A WAIVER FROM THE REQUIREMENTS OF SECTIONS 16.144(a) and (f), 16.145, and 16.146 TO NOT BE REQUIRED TO SUBMIT SKETCH AND PRELIMINARY PLANS FOR THE PROPOSED ADDITION OF LAND (P/O PARCEL 125) TO A MAJOR SUPPIVISION (F-O2-54, EMA'S MANOR); AND SECTION 16:121(e)(1) TO PERMIT THE REQUIRED PUBLIC ROAD FRONTAGE FOR OPEN SPACE TO BE REDUCED TO: 20 FEET FOR PROPOSED OPEN SPACE LOT 2, WOODCREST, SECTION 2 WITHOUT REQUIRES THE ADJACENT SIDE BRL'S ON ADJACENT LOTS TO BE INCREASED BY 10 FEET AND. ZERO FEET FOR THE TWO PROPOSED OPEN SPACE PARCELS, SHOWN AS LOTS 10 & 11. FILE NO. WP-02-120 APPROVED JULY 30, 2002
- 30. STORMWATER WILL BE PROVIDED BY AN INFILTRATION BASIN. SWM FACILITY WILL BE OWNED & MAINTAINED

EMA'S MANOR, LLC 946-A MARIMICH CT. ELDERSBURG, MD 21784 CHATEAU HOMES, INC. 5850 WATERLOO RD. (STE 230) COLUMBIA, MD, 21045—1943

DEVELOPER: FAIRMONT REAL ESTATE SERVICES 946-A MARIMICH CT. ELDERSBURG, MD 21784

"AG-BUILT"

## EMA'S MANOR


TAX MAP 37 GRID 14 IST ELECTION DISTRICT


PARCEL 143, P/0 125 HOWARD COUNTY, MARYLAND

CHARLES R. CROCKEN AND ASSOCIATES, INC. Civil Engineering — Land Planning PO Box 301 Westminster, MD 2||57 Tel. (4|0) 549-2708 Fax. (4|0) 549-9063

AX MAP 37, BLK 14, PARCEL 134 PROJECT NO: DESIGNED BY: SCALE: AS SHOWN DRAWN BY: L.A.B.

> DRAWING NO. \_\_\_\_ OF \_\_6\_\_ F-02-54

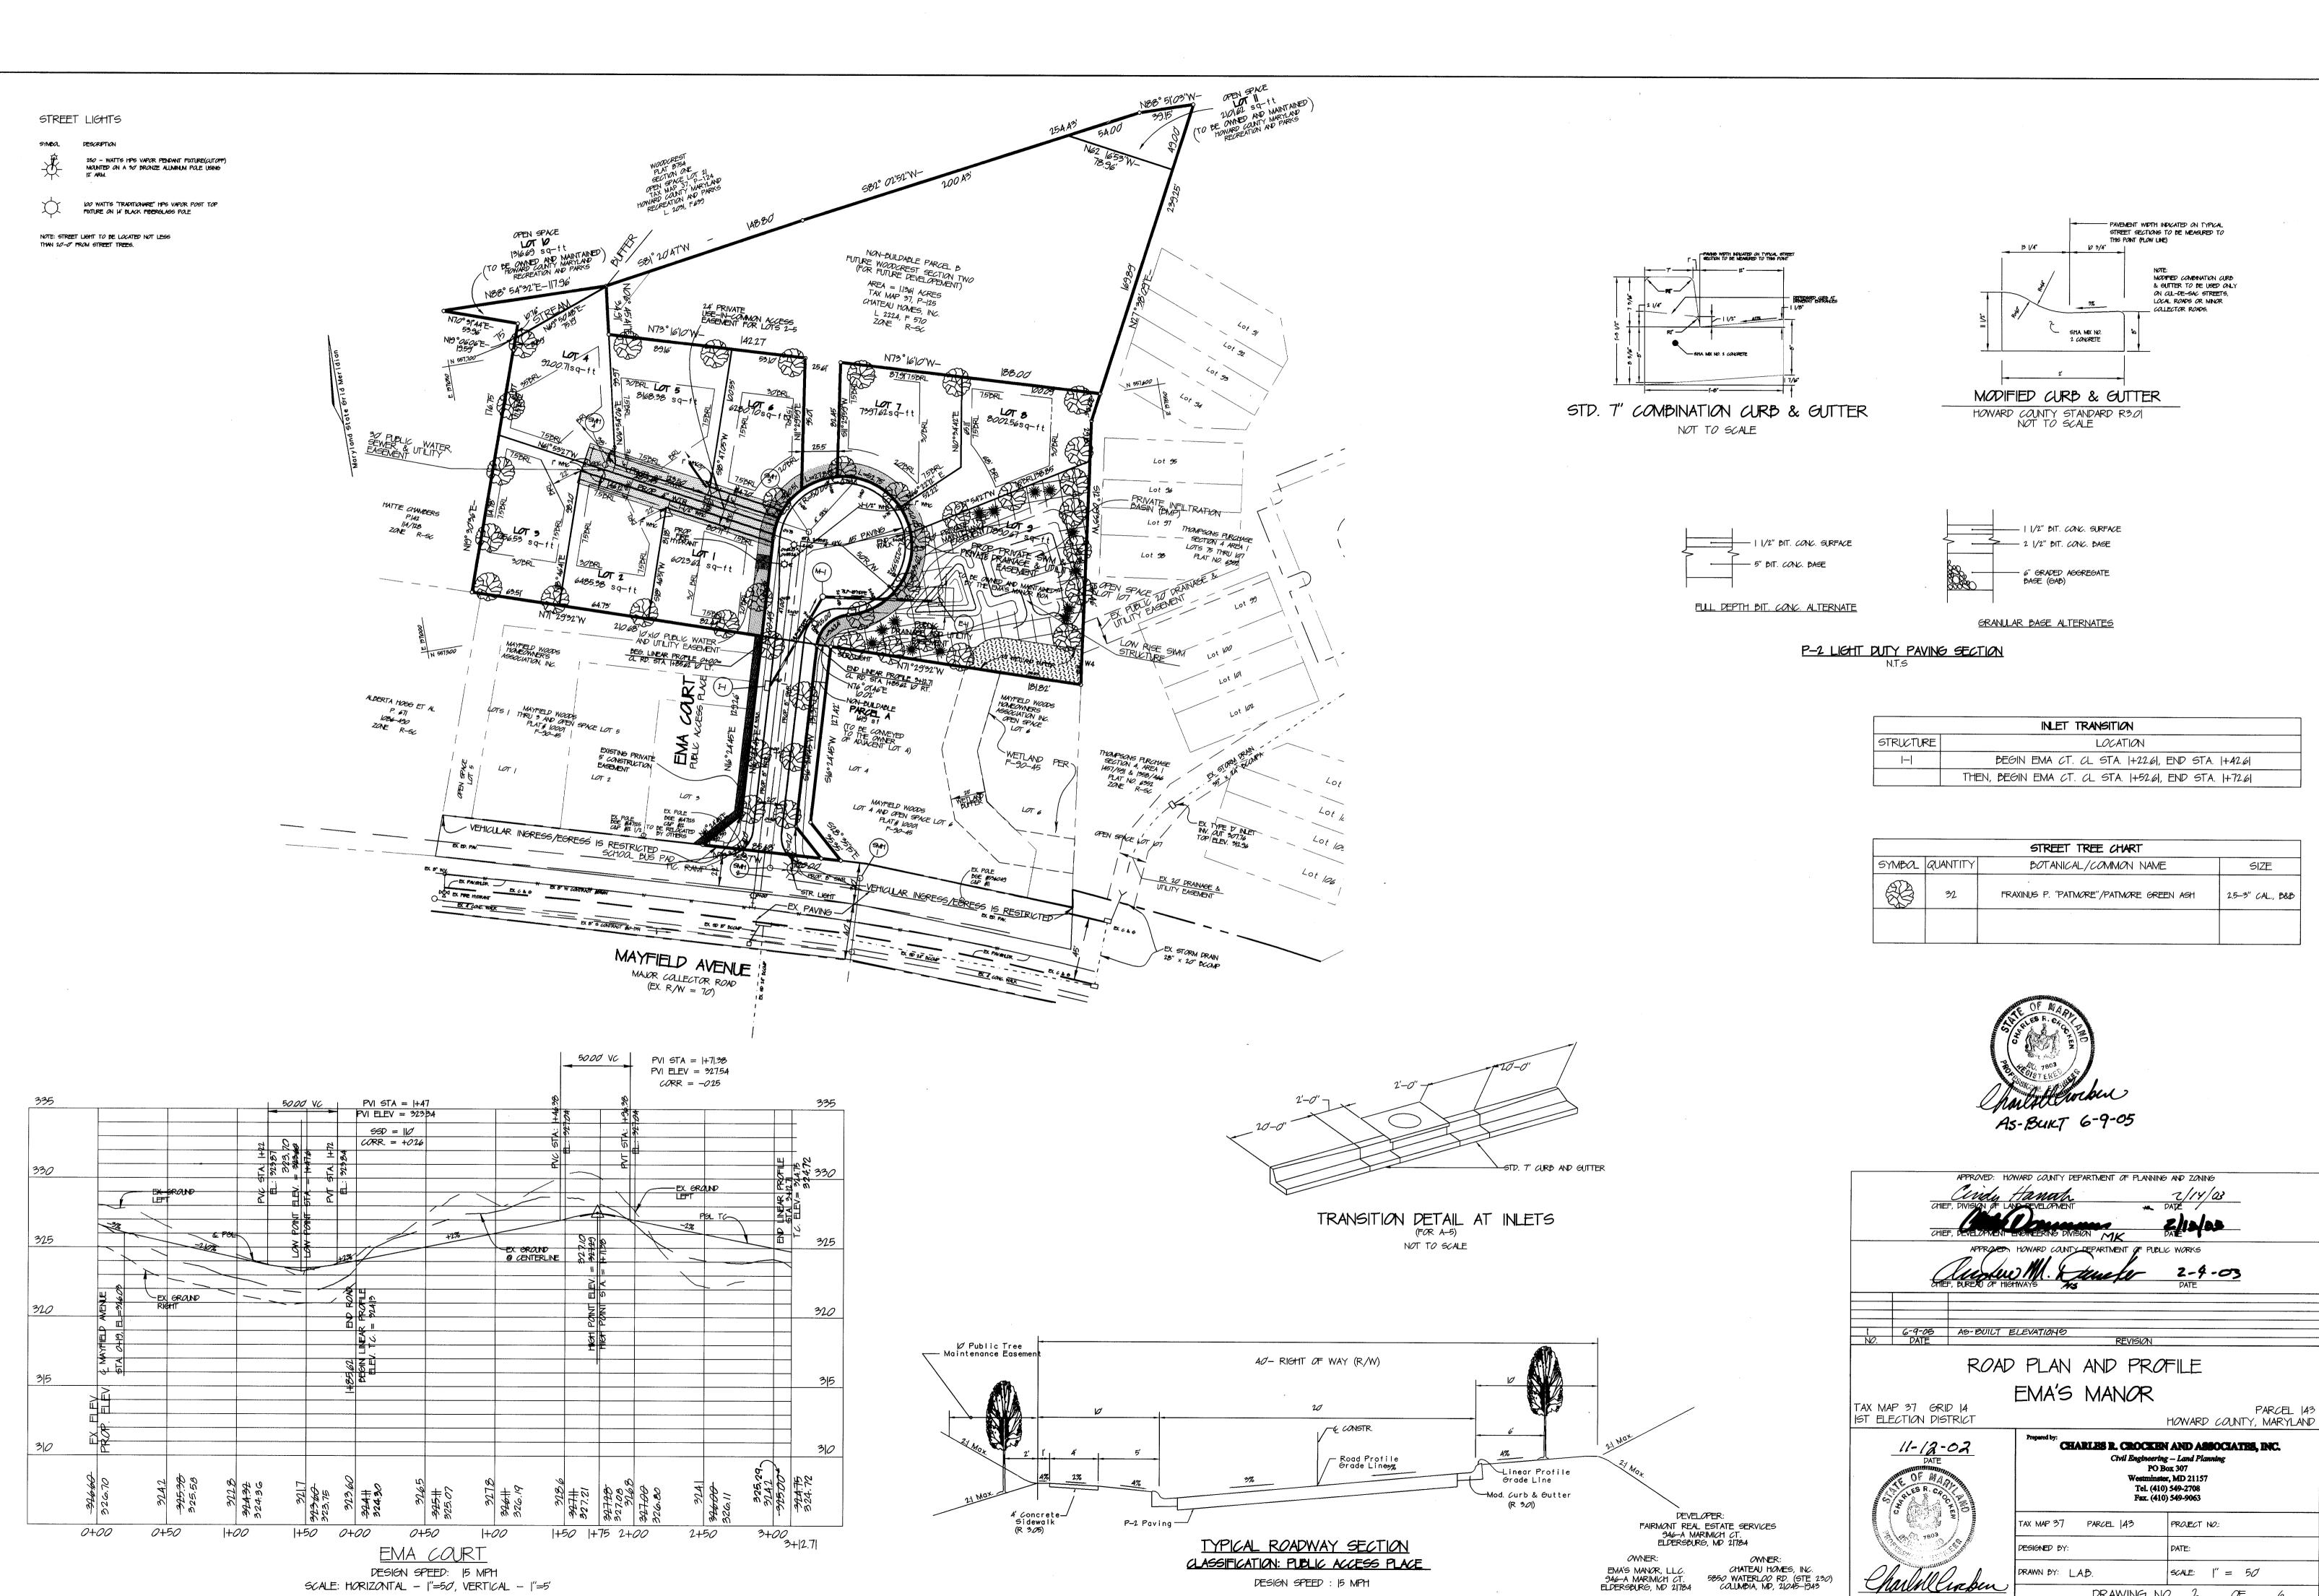

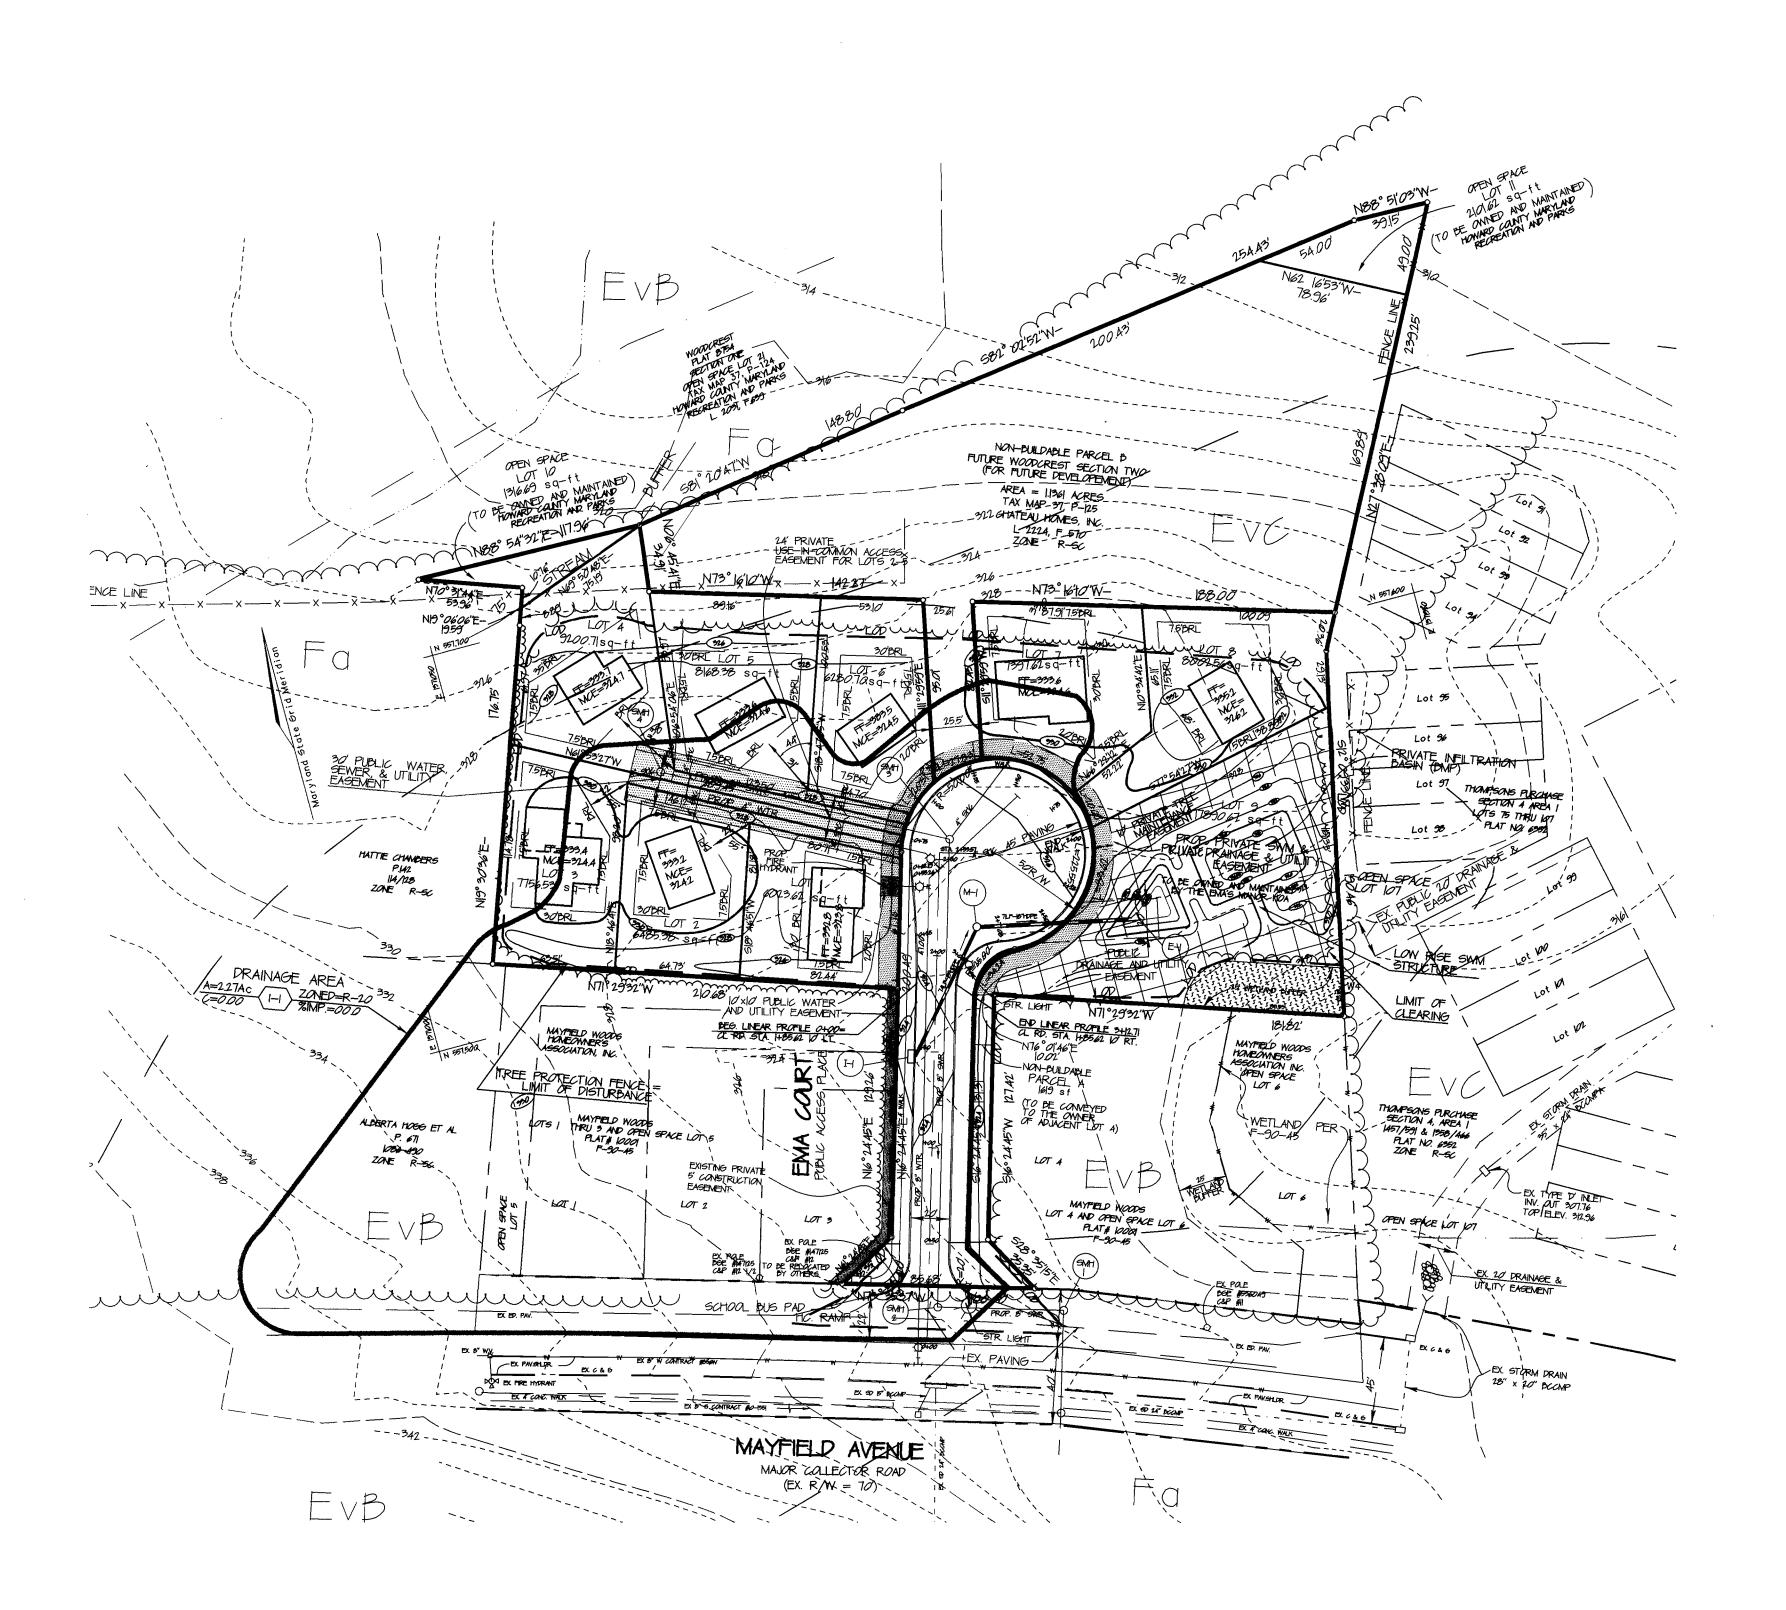


### REQUIRED SEQUENCE OF CONSTRUCTION:

- 1. OBTAIN GRADING PERMIT 3 DAYS
- 2. INSTALL TREE PROTECTION DEVICE 2 DAYS
- 3. INSTALL STABILIZED CONSTRUCTION ENTRANCE 1 DAY
- CLEAR AND GRUB AREAS FOR INSTALLING SILT FENCE AND PERIMETER DIKES/SWALES – 4 DAYS
- 5. INSTALL SILT FENCE /SUPER SILT FENCE AND PERIMETER DIKES/SWALES 1-1/2 WFFKS
- 6. ROUGH GRADE SITE TO LIMITS OF DISTURBANCE 2 WEEKS
- 7. CONSTRUCT ROAD SUBBASE 2 WEEKS
- 8. CONSTRUCT INITIAL PHASE OF SWM FACILITY IN ACCORDANCE WITH CONSTRUCTION SEQUENCE FOR SWM FACILITY NOTE #3 AND INSTALL 18' PIPE FOR CLEAN WATER.
- 9. CONSTRUCT STORM DRAINS AND OTHER UTILITIES AND INSTALL INLET PROTECTION AND SILT FENCE IN FRONT OF LOTS # 1, 6, 7, & 8. 5 WEEKS
- 10. REMOVE STABILIZED CONSTRUCTION ENTRANCE AND CONSTRUCT BASE COURSE
- FOR EMA COURT 1 WEEK

  11. STABILIZE, SEED AND MULCH ALL DISTURBED AREAS 1 WEEK
- 12. UPON APPROVAL OF THE SEDIMENT CONTROL INSPECTOR, REMOVE ALL SEDIMENT CONTROL DEVICES EXCEPT THE SEDIMENT CONTROL MEASURES AROUND THE INFILTRATION BASIN 1 WEEK
- 13. CONSTRUCT INFILTRATION BASIN IN ACCORDANCE WITH CONSTRUCTION
  SEQUENCE. REMOVE ALL SEDIMENT CONTROL MEASURES AROUND BASIN,
  STABILIZE, AND PERMANENTLY SEED AND MULCH ALL AREAS DISTURBED DURING
  CONSTRUCTION 1-1/2 WEEKS

	SOILS LEGEND	
SYMBAL	NAME/DESCRIPTION	sal eraip
Ev₿	EVESBORD LOAMY SAND, 1% TO 5% SLOPES	Α
Evc	EVESBORD LOAMY SAND, 5% TO 15% SLOPES	Α
Fa	FALLINGSTON LOAM	₿/D

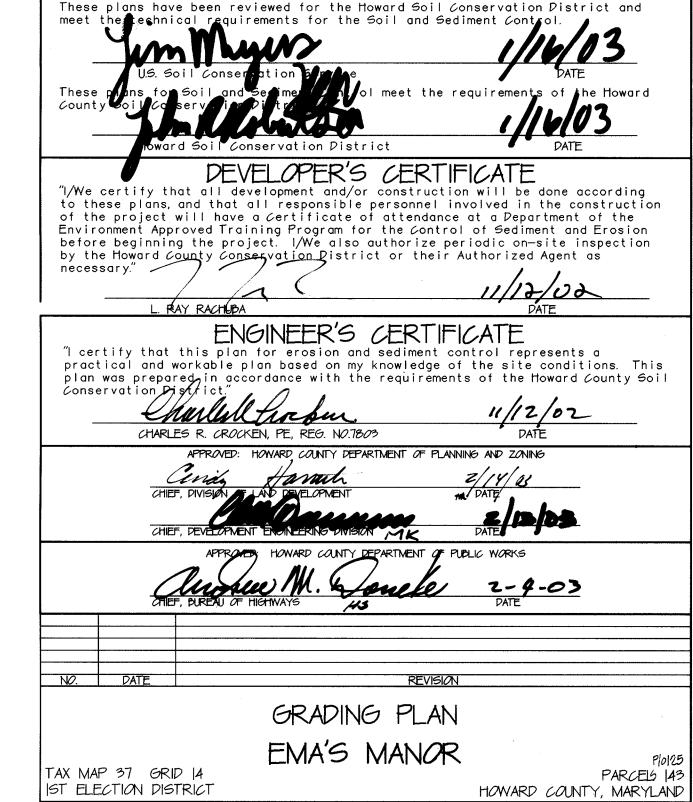

Existing Contour
Proposed Contour
Spot Elevation
Direction of Flow

Existing Trees to Remain


Light Poles

The poly and th

DEVELOPER: FAIRMONT REAL ESTATE SERVICES 946-A MARIMICH CT. ELDERSBURG, MD 21784

OWNER:
CHATEAU HOMES, INC.
5850 WATERLOO RD. (STE 230)
COLUMBIA, MD, 21045-1943

EMA'S MANOR, LLC.
946-A MARIMICH CT.
ELDERSPURG, MD 21784

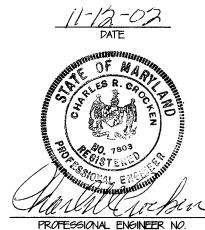

CHARLES R. CROCKEN AND ASSOCIATES, INC.

Civil Engineering — Land Planning
PO Box 307

Westminster, MD 21157
Tel. (410) 549-2708
Fax. (410) 549-9063

TAX MAP 37 PARCEL |43, P|0 |25 PROJECT NO:

DESIGNED BY:

DRAWN BY: LAB.

DRAWING NO. \_3\_ OF \_6\_

F-02-54


# #F=333.6 PROP. PRIVATE, SWM PRIVATE DRAINAGE & UTILITY OPEN SPACE 17890.67 sq-ft TO BE OWNED AND MAINTAINED BY THE EMA'S MANOR HOA PRIVATE INFILTRATION BASIN (BMP=WATER QUALITY BOTTOM = 34 x 16 ELEV. = 316.55 BOTTOM = 12'x12'x12'

# STORMWATER MANAGEMENT FACILITY (INFILTRATION)

SCALE: 1'=30' STORMWATER MANAGEMENT FACILITY TO BE OWNED BY THE HOME OWNERS ASSOCIATION AND JOINTLY MAINTAINED BY H.O.A. AND HOWARD COUNTY SEE MAINTENANCE AND OPERATION SCHEDULE

### 335 INFILTRATION BASIN FOREBAY FOR Way. & Rev. CENTERLINE U INITIAL EXCAVATION 320.09 旦=32000 一 "FOREBAY FL =38.50 18" HDPE 8 050% NOTE: ALL RIP-RAP SHALL BE V POND EXCAVATION: CLASS I do=9.5", 19" TH. O INTIAL EXCAVATION = FOREBAY (316.55) & BASIN (310.00) O FINAL EXCAVATION = FOREBAY (316.55) & BASIN (318.50) 318.20 INCL. RIPRAP & SAND AS SHOWN.

SECTION A-A THROUGH INFILTRATION BASIN SCALE: HORIZONTAL - 1"=30" VERTICAL - 1"=5"

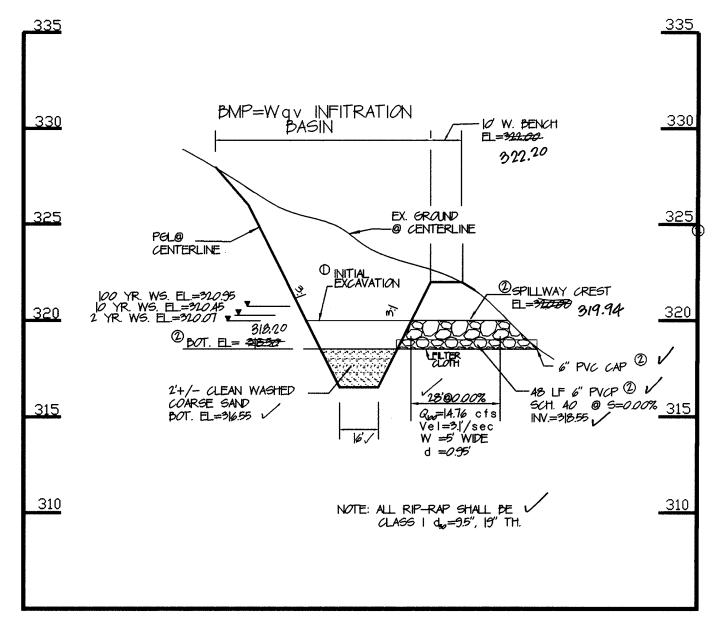


SECTION B-B THROUGH INFILTRATION BASIN SCALE: HORIZONTAL - 1"=30" VERTICAL - 1"=5"

#### MAINTENANCE AND OPERATION SCHELLLE:

- I. DRAINAGE SYSTEMS MUST BE INSPECTED ON A ROUTINE BASIS TO ENSURE THAT THEY ARE FUNCTIONING PROPERLY. INSPECTION SHALL BE DONE ON A SEMIANNUAL BASIS BUT SHOULD ALWAYS BE CONDUCTED FOLLOWING MAJOR STORMS, TO REMOVE ACCUMILATED PAPER TRASH AND DEBRIS. THE COLLECTION OF TRASH AND DEBRIS SHALL BE DONE BY THE HOMEOWNERS ASSOCIATION.
- 2. THE COUNTY SHALL INSPECT THE INFILTRATION BASIN ANNUALLY ANY REPAIR REQUIRED SHALL BE DONE BY COUNTY AND THE HOMEOWNERS ASSOCIATION.
- 3. WHENEVER SILT HAS ACCUMULATED MORE THAN 4 INCHES IN THE FOREBAY, THE INFILTRATION BASIN SHALL BE CLEANED OF SILT DEPOSIT. REMOVAL SHALL BE DONE IN ACCORDANCE WITH SEDIMENT REMOVAL IN
- ITRACTORS BE EMPLOYED FOR THESE OPERATIONS.IN THE EVENT HEAVY EQUIPMENT HAS CAUSED DEEPER THAN NORMAL COMPACTION OF THE SURFACE, THESE OPERATIONS SHALL BE PRECEDED BY DEEP PLOWING. IN ITS FINAL CONDITION AFTER TILLING, THE BASIN FLOOR SHALL BE LEVEL, SMOOTH, AND FREE OF RIDGES AND FURROWS TO EASE FUTURE REMOVAL OF SEDIMENT AND MINIMIZE TEH MATERIAL TO BE REMOVED DURING THE FUTURE CLEANING OPERATIONS. A LEVELING DRAG, TOWED BEHIND THE EQUIPMENT ON THE LAST PASS WILL
- 5 THROROUGH TILLIG SHALL BE DONE ONCE EACH SEASON, FROM LATE JUNE TO SEPTEMBER.
- 1/2 TO CONTROL VEGETATIVE GROWTH AN ADDITION LIGHT TILLAGE IS ADVISABLE DURING THE GROWING SEASON.

  PRECAUTION SHALL BE TAKEN TO AVOID ANY SEDIMENT ACCUMULATION INTO THE BASIN FLOOR. ALL TILLING OPERATIONSS SHALL BE PRECEDED BY CAREFUL SEDIMENT REMOVAL.
- 1) VEGETATION ON THE TOP AND SIDE SLOPES SHALL NOT BE ALLOWED TO EXCEED IS INCHES IN HEIGHT AT ANY TIME MOWING OF THE BASIN'S SIDE SLOPES AT LEAST TWICE A YEAR, ONCE IN JUNE AND AGAIN IN SEPTEMBER
- 6.AFTER THE SECOND YEAR OF SEEDING, REFERTILIZE THE BASIN WITH 10-6-4 RATIO FERTILIZER AT A RATE OF 500 LBS. PER ACRE OR ILBS PER 1000 SQ-FT.

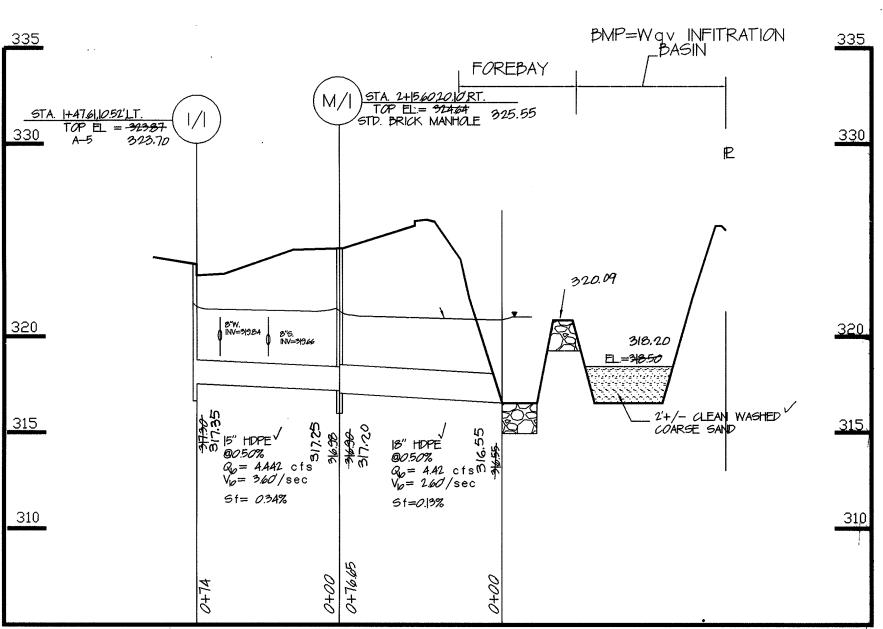

STORMDRAIN PROFILE SCALE: HURIZUNTAL - 1"=50" VERTICAL - 1"=5"

STRUCTURE SCHEDULE								
NUMBER	TYPE	INV. IN	INV. OUT	TOP ELEV.	REMARKS	LOCATION		
1/  -	A5		317.49 317.35	323.70	HO. CO. SD.4.01	STA.  +47.6 , 0.52'LT.		
M/I	STD.	37.12317.25		-	HO. CO. 65.01	STA. 2+1560,20.10,RT.V		
E9-I	END SECTION		3/6.59 V	318.24 318.00	HO. CO. 65.0	N557472.9  9 V E 37  368.2326		



	STO	ORM WATE	R MANAGEME	ENT DATA	
DESIGN STORM	EXIST.	PEAK	ST	PRAGE	PEAK
ST <i>O</i> RM	EXIST. RUNAFF	FLOW	REQUIRED	PROVIDED	W.S. ELEV.
2 YEAR	<i>000</i> cfs	2.07 cfs	NONE	N/A	32002
10 YEAR	<i>0.00</i> cfs	7.37 cfs	NONE	N/A	320.35
00 YEAR	0.40 cfs	14.76 cfs	NONE	N/A	320.75

			WATER	QUA	ITY DA	TA -		(STRE	AM (CLASS I)	
1	WQV WATER QUALITY MANAGEMENT REV WATER RECHARGE									
AREA	ВМР	AREA	IMPERV. AC. %	Rv		TORAGE PROVIDED	D.A.	IMP. AC.	Rev REQ'D.	Rev. PROVIDED
<b>(A)</b>	INFIL	2.21	104 51	0.5	2,177 CF.	2,640 CF.	2.2	0.87	1,555 C.F.	2,640 C.F.
		N	OTE: Way A			TRATION B		OR ARE	A A	

I-YEAR PEAK FLOW = 004 cfs < 200 cfs Cpv NOT REQD.

#### PRETREATMENT PROVIDED BY FOREBAY.

#### CONSTRUCTION SEQUENCE FOR SWM FACILITY

- I. THE AREA TO BE COVERED BY THE BASIN SHALL BE CLEAR OF ALL TREES, BRUSH , LOGS, RUBBISH AND OTHER OBJECTIONABLE MATERIALS.
- 2. ALL CLEARED AND GRUBBED MATERIALS SHALL BE DISPOSED OF NO LESS THAN 25 FEET WITHIN THE BASIN LIMITS AS DIRECTED BY THE OWNER OR HIS AUTHORIZED REPRESENTATIVE OR HAULED OFF SITE.
- 3. THE SWM FACILITY SHALL BE CONSTRUCTED IN PHASES TO AVOID SEDIMENT CLOGGING THE INFILTRATION BASIN. THE INITIAL CONSTRUCTION SHALL INCLUDE EXCAVATION OF THE FOREBAY TO ELEV.=316.59 AND THE BASIN TO ELEV.=310.00 (SEE PLAN AND NOTES)
- 4. WHEN THE GRADING OR DISTURBANCE OF ALL AREAS DRAINING TO SWM FACILITY HAVE BEEN COMPLETED AND THE AREAS PERMANENTLY STABILIZED, THE FINAL PHASE EXCAVATION SHALL BE CARRIED OUT, AFTER AFTER APPROVAL FROM THE SEDIMENT CONTROL INSPECTOR IS OBTAINED.
- 5. ALL ACCUMULATED SEDIMENT ON THE BASIN SHALL BE REMOVED AND THE INFILTRATION BASIN EXCAVATED TO THE FINAL ELEVATION SHOWN ON THE PLAN. RELATIVELY LIGHT EQUIPMENT SHALL BE USED FOR THIS OPERATION TO AVOID COMPACTION OF THE BASIN FLOOR. THE MATERIAL EXCAVATED FROM THE BASIN SHALL BE PLACED AND SPREAD NO LEGS THAN 15 FEET FROM THE BASIN LIMITS WITH THE TOP SLOPING AWAY FROM THE BASIN EDGE.
- 6. AFTER THE FINAL GRADING IS COMPLETED, THE BASIN FLOOR SHALL BE DEEPLY TILLED BY MEANS OF ROTORY TILLERS OR DISC HARROWS TO PROVIDE A WELL- AERATED, HIGHLY POROUS SURFACE TEXTURE.
- 7. THE INFILTRATION BASIN SHALL BE LINED WITH A 2'+/- LAYER OF COARSE SAND TO HELP PREVENT THE BUILDING OF IMPERVIOUS DEPOSITS ON THE SOIL SURFACE.
- 8. AFTER THE INFILTRATION BASIN IS EXCAVATION TO THE GRADE SPECIFIED IN TH DRAWINGS, ESTABLISH DENSE VEGETATION ON THE BASIN SIDE SLOPES AND FLOOR TO PREVENT EROSION AND SLOUGHING WHILE WHILE PROVIDING A NATURAL MEANS OF MAINTAINING RELATIVELY HIGH INFILTRATION RATES, SELECTION OF SUITABLE VEGETATIVE MATERIALS SHALL BE DONE IN ACCORDANCE WITH MARYLAND STANDARD AND SPECIFICATIONS FOR SOIL EROSION AND SEDIMENT CONTROL.

OPERATION AN MAINTENCE SCHEDULE FOR STORM WATER MANAGEMENT INFILTRATION FACILITY. STORMWATER MANAGEMENT FACILITY ROUTINE MAINTENANCE BY HOA:

- 1. FACILITY WILL BE INSPECTED ANNUALLY AND AFTER MAJOR STORMS. INSPECTIONS SHOULD BE PERFORMED DURING MET WEATHER TO DETERMINE 18 FUNCTIONING PROPERLY.
  2. TOP AND SIDE SLOPES OF THE EMBANKMENT SHALL BE MOWED A MINIMUM OF TWO (2) TIMES A YEAR ONCE IN JUNE AND ONCE IN SEPTEMBER OTHER SIDE SLOPES AND MAINTENANCE ACCESS SHOULD BE MOWED AS
- NEEDED
  3. DEBRIG AND LITTER NEXT TO THE OUTLET STRUCTURE SHALL BE REMOVED DURING REGULAR MOWING OPERATIONS AND AS NEEDED.
  4. VISIBLE SIGNS OF EROSION IN THE POND AS WELL AS RIP RAP OUTLET AREAS SHALL BE REPAIRED AS SOON AS IT IS NOTICED
- HON-POUTINEMAINTENANCE BY HUA: 1. STRUCTURAL COMPONENTS OF THE POND SUCH AS THE DAM. THE RIGER. AND THE PIPES SHALL BE REPAIRED UPON DETECTION OF ANY DAMAGE THE COMPONENTS SHOULD BE INSPECTED DURING ROUTINE MAINTENANCE

2. SEDIMENT SHOULD BE REMOVED WHEN ITS ACCUMULATION SIGNIFICANTLY REDUCES THE DESIGN GTORAGE. INTERFERE WITH THE FUNCTION OF THE RISER. WHEN DEEMED NECESSARY FOR ABSTHETIC REASONS. OR WHEN DEEMED NECESSARY BY THE HOWARD COUNTY DEPARTMENT OF PUBLIC WORKS.

DEVELOPER: FAIRMONT REAL ESTATE SERVICES 946-A MARIMICH CT. ELDERSBURG, MD 21784

OWNER: EMA'S MANOR, LLC. 946-A MARIMICH CT. ELDERSBURG, MD 21784


OWNER: CHATEAU HOMES, INC. 5850 WATERLOO RD. (STE 230) COLUMBIA, MD, 21045-1943

APPROVED: HOWARD COUNTY DEPARTMENT OF PLANNING AND ZONING 1 6-9-05 AS-BUILT ELEVATIONS SWM PLAN, DETAILS, & STORM DRAIN PROFILE

EMA'S MANOR

TAX MAP 37 GRID 4 IST ELECTION DISTRICT

PARCEL 143 HOWARD COUNTY, MARYLAND

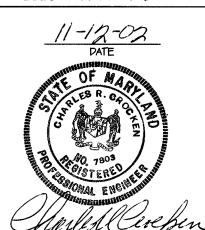



PROFESSIONAL ENGINEER NO.

CHARLES R. CROCKEN & ASSOC., INC. Civil Engineering - Land Planning PO Box 307 Westminster, MD 21157 Tel. (410) 549-2708 Fax. (410) 549-9063

TAX MAP 37 PARCEL 43, P/0125 PROJECT NO: DESIGNED BY: CRC. DATE: 8/20/02 SCALE: |'' = 50DRAWN BY: L.A.B. CHC.

> DRAWING NO. <u>4</u> OF <u>6</u> F-02-54

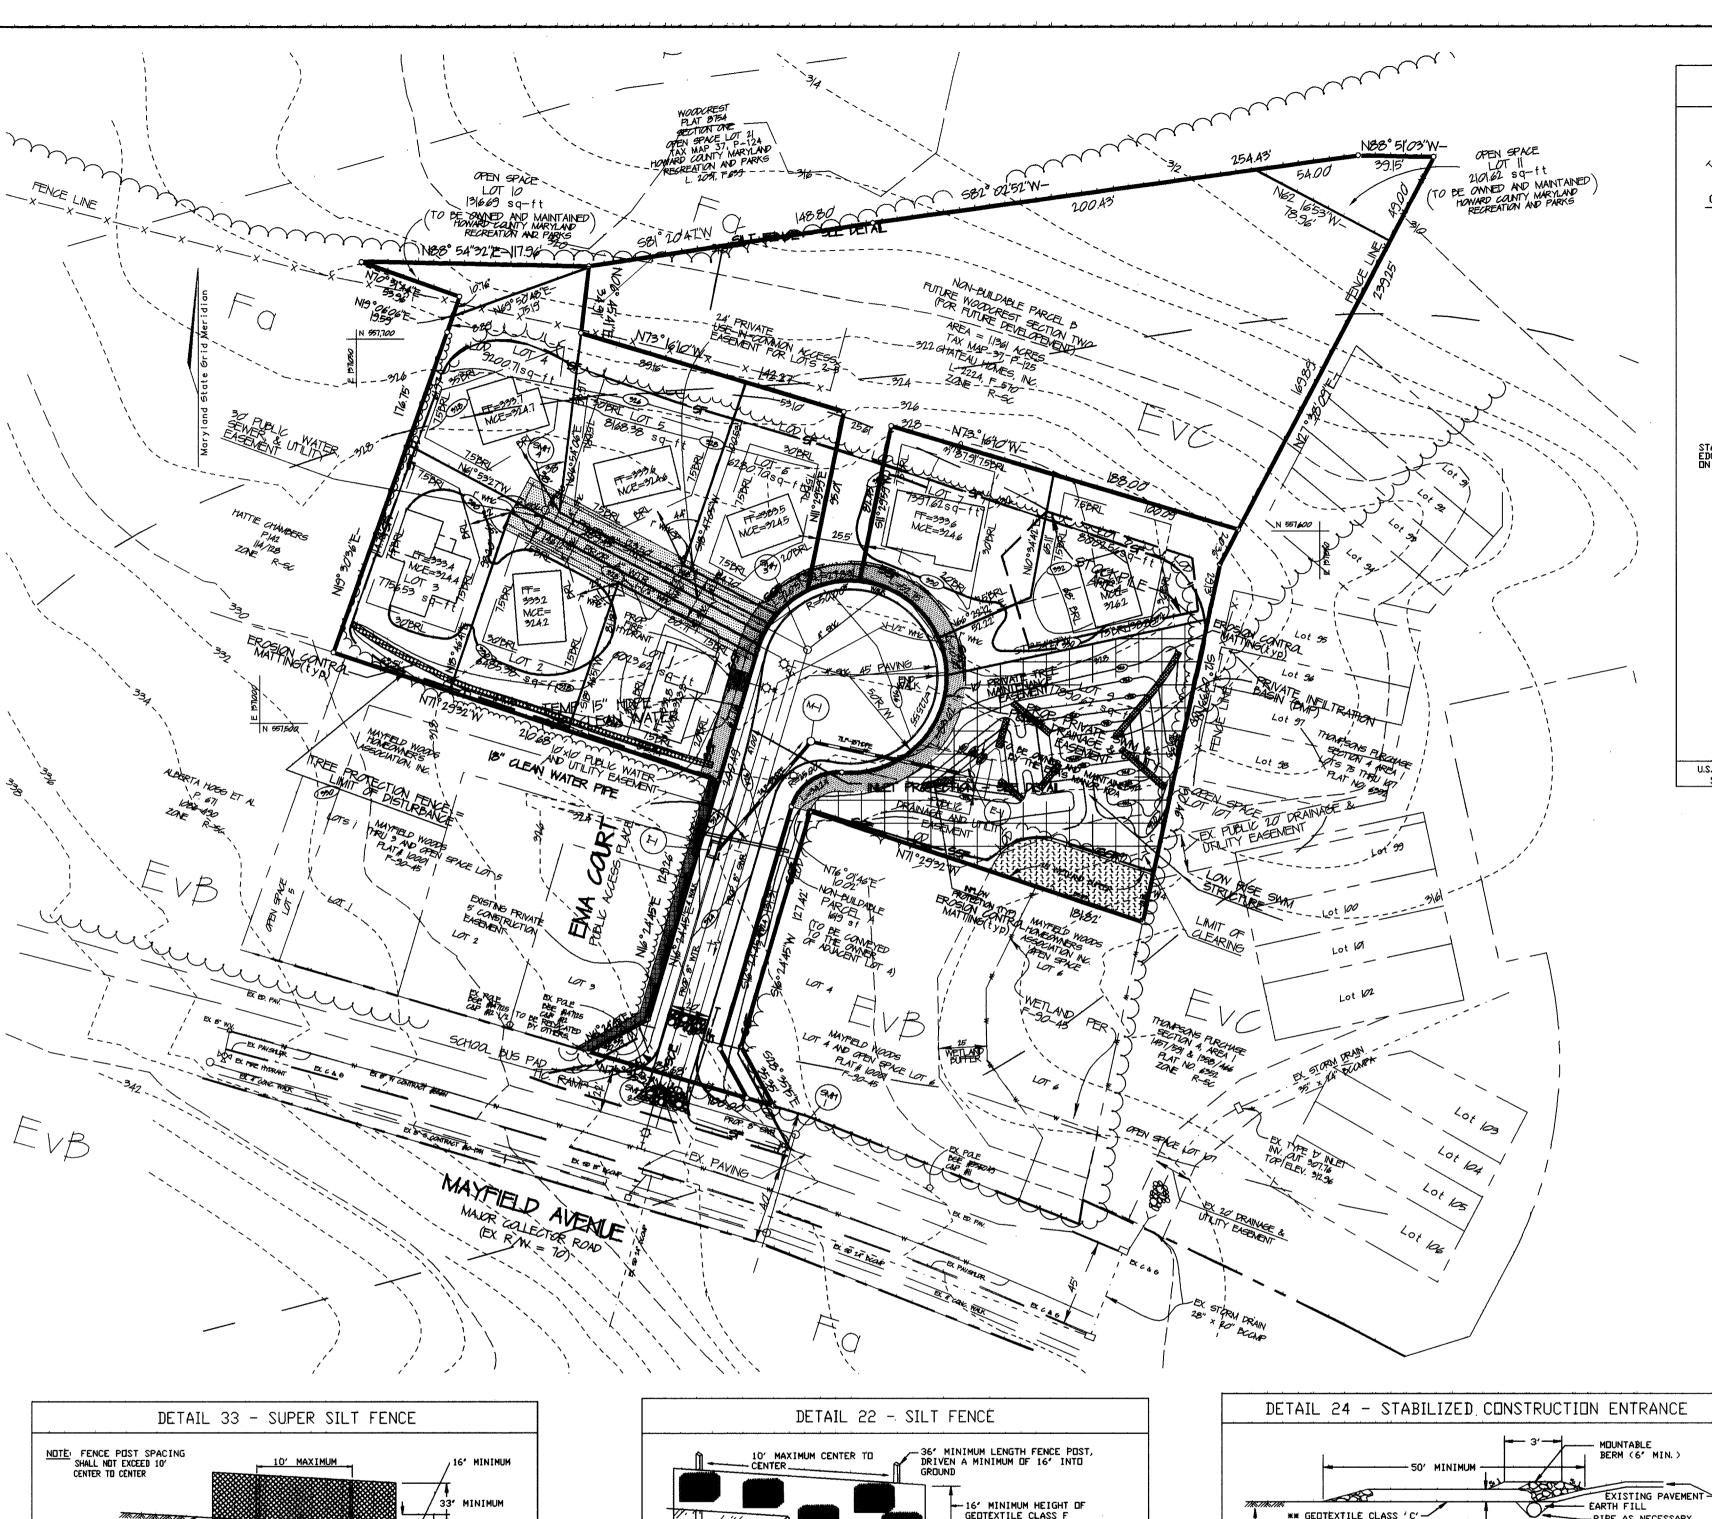

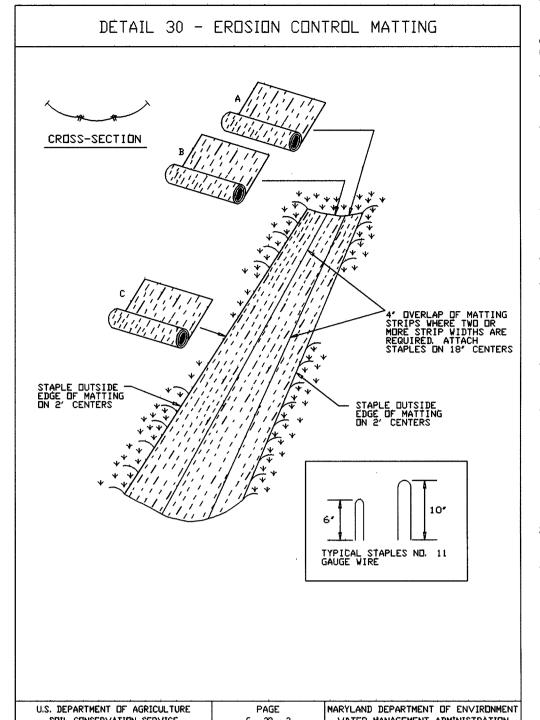

STANDARD SEDIMENT CONTROL NOTES

1) A minimum of 48 hours notice must be given to the Howard County Office of Inspection and Permits prior to the start of any construction.

2) All vegetative and structural practices are to be installed according to the provisions of this plan and are to be in conformance with the 1983 Maryland Standards and Specifications for Soil Erosion and Control.

う) Following initial soil disturbance or redisturbance, permanent or temporary stabilization shall be completed within a) 7 calendar days for all perimeter sediment control structures, dikes, perimeter slopes and all slopes greater than 5:1, b) |4 days as to all other disturbed or graded areas on the project site.

4) All sediment traps/basins shown must be fenced and warning signs posted around their perimeters in accordance with Vol. | Chap. |2 of the Howard County Design Manual, Storm Drainage.

5) All disturbed areas must be stabilized within the time period specified above in accordance with the 1983 Maryland Standards and Specifications for soil erosion and sediment control for permanent seedings (Sec. 51), sod (Sec. 54), temporary seeding (Sec. 50), and mulching (Sec. 152). Temporary stabilization with mulch alone can only be done when recommended seeding dates do not allow for proper germination and establishment of grasses.

∅) All sediment control structures are to remain in place and are to be maintained in operative condition until permission for their removal has been obtained from the Howard County Sediment Control Inspector.

7) Site analysis: Total area of site - 2001 acres

Total fill-

Area disturbed — 1.956 acres - *0.6*8 acres Area to be roofed or paved Area to be vegetatively stabilized - 1.276 acres Total cut

730 cu. yds. Offsite waste/borrow area location - n/a

3) Any sediment control practice which is disturbed by grading activity for placement of utilities must be repaired on the same day of disturbance.

9) Additional sediment controls must be provided if deemed necessary by the Howard County DPW Sediment Control Inspector.

 $|\phi\rangle$  On all sites with disturbed areas in excess of 2 acres, approval of the inspection agency shall be requested upon completion of installation of perimeter erosion and sediment controls, but before proceeding with any other earth disturbance or grading. Other building or grading inspection approvals may not be authorized until this initial approval by the inspection agency is made.

PERMANENT SEEDING NOTES

Apply to graded or cleared areas not subject to immediate further disturbance where a permanent long-lived vegetative cover is needed. Seedbed Preparation: Loosen upper 3 inches of soil by raking, discing, or other suitable means before seeding, unless otherwise loosened

Soil Amendments: In lieu of soil test

recommendations, use the following schedules: l) Preferred — apply 2 tons per acre dolomitic limestone (91 lbs./1000 sq. ft.) and 600 lbs. per acre 10-10-10 fertilizer (14 lbs./1000 sq. ft.) before seeding. Harrow or disc into upper 3 inches of soil. At time of seeding, apply 400 lbs. per acre 30-0-0 ureaform fertilizer (9

2) Acceptable - apply 2 tons per acre dolomitic limestone (91 lbs./1000 sq. ft.) and 1000 lbs. per acre 10-10-10 fertilizer (23 lbs./1000 sq. ft.) before seeding. Harrow or disc into upper inches of soil one of the following schedules.

Seeding — For the periods March | through April 30, and Aug. | through 0ct. 15, seed with 60 lbs/acre (1.4 lbs./1000 sq. ft.) of Kentucky 3 tall fescue. For the period May | through July 3|, seed with 60 Ibs./acre of Kentucky 🔊 tall fescue and 2 lbs. per acre (05 lb./1000 sq. ft) of weeping lovegrass. For the period Oct. 15 through Feb. 28 protect by: Option (1) 2 tons/acre of well-anchored straw mulch and seed as soon as pbssible in the spring; Option (2) use sod; Option (3) seed with 60 lbs./acre of Kentucky 3 tall fescue and mulch with 2 tons/acre of

Mulching - Apply |-|/2 to 2 tons/acre (70 to  $\frac{20}{100}$  lbs./|000 sq. ft.) of unrotted small grain straw immediately after seeding. Anchor mulch immediately after application using mulch anchoring tool or 218 gallons/acre (5gal./1000 sq. ft.) of emulsified asphalt on flat areas. On slopes 8 feet or higher use 348 gallons/acre (8 gallons/1000 sq. ft.) for anchoring.

Maintenance - inspect all seeded areas and make needed repairs, replacements, and reseedings. For the period Nov. 16 through Feb. 25, protect site by applying 2 tons/acre of well anchored straw mulch and seed as soon as possible in the spring, or use sod.

TEMPORARY SEEDING NOTES

These plans have been reviewed for the Howard Soil Conservation District and

meet the technical requirements for the Soil and Sediment Control

well-anchored straw.

Apply to graded or cleared areas likely to be redisturbed where a short-term vegetative

Seedbed Preparation: Laosen upper three inches of soil by raking, discing, or other acceptable means before seeding, unless previously loosened.


Soil Amendments: Apply 600 lbs./acre 10-10-10 fertilizer (14 lbs./1000 sq. ft.). Seeding: For periods March | through April 30 and August

15 through Nov. 15, seed with 2-1/2 bushels/acre (3.2 lbs./1000 sq. ft.) of annual rye. For the period May | through Nov. 14, seed with 3 | Ibs./acre (01 Ibs./1000 sq. ft.) of weeping lovegrass.

Mulching: Apply |-|/2| to 2 tons/acre (70 to 90 lbs./100 sq. ft.) of unrotted small grain straw immediately after seeding. Anchor mulch immediately after application using mulch anchoring tool or 215 gallons/acre (5gal./1000 sq. ft.) of emulsified asphalt on flat areas. On slopes & feet or higher use 34% gallons/acre (% gallons/1000 sq. ft.) for anchoring. Refer to 1994 Maryland Standards for Soil Erosion and Sediment Control for rates and methods not covered

DRAWING NO. 5 OF 6

F-02-54

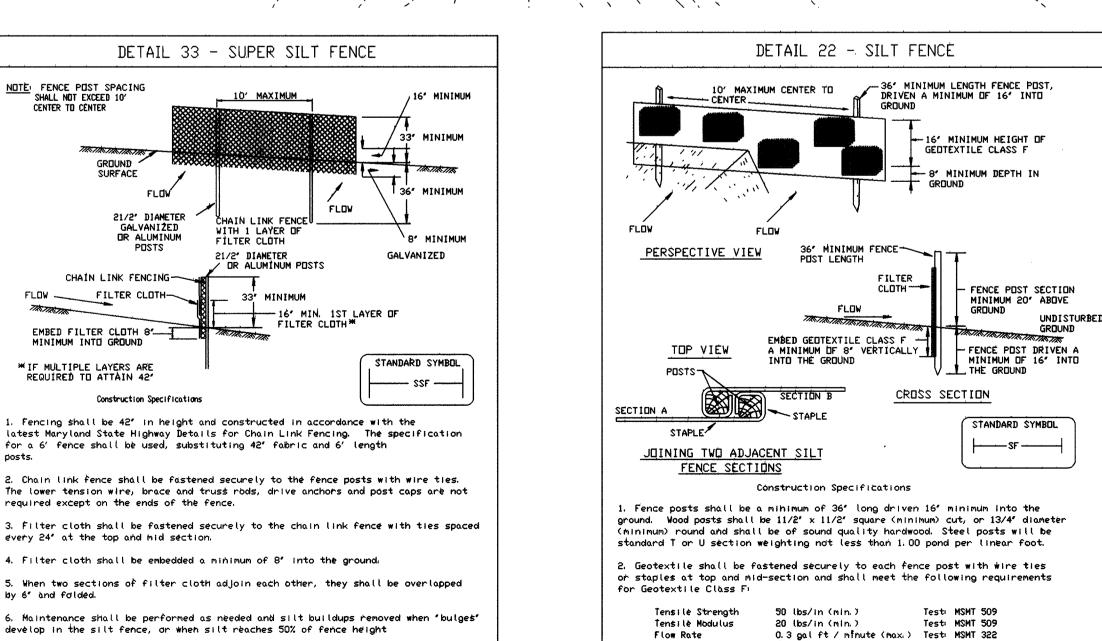

filtering Efficiency 75% (min.)

SOIL CONSERVATION SERVICE

folded and stapled to prevent sediment bypass.

3. Where ends of geotextile fabric come together, they shall be overlapped,

4. Silt Fence shall be inspected after each rainfall event and maintained when

MARYLAND DEPARTMENT OF ENVIRONMENT

E - 15 - 3 WATER MANAGEMENT ADMINISTRATION

bulges occur or when sediment accumulation reached 50% of the fabric height.

7. Filter cloth shall be fastened securely to each fence post with wire ties or

50 lbs/in (min.)

20 lbs/in (min.)

0.3 gal/ft /minute (max.)

Test: MSMT 509

Test: MSMT 509

MARYLAND DEPARTMENT OF ENVIRONMENT

WATER MANAGEMENT ADMINISTRATION

Test: MSMT 322

staples at top and mid section and shall meet the following requirements for

Geotextile Class Fi

Tensile Strength


filtering Efficiency 75% (min.)

Tensile Modulus

U.S. DEPARTMENT OF AGRICULTURE

SOIL CONSERVATION SERVICE

Flow Rate

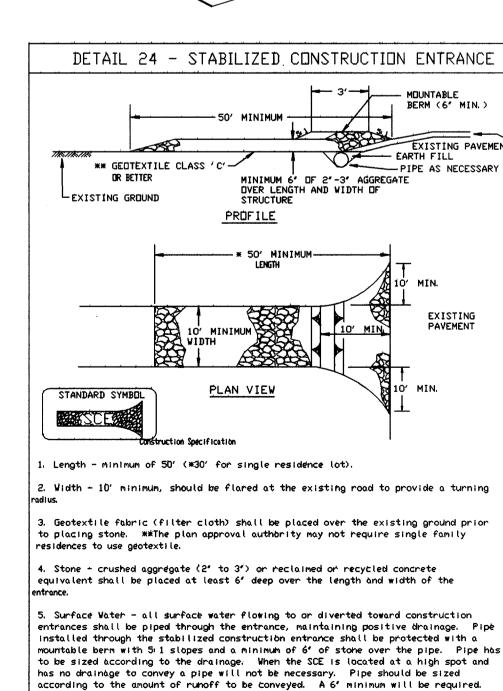


5. Location - A stabilized cohstruction entrance shall be located at every point

where construction traffic enters or leaves a construction site. Vehicles leaving

the site must travel over the entire length of the stabilized construction entrance

SOIL CONSERVATION SERVICE


MARYLAND DEPARTMENT OF ENVIRONMENT WATER MANAGEMENT ADMINISTRATION

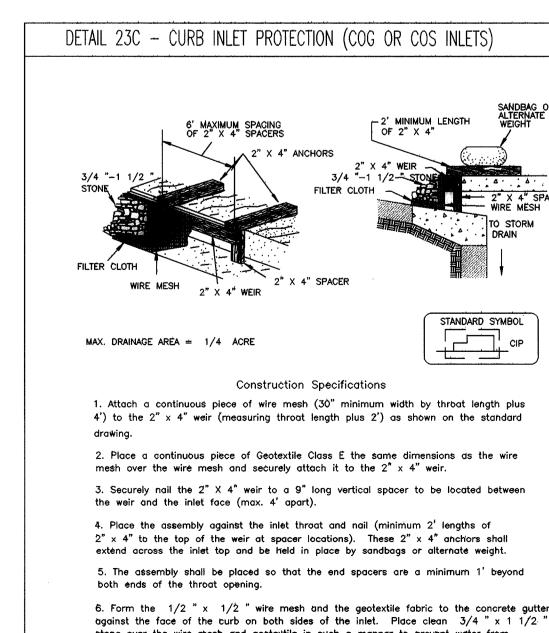


E - 16 - 50

WATER MANAGEMENT ADMINISTRATION

SOIL CONSERVATION SERVICE

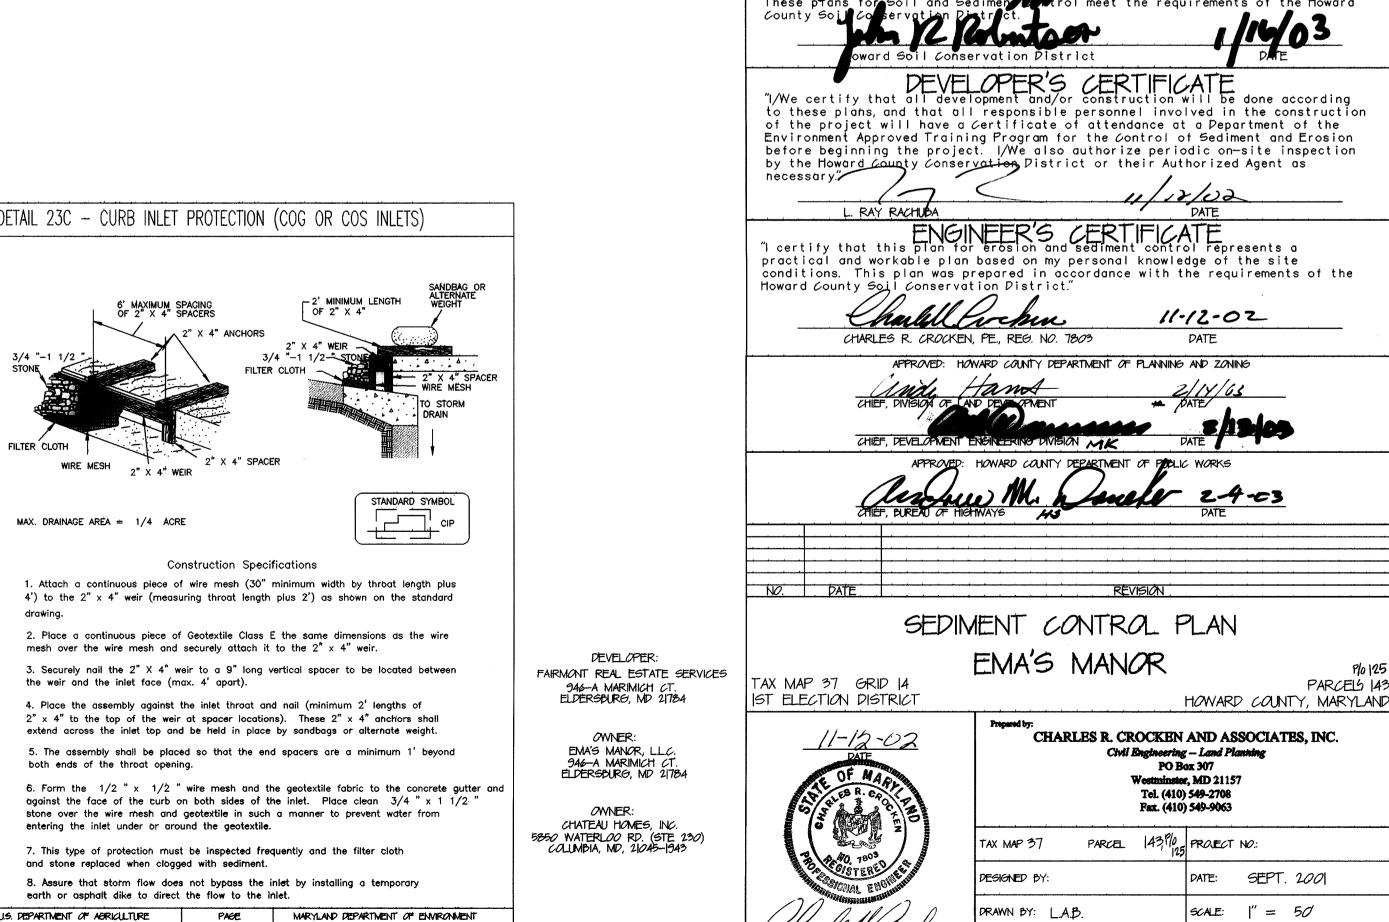

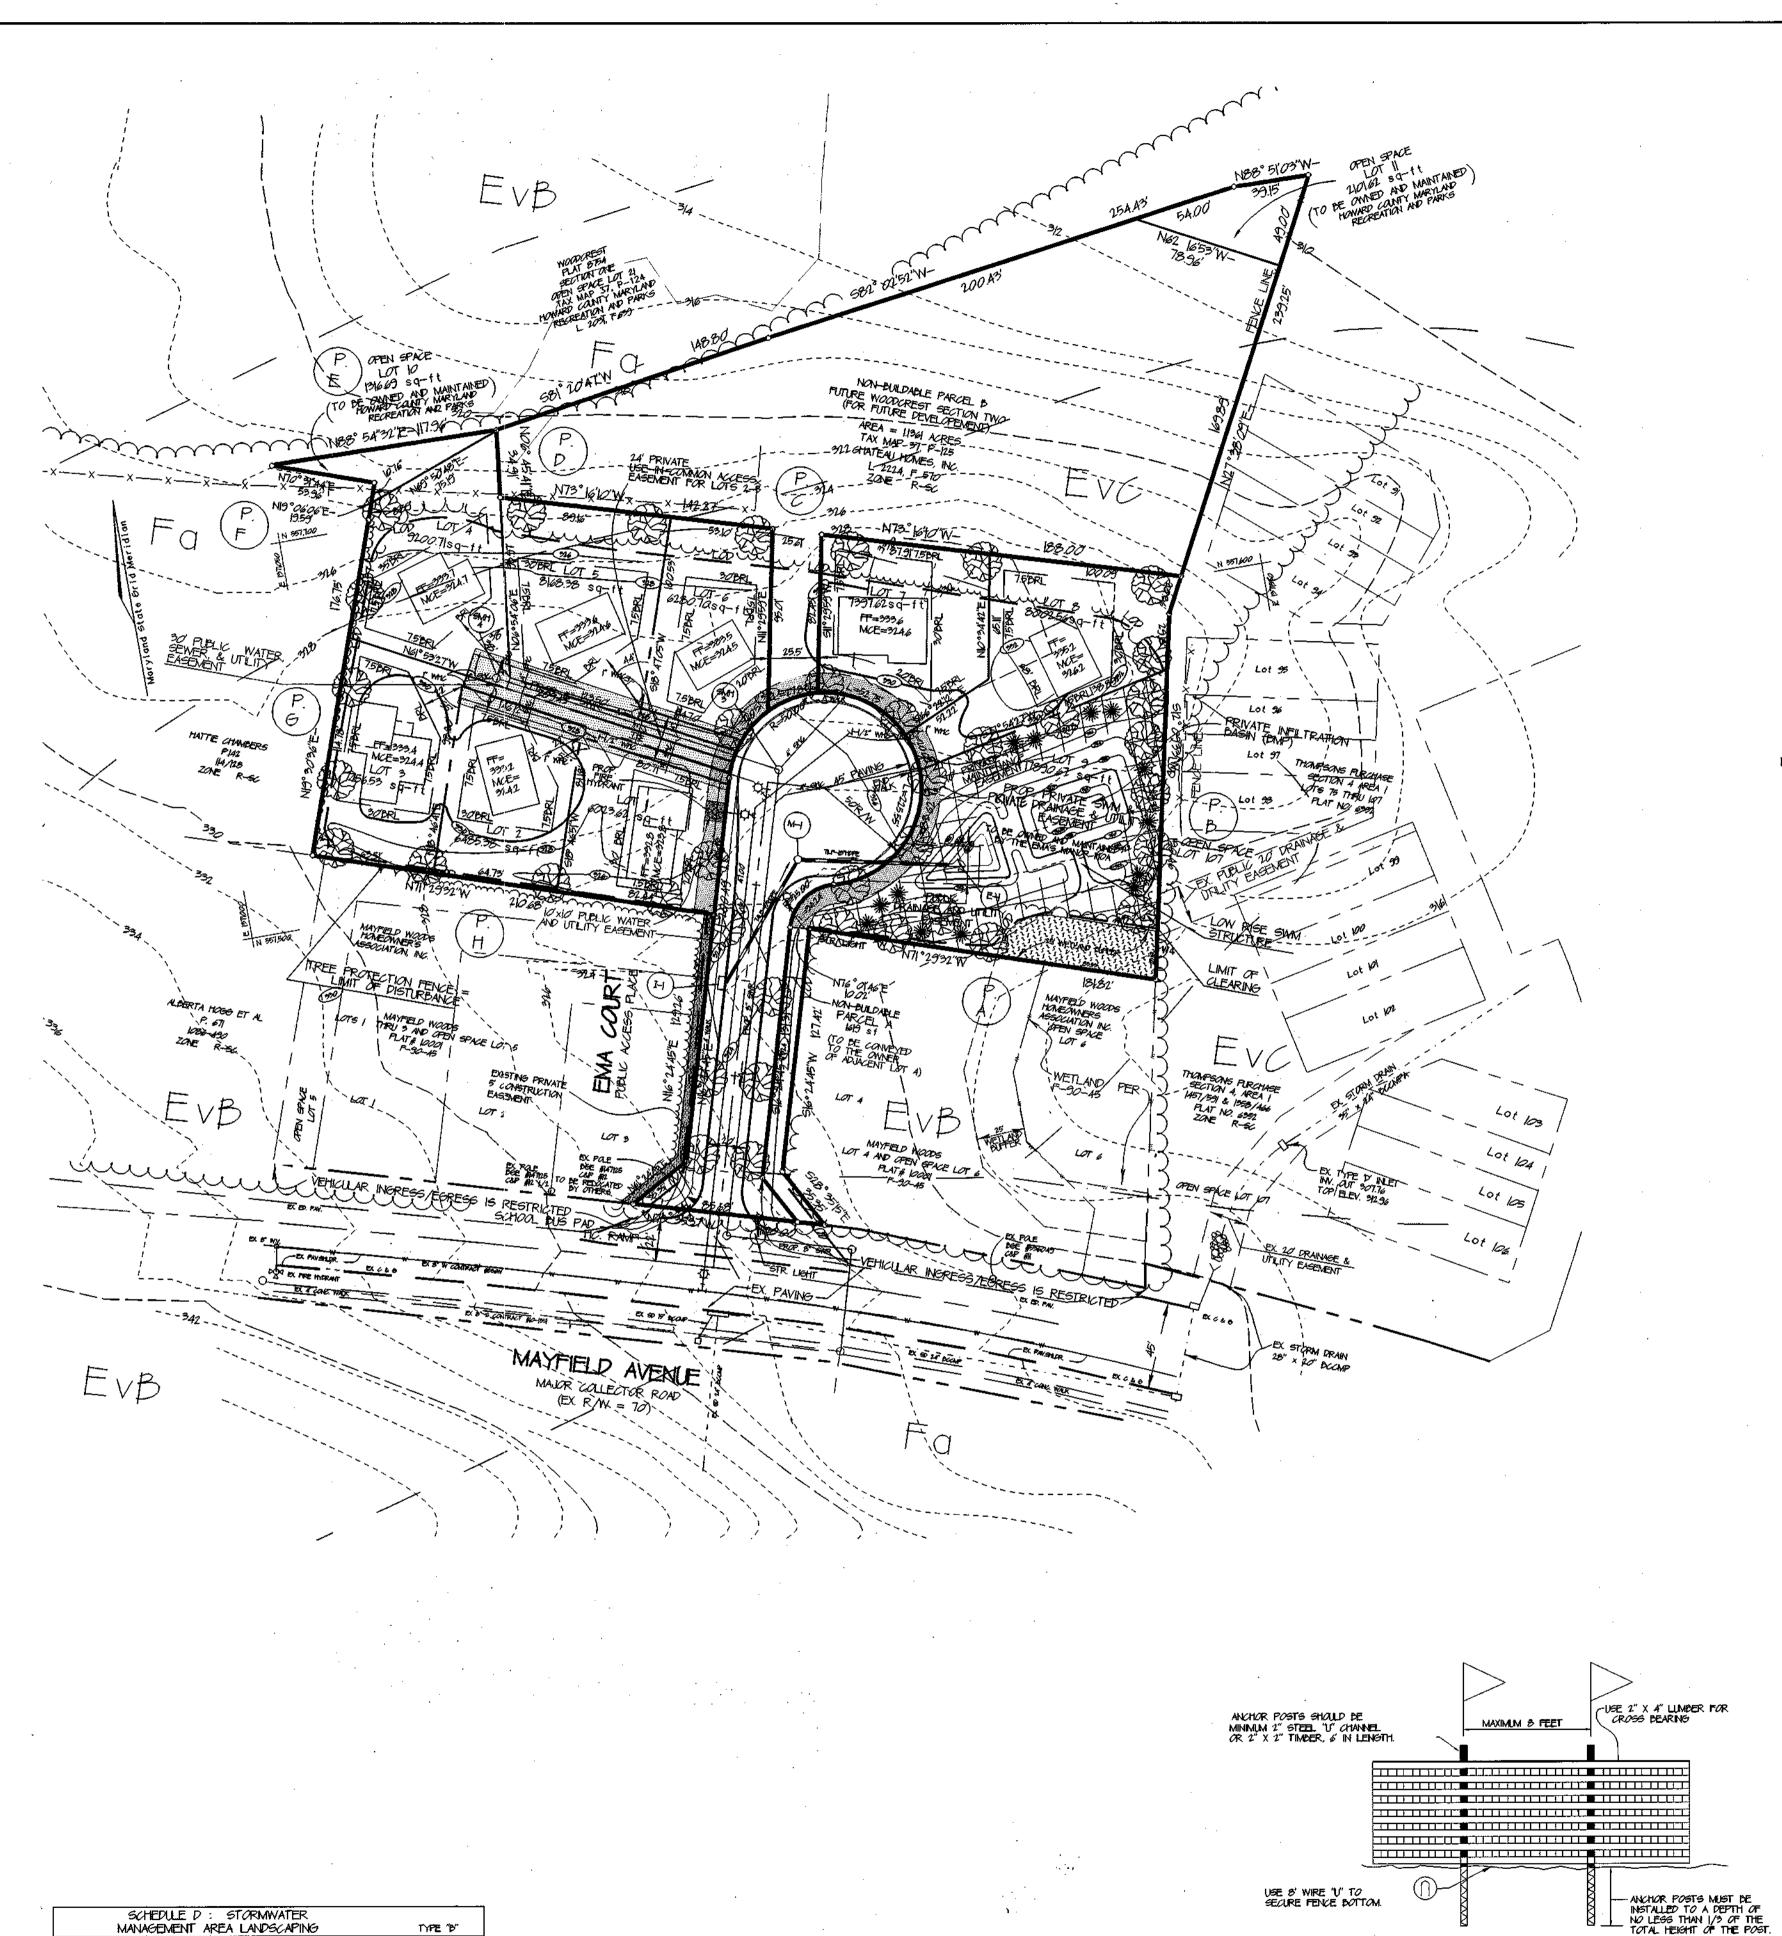

SOILS LEGEND

EVC EVESDORD LOAMY SAND, 5% TO 15% SLOPES A

NAME/DESCRIPTION

EVB EVESBORD LOAMY SAND, 1% TO 5% SLOPES

FALLINGSTON LOAM

SYMBOL

LINEAR FEET OF PERIMETER

(NO, YES AND LINEAR FEET)

(NO, YES AND %)

NUMBER OF TREES PROVIDED
SHAPE TREES
EVERGREEN TREES
OTHER TREES (2) SUBSTITUTION)

Number of Trees required Shade Trees Evergreen Trees 600.∏ LF

YES, 80 LF

10 SHADE TREES 19 EVERGREEN TREES

7 SHADE TREES

YES, 3 PERMETER TREES

o trees (o substitution trees)

# FOREST CONSERVATION WORKSHEET NET TRACT AREA: A TOTAL TRACT AREA 223 AC

A. TOTAL TRACT AREA

B. AREA WITHIN 100 YEAR FLOODPLAIN/WETLAND &STREAM BUFFERS

C. AREA TO REMAIN IN AGRICULTURAL PRODUCTION

D. NET TRACT AREA

223 AC

LAND USE CATEGORY (FROM TABLE 3.2.1, PAGE 40, MANUAL)

INPUT THE NUMBER "I" UNDER THE APPROPRIATE LAND USE ZONING, AND LIMIT TO ONLY ONE ENTRY.

A MDR IDA HDR MPD CIA

E. AFTOREST THRESHOLD F. CONSERVATION THRESHOLD 15% X D = 0.33 AC 20% X D = 0.44 AC

EXISTING FOREST COVER:

G. EXISTING FOREST COVER (EXCLUDING FLOODPLAIN) = 2.23 AC H. AREA OF FOREST ABOVE AFFORESTATION THRESHOLD = 1.36 AC I. AREA OF FOREST ABOVE CONSERVATION THRESHOLD = 1.77 AC

BREAK EVEN POINT:

J. FOREST RETENTION ABOVE THRESHOLD WITH NO MITIGATION = 080
K. CLEARING PERMITTED WITHOUT MITIGATION = 141

PROPOSED FOREST CLEARING:

L. TOTAL AREA OF FOREST TO BE CLEARED = 2.23 AC CANNOT EXCEED EXIST.

M. TOTAL AREA OF FOREST TO BE RETAINED = 0.00 AC

DI ANITING DECINDENENTS

PLANTING REQUIREMENTS:

N. REFORESTATION FOR CLEARING ABOVE CONSERVATION THRESHOLD = 0.44 AC
P. REFORESTATION FOR CLEARING BELOW CONSERVATION THRESHOLD = 0.88 AC
Q. CREDIT FOR RETENTION ABOVE CONSERVATION THRESHOLD = 0.00 AC
R. TOTAL REFORESTATION REQUIRED = 1.33 AC
T. TOTAL REFORESTATION AND AFFORESTATION REQUIRED = 1.33 AC
OFFSITE REFORESTATION (FOREST BANK) = 1.20 AC
DALANCE REQD (EQUIV. AREA FEE) = 0.13 AC

NOTE: THE ACREAGE OF NON-BUILDABLE PARCEL B IS NOT INCLUDED IN THIS WORKSHEET.

## PRE-CONSTRUCTION ACTIVITIES

- Install blaze orange fence and retention signs before construction begins.
- Root Prune adjacent to Blaze Orange Fence as per detail this sheet.
- Fencing shall be maintained in good condition and promptly repaired or restored as the situation warrants.
   CONSTRUCTION PHASE
- No disturbance or dumping is allowed inside the tree retention area.
- 2. No equipment shall be operated inside the tree retention area including tree canopies.
- 3. In the event of drought, the protected trees shall be monitored for signs of stress and watered as needed.

#### POST-CONSTRUCTION ACTIVITIES

- ). At the direction of a qualified tree care expert, damages to retained trees shall be repaired by the contractor.
- 2. Fence removal and stabilization shall be as per the sediment and erosion control plan.
- Signs are to remain for a period of two years after recording the final plat.


#### GENERAL NOTES


- Wetland buffers are to be retained.
   There are no endangered species on this site.
- There are no specimen trees 30" in diameter or larger on this site.
   There are no historic structures on this site.
   Offsite reforestation is proposed via the purchase of |20 acres of reforestation credit from the Howard County approved Winkler Forest Conservation Pank.

#### FOREST CONSERVATION NOTE:

1. Forest protection device only.
2. Retention area will be set as part of the review process.
3. Doundaries of retention area should be staked and flagged prior to installing device.
4. Root damage should be avoided.
5. Protection signage should be used.
6. Device should be maintained throughout construction.

PLAZE ORANGE PLASTIC MESH TYPICAL TREE PROTECTION FENCE DETAIL THE FOREST CONSERVATION OBLIGATION FOR REFORESTATION AND AFFORESTATION, INCURRED BY THE SUBDIVISION SHOWN HEREON, 1,33 ACRES HAS BEEN SATISFIED BY THE AQUISITION OF 1,20 ACRES OF FOREST MITIGATION CREDITS FROM ENVIRONMENTAL BANC & EXCHANGE L.L.C. (EXB) BY EMA'S MANOR L.L.C. (EXB) SHALL DELIVER TO HOWARD COUNTY ANY AND ALL DOCUMENTS RELATING TO THE FOREST MITIGATION. AND THAT THE OUTSTANDING REFORESTATION OBLIGATION OF 0,13 ACRES HAS BEEN MET BY A FEE-IN-LIEU PAYMENT OF \$1,831,40 TO THE HOWARD CO. FOREST CONSERVATION FUND.

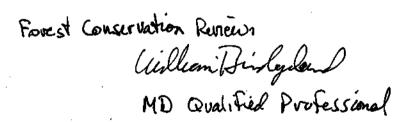

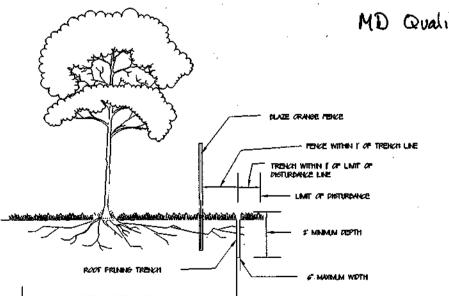

NOTES:
1. Retention Areas to be established as part of the forest conservation plan review process.
2. Poundaries of Retention Areas to be staked, flagged and/or fenced prior trenching.
3. Exact location of trench should be identified.
4. Trench should be immediately backfilled with soil removed or organic soil.
5. Roots should be cleanly cut using vibratory knife or other acceptable equipment.

ROOT PRUNING

DEVELOPER: FAIRMONT REAL ESTATE SERVICES 946-A MARIMICH CT. ELDERSBURG, MD 21784

OWNER:

EMAR'S MANOR, LLC.

946-A MARIMICH CT.

5850 WATERLOO RD. (STE 230)

ELDERSBURG, MD 21784

COLLMBIA, MD, 21045-1943

LEGEND			
Existing Contou	ır		382
Proposed Conto	ir	— <b>3</b> D-,—	<u>.                                    </u>
Spot Elevation		+81 <sup>53</sup>	
Direction of Fl	<b>⇔w</b>	<del>-=</del>	*
	€	my.	$\sim\sim$
Existing Trees	to Remain G	wky	ببير
Light Poles	Post Top	} Øverhead	<b>≭</b> ⊅ollardi
<del></del>		MA	

Shade Trees

Perimeter Landscape Edge

Evergreen Trees

(P. B)

	PERIME	SCHEDULE FER LANDSC		E.					
CATEGORY ADJACENT TO ADJACENT TO ROADWAYS PERIMETER PROPERTIES									
Perimeter/Frontage Designation Landscape Type		A	D A	· A	D A	E A	F	6 A	H
Linear Feet of Roadway Frontage/Perimeter		182	2	356	35	118	54	2 4	2
Credit for Existing Vegetation (Yes, No, Linear Feet Pescribe below if needed)		Yes* 84	Yes* 25	No	Yes* 35	Yes∗ ∥8′	Yes* 54	No	No
Credit for Wall, Fence or Berm (Yes, No, Linear Feet Describe below if needed)		No	No	No	No	No	No	No	No
Number of Plants Required Shade Trees Evergreen Trees Shrubs		(102°) 1:60 2 -	(186) 1:60 3 - -	1:60 6	1:60 0	1:60 0	1:60 0	1:60 4	1:60 4
Number of Plants Provided Shade Trees Evergreen Trees Other Trees (2:1 Substitution) Shrubs ( O:1 Substitution)		2 -	3 - -	6 -	0 -	0 -	0 1,1 1	4  -	4
Describe Plant Substitution Credits Below if needed)				:					

\* Existing Woods to Remain

STREET TREE CHART							
SYMBOL	QUANTITY	BOTANICAL/COMMON NAME	SIZE				
	13	FRAXINUS P. "PATMORE"/PATMORE GREEN ASH	2.5-3" CAL., 1881				

#### THIS LIST INCLUDES LANDSCAPE MATERIAL FOR PERIMETER LANDSCAPE EDGE AND STREET TREES.


		PLANT LIST		
SYMBOL	QUANTITY	BOTANICAL/COMMON NAME	SIZE	REMARKS
	3 <del>9</del>	FRAXINUS P. "PATMORE" /PATMORE GREEN ASH	2.5-3" CAL., D&D	12'-14' HT.
*	13	PINUS STOBUS / WHITE PINE	. 6-8' HT., B&D	10-15 OC

NOTE: PLANTS SHOULD BE LOCATED IN THE FIELD BY LANDSCAPE ARCHITECT OR OWNER'S REPRESENTATIVE PRIOR TO PLANTING

### GENERAL NOTES

| FINANCIAL SURETY FOR THE REQUIRED LANDSCAPING MUST BE
POSTED AS PART OF THE DPW DEVELOPERS AGREEMENT IN THE AMOUNT
OF \$9,750.00 FOR 26 SHADE TREES AND IS EVERGREEN TREES.

2. THIS PLAN HAS BEEN PREPARED IN ACCORDANCE WITH THE PROVISIONS SECTION 16.124 OF THE HOWARD CO. CODE AND THE HOWARD CO. LANDSCAPE MANUAL

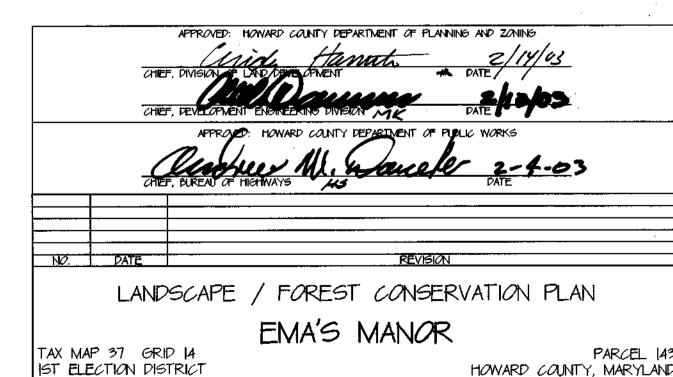

Prepared by:

CHARLES R. CROCKEN AND ASSOCIATES, INC.

Civil Engineering — Land Planning

PO Pox 301

Westminster, MD 2||57



11-12-02

F-02-54