
GENERAL NOTES 1. Subject property Zoned "R-12" per 02/02/04 Comprehensive Zoning Plan and per the "Comp. Lite" Zoning Regulation Amendments effective 7/28/06. 2. Public water and sewer are to be utilized. Sewer and Water Contract R-3629. 3. Sketch plan, S-06-014, approved on June 15, 2007. 4. This site is located within the metropolitan district. 5. Soils map no. 29. 6. Gross area of site: 2.510 ac.± 7. Number of proposed buildable lots: 7 Area of proposed buildable lots: 1.636 ac.± 8. Number of proposed open space lots: 2 Area of proposed open space lot: 0.867 ac.± 9. Open space requirements: a.) Open space required (30% gross area of site- minimum lot size 8,400sf.): $2.510 \text{ ac.} \pm \times 0.30 = 0.753 \text{ ac.} \pm$ b.) Open space provided: 0.867 act (Credited) 0.000 act (Not Credited) 10. Area of right of way to be dedicated to Howard County Maryland: 0.007 Ac. 1. The on site existing topography was Field Run by FSH Associates on September 2007. Off Site Topography is based on aerial survey with two foot contour intervals prepared by Howard County dated 2004. 2. Boundary shown is based on Field Run Boundary Survey by FSH Associates on September 2007. 13. A.P.F.O. Traffic Study prepared by Street Traffic Studies Ltd. approved on June 15, 2007. 14. The wetlands delineation study for this project was prepared by Exploration Research Inc., and approved on June 15, 2007. 15. The Forest Stand Delineation and report for this project was prepared by Exploration Research Inc., and approved on June 15, 2007. approved on June 15, 2007. b. There are no floodplains, steep slopes, streams, historic structures or cemeteries on-site. 7. Forest Conservation Obligations will be met partly on-site and partly by fee-in-lieu payment. 8. Perimeter Landscape Obligations in accordance with Section 16.124 of the Landscape Manual shall be shown under . Topography along lines of sight was field run by FSH Associates on or about January 2006. 20. Stormwater management quantity \$ quality is provided as necessary in accordance with the 2000 Stormwater Management Manual. A pocket sand filter facility will be used to treat Cpv and Way. The recharge volume to be treated through the grass channel credit. The stormwater management facility shall be H.O.A owned and 21. The project is in conformance with the latest Howard County Standards unless waivers have been approved. 22. The coordinates shown hereon are based upon the Howard County Geodetic Control which is based on the Maryland State Plane Coordinate System. Howard County Monumant Nos. 42R1 and 42R2 were used for this 23. Existing utilities along Guilford Road are based on field run survey by FSH Associates on or about January, 2006. 24. The geotechnical report for this project was prepared by Herbst/ Benson \$ Associates, dated October 11, 2007. 25. This plan is subject to a design manual waiver from section 2.5.2.H and Figure 2.17 of Design Manual Volume III to allow the use of stopping sight distance on a Major Collector and higher classification roadway. Waiver was approved on 8/22/06. 26. A waiver from section 5.4.B.6 of Howard County Design Manual, Volume II, Water and Sewer, to allow the sewer line to be closer than 25 feet but no closer than 15 feet was approved on May 28, 2008. 27. A waiver from Section 2.6.A of Howard County Design Manual, Volume III, Roads and Bridges, to allow a Use-In-Common driveway to serve more than six (6) dwelling units (7 dwelling units approved), was approved 28. Note - Development Engineering Division has agreed to allow water quality(WQV) and channel protection(CPV) to be treated jointly within the proposed pocket sand filter. -Use-In Common Access Easement >


FRONT FOOT DIMENSION ENLARGEMENT DETAIL

SCALE: 1"=101

PRELIMINARY PLAN KINGS COVE

A RESUBDIVISION OF LOTS 4 AND PLAT NUMBERS PB 7/F 71 AND PB 026/F 039 HOWARD COUNTY, MARYLAND

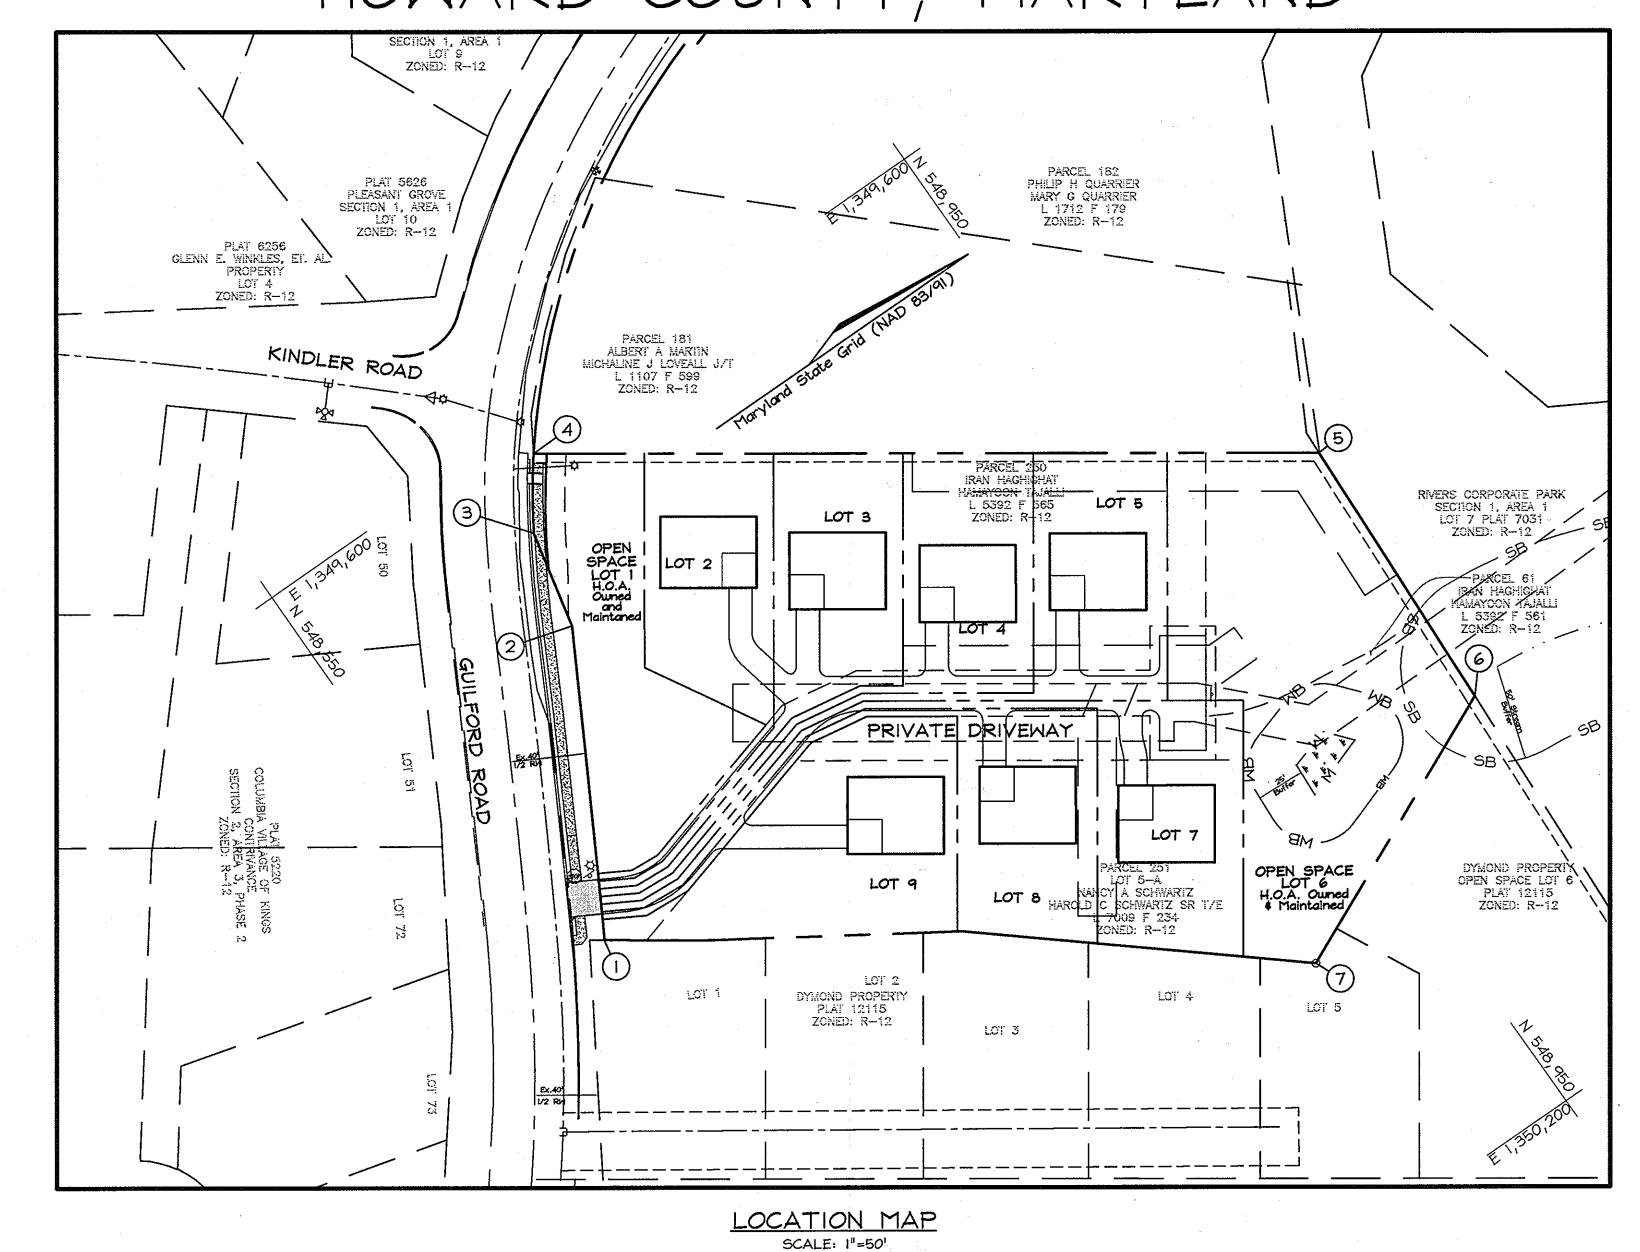

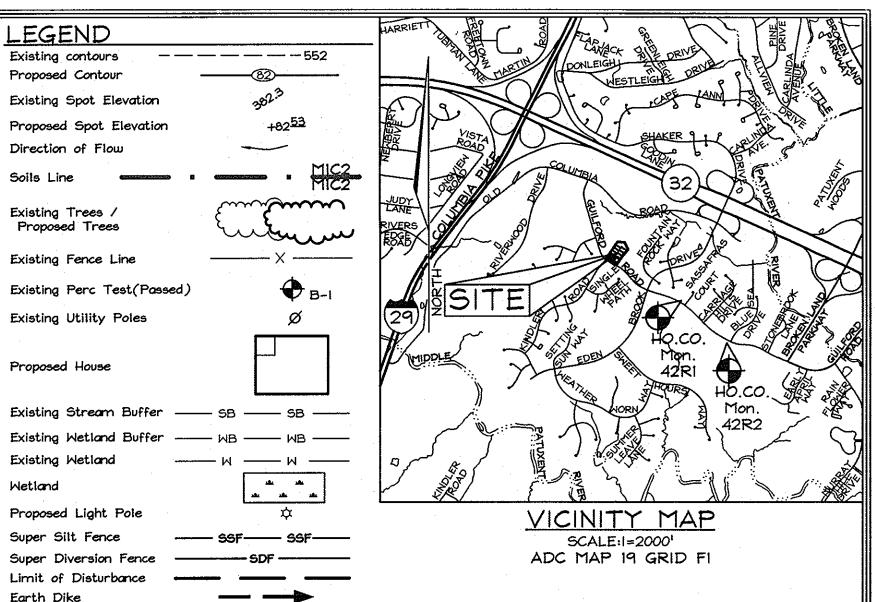

BENCHMARKS

approximate location (see vicinity map).

Sta. 42RI N 547,820.2380 E 1,351,171.5866 E1.: 375.871 Sta. 42R2 N 546,946.8001 E 1,352,118.5607 E1.: 331.525

MINIM	IUM LOT	SIZE C	HART
LOT NUMBER	GROSS AREA (SF)	PIPESTEM AREA (SF)	MINIMUM LOT SIZE (SF
2	9,035±	494±	8,541±
3	9,148±	510±	8,638±
4	9,286±	800±	8,486±
5	10,052±	1,069±	8,983±
7	11,046±	1,200±	9,846±
8	9,553 ±	907±	8,646±
9	13,147 ±	1,501±	11,646±

SHEET INDEX	
DESCRIPTION	SHEET No.
Cover Sheet	1 of 7
Preliminary Guilford Road Improvements	2 of 7
Preliminary Plan	3 of 7
Preliminary Grading Landscaping, Sediment \$ Erosion Control \$ Soils Plan	4 of 7
Preliminary Storm Drain Drainage Area Map	5 of 7
Preliminary Forest Conservation Plan	6 of 7
Preliminary Forest Conservation Notes and Details	7 of 7

CI	ENTER	INE	ROA	D CU	RVE D	ATA	
ROAD NAME	CURVE No.	RADIUS	LENGTH	DELTA	TANGENT	CHD BEAR	CHD LEN
Private Driveway	Cl	45.001	31.221	39°45'14"	16.271	N06*14'17"E	30.60'
11 Trace Di Iveway	C2	45.00	38.67	49*13'54"	20.62'	509°47'15"W	37.49'

CO	ORDINATE	TABLE
POINT	NORTHING	EASTING
1	548,589.1467	1,349,845.4863
2	548,669.3027	1,349,701.2651
3	548,680.4389	1,349,650.2668
4	548,704.2069	1,349,616.1611
5	549, <i>0</i> 38.5153	1,349,849.2022
6	549,032.0114	1,349,999.7327
7	548,884.8679	1,350,066.5653

	STR	REET L	IGHT TABLE
STREET NAME	LOCATION	OFFSET	FIXTURE TYPE
PRIVATE DRIVEWAY	€ Sta. 0+35.57	l6± Left	14' High Black Fiberglass pole, 100 watt HPS or 150 watt HPS, post top: Premier or Acron

*Note: 🌣 Denotes Street Light

OWNER/DEVELOPER

CMC Land, LLC 11710 Stonegate Lane Columbia, MD 21044 Attn: Ms. Cindy Delzoppo 443-250-6395


COVER SHEET

KINGS COVE (A RESUBDIVISION OF LOTS 4 AND 5-A, PLAT NUMBERS PB 7/F 71 AND PB 026/F 039)

ZONING R-12

TAX MAP 42 GRID 7 6TH ELECTION DISTRICT

PARCELS 61, 250 \$ 251 HOWARD COUNTY, MARYLAND

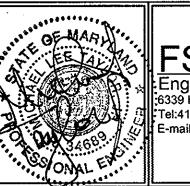

FSH Associates Engineers Planners Surveyors ;6339 Howard Lane, Elkridge, MD 21075 Tel:410-567-5200 Fax: 410-796-1562 E-mail: info@fsheri.com

DESIGN BY: MLT SCALE: As Shown DATE: Feb. 2, 2009 W.O. No.: <u>3394</u> SHEET No.: ___OF_

LOT SPACE PRIVATE DRIVEWAY LOT OPEN LOT SPACE

PARTIAL LOT PIPE STEM DETAIL

PROFESSIONAL CERTIFICATION hereby certify that these documents were prepared or approved by me, and that I am a duly licensed professional engineer under the laws of the State Maryland, License No. #34689, Expiration Date: 07/08/2009.


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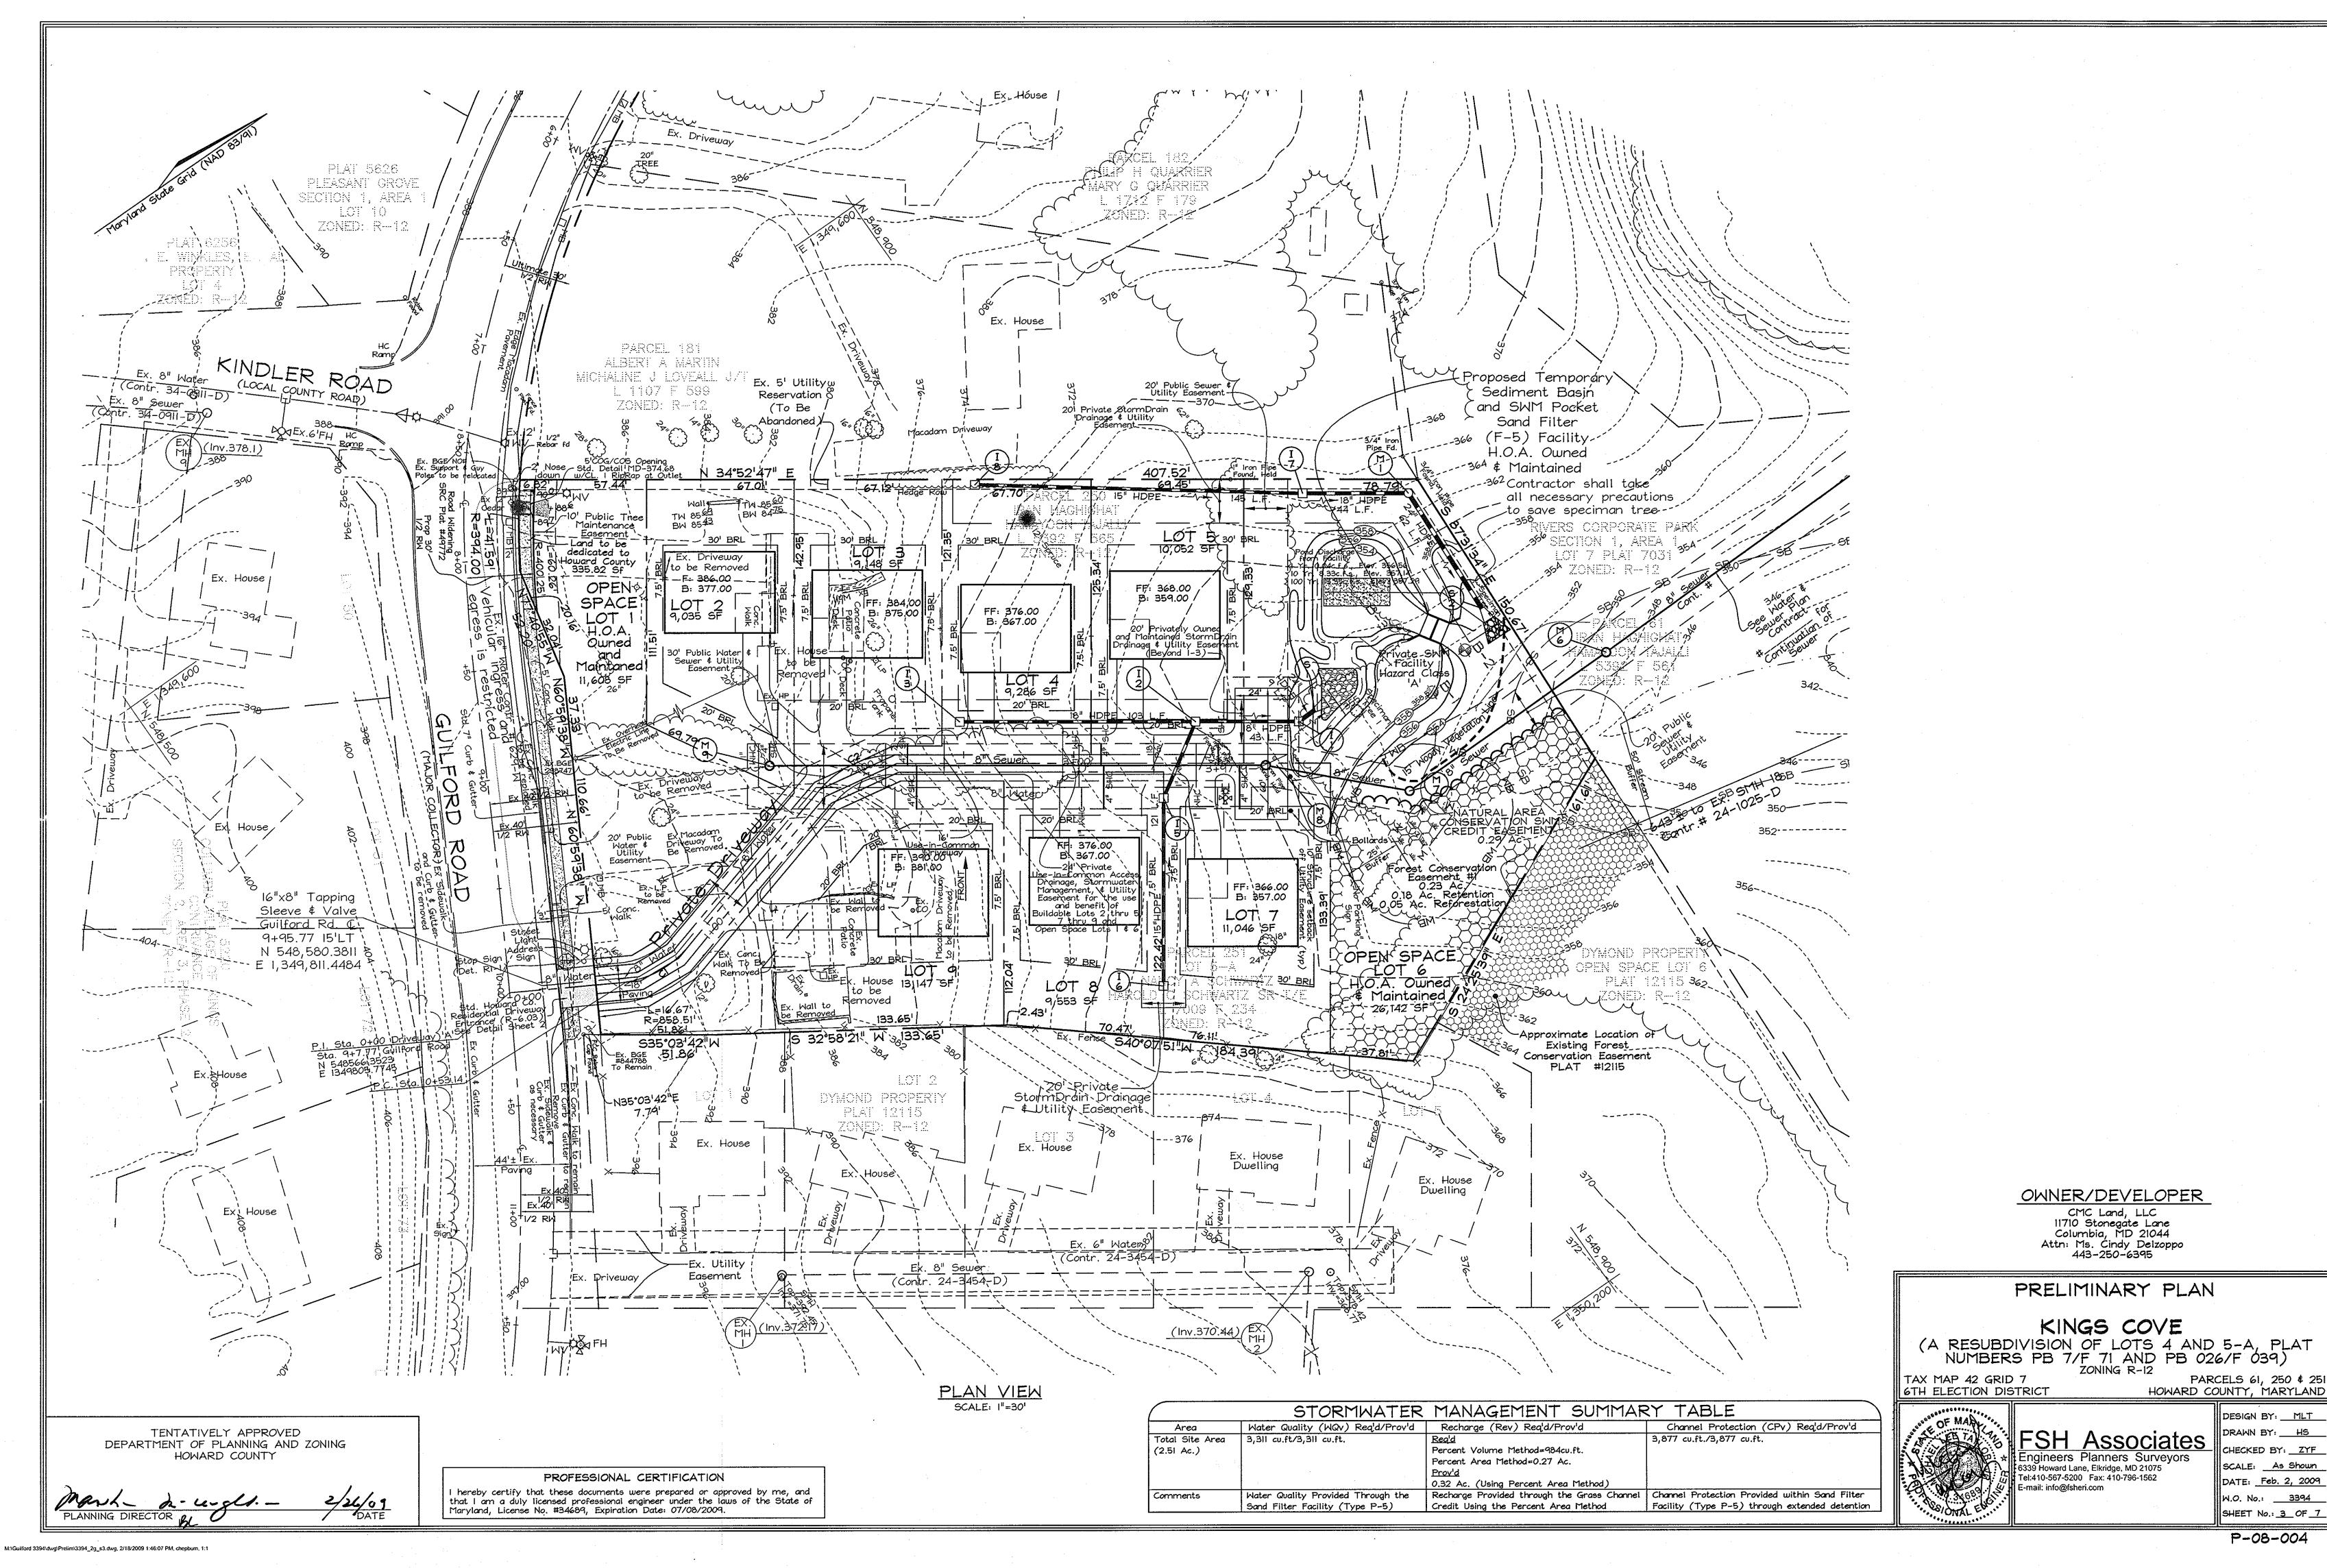
TENTATIVELY APPROVED

HOWARD COUNTY


DEPARTMENT OF PLANNING AND ZONING


P-08-004




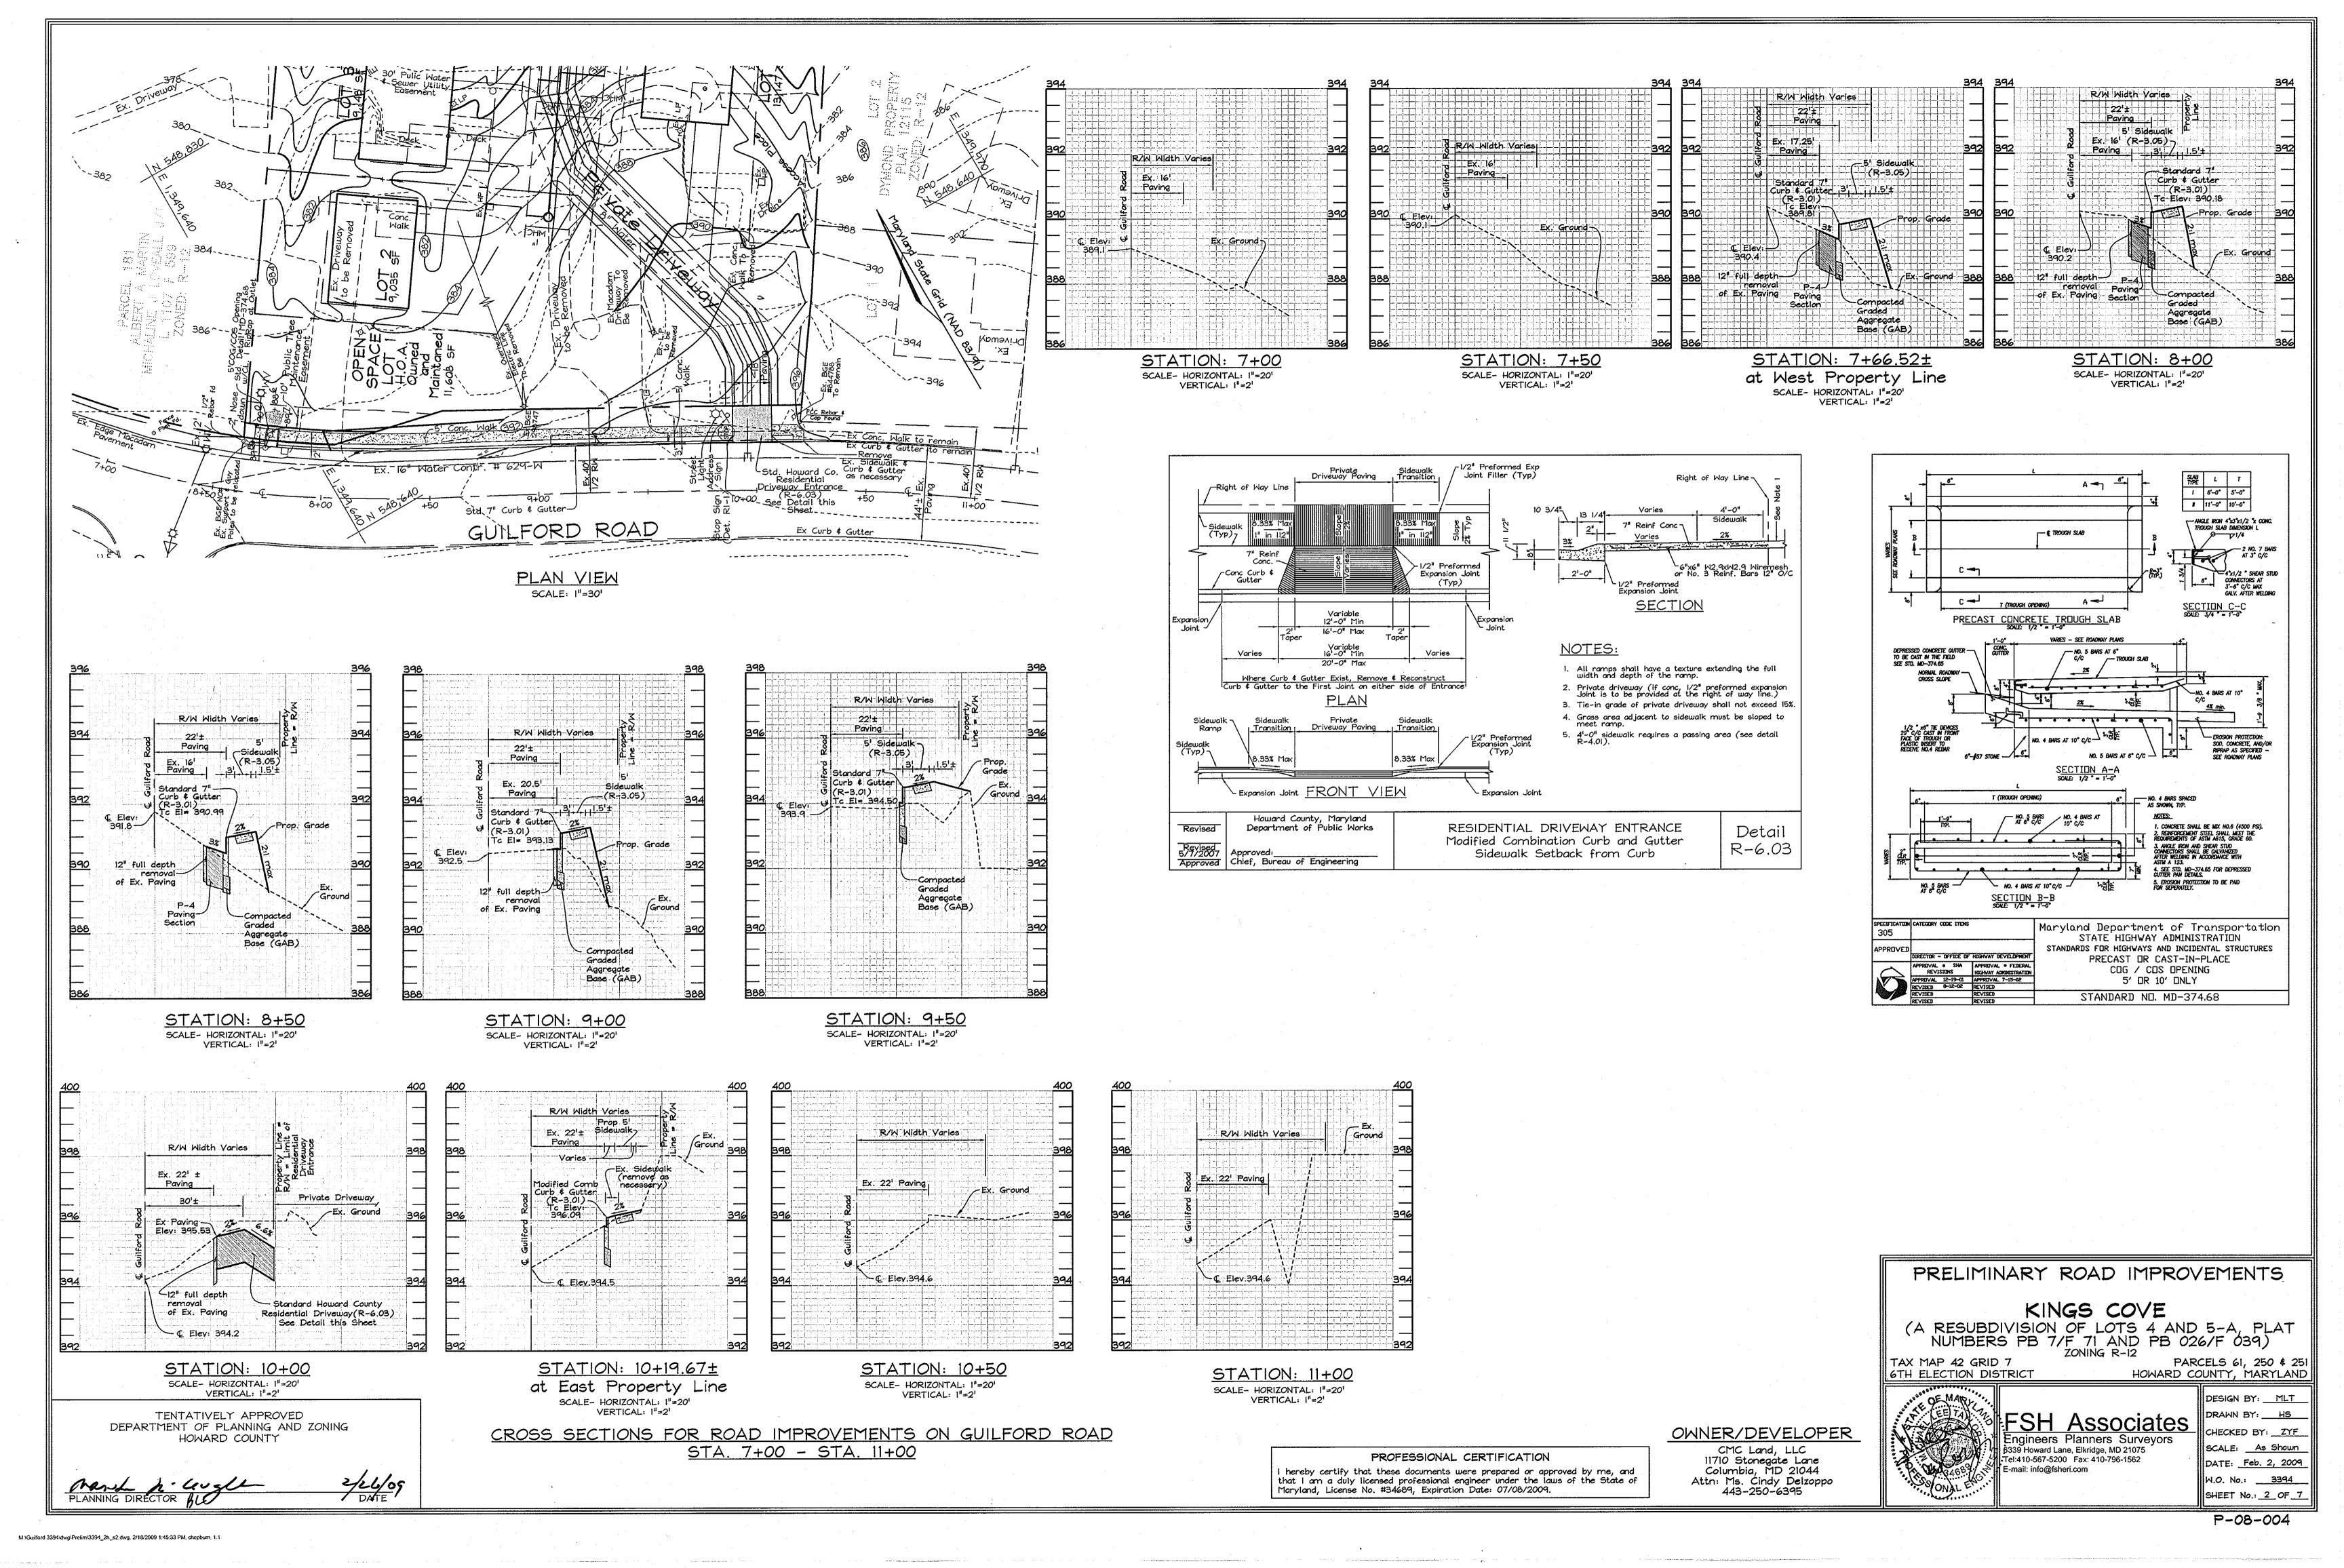

P-08-004

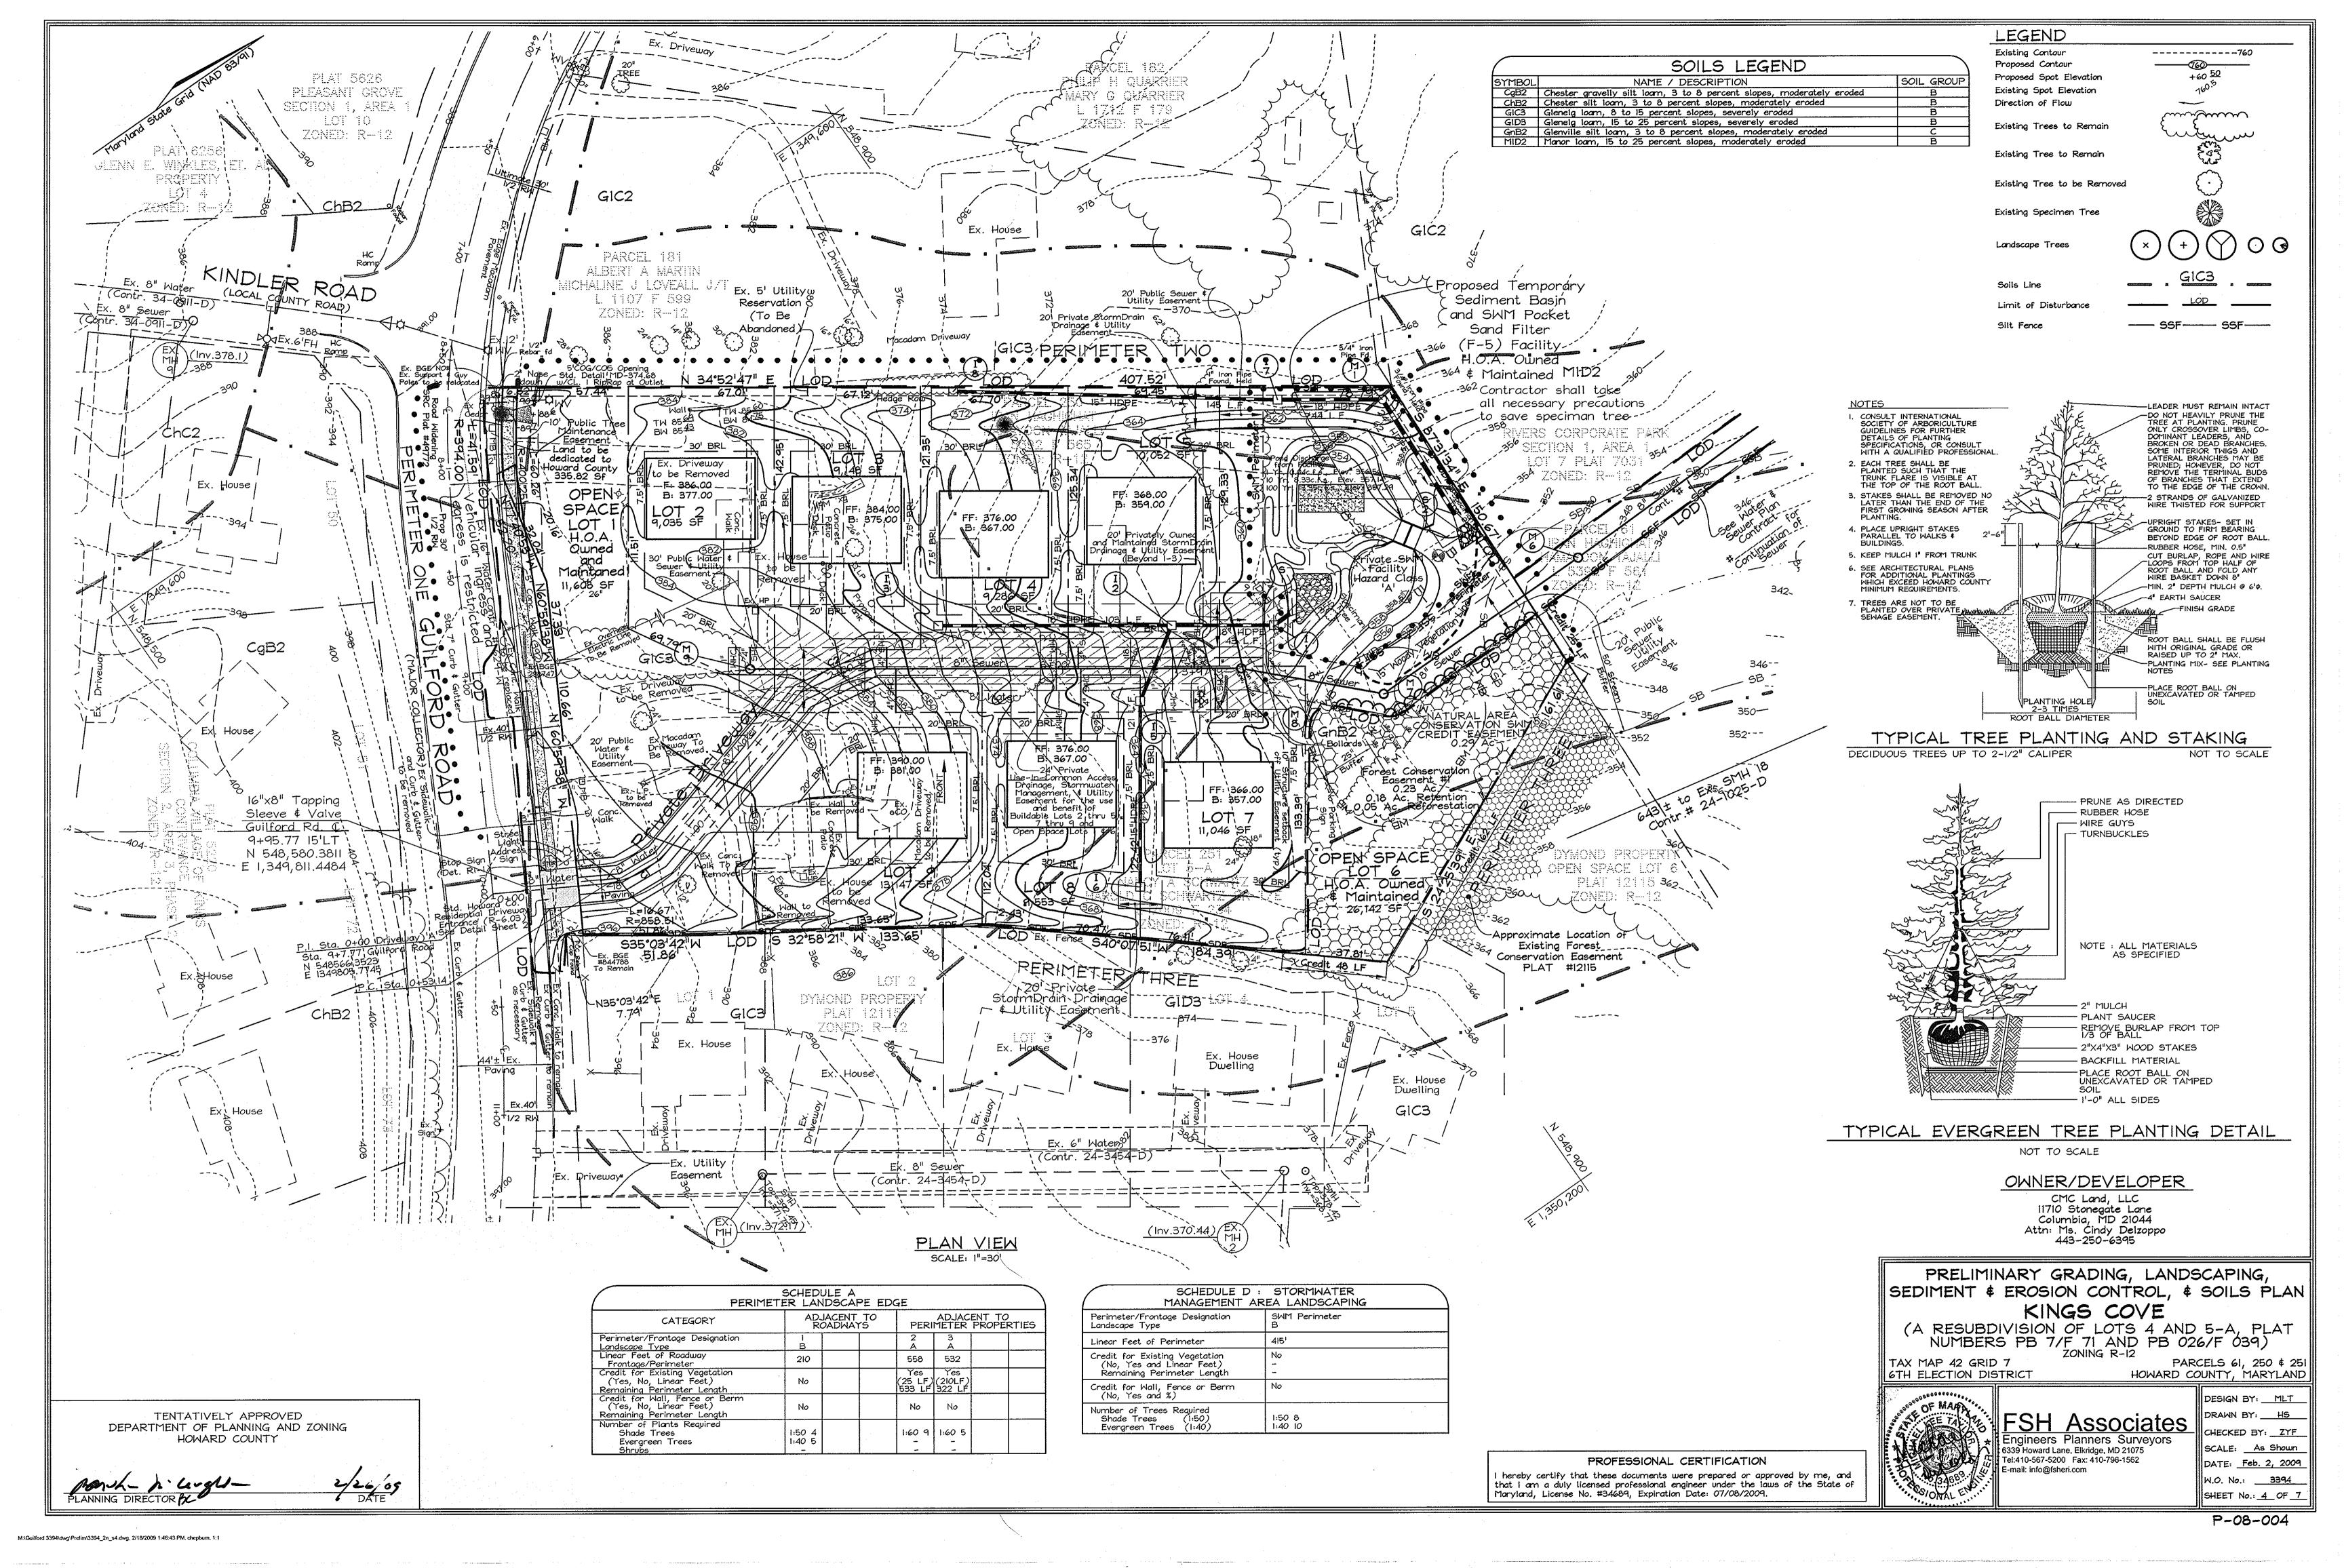

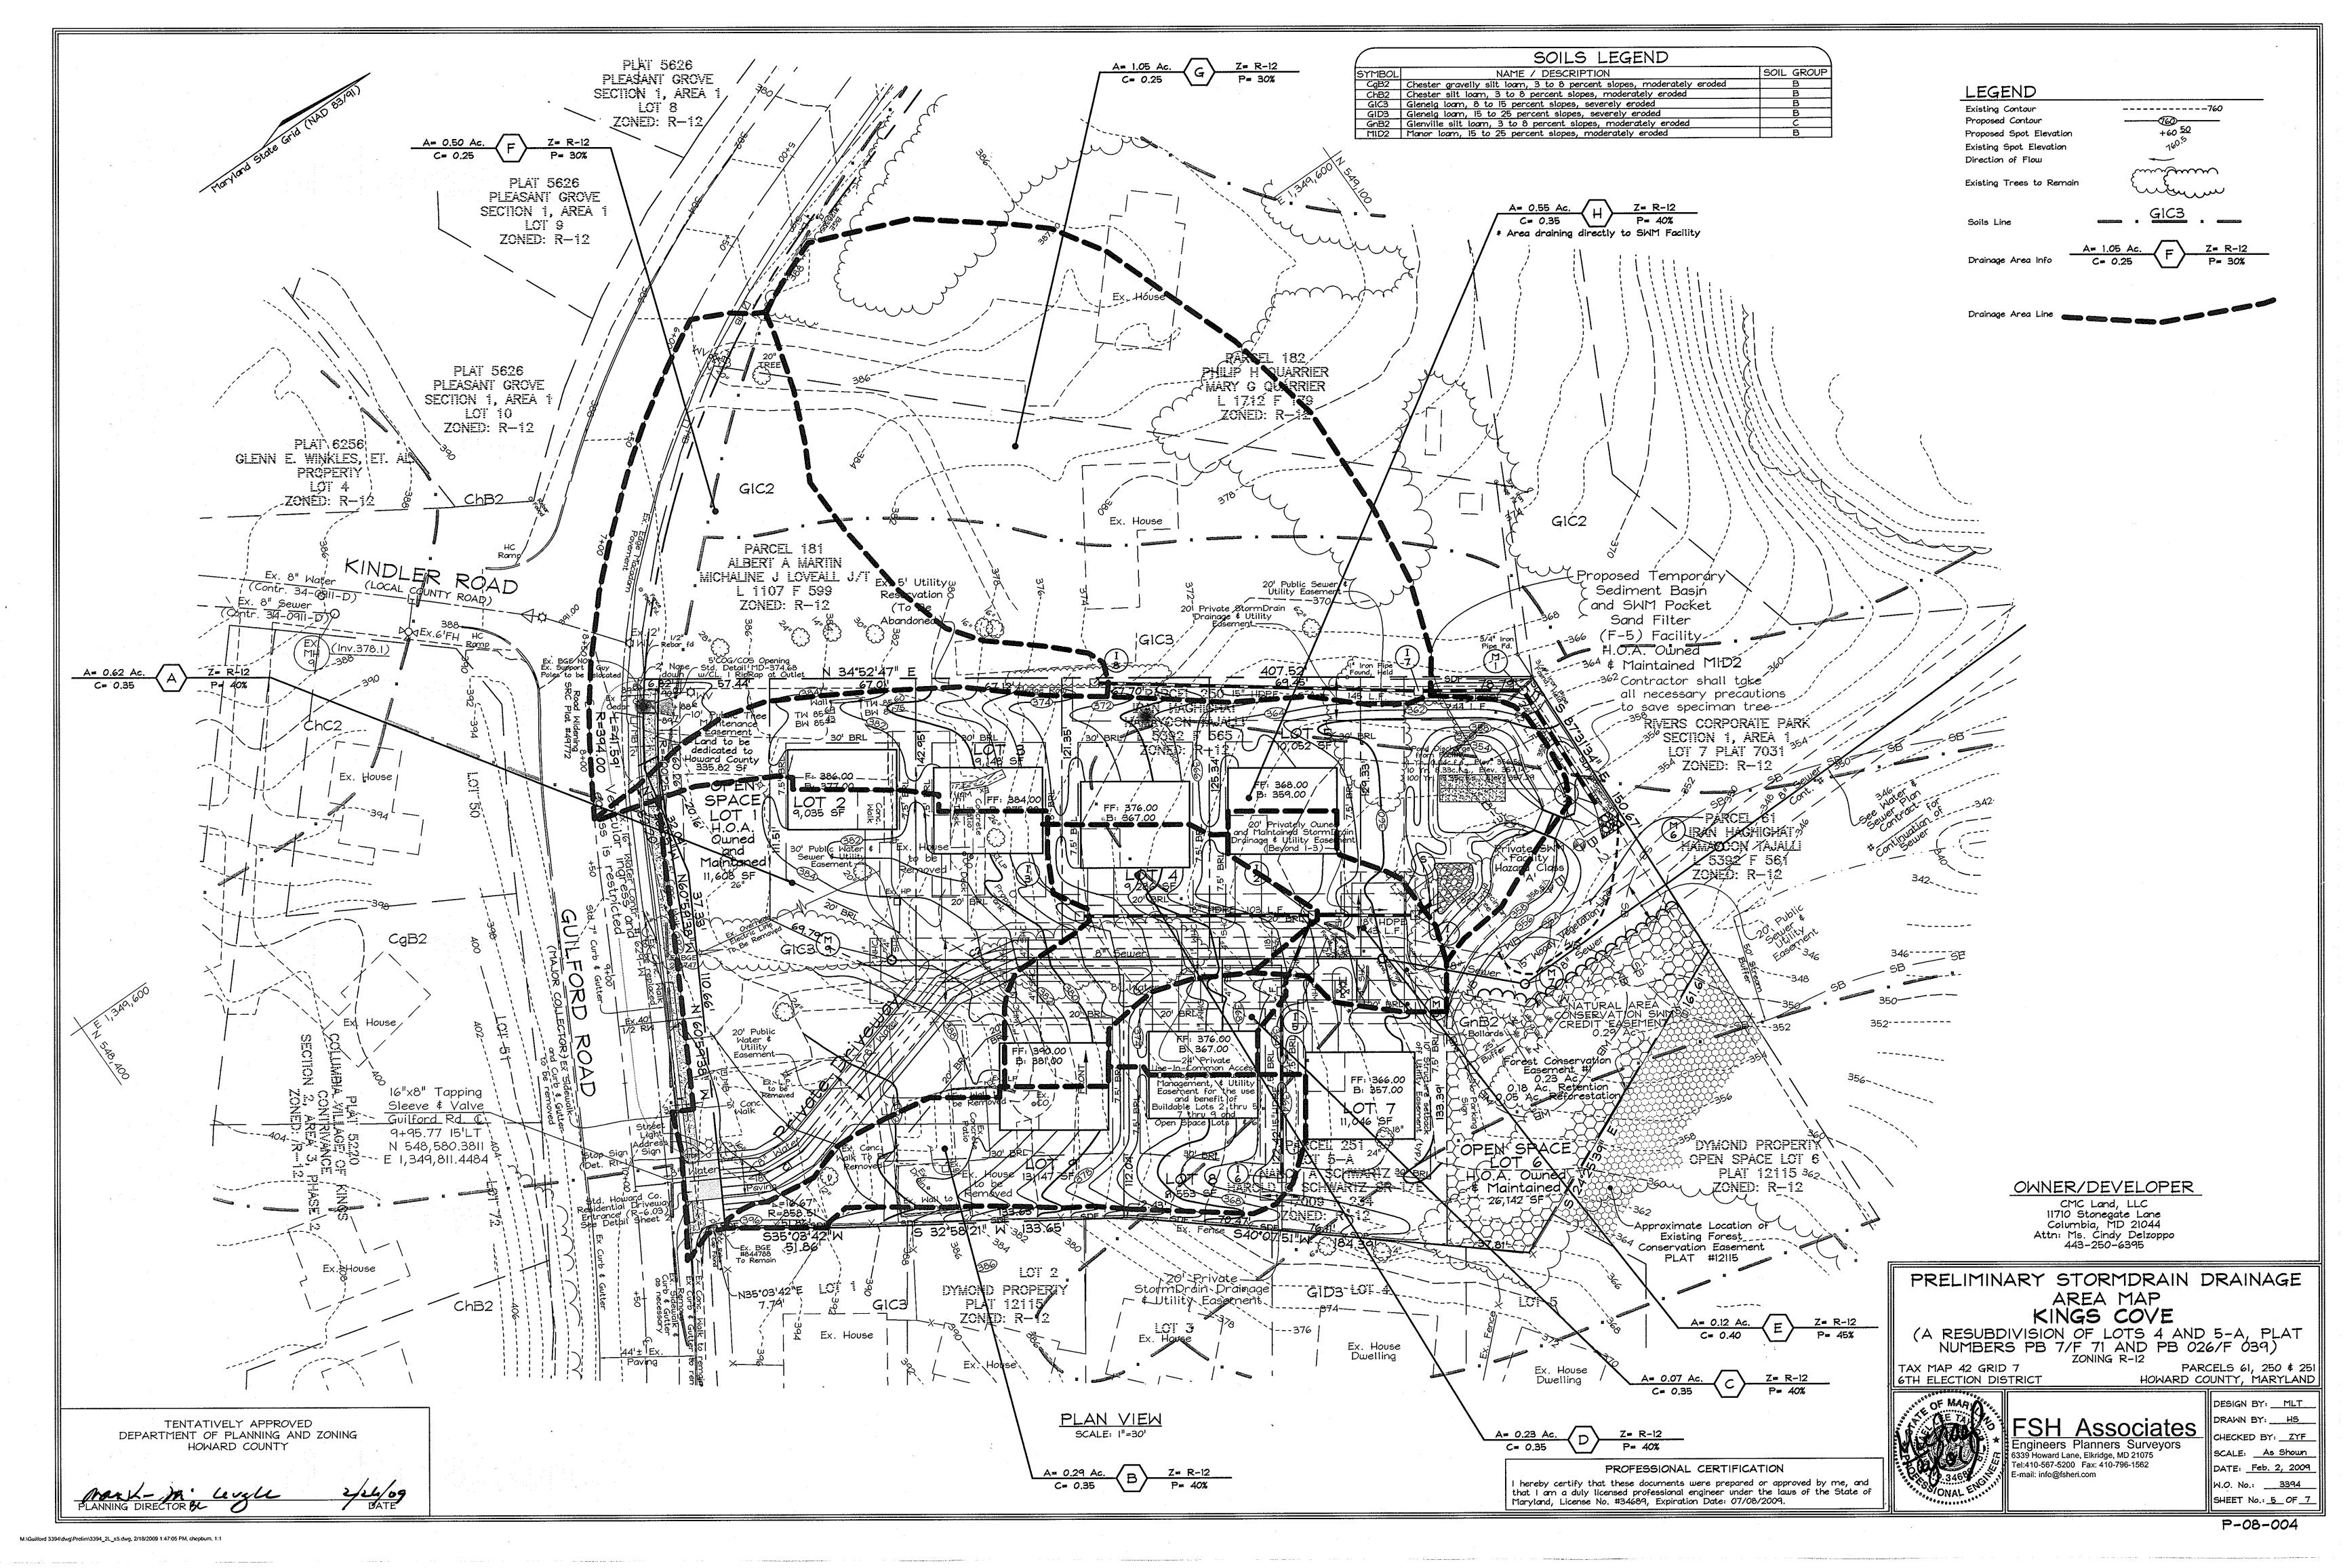

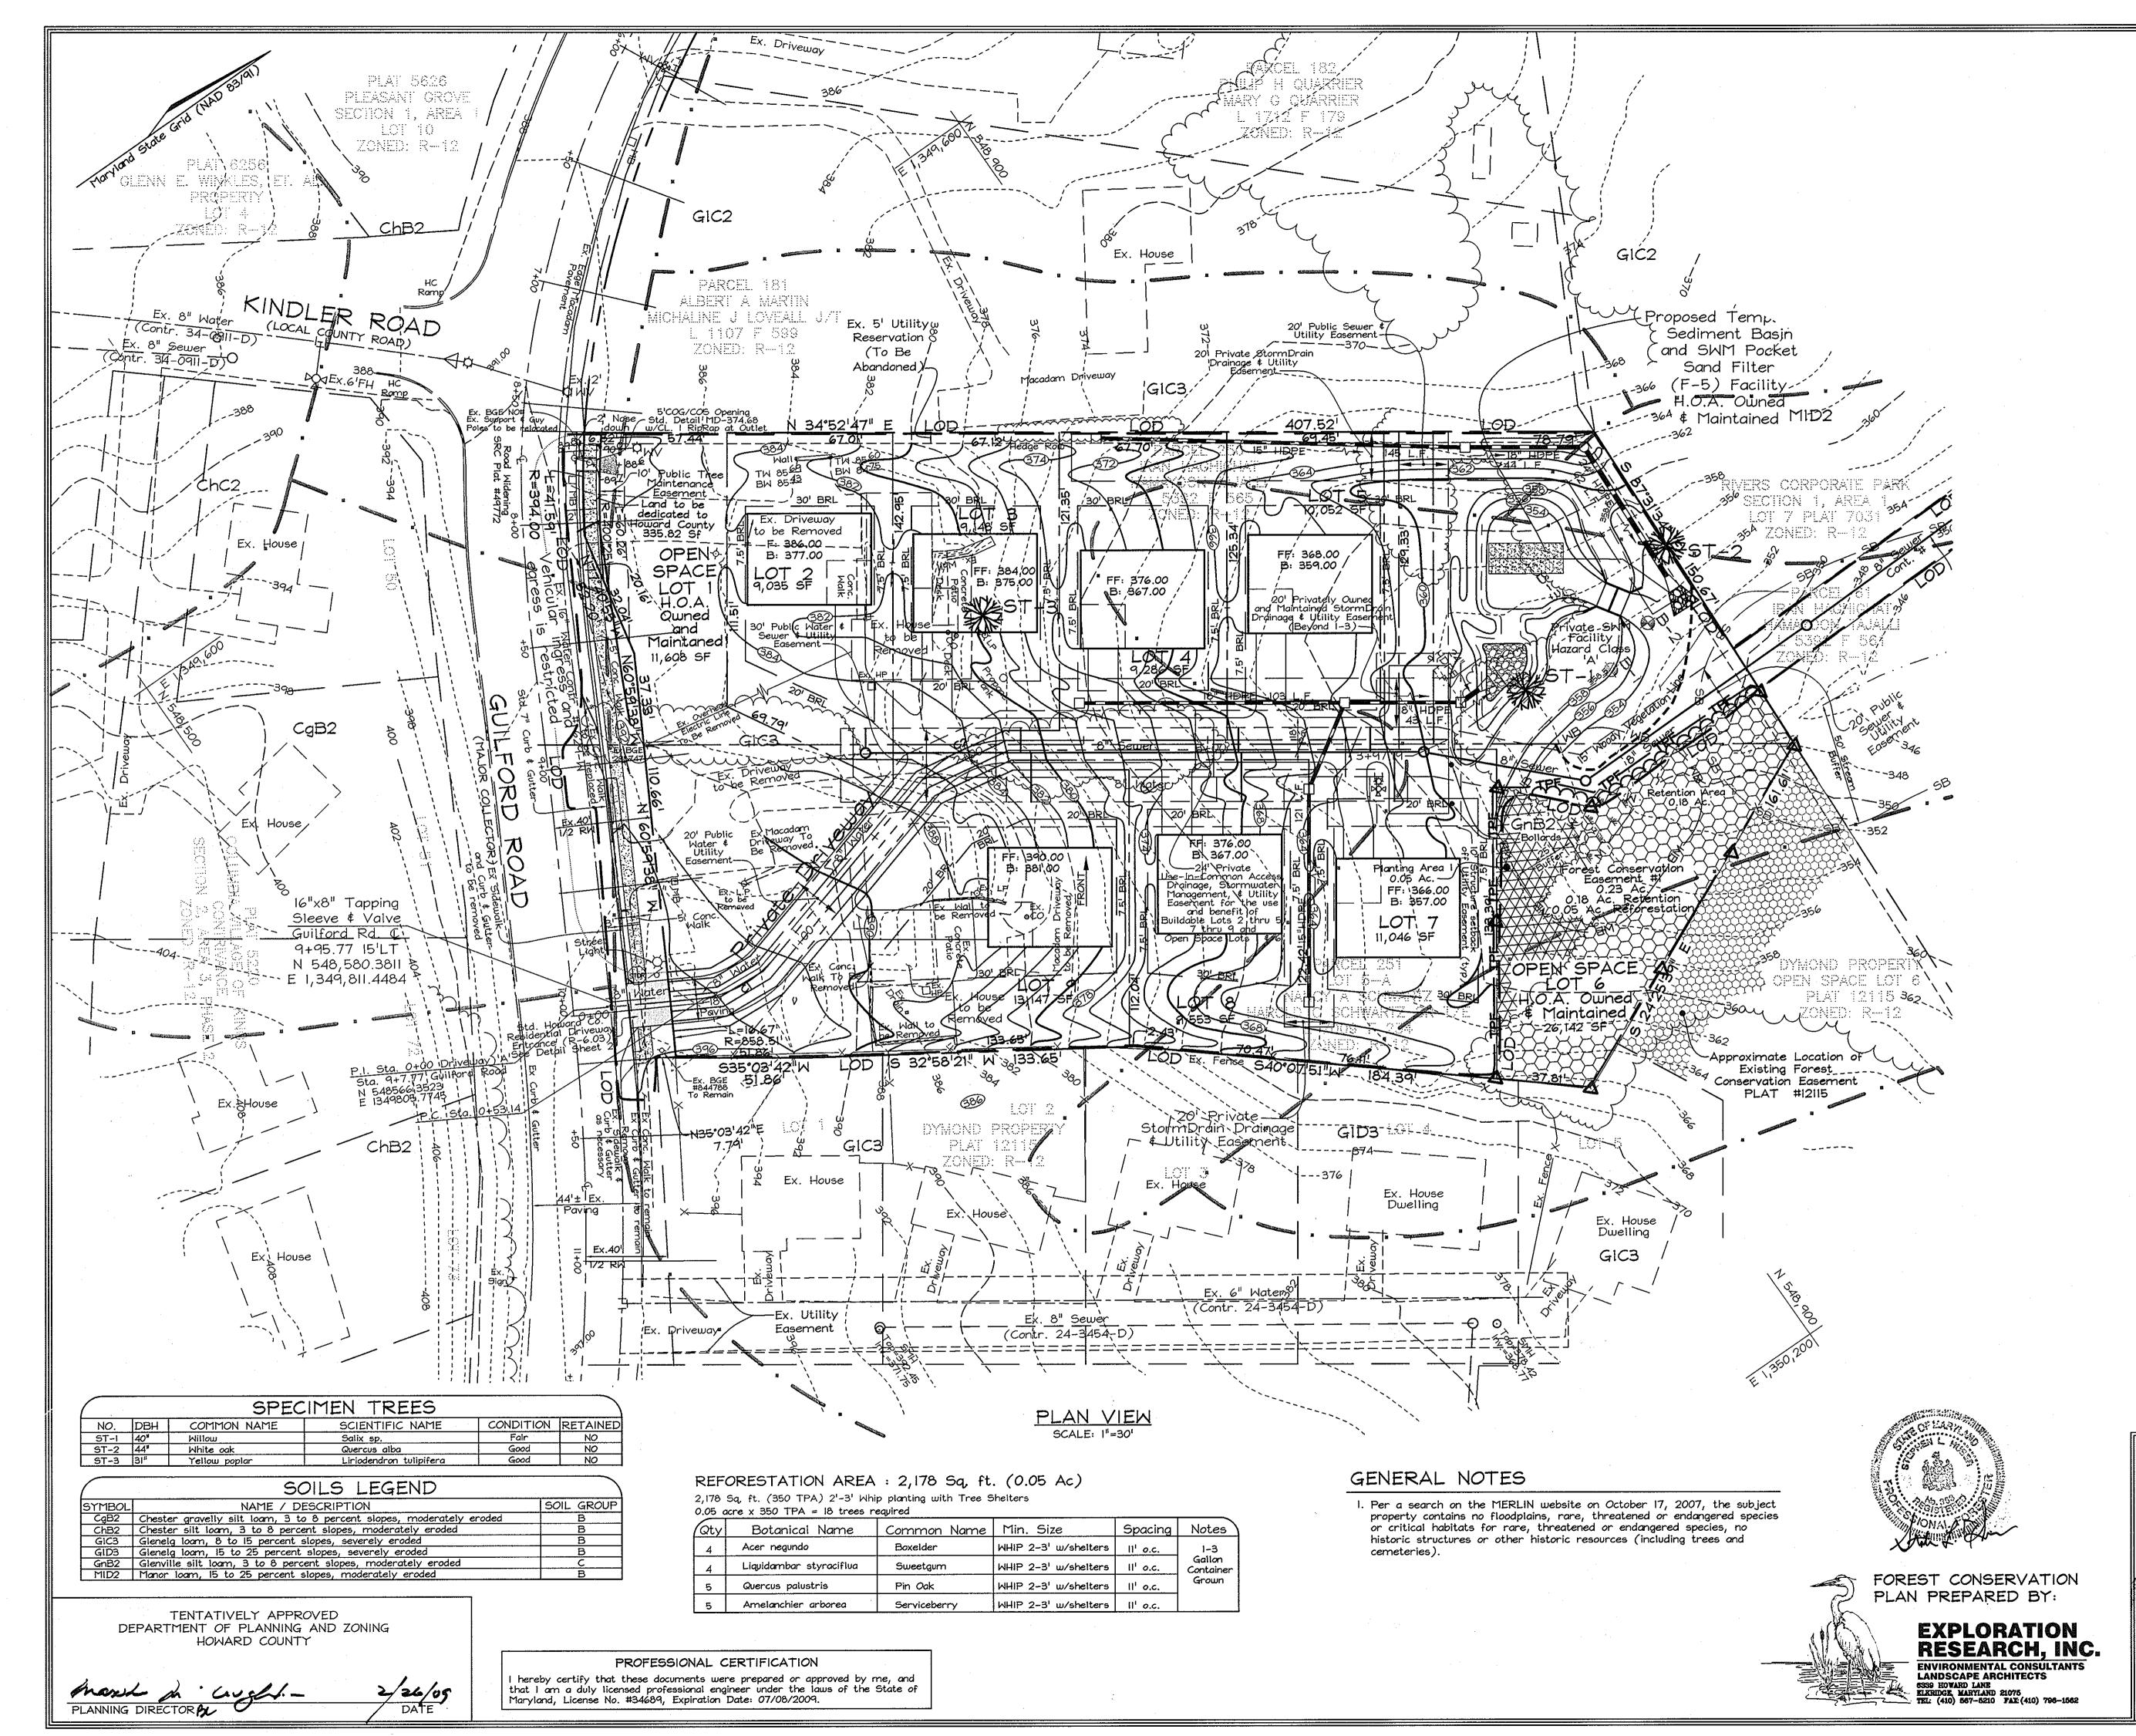

LEGEND Existing Contour ------382 Proposed Contour Existing Trees to Remain Stream Centerline Stream Buffer Wetland Wetland Buffer Soil Boundary Forest Conservation Easement Retention Area Forest Conservation Easement FCE Signage Tree Protection Fence

FOREST CONSERVATION NARRATIVE

This Forest Conservation Plan was prepared in accordance with the Howard County Forest Conservation Manual.

The total tract area consists of 2.51 acres of land. The site contains 0.46 acres of forest resources, 0.18 acres of which shall be retained in a Forest Conservation Easement. There are 3 specimen trees on-site, all of which will be removed for site grading and utilities.

Of the required 0.48 acres of reforestation, 0.05 Ac. shall be planted in the Forest Conservation Easement. The easement will partially contain priority areas of wetland and wetland buffer. The remaining 0.43 acres of obligation will be fulfilled by a fee-in-lieu payment of \$14,048.10 (18,730.8 s.f. @ \$0.75/s.f.).

FOREST CONSERVATION WORKSHEET

Net Tract Area	Acres
A. Total Tract Area	2.51
B. Area Within 100 Year Floodplain	
C. Other deductions	
D. Net Tract Area	2.51
Zoning Use Category: RESIDENTIAL-SUBURBAN	
Land Use Category	
E. Afforestation Minimum (15 % x D)	0.38
 F. Conservation Threshold (20 % x D)	0.50
 Existing Forest Cover	
G. Existing Forest on Net Tract Area	0.42
H. Forest Area Above Conservation Threshold	0
 Breakeven Point	
1. Forest Retention Above Threshold with no	0.50
Mitigation	
J. Clearing Permitted without Mitigation	0
Proposed Forest Clearing	
 K. Forest Areas to be Cleared	0.24
L. Forest Areas to be Retained	0.18
 Planting Requirements	
M. Reforestation for Clearing Above Threshold	0
N. Reforestation for Clearing Below the Threshold	0.48
P. Credit for Retention Above Conservation Threshold	0
Q. Total Reforestation Required	0.48
R. Total Afforestation Required	0
S. Total Reforestation and Afforestation Requirement	0.48

OWNER/DEVELOPER

CMC Land, LLC 11710 Stonegate Lane Columbia, MD 21044 Attn: Ms. Cindy Delzoppo 443-250-6395


PRELIMINARY FOREST CONSERVATION PLAN

KINGS COVE

(A RESUBDIVISION OF LOTS 4 AND 5-A, PLAT NUMBERS PB 7/F 71 AND PB 026/F 039) ZONING R-12

TAX MAP 42 GRID 7 6TH ELECTION DISTRICT


PARCELS 61, 250 \$ 251 HOWARD COUNTY, MARYLAND

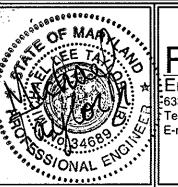



FSH Associates Engineers Planners Surveyors 6339 Howard Lane, Elkridge, MD 21075 Tel:410-567-5200 Fax: 410-796-1562 E-mail: info@fsheri.com


DESIGN BY: MLT/SMM DRAWN BY: <u>HS/SMM</u> CHECKED BY: ZF/RAB SCALE: As Shown DATE: Feb. 2, 2009 W.O. No.: 3394/2379 SHEET No.: 6 OF 7

ROOT PRUNING . Retention areas shall be set prior to construction 2. Boundaries of retention areas shall be flagged, and location of trench shall be specified by ERI Qualified Professional. 3. Roots shall be cut cleanly with root pruning equipment. Where roots >1" are found, trenching shall be done by air spade or hand tools. Roots >1" shall be cut with a hand saw. 4. Trench shall be immediately backfilled with soil removed or high organic content soil. 5. Any other techniques shall be approved by the ERI Qualified Professional before implementation. -Tree Protection Fence -6"-12" from trench to fence _12"± from LOD -2' minimum depth 6" maximum width CRITICAL ROOT ZONE

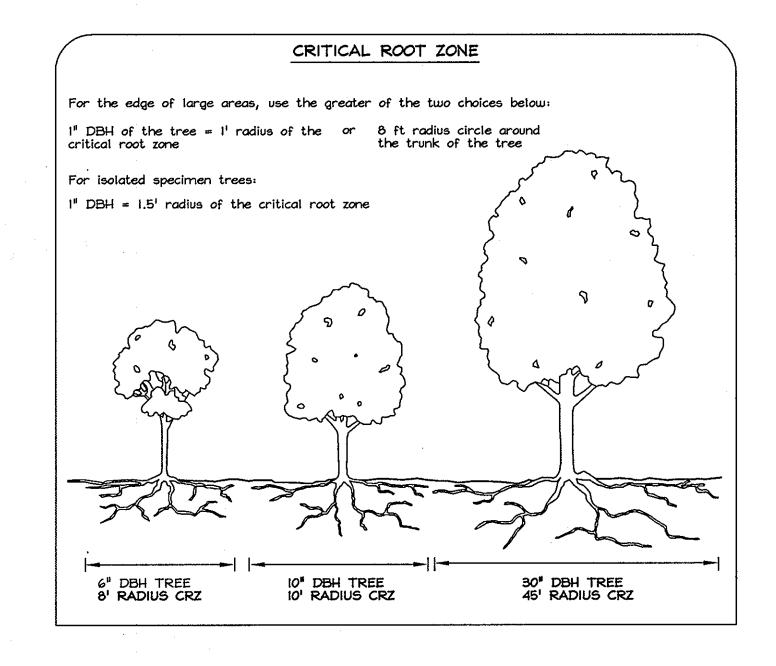

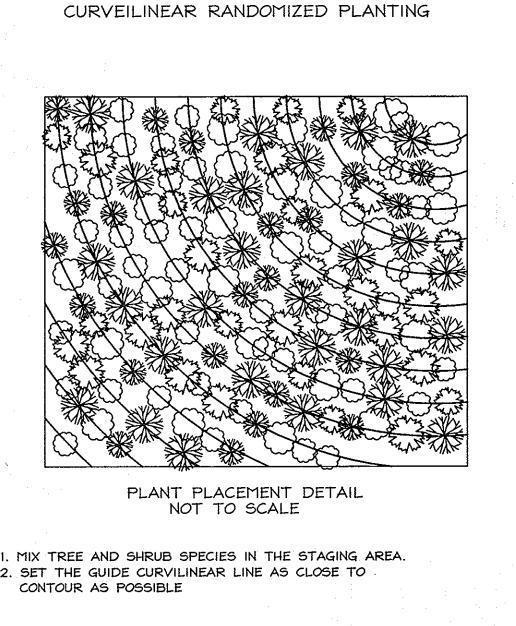

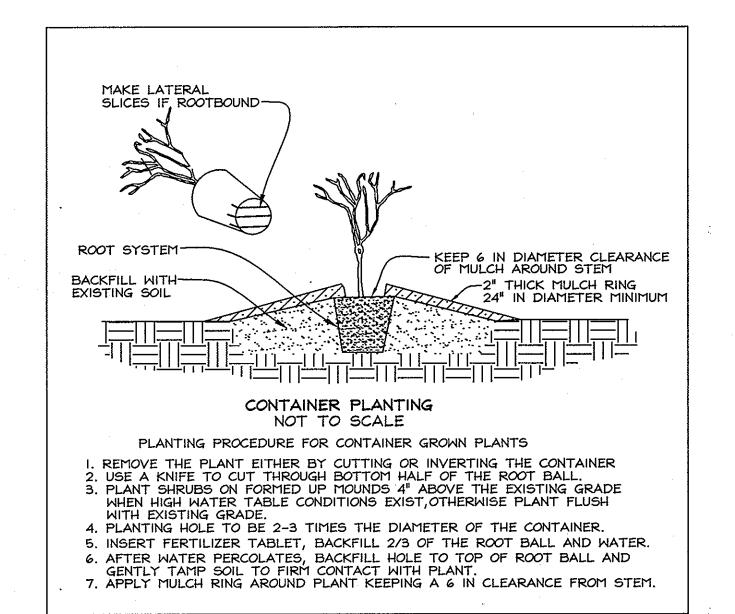

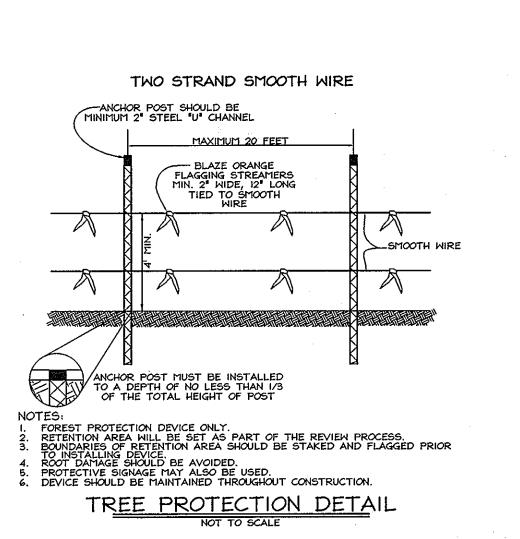

Soil Protection Zone Notes

Pruning detail, shown on this plan.

Forest Conservation Professional

treatment or removal.

Limit of Disturbance.

1. The Soil Protection Zone shall include all areas contained outside the

2. Where possible, the Soil Protection Zone shall extend to the drip line

drip line or 40% of the height of the tree, whichever is greater.

3. No construction activity is permitted within the Soil Protection Zone.

5. Root pruning shall occur prior to the beginning of construction.

of specimen trees. For other groups of trees, the zone shall be the

4. If soil has been compacted or grading has taken place in the vicinity of

6. Where the Limit of Disturbance must encroach inside the Critical Root

mulching, radial trenching, or another method approved by the ERI

7. Prior to construction, the Limits of Disturbance shall be marked and

8. Tree maintenance and removal shall be undertaken by a qualified

impact otherwise unprotected Critical Root Zone.

Maryland Tree Expert to ensure damage to surrounding trees is

9. Brush and limbs removed for construction shall be chipped and spread at the edge of the Soil Protection Zone to a depth of 6 inches. This

shall occur outside the Soil Protection Zone where compaction could

the ERI Professional shall determine which trees will need preventative

Zone of a tree, soil disturbance shall be mitigated with vertical

the Soil Protection Zone, root pruning shall be implemented per Root

Reforestation Area Planting Notes

- 1. Initial planting inspection and certification required. Planting contractor to notify ERI qualified professional 24 hours in advance of planting.
- 2. Reforestation areas may be planted as soon as reasonable to do so. Late winter- early spring plantings are preferred. Earliest planting dates will vary from year to year but planting may generally begin as soon as the ground is no longer frozen. Alternate planting dates may be considered as conditions warrants.
- 3. Soil amendments and fertilization recommendations will be made based upon the results of soil analysis for nitrogen, phosphorus, potassium, organic matter content and pH. If required, fertilizer will be provided using a slow release, soluble 16-8-16 analysis designed to last 5-8 years contained in polyethylene perforated bags such as manufactured by ADCO Works, P.O. Box 310 Hollins, N.Y. 11423 or approved equal.

 4. Plant materials shall be planted in accordance with the planting
- diagram, planting details and planting schedule.

 5. Plant stock must be protected from desiccation at all times prior
- to planting. Materials held for planting shall be moistened and placed in cool shaded areas until ready for placement.
- Plants not conforming to the American Standards for Nursery Stock specifications for size, form, vigor, or roots, or due to trunk wounds, breakage, desiccation, insect or disease must be replaced.

6. Planting materials shall be nursery grown and inspected prior to planting.


- 7. Newly planted trees may require watering at least once per week during the first growing season depending on rainfall in order to get established. The initial planting operation should allow for watering during installation to completely soak backfill materials.
- 8. Mulch shall be applied in accordance with the diagram provided and shall consist of composted, shredded hardwood bark mulch, free of
- 9. Planting holes should be excavated to a minimum diameter of 2.5 to 3 times the diameter of the root ball or container. Mechanical angering is preferred with scarification of the sides of each hole.
- 10. All nursery stock to be sprayed with deer repellent containing Bitrex such as Repellex All nursery stock to be grown with deer repellent tablets in growing medium, such as Repellex Tablets.

Reforestation Area Monitoring Notes

- 1. Monthly visits during the first growing season are to assess the success of the plantings and to determine if supplemental watering, pest control or other actions are necessary. Early spring visits will document winter kill and autumn visits will document summer kill.
- 2. The minimum survival rate shall be 75% of the total number of trees planted per acre at the end of the two year maintenance period. Wild tree seedlings from natural regeneration on the planting site may be counted up to 50% toward the total survival number if they are healthy native species at least 12 inches tall.
- Certification at the end of the two-year post construction period must indicate that the survival rates will result in a 100 tree per acre ratio for a forest and the 3 to 4 foot height standard for whips by the end of the two growing season post construction period, with at least 50% of those trees having the potential of attaining a 2" caliper DBH within 7 years.
- 3. Survival will be determined by a stratified random sample of the plantings. The species composition of the sample population should be proportionate to the amount of each species in the entire planting to be sampled. 4. Effective monitoring will assess plant survivability during the first growing
- season and make recommendations for reinforcement planting if required at

Forest Retention Management Notes

- 1. All proposed activities shall adhere to the conditions, schedules and terms of an approved sediment control and erosion plan.
- 2. After the boundaries of the retention area have been staked and flagged and before any disturbance has taken place on-site, a preconstruction meeting at the construction site shall take place. The developer, contractor or project manager, and appropriate County inspectors shall attend.
- 3. Tree protection for all retained areas:
- a. All retention areas within 50 feet of proposed construction activities shall be protected by highly visible, well anchored temporary protection devices (silt fence or blaze orange plastic mesh).
- b. All protection devices shall be in place prior to any grading or land
- c. All protection devices shall be properly maintained and shall remain in place until construction has ceased.
- d. Attachment of signs, fencing or other objects to trees is
- e. No equipment, machinery, vehicles, materials or excessive pedestrian traffic shall be allowed within protected areas.
- 4. If the critical root zone (see detail) is affected by construction activities such as grade change, digging for foundations and roads or utility installation:
- a. Prune roots with a clean cut using proper pruning equipment (see root pruning detail)
- b. Water and fertilize as needed.
- 5. During construction phase, monitor and correct condition of retained trees for: soil compaction, root injury, flood conditions, drought
- conditions and other stress signs. 6. Post-Construction Phase
- a. Inspect existing trees around the perimeter of disturbed limits for evidence of soil compaction, root injury, limb injury, or other stress signs and correct with proper management techniques such as root or limb pruning, soil aeration, fertilization, crown reduction or watering. Inspection and evaluation shall be performed by a licensed arborist.
- b. Inspect for dead or dying trees or limbs which may pose safety hazard and remove.
- c. No burial of discarded materials will occur onsite within the conservation areas.
- d. No burning within 100 feet of wooded area.
- e. All temporary forest protection structures will be removed after
- f. Following completion of construction, prior to use, the County inspector shall inspect the entire area.

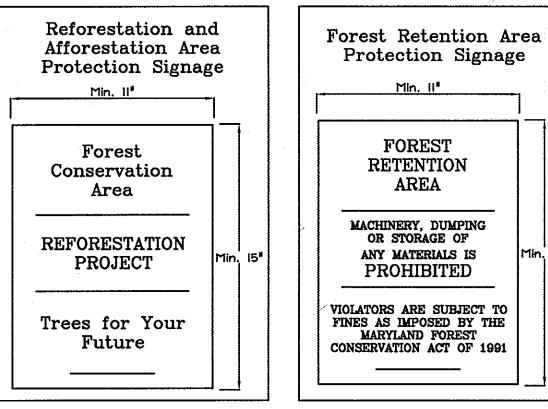

VIOLATORS ARE SUBJECT TO FINES AS IMPOSED BY THE MARYLAND FOREST CONSERVATION ACT OF 1991 SIGNAGE NOTE: All tree protection signs shall be placed on metal 'T' posts or pressure treated wood poles. NO attachment

of signs to trees is permitted.

OWNER/DEVELOPER

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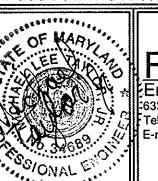
PRELIMINARY FOREST CONSERVATION NOTES AND DETAILS KINGS COVE

(A RESUBDIVISION OF LOTS 4 AND 5-A, PLAT NUMBERS PB 7/F 71 AND PB 026/F 039)

ZONING R-12

TAX MAP 42 GRID 7 6TH ELECTION DISTRICT

PARCELS 61, 250 \$ 251 HOWARD COUNTY, MARYLAND



EXPLORATION

ENVIRONMENTAL CONSULTANTS LANDSCAPE ARCHITECTS

RESEARCH, INC.

Engineers Planners Surveyors 6339 Howard Lane, Elkridge, MD 21075 Tel:410-567-5200 Fax: 410-796-1562 E-mail: info@fsheri.com

DESIGN BY: MLT/SMM DRAWN BY: HS/SMM CHECKED BY: ZF/RAE SCALE: As Shown DATE: Feb. 2, 2009 W.O. No.: <u>3394/2379</u> SHEET No.: _7_OF_7

PROFESSIONAL CERTIFICATION hereby certify that these documents were prepared or approved by me, and that I am a duly licensed professional engineer under the laws of the State of

Maryland, License No. #34689, Expiration Date: 07/08/2009.

manh- h

TENTATIVELY APPROVED

DEPARTMENT OF PLANNING AND ZONING

HOWARD COUNTY