

SECTION

SECTION I PLAT 13085

ZONED: R-SC

PRELIMINARY PLAN LOCATION: TAX MAP 38, PARCEL 235 FIRST ELECTION DISTRICT AREA OF 1871 ACCESS EASEMENT: 8072.43 SF (0.185 AC.) SHADY LANE CROSSING AREA OF FLOODPLAIN: 0.16 AC.
AREA OF STEEP SLOPES: 0.059 AC.
NET AREA OF PROJECT: 8.90 AC. — 0.16 AC. = 8.74 AC.
NUMBER OF PROPOSED RESIDENTIAL LOTS: 21 AREA OF PROPOSED RESIDENTIAL LOTS: 218669.44 SF 5.0 AC

AREA OF PROPOSED RESIDENTIAL LOTS: 218669.44 SF 5.0 AC.

AREA OF SMALLEST BUILDABLE LOT PROPOSED: 8418.57 SQ. FT (LOT 10)

: 8402.81 SQ. FT (LOT 17)

NUMBER OF PROPOSED OPEN SPACE LOTS: 3 (LOT 13, 19, 24)

AREA OF OPEN SPACE LOTS: 132083.83 SF (3.0 AC.)

AREA OF OPEN SPACE REQUIRED: 30% OF GROSS AREA OF PARCEL (2.67 AC.)

TOTAL AREA OF CREDITED OPEN SPACE PROVIDED: 12,1745.66 (2.77 ACRES) - LOT 13 AND 19

TOTAL AREA OF NON-CREDITED OPEN SPACE PROVIDED: 10,338.17SF (0.23 ACRES) - LOT 24, LOT 13.

AREA OF RECREATION OPEN SPACE REQUIRED: 4200 SF

AREA OF RECREATION OPEN SPACE PROVIDED: 4366.89 SF ON LOT 19

N 559250

COORDINATE TABLE

BOUNDARY POINTS

EASTING

1390164.5732

1391152.9777

1391141.0682

1391104.1708

1391096.7964 1390223.1079

NORTHING

559000.8020

559187.4866

559139.4407

558978,6191 558758.8283

558586.9023

HOWARD COUNTY, MARYLAND

PARCEL 871 SCHAFTINER PROPERTY

F-98-124

ZONED: R-12

___ 7.5' BRL_


NORTH 557,500.663' EAST 1,391,227.052'

HOWARD COUNTY CONTROL STATION

BENCHMARK

NORTH 557,417.823' EAST 1,391,983.177'

	SHEET INDEX
HEET NO.	TITLE
1	COVER SHEET
2	SITE AND UTILITY PLAN
3	GRADING & SEDIMENT CONTROL PLAN
4	LANDSCAPE & FOREST CONSERVATION PLAN
5	LANDSCAPE & FOREST CONSERVATION DETAILS
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- 2. DEED REFERENCE: 505/295

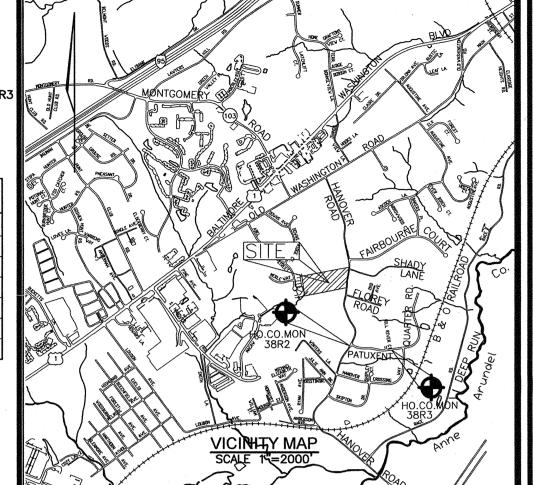- CONT. #650-S AND WATER TO BE PROVIDED THROUGH CONTR. NO. 650-S

- 19. STREET TREES ARE REQUIRED FOR THIS SUBDIVISION IN ACCORDANCE WITH SECTION 16.124(e)(1) OF THE SUBDIVISION REGULATIONS AND THE LANDSCAPE MANUAL. LANDSCAPE SURETY WILL BE PART OF THE DEVELOPER'S AGREEMENT.
- 22. OPEN SPACE LOT 19 & 24 TO BE PRIVATELY OWNED AND MAINTAINED BY THE HOA. OPEN SPACE LOT 13 TO BE OWNED AND MAINTAINED BY HOWARD COUNTY DEPT. OF RECREATION AND PARKS.
- 24. LOTS 4 & 5, 7 THRU 10, LOTS 14 THRU 17, LOTS WILL UTILIZE A USE-IN-COMMON DRIVEWAY. HOWARD COUNTY
- 25. TREE PROTECTION FENCING WILL BE PROVIDED AT THE LIMITS OF DISTURBANCE WHERE GRADING IS ADJACENT TO FOREST CONSERVATION RETENTION AREAS AND SENSITIVE ENVIRONMENTAL AREAS, SUCH AS STREAM BUFFERS AND STEEP SLOPES.
- 26. FOR FLAG OR PIPESTEM LOTS, REFUSE COLLECTION, SNOW REMOVAL AND ROAD MAINTENANCE ARE PROVIDED TO THE JUNCTION OF THE FLAG OR PIPESTEM AND ROAD RIGHT-OF-WAY LINE AND NOT TO THE PIPESTEM LOT DRIVEWAY.
- 27. ON 2/7/02, DPW BUREAU OF ENGINEERING APPROVED 8 LOTS TO HAVE NO BASEMENT GRAVITY SEWER SERVICE, SAID LOTS HAVE BEEN IDENTIFIED AT PRELIMINARY PLAN PHASE
- 28. THIS PLAN IS SUBJECT TO A DESIGN WAIVER TO DESIGN MANUAL, VOLUME III SECTION 2.5.2.H
- APPROVED APRIL 10,2003. THIS APPROVAL IS DUE TO THE FOLLOWING: 1. THE APPLICANT HAS SUBMITTED SUFFICIENT EVIDENCE THAT A SIGHT DISTANCE EASEMENT WAS REQUESTED FROM. THE ADJACENT PROPERTY OWNER(S) AS A MINIMUM REQUIREMENT FOR APPROVING A WAIVER TO THE CURRENT INTERSECTION SIGHT DISTANCE
- 2. THE PROPOSED INTERSECTIONS AS DESIGNED WILL MEET THE REQUIREMETNS FOR ADEQUATE STOPPING SIGHT DISTANCE.
- 29. THIS PLAN IS SUBJECT TO WP-03-65 TO WAIVE SECTION 16.116(a) TO ALLOW DISTURBANCE OF WETLANDS, WETLANDS BUFFER AND STREAM BUFFER FOR THE CONSTRUCTION OF A USE-IN-COMMON DRIVEWAY TO SERVE 4 RESIDENTIAL LOTS. THE CROSSING FOR THE SEWER MAIN WAS CONSIDERED TO BE ESSENTIAL. THE FOLLOWING ARE CONDITIONS OF APPROVAL:
- 1. COMPLY WITH THE COMMENTS FROM THE DEVELOPMENT ENGINEERING DIVISION REGARDING CULVERT CAPACITY AND LIMITING DISTURBANCE TO THAT SHOWN ON THE EXHIBITS DATED 1-14-03
- 2. COMPLY WITH THE COMMENTS FROM THE SOIL CONSERVATION DISTRICT DURING SUBDIVISION DESIGN
- DEVELOPEMENT TO MINIMIZE THE IMPACT OF THE DESIGN AND CONSTRUCTION OF THE DRIVEWAY ON THE WETLANDS. 3. THE DEVELOPER MUST OBTAIN ALL NECESSARY STATE AND/OR COE PERMITS FOR THE PROPOSED ENVIRONMENTAL IMPACTS.
- 31. A STOP SIGN IS REQUIRED AT THE INTERSECTION OF HANOVER ROAD. 32. THIS SUBMISSION IS SUBJECT TO THE 5TH EDITION SUBDIVISION REGULATIONS AND TO THE ZONING REGULATIONS EFFECTIVE 1-08-02.
- 33. ALL SIGN POST USED FOR TRAFFIC CONTROL SIGNS INSTALLED IN THE COUNTY RIGHT-OF-WAY SHALL BE MOUNTED ON A 2" GALVANIZED STEEL, PERFORATED, SQUARE TUBE POST (14 GAUGE) INSERTED INTO A 2-1/2" GALVANIZED STEEL, PERFORATED,
- SQUARE TUBE SLEEVE (12 GAUGE 3' LONG, A GALVANIZED STEEL POLE CAP SHALL BE MOUNTED ON TOP OF EACH POST. 34. PARKING IS PROHIBITED ON THE 60'X25' TEE TURNAROUND.
- 35. NO WELLS OR SEPTIC SYSTEMS WERE FOUND ONSITE. IF WELLS AND/OR SEPTIC SYSTEMS ARE ENCOUNTERED DURING GRADING GRADING, CONTRACTOR TO CONTACT THE HEALTH DEPARTMENT FOR PROPER ABANDONMENT.

6168 INVESTMENT & RENTAL PROPERTY, LLC 5705 LANDING ROAD

- ELKRIDGE, MARYLAND 21075 (410) 796-1850 DEVELOPER
- MAIN STREET BUILDERS 5705 LANDING ROAD ELKRIDGE, MARYLAND 21075

REQUIREMENT WITH CREDITS

0.0 AC. FT.

PLAN VIEW
SCALE 1"=50'

(410) 796-1850 QUIREMENTS - AREA 4

YEAR LESS THAN 2CF



LIBER 505 AND FOLIO 295 TAX MAP #38 GRID 9

PARCEL 235 **1ST ELECTION DISTRICT** HOWARD COUNTY, MARYLAND



ENGINEERING, INC. NEERS • SURVEYORS • PLANNERS TEL: 410.461.7666 r City, MD 21043 FAX: 410.461.8961



DESIGN BY:	RJ/JCO
DRAWN BY:	RJ/JCO
CHECKED BY:	RHV
DATE:	FEB. 2005
SCALE:	AS SHOWN
W.O. NO.:	2019019.00


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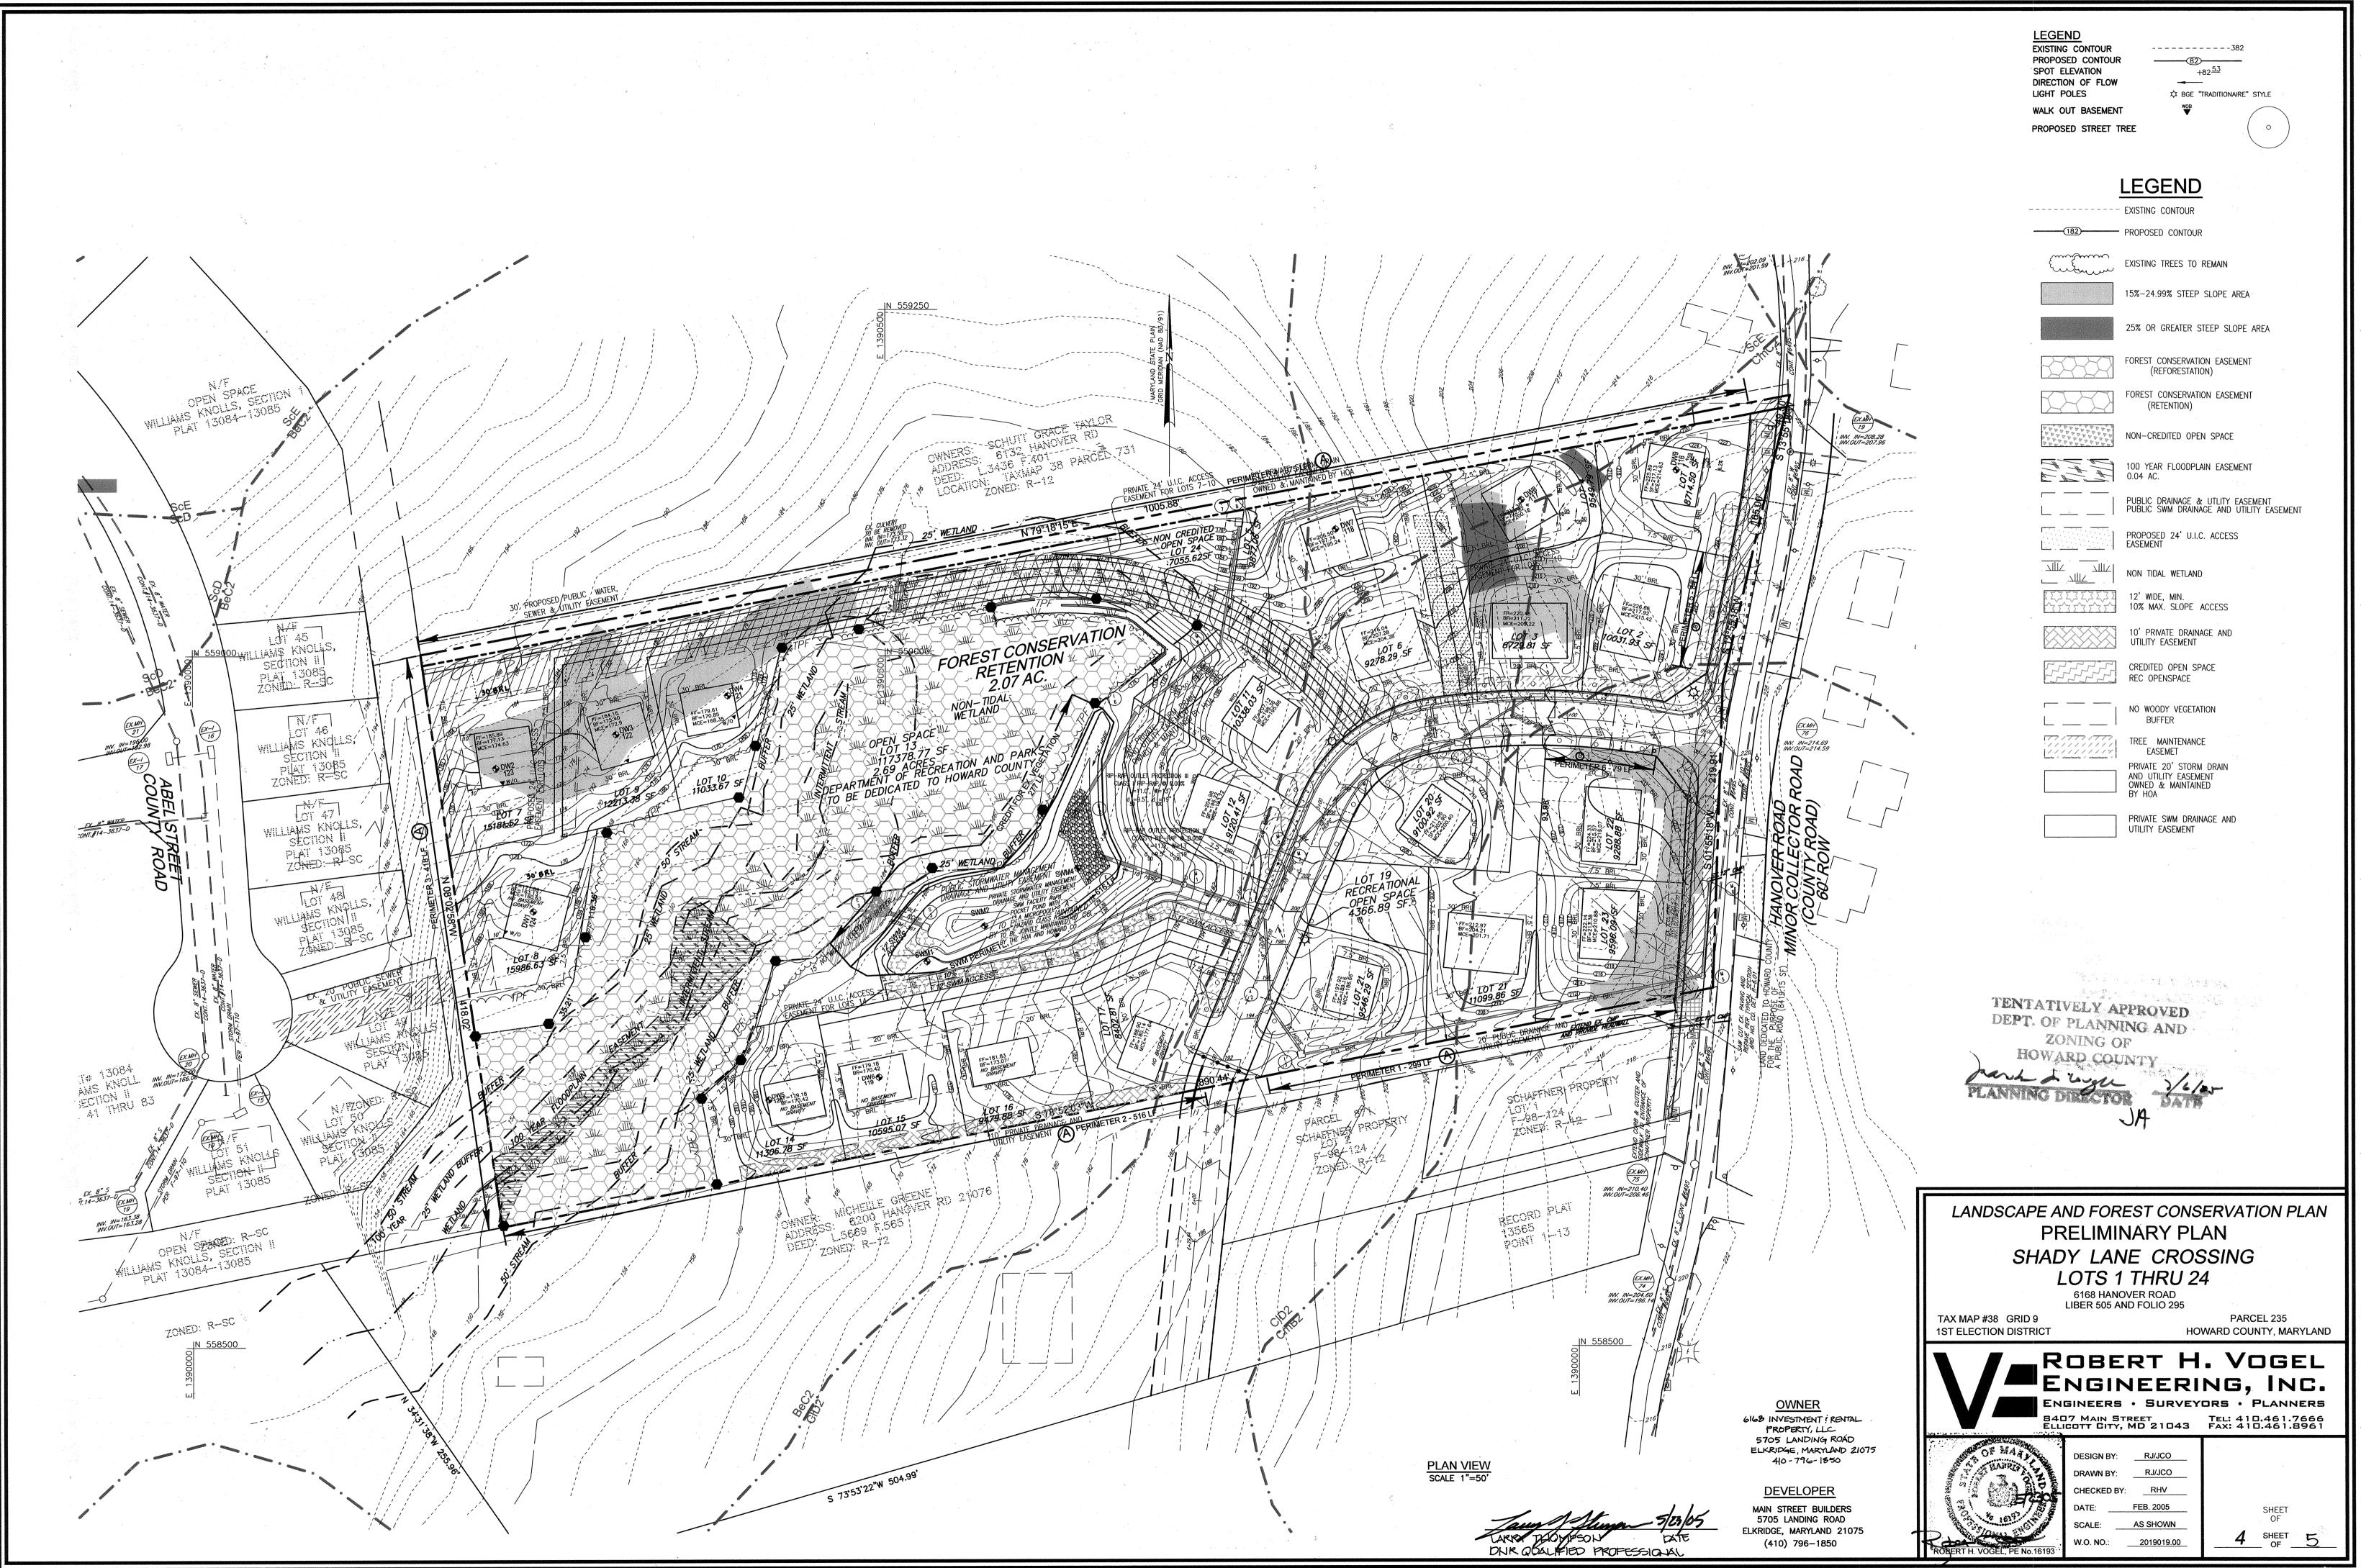
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	STOR	MWATER MANAC	SEMENT REQUIR	EMENTS - PO	ND 1		STORM	MWATER MANA	GEMENT REQUIR	REMENTS - AR	EA 2		STORM	MWATER MANAC	SEMENT REQUIR	REMENTS - ARE	=A 3		STORM	WATER MANA	GEMENT REQUI
REA 3 AC.	REQUIREMENT	VOLUME REQUIREMENT WITHOUT CREDITS	CREDITS	VOLUME REQUIREMENT WITH CREDITS	NOTES	AREA 0.96 AC.	REQUIREMENT	VOLUME REQUIREMENT WITHOUT CREDITS	CREDITS	VOLUME REQUIREMENT WITH CREDITS	NOTES	AREA 1.03 AC.	REQUIREMENT	VOLUME REQUIREMENT WITHOUT CREDITS	CREDITS .	VOLUME REQUIREMENT WITH CREDITS	NOTES	AREA 2.71 AC.	REQUIREMENT	VOLUME REQUIREMENT WITHOUT CREDITS	CREDITS
1	WATER QUALITY VOLUME (WQv)	0.13 AC. FT.		0.13 AC. FT.	50% IN GROUND WATER POCKET POND	1	WATER QUALITY VOLUME (WQv)	0.03 AC. FT.	RAINGARDENS	0.0 AC. FT.		1	WATER QUALITY VOLUME (WQv)	0.03 AC. FT.	RAINGARDENS	0.0 AC. FT.		1	WATER QUALITY VOLUME (WQv)	0.09 AC. FT.	NON-ROOFTOP DISCONNECTS RAINGARDENS
2	RECHARGE VOLUME (REv)	0.031 AC. FT. 0.36 AC.	0.39 AC. GRASS SWALE	0.00 AC. FT.		2	RECHARGE VOLUME (REV)	0.005 AC. FT. 0.06 AC.	RAINGARDENS	0.0 AC. FT.		2	RECHARGE VOLUME (REv)	0.004 AC. FT. 0.05 AC.	RAINGARDENS	0.0 AC. FT.		2	RECHARGE VOLUME (REv)	0.012 AC. FT. 0.13 AC.	NON-ROOFTOP DISCONNECTS RAINGARDENS
3	CHANNEL PROTECTION VOLUME (CPv)			0.19 AC. FT.	POCKET POND	3	CHANNEL PROTECTION VOLUME (CPv)	N/A			1 YEAR LESS THAN 2CFS	3	CHANNEL PROTECTION VOLUME (CPv)	N/A			1 YEAR LESS THAN 2CFS	3,	CHANNEL PROTECTION VOLUME (CPv)	N/A	
4	OVERHEAD FLOOD PROTECTION					4	OVERHEAD FLOOD PROTECTION (Q ₁₀ P)					4	OVERHEAD FLOOD PROTECTION (Q ₁₀ P)		-	,		4	OVERHEAD FLOOD PROTECTION (Q ₁₀ P)		
5	EXTREME FLOOD VOLUME					5	EXTREME FLOOD VOLUME (Q ₁₀₀ P)					5	EXTREME FLOOD VOLUME (Q ₁₀₀ P)	***************************************		- <u> </u>		5	EXTREME FLOOD VOLUME (Q ₁₀₀ P)		
SWM	PROVIDED BY A POCKET POND (P-5)				SWM F	PROVIDED BY A RAINGARDENS					SWM PF	ROVIDED BY A RAINGARDENS					SWM PR	ROVIDED BY A RAINGARDENS		

DEPT. OF PLANNING AND

HOWARD COUNTY





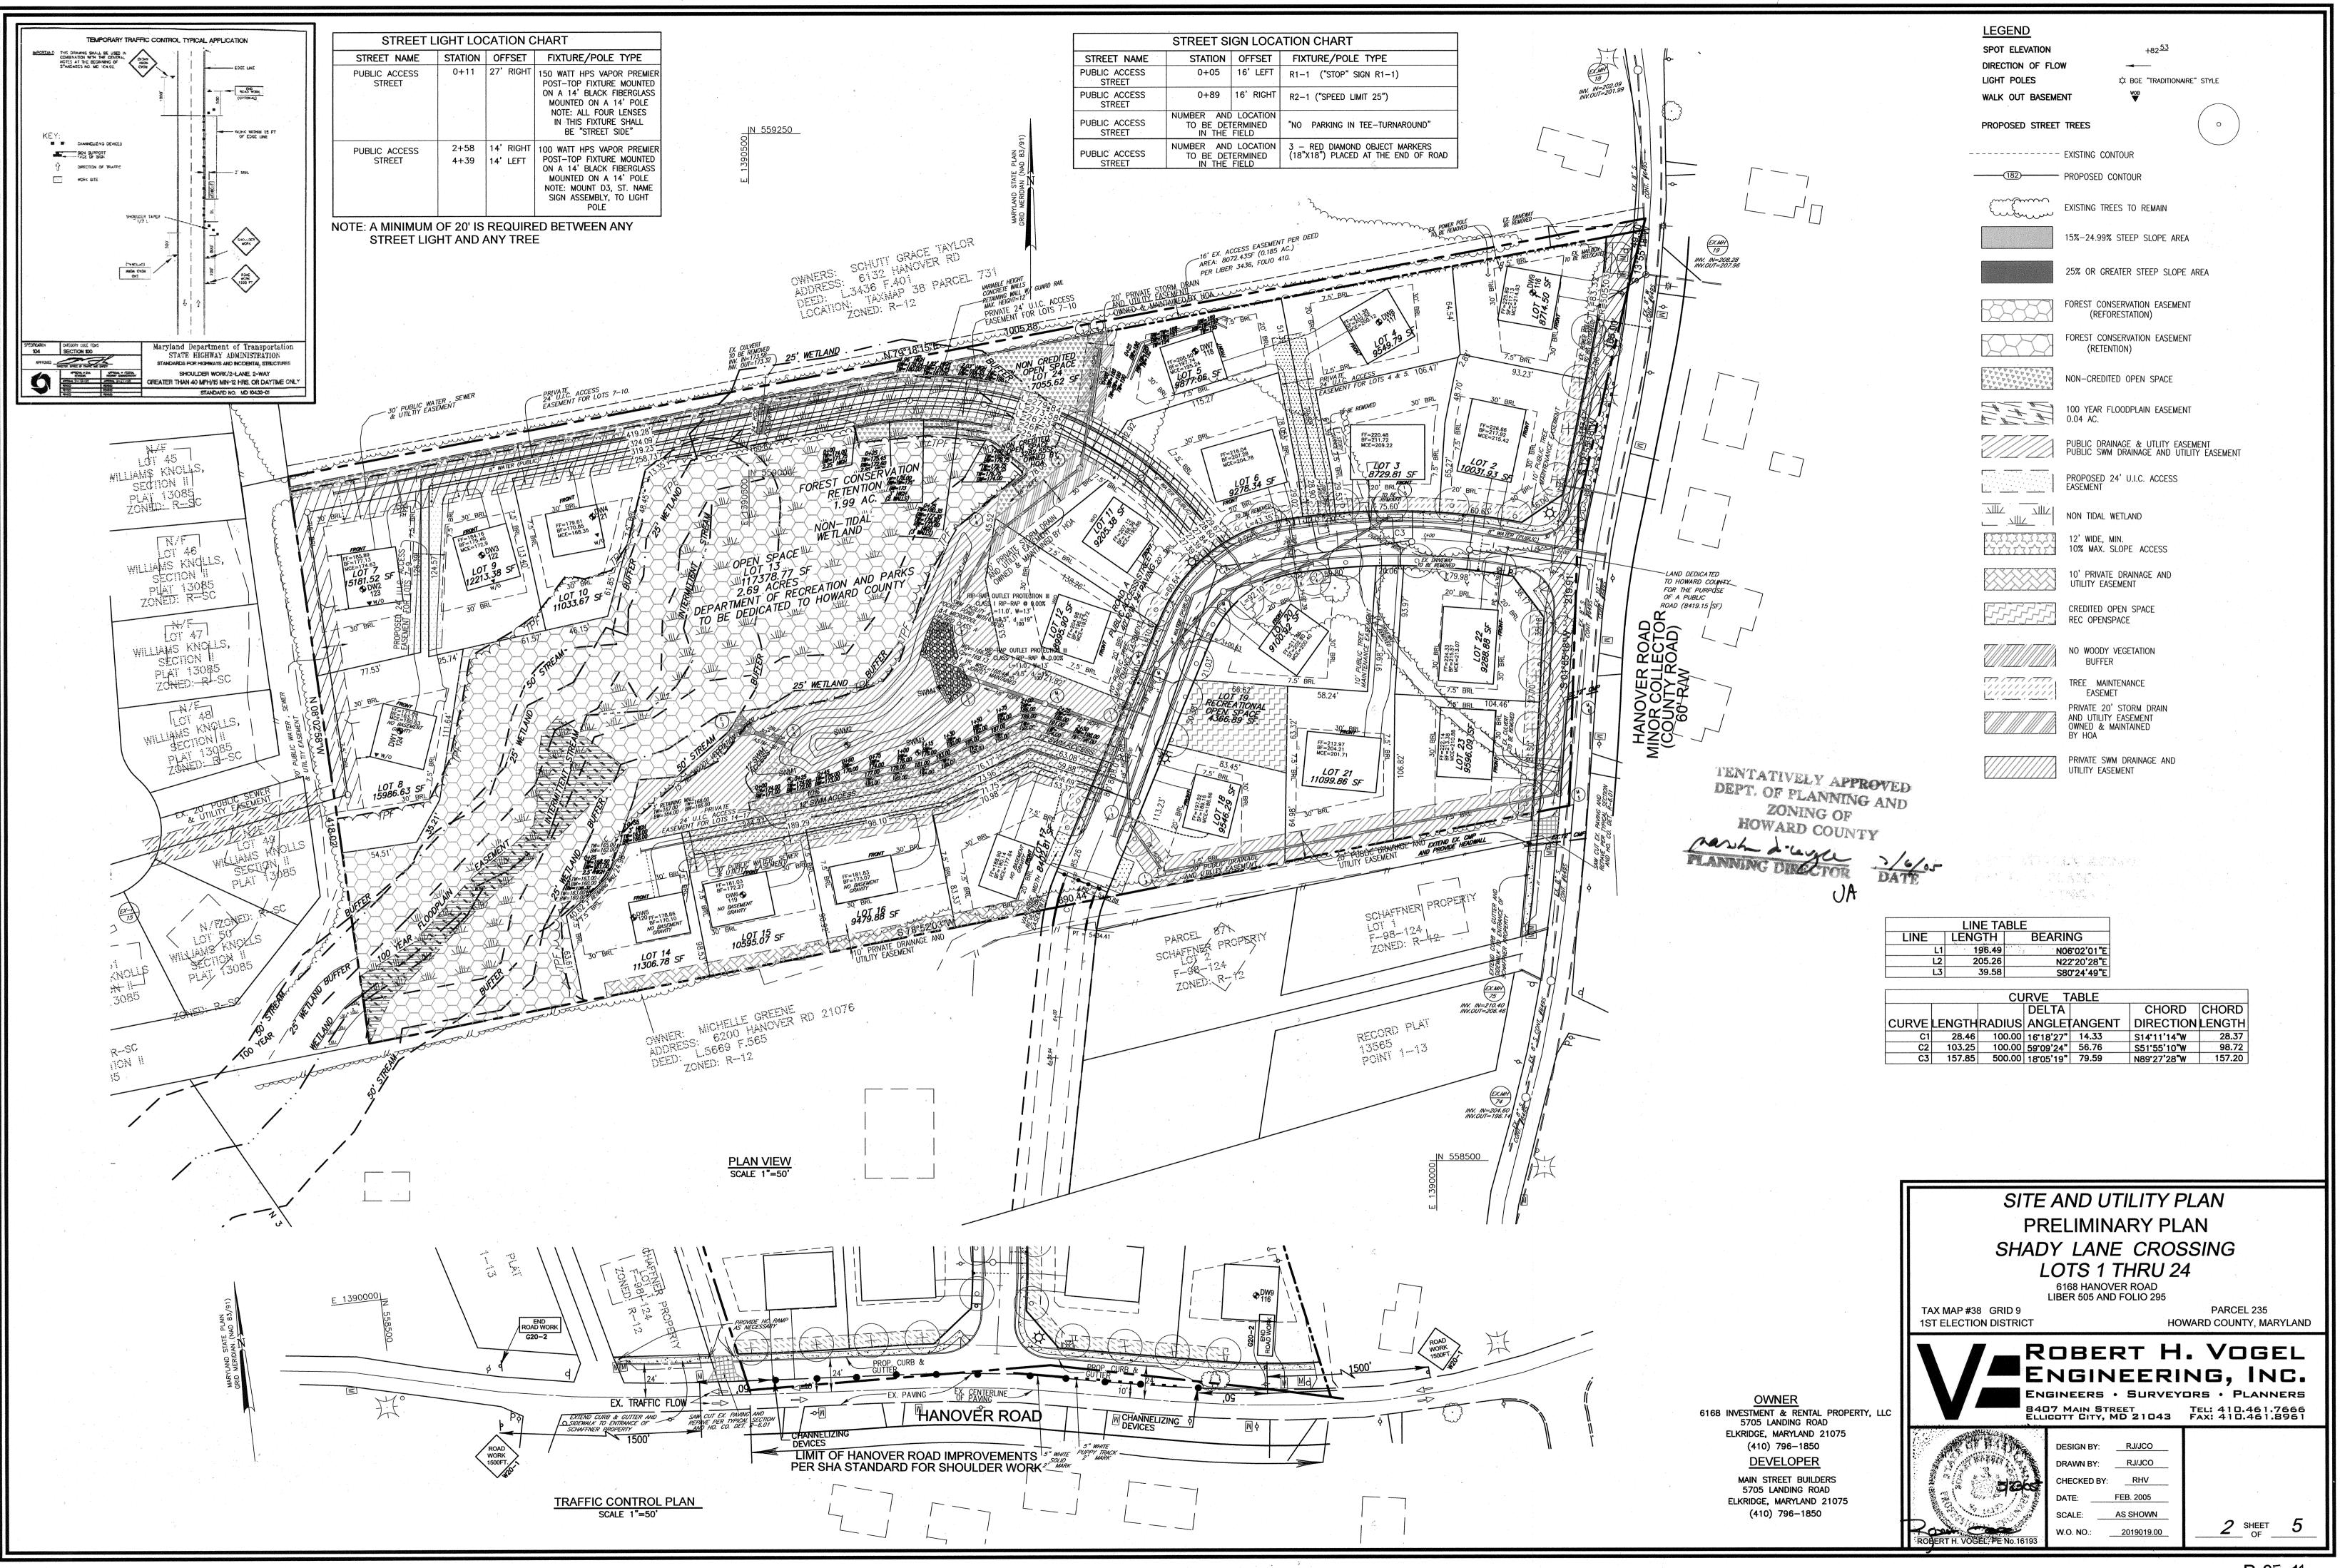

FOREST RETENTION AREAS AND NOTES

- 1. FORESTED STREAM BUFFERS ARE RETAINED IN OPEN SPACE LOTS 2. NO RARE, THREATENED OR ENDANGERED SPECIES WERE OBSERVED ON THIS SITE.
- 3. THE WOODED STEEP SLOPES ARE SUBSTANTIALLY RETAINED IN OPEN SPACE LOTS. 4. FORESTED AREAS ADJACENT TO FLOODPLAINS AND STREAM BUFFERS ARE SUBSTANTIALLY
- RETAINED IN OPEN SPACE LOTS.
- 5. THERE ARE NO ISOLATED FOREST STANDS ON THIS SITE. 6. CHANGES IN GRADING AND RUNOFF WITHIN CONSTRUCTION/INSTALLATION AREAS WILL NOT ADVERSELY AFFECT THE SOILS WITHIN THE FOREST RETENTION AREA. SEDIMENT CONTROL MEASURES WILL REDIRECT CONCENTRATED FLOW RUNOFF TO STORMWATER MANAGEMENT FACILITIES, RETAIN SEDIMENT WITHIN THE CONSTRUCTION SITE, AND/OR REDIRECT CLEAN WATER AWAY FROM CONSTRUCTION AREAS.
- 7. FOREST CONSERVATION REQUIREMENTS PER SECTION 16.1200 OF THE HOWARD COUNTY CODE, DPZ, AND THE FOREST CONSERVATION MANUAL FOR THIS SUBDIVISION WILL BE FULFILLED BY THE RETENTION OF EXISTING FOREST IN THE AMOUNT OF 2.00 AC, REFORESTATION OF 0.058 AC., AND FEE—IN—LIEU FOR THE REMAINING 0.842AC.
- 8. THE FOREST CONSERVATION EASEMENT HAS BEEN ESTABLISHED TO FULFILL THE REQUIREMENTS OF SECTION 16.1200 OF THE HOWARD COUNTY CODE. NO CLEARING, GRADING OR CONSTRUCTION IS PERMITTED WITHIN THE FOREST CONSERVATION EASEMENT, HOWEVER, FOREST MANAGEMENT PRACTICES AS DEFINED IN THE DEED OF FOREST CONSERVATION EASEMENT ARE ALLOWED.

FOREST PROTECTION NOTES

PRE-CONSTRUCTION ACTIVITES

- 1. FOR RETENTION AREAS, INSTALL BLAZE ORANGE FENCE AND RETENTION SIGNS
- BEFORE CONSTRUCTION BEGINS.
- 2. FENCING SHALL BE MAINTAINED IN GOOD CONDITION AND PROMPTLY REPAIRED OR RESTORED AS THE SITUATION WARRANTS.
- 3. A QUALIFIED TREE CARE EXPERT SHALL DETERMINE IF ROOT PRUNING IS REQUIRED ALONG THE LIMIT OF DISTURBANCE. ROOT PRUNE TREES AS REQUIRED. WATER ANY ROOT-PRUNED TREES IMMEDIATELY AFTER ROOT-PRUNING AND MONITOR FOR SIGNS OF STRESS DURING CONSTRUCTION.

CONSTRUCTION PHASE

- 1. NO DISTURBANCE OR DUMPING IS ALLOWED INSIDE THE TREE RETENTION AREA.
- 2. NO EQUIPMENT SHALL BE OPERATED INSIDE THE TREE RETENTION AREA INCLUDING TREE CANOPIES.
 - 3. IN THE EVENT OF DROUGHT, THE PROTECTED TREES SHALL BE MONITORED FOR SIGNS OF STRESS AND WATERED AS NEEDED.

POST-CONSTRUCTION ACTIVITIES

- 1. AT THE DIRECTION OF A QUALIFIED TREE CARE EXPERT, DAMAGES TO RETAINED TREES SHALL BE REPAIRED BY THE CONTRACTOR.
- 2. FENCE REMOVAL AND STABILIZATION SHALL BE AS PER THE
- SEDIMENT AND EROSION CONTROL PLAN.

3. DO NOT REMOVE SIGNS. COST ESTIMATE: (For bonding purposes, only)

RETENTION OF 200 AC.

1.49 200 ACRES OF RETENTION WILL BE RETAINED IN A FOREST CONSERVATION EASEMENT AND FEE-IN-LIEU WILL BE PAID FOR 0.20 ACRES, BOTH AS PART OF THE FINAL PLANS.

HOWARD COUNTY FOREST CONSERVATION WORKSHEET

ZONED R-20

NET TRACT AREA:		
A. TOTAL TRACT AREA	8.90	A
B. AREA WITHIN 100 YEAR FLOODPLAIN	0.16	Α
C. AREA TO REMAIN IN AGRICULTURAL PRODUCTION	0.00	A
D. NET TRACT AREA	8.74	A

LAND USE CATEGORY

INPUT THE NUMBER "1" UNDER THE APPROPIATE LAND USE ZONING, AND LIMIT TO ONLY ONE ENTRY. ZONED R-12.

ARA MDR IDA HDR MPD CIA

0 0	1 * 3	0 0	
. AFFOREST THRESHOLD		15% X D = 1.31 AC	
. CONSERVATION THRESHOLD		20% XD = 1.75 AC	

F. CONSERVATION THRESHOLD

EXISTING FOREST COVER: G. EXISTING FOREST COVER (EXCLUDING FLOODPLAIN) = H. AREA OF FOREST ABOVE AFFORESTATION THRESHOLD =
I. AREA OF FOREST ABOVE CONSERVATION THRESHOLD = 5.28 AC

4.84 AC

0.00 AC

BREAK EVEN POINT:

 $(.2 \times I) + F = BREAK EVEN POINT (2.62AC)$

J. FOREST RETENTION WITH NO MITIGATION = 2.72 AC K. CLEARING PERMITTED WITHOUT MITIGATION = 3.87 AC

PROPOSED FOREST CLEARING:

L. TOTAL AREA OF FOREST TO BE CLEARED = 4.59 AC = 2.00 AC M. TOTAL AREA OF FOREST TO BE RETAINED

PLANTING REQUIREMENTS: N. REFORESTATION FOR CLEARING ABOVE CONSERVATION THRESHOLD (L X.25) = 1.15 AC P. REFORESTATION FOR CLEARING BELOW CONSERVATION THRESHOLD = 0.00 AC Q. CREDIT FOR RETENTION ABOVE CONSERVATION THRESHOLD (M-F) = 0.25 AC R. TOTAL REFORESTATION REQUIRED (N+P-Q) 0.90 AC

T. TOTAL REFORESTATION AND AFFORESTATION REQUIRED =

OBLIGATION TO BE FULFILLED BY ON-SITE RETENTION OF 1.99 AC.

AND FEE-IN-LIEU FOR 0.91 AC.


S. TOTAL AFFORESTATION REQUIRED

1. THE TOPOGRAPHY SHOWN HEREIN IS BASED ON A TOPOGRAHIC SURVEY PREPARED BY FREDERICK WARD ASSOCIATES IN JANUARY 2002.

NOTES:


1. RETENTION AREAS TO BE ESTABLISHED AS PART OF THE FOREST CONSERVATION PLAN REVIEW PROCESS. 2. BOUNDARIES OF RETENTION AREAS TO BE STAKED, FLAGGED AND/OR FENCED PRIOR TRENCHING. . EXACT LOCATION OF TRENCH SHOULD BE IDENTIFIED. 4. TRENCH SHOULD BE IMMEDIATELY BACKFILLED WITH SOIL REMOVED OR ORGANIC SOIL.

5. ROOTS SHOULD BE CLEANLY CUT USING VIBRATORY KNIFE OR OTHER ACCEPTABLE EQUIPMENT.

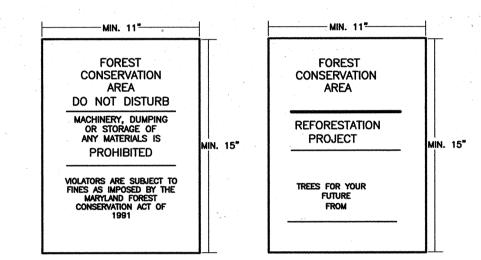

1. BOTTOM OF SIGNS TO BE HIGHER THAN TOP OF TREE PROTECTION FENCE. 2. SIGNS TO BE PLACED APPROXIMATELY 100' FEET APART. CONDITIONS ON SITE AFFECTING VISIBILITY MAY WARRANT PLACING SIGNS CLOSER OR FARTHER APART. 3. ATTACHMENT OF SIGNS TO TREES IS PROHIBITED.

FOREST CONSERVATION AREA SIGN

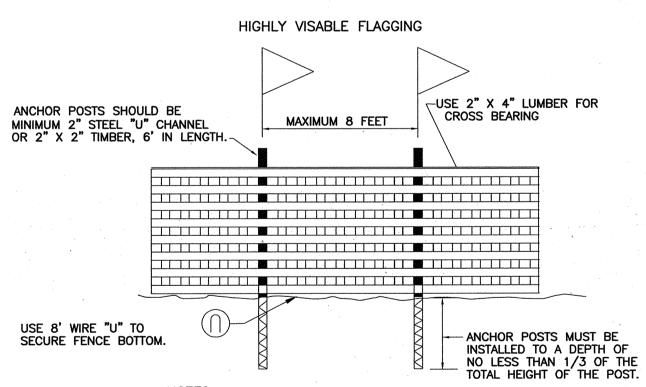

1. FOREST PROTECTION DEVICE ONLY.
2. RETENTION AREA WILL BE SET AS PART OF THE REVIEW PROCESS.
3. BOUNDARIES OF RETENTION AREA SHOULD BE STAKED AND FLAGGED

PRIOR TO INSTALLING DEVICE.

4. ROOF DAMAGE SHOULD BE AVOIDED. 5. PROTECTION SIGNAGE SHOULD BE USED.
6. DEVICE SHOULD BE MAINTAINED THROUGHOUT CONSTRUCTION.

BLAZE ORANGE PLASTIC MESH

TYPICAL TREE PROTECTION FENCE DETAIL

COLIED	III E A DE	DIMETER		DE EDOE				
SCHEDULE A: PERIMETER LANDSCAPE EDGE								
CATEGORY		OFOU	ADJACENT TO		ADJACENT TO			
		PERIM	ETER PROPER	(IIE2	RO	ADWAYS		
PERIMETER/FRONTAGE DESIGNATION	1	2	3	4	(LOT-2) 5	(LOT-22) 6		
LANDSCAPÉ TYPE	Α	Α	A	Α	В	В		
LINEAR FEET OF ROADWAY FRONTAGE/PERIMETER	299	516	418	975	84	79		
CREDIT FOR EXISTING VEGETATION (YES, NO, LINEAR FEET DESCRIBE BELOW IF NEEDED)	NO	YES* 158	YES* 140	NO	NO	NO		
CREDIT FOR WALL, FENCE OR BERM (YES, NO, LINEAR FEET DESCRIBE BELOW IF NEEDED)	NO	NO	NO	NO	NO	NO		
NUMBER OF PLANTS REQUIRED(LF REMAINING) SHADE TREES EVERGREEN TREES	299 1:60 5 —	358 1:60 6 —	278 1:60 5 —	975 1:60 17 —	84 1:50 2 1:40 2	79 1:60 2 1:40 2		
SHRUBS		-	_			_		
NUMBER OF PLANTS PROVIDED SHADE TREES EVERGREEN TREES	5	6	5	17 -	2 2	2 2		
OTHER TREES (2:1 SUBSTITUTION) SHRUBS (10:1 SUBSTITUTION)	_			_	=	_		
DESCRIBE PLANT SUBSTITUTION CREDITS BELOW IF NEEDED)	_	_	_	-	_	_		

* EXISTING WOODS TO REMAIN

SCHEDULE D: STORMWAT	ER MANAGEMENT AREA LANDSCAPING
LINEAR FEET OF PERIMETER	POND #1 616 LF
CREDIT FOR EXISTING VEGETATION (NO, YES AND LINEAR FEET)	YES* 277'
CREDIT FOR OTHER LANDSCAPING (NO, YES AND %)	NO
NUMBER OF TREES REQUIRED SHADE TREES EVERGREEN TREES	(339) 7 SHADE TREES 8 EVERGREEN TREES
NUMBER OF TREES PROVIDED SHADE TREES EVERGREEN TREES SHRUBS	7 SHADE TREES 8 EVERGREEN TREES

*EXISTING WOODS TO REMAIN

STREET TREE CALCULATIONS							
STREET NAME	LINEAR FEET	REQUIRED TREES	PROVIDED TREES				
PUBLIC ACCESS STREET-R/W	938/40	24	24				
HANOVER RD-R/W	335/40	9	9				

STREET TREE PLANT LIST								
SYMBOL	QTL	BOTANICAL NAME	SIZE	REMARKS				
•	24	SHADE TREES ACER RUBRUM/ RED MAPLE	2 1/2" -3"Cal.	B&B				
+	9	PRUNUS SARGENTII SARGENT CHERRY	2 1/2" -3"Cal.	B&B				

GENERAL NOTES

OWNER

5705 LANDING ROAD

ELKRIDGE, MARYLAND 21075

(410) 796-1850

MAIN STREET BUILDERS 5705 LANDING ROAD

(410) 796-1850

FIGO PROFESSIONAL ELKRIDGE, MARYLAND 21075

6168 INVESTMENT & RENTAL PROPERTY, LLC

A MINIMUM SPACING OF 20' SHALL BE MAINAINED BETWEEN ANY STREET LIGHT AND ANY TREE.

FINANCIAL SURETY FOR THE REQUIRED LANDSCAPING WILL BE POSTED WITH THE DEVELOPER'S AGREEMENT AS PART OF THE FINAL PLAN

> MNTATIVELY APPROVED BEPT, OF PLANNING AND ZONING OF HOWARD COUNTY



LIBER 505 AND FOLIO 295 TAX MAP #38 GRID 9

PARCEL 235 HOWARD COUNTY, MARYLAND



ROBERT H. VOGEL ENGINEERING, INC.

ENGINEERS • SURVEYORS • PLANNERS 8407 MAIN STREET TEL: 410.461.7666 ELLICOTT CITY, MD 21043 FAX: 410.461.8961



DESIGN BY: RJ/JCO RJ/JCO DRAWN BY: CHECKED BY: FEB. 2005 DATE: ____ AS SHOWN SCALE: W.O. NO.: <u>2019019.00</u>

SHEET 5