	SHEET INDEX
NO	DESCRIPTION
1	PRELIMINARY TITLE SHEET
2	PRELIMINARY PLAN
3	PRELIMINARY GRADING AND SEDIMENT CONTROL PLAN
4	PRELIMINARY LANDSCAPE PLAN
5	PRELIMINARY NOTES AND TABULATIONS
6	PRELIMINARY FOREST CONSERVATION PLAN
- Clitting Co.	

1. THE EXISTING TOPOGRAPHY IS TAKEN FROM AERIAL SURVEY MAPS WITH MAXIMUM TWO FOOT CONTOUR

4. THE STORMWATER MANAGEMENT FOR THIS SITE WILL BE PROVIDED BY A GRASS CHANNEL CREDITS, AND A

5. THE WETLANDS DELINEATION STUDY FOR THIS PROJECT WAS PREPARED BY DAFT McCUNE & WALKER, INC.

7. THE BOUNDARY SURVEY FOR THIS PROJECT WAS PREPARED BY DAFT, McCUNE & WALKER, INC. JULY 2000.

9. SEE DEPARTMENT OF PLANNING AND ZONING FILE NO'S .: S-99-12, PB-339, ZB-979-M, PB-359 (AMENDED

10. DESIGNED TRAFFIC SPEED IN ACCORDANCE WITH THE HOWARD COUNTY DESIGN MANUAL VOL. III. ALL 60' RIGHT

11. STREET TREES LOCATION, TYPE AND NUMBER OF TREES SHOWN ON THIS PLAN ARE TENTATIVE AND ARE USED FOR BOND PURPOSES ONLY. THE FINAL LOCATION AND VARIETY OF LOCATION AND VARIETY OF TREES MAY VARY

ACCORDANCE WITH THE SUBDIVISION REGULATIONS AND THE LANDSCAPE MANUAL. BOND RELEASE IS CONTINGENT UPON SECTION 16.124 OF THE HOWARD COUNTY SUBDIVISION REGULATIONS, AS APPROVED BY THE DEPARTMENT OF

1. THE STORMWATER MANAGEMENT FACILITY SHOWN ARE SCHEMATIC ONLY. ACTUAL SIZE AND LOCATION OF THE FACILITY MAY CHANGE PRIOR TO CONSTRUCTION. THE DEVELOPER ACKNOWLEDGES THAT THESE FACILITIES MUST

16. DEVELOPMENT OF EMERSON SECTION 3, AREA 2 UNDER THE CURRENT FOREST CONSERVATION ACT REQUIRES THE CLEARING OF APPROXIMATELY 2.20 FORESTED ACRES. WHEN EVALUATED CUMULATIVELY WITH PREVIOUS PHASES OF THE PROJECT, NO REFORESTATION IS REQUIRED. PLEASE SEE THE TRACKING CHART ON CHART 5 FOR DETAILS.

17. THE EXISTING STRUCTURE ON PARCEL 'B' WILL REMAIN AND WILL REMAIN VACANT UNTIL SUCH TIME AS A

19. STREAM BUFFERS ARE DETERMINED BY LAND USE ADJOINING THE OPEN SPACE. EMPLOYMENT USE = 50' BUFFER FROM ANY STREAM. RESIDENTIAL USES = 50' BUFFER FOR INTERMITTENT STREAMS AND 75' BUFFER FOR

20. PHASING FOR THIS PROJECT IS IN ACCORDANCE WITH THE DECISION AND ORDER FOR ZONING CASE ZB-979M

18. OPEN SPACE AREAS MAY CONTAIN ACTIVE RECREATION FACILITIES AS ALLOWED IN THE APPROVED

AND THE DECISION AND ORDER FOR PB-339 AND PB-359, (COMPREHENSIVE SKETCH PLAN S-99-12).

21. ON SEPTEMBER 3, 1998, THE ZONING BOARD GRANTED APPROVAL OF ZB-979M FOR THE PRELIMINARY DEVELOPMENT PLAN AND DEVELOPMENT CRITERIA FOR 516 ACRES OF LAND RE-ZONED AS PEC-MXD-3 AND

22. PARCELS A&B MAY BE RESUBDIVIDED FOR EMPLOYMENT USES, IN ACCORDANCE WITH THE APPROVED

23. DEVELOPMENT FOR THIS PHASE WILL BE DONE IN ACCORDANCE WITH THE DEVELOPMENT CRITERIA APPROVED

Ac. (%)

-0-

-0-

80.6 (32.1%)

(B) Allowed

44.5 27.3 (61.3%)

Other Res.

Ac. (%)

-0-

Land Use Acreages

8.0 (8.2%)

Emerson Sections 2 & 3 (MXD) - Overall Development Tracking Chart

June 3, 2002

Ac. (%)

40.1 (41%)

4.9 (26.5%)

47.4 (68.2%)

17.2 (38.7%)

117.83 (44.7%)

114.4 251.4 -0-

Ac. (%)

22.1

8.92

31.02 (11.8%)

SFD Units

Max. Res. Units Proposed

Note: This chart reflects the current information for this project at the time of recordation of this plat or approval

of this plan. For current information, refer to the most recently recorded plat or approved plan.

Aptmt (OR)

SFA (OR)

Max. Res. Units Allowed

S-99-12

450 (37.5%) 395 (34.5%)

 500 (41.7%)
 500 (43.7%)

 250 (20.8%)
 250 (21.8%)

TO ACCOMODATE FIELD CONDITIONS INCLUDING 20' CLEARANCE OF ANY STREET LIGHT AND SHALL BE IN

12. STREAM BUFFERS ARE DETERMINED BY LAND USE ADJOINING THE OPEN SPACE. EMPLOYMENT USE = 50'

INTERVALS PREPARED BY AIR SURVEY CORP. FLOWN IN APRIL 1998.

6. THIS PROJECT FALLS UNDER THE APPROVED APFO STUDY OF S-99-12.

8. SUBJECT PROPERTY ZONED PEC-MXD-3 PER ZONING BOARD CASE ZB-979-M.

13. THERE ARE NO KNOWN CEMETARIES OR GRAVE SITES ON THIS PROPERTY.

WAIVER OR SITE PLAN IS APPROVED FOR EMPLOYMENT USE.

COMPREHENSIVE SKETCH PLAN (S-99-12) AND DEVELOPMENT CRITERIA.

WITH COMPREHENSIVE SKETCH PLAN S-99-12 (PB-339).

Number

F-01-137

F-01-45

F-02-55

File Reference Gross Acreage

MEET CURRENT HOWARD COUNTY DESIGN CRITERIA/OR AS APPROVED BY WAIVER.

2. WATER IS PUBLIC.

3. SEWER IS PUBLIC.

PUBLIC WET POND.

S-99-12)

BUFFER FROM ANY STREAM.

R-SC-MXD-3.

Section and

Phase

TOTAL

Overall Density Tabs

Overall SFD Density

Overall Project Density

Overall OR Density


EMERSON SECTION THREE AREA TWO 6th ELECTION DISTRICT HOWARD COUNTY, MARYLAND

BENCHMARKS

TRAVERSE POINT 102 ELEVATION 346.19 N 536,499.165 E 1,353,974.017 LOCATED NEAR THE INTERSECTION OF GORMAN ROAD AND SKYLARK BLVD.

TRAVERSE POINT 1154 ELEVATION 347.45 N 536,018.069 E 1,355,129.333 LOCATED NEAR THE I-95 BRIDGE ALONG GORMAN ROAD

CONTROL STATION 47E4 ELEVATION 339.00 N 535,846.16 E 1,355,431.23 LOCATED NEAR THE I-95 BRIDGE ALONG GORMAN ROAD

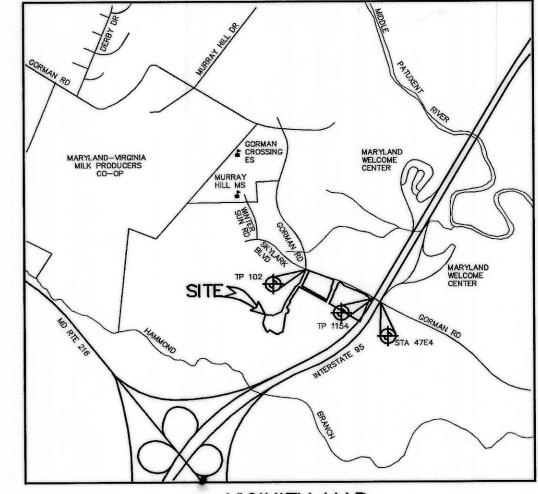

SITE ANALYSIS DATA CHART

1. AREA TABULATION

12.35 ACRES a. TOTAL GROSS SITE AREA OF 3/2 b. LESS STEEP SLOPES 0 ACRES 0 ACRES c. LESS 100 YEAR FLOODPLAIN d. NET SITE AREA 12.35 ACRES e. AREA OF PROPOSED EMPLOYMENT PARCELS (includes road right of way) f. AREA OF PROPOSED OPEN SPACE LOTS 3.43 ACRES 3.43 ACRES AREA OF HOA OPEN SPACE LOTS 0.86 ACRES g. AREA OF PROPOSED PUBLIC ROADS

2. OPEN SPACE DATA

a. NUMBER OF OPEN SPACE LOTS/PARCELS PROPOSED: b. OPEN SPACE REQUIRED: 4.37 ACRES (35.4% OF GROSS ACREAGE). c. OPEN SPACE PROVIDED: 3.43 CREDITED ACRES (the balance of the open space requirement is drawn from the excess open space in Section 2, Phase 1).

SECTION 1, F-01-40GORMAN ROAD (7 PARCEL FUTURE RESIDENTIAL PARCEL B OPEN SPACE FUTURE EMPLOYMENT Other Res. Units Other Res. (SFA/Apt/Condo) Density Density (D) 3 D.U./Ac. 9.4 D.U./Ac. 8.8 D.U./Ac.

BOUNDARY CHART

1 536034.7138 1354920.9220 N 47°23'37" W 104.05' S 33 28 26 W 66.09

TENTATIVELY APPROVED DEPT. OF PLANNING AND ZONING OF HOWARD COUNTY

REVISION DATE NO. OWNER/DEVELOPER

THE HOWARD RESEARCH AND DEVELOPMENT CORPORATION THE ROUSE BUILDING 10275 LITTLE PATUXENT PARKWAY COLUMBIA, MARYLAND 21044 410-992-6000

PROJECT

EMERSON SECTION THREE AREA TWO

TAX MAP 47 BLOCK 8 & 9 ZONED: PEC-MXD-3 PARCEL: 462


6th ELECTION DISTRICT HOWARD COUNTY, MARYLAND

PRELIMINARY TITLE SHEET

Patton Harris Rust & Associates,pc

Engineers. Surveyors. Planners. Landscape Architects.

8818 Centre Park Drive Columbia, MD 21045 T 410.997.8900

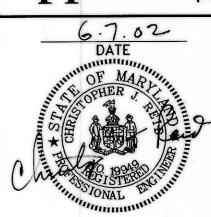

DESIGNED BY : A.C.R DRAWN BY: DAM

CHECKED BY: C.J.R. PROJECT NO: C-PREL1.DWG DATE: JUNE 5, 2002

SCALE : AS SHOWN DRAWING NO. 1 OF 6

CHRISTOPHER J. REID #19949 P-02-22


13 14 15 16 17 18 19 20 21 22 23 24 25 26 27 28 29 30	536180.0790 536245.2506 536314.3728 536330.9590 536469.9420 536459.0382 536476.4979 536484.4903 536506.8740 536228.5194 536228.5194 536002.8472 535839.1368 535783.3200 535796.7604 535668.1019 535606.5698 535603.7883 535521.9557 535550.7841 535520.5955 535487.1860 535526.8661 535805.7487 535832.1736 535859.9892 535913.8472	1354446.6541 1354453.1859 1354080.3580 1354076.2950 1354029.4425 1353965.0392 1353904.9733 1353804.5198 1353728.9157 1353583.4665 1353511.3360 1353383.1162 1353261.8588 1353220.9687 1353234.4890 1353234.4890 1353242.3192 1353269.4269 1353294.0847 1353326.3989 1353376.2413 1353376.2413 135353532.2316 1353578.1517 1353618.5119 1353631.0374 1353599.1053	Z K Z Z W Z X Z X Z X W W W W W W Z Z Z X X Z X X Z X X Z X X X Z X	= 1849.86' L = 182.06 68'30'18" W 177.86' 43'49'51" W 95.82' 21'29'42" W 17.83' 69'33'20" W 397.89' 20'26'17" W 11.64' 69'33'43" W 50.00' 82'55'33" W 64.90' 69'33'43" W 64.10' 25'20'15" W 234.73' 48'47'35" W 100.49' 32'48'09" W 268.48' 23'46'42" W 178.90' 66'28'32" W 139.84' 83'40'30" W 122.00' 17'37'52"W 135.00' 12'23'33" E 63.00 70'26'39" W 8.31' 24'32'46" E 65.25' 47'38'56" W 33.37' 48'15'47" E 43.30' 58'47'51" E 58.27' 66'23'51" E 60.58' 64'35'07" E 92.46' 09'21'01" E 282.64' 56'47'10" W 48.24' 24'14'32" W 30.51' 30'39'49" W 62.61' 35'31'15" E 98.54'
25 26 27 28 29	535487.1860 535526.8661 535805.7487 535832.1736 535859.9892	1353448.7209 1353532.2316 1353578.1517 1353618.5119 1353631.0374	ZZSSZZ	64°35'07" E 92.46' 09°21'01" E 282.64' 56°47'10" W 48.24' 24°14'32" W 30.51' 30°39'49" W 62.61'
32 33 34 35 36 37	536016.5871 536233.2914 535997.5069	1353651.8073 1353791.4766 1354214.0489 1354265.6326 1354749.8638	ZZSSSZS	32'48'09" E 257.81' 60'50'23" E 483.90' 59'15'25" E 60.05' 59'15'25" E 563.41' 23'41'43" E 329.35' 35'28'26" W 66.69'

(A) SFD acreage includes Common Open Areas (COA Lots). (B) Overall allowed density based on maximum number of units allowed per ZB 979 M and Max. Allowed Land Use Acreages.

69.5

12.35

- (C) Max. density for any individual SFD area is 5.0 units/acre. (D) Max. density for an individual OR area is 20.0 units/acre.
- (E) Proposed density tabulations are shown for informational purposes only. The proposed density tabs are based on proposed land use acreages. Those tabulations will be reconciled against the maximum density tabs with the last plat/phase.

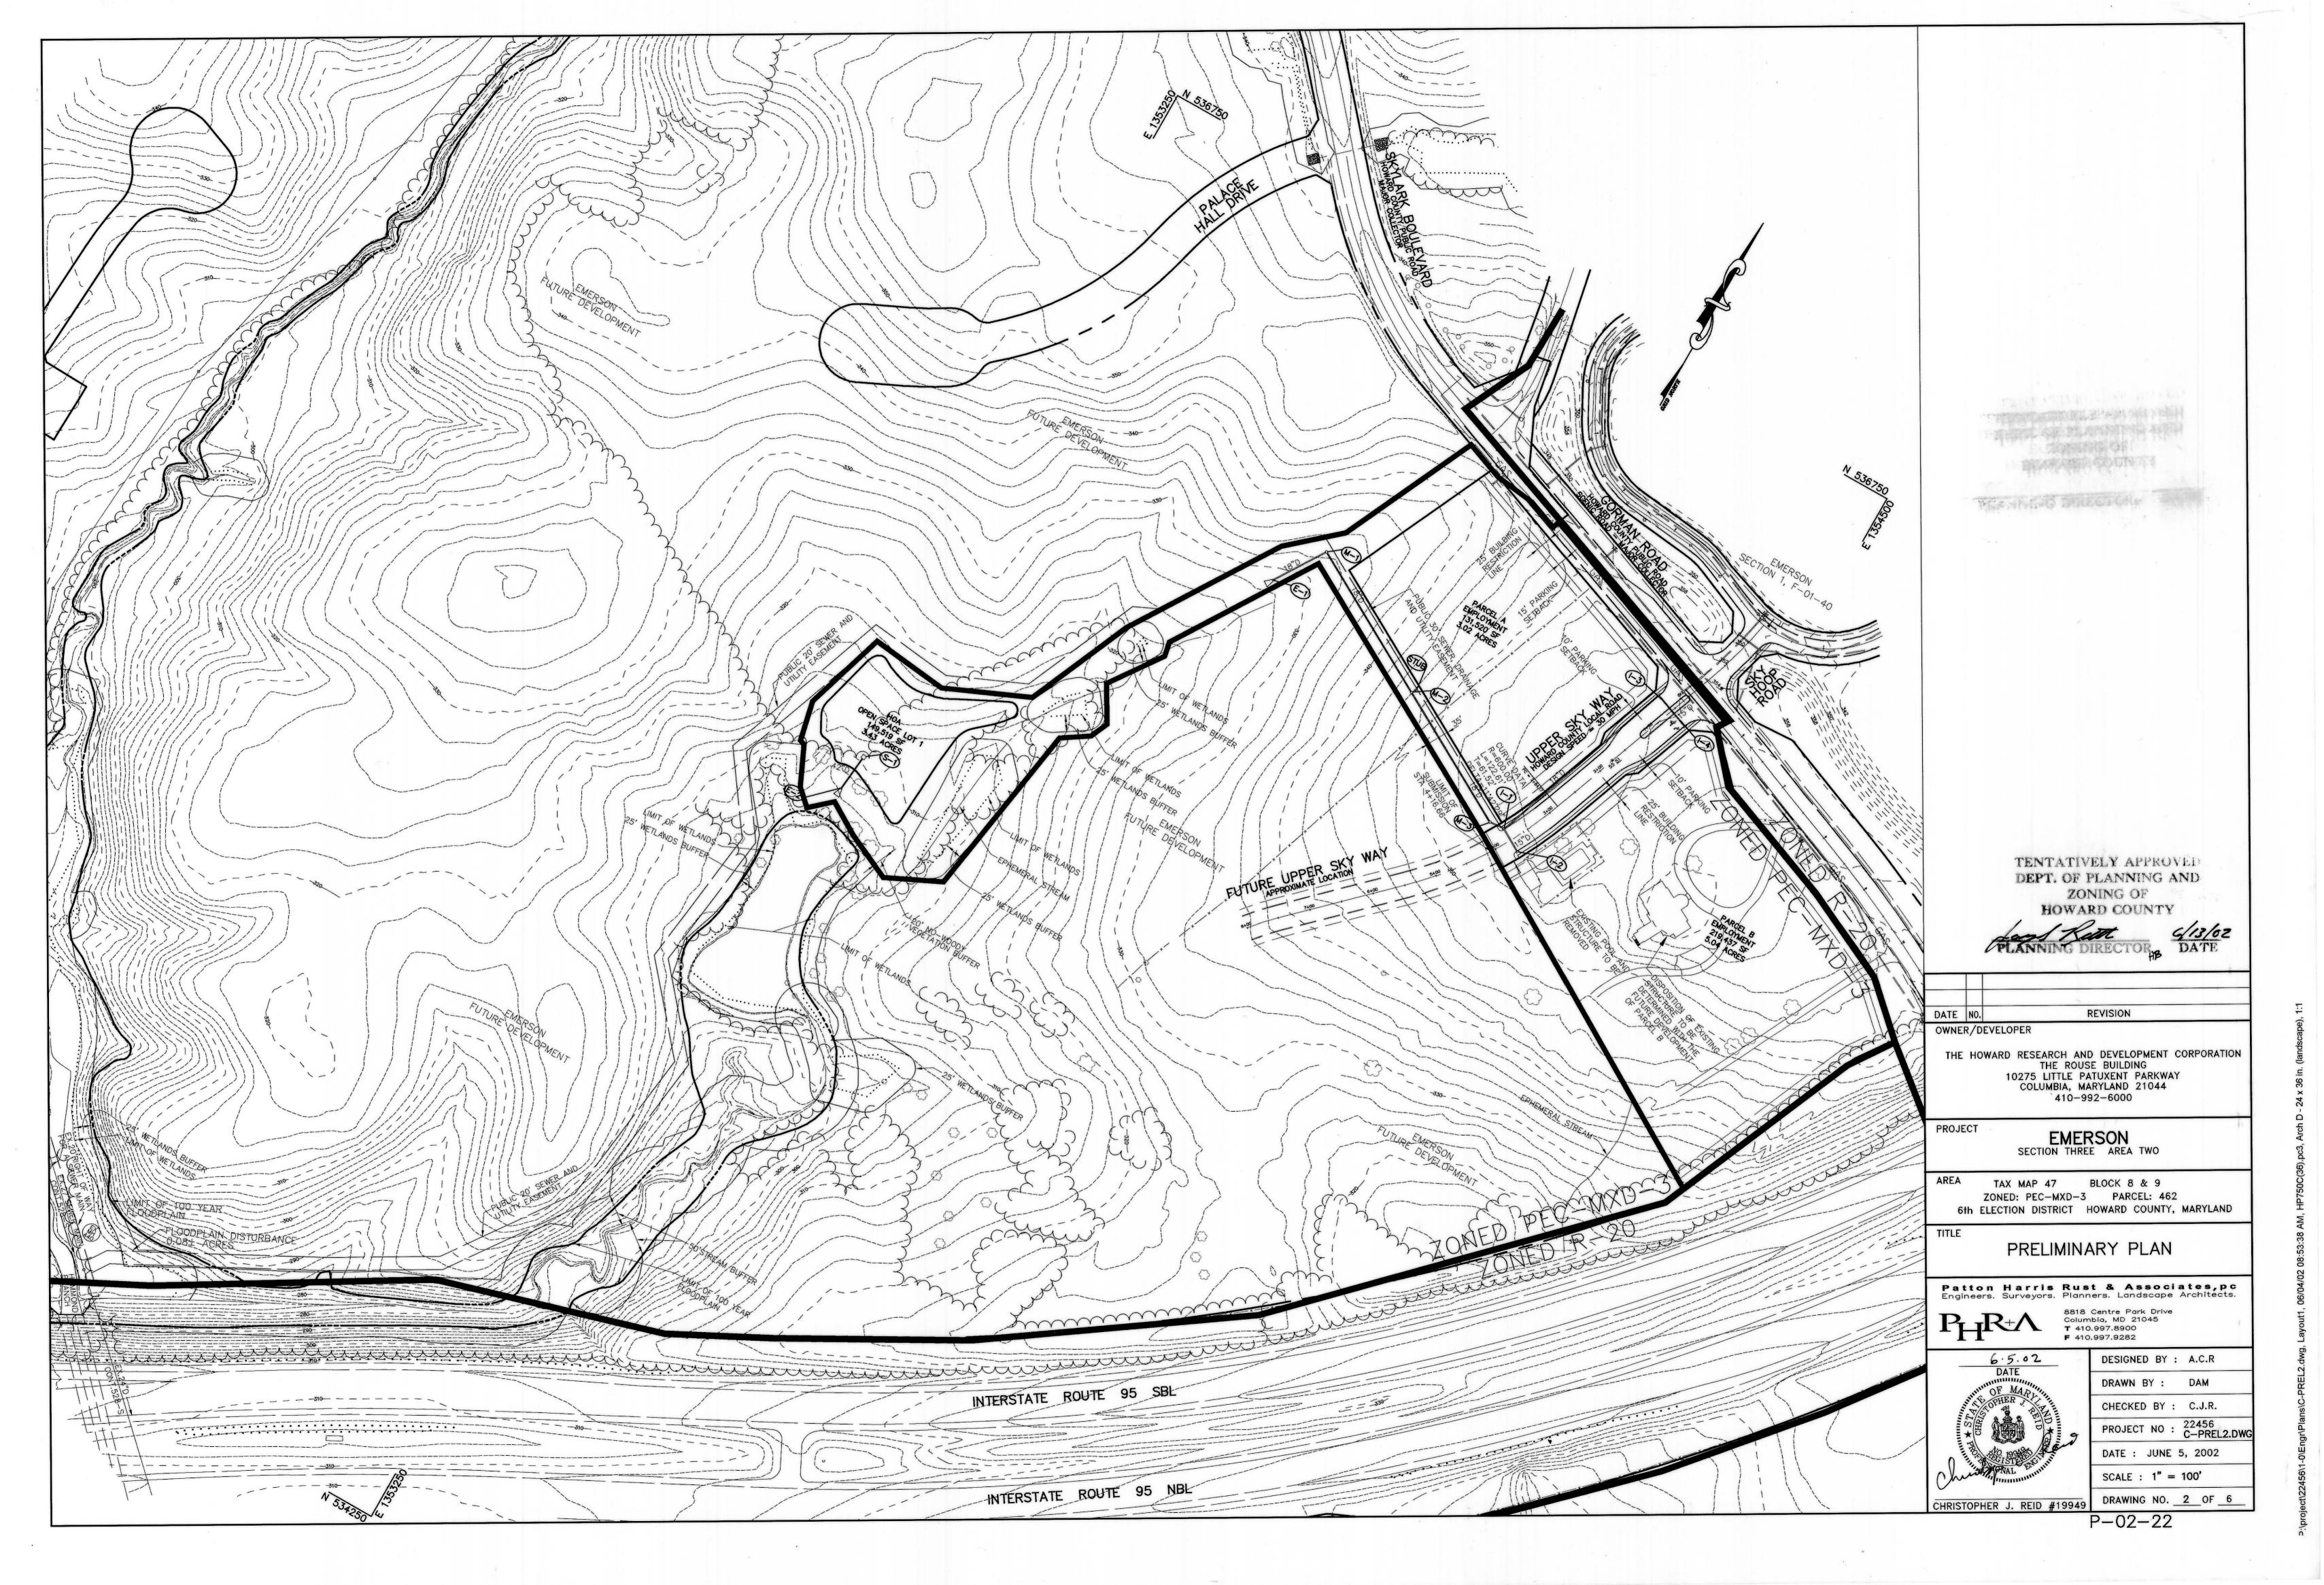



-0\EngthPlans\C-PRFI 3 dwg 1 avout1 06/04/02 08:55:00 AM. HP750C(36).pc3, Arch D - 24 x 36 in. (landscape), 1:1

SCHEDULE D - STORMWATER MANAGEMENT AREA LANI	DSCAPING
S.W.M. POND PERIMETER	1
LANDSCAPE TYPE	В
LINEAR FEET OF TOTAL PERIMETER	±2,0001
CREDIT FOR EX. VEGETATION (NO OR YES \$ %)	YES, 15%
CREDIT FOR OTHER PROP. LANDSCAPING (NO OR YES # %)	NO
LINEAR FEET OF REMAINING PERIMETER	±1,700
NUMBER OF TREES REQUIRED: SHADE TREES EVERGREEN TREES	34 43
NUMBER OF PLANTS PROVIDED SHADE TREES EVERGREEN TREES OTHER TREES (2:1 SUBSTITUTION, 50% MAX.)	34 43 0

STREET TR	EE CALCU	LATIONS
ROAD P	380'/40	10 LARGE TREES
TOTAL TREES REQU	JIRED	10 LARGE TREES
TOTAL TREES PROV	/I DED	10 LARGE TREES

	ADJACE1 ROADM		
PERIMETER	1	2	3
LANDSCAPE TYPE	E	E	* *
LINEAR FEET OF ROADWAY FRONTAGE/ PERIMETER	1,120'±	395'±	563'±
CREDIT FOR EXISTING DRIVE AISLE (LINEAR FEET)	YES 38' ±	NO	NO
CREDIT FOR EXISTING VEGETATION (YES, NO, LINEAR FEET) (DESCRIBE BELOW IF NEEDED)	NO 0'	NO 0'	NO
LINEAR FEET REMAINING	1,082'±	395 ' ±	0'
CREDIT FOR WALL, FENCE, OR BERM (YES/NO/LINEAR FEET)	NO -	NO -	NO -
NUMBER OF PLANTS REQUIRED SHADE TREES EVERGREEN TREES SHRUBS	27* 0 271*	10 0 99	000
NUMBER OF PLANTS PROVIDED SHADE TREES EVERGREEN TREES SMALL FLOWERING TREES SHRUBS	0* 000*	O* O O*	0000

SCHEDULE A NOTES: *PERIMETER 1 & 2: LANDSCAPE PLANT MATERIAL DEFERRED UNTIL SITE DEVELOPMENT PLAN FOR PARCELS A & B. ** NO LANDSCAPING REQUIRED BETWEEN PARCELS WITHIN THE SAME DEVELOPMENT.

GENERAL NOTES:

AND PROGRAMS.

NURSERYMEN.

MANUAL.

1. THIS PLAN HAS BEEN PREPARED IN ACCORDANCE WITH THE PROVISIONS OF SECTION 16.124 OF THE HOWARD COUNTY CODE AND THE LANDSCAPE MANUAL.

DEVELOPER'S AGREEMENT IN THE AMOUNT OF \$16,650.

3. THIS PLAN IS FOR LANDSCAPING PURPOSES ONLY.

SEQUENCES, PROCEDURES, AND SAFETY PRECAUTIONS

5. ALL MATERIAL SELECTED SHALL BE EQUAL TO OR

ACCORDANCE WITH THE MINIMUM STANDARDS CITED IN THE LATEST EDITION OF "LANDSCAPE SPECIFICATION

7. AT THE TIME OF INSTALLMENT, ALL SHRUBS AND OTHER PLANTINGS SHALL BE OF THE PROPER HEIGHT AND/OR SPREAD REQUIREMENTS IN ACCORDANCE WITH

8. NO SUBSTITUTIONS OR RELOCATION OF PLANTS MAY BE MADE WITHOUT PRIOR APPROVAL FROM THE

DEPARTMENT OF PLANNING AND ZONING OF HOWARD

COUNTY. ANY DEVIATION FROM THIS LANDSCAPE

DEVELOPMENT PLAN(S) AND/OR DENIAL IN THE

RELEASE OF LANDSCAPE SURETY.

PLAN MAY RESULT IN A REQUIREMENT FOR SUBMITTAL

OF AN OFFICIAL "REDLINE REVISION" TO THE SITE

THIS PLAN AND THE HOWARD COUNTY LANDSCAPE

4. CONTRACTOR IS SOLELY RESPONSIBLE FOR CONSTRUCTION MEANS, METHODS, TECHNIQUES,

BETTER THAN THE REQUIREMENTS OF THE "USA STANDARD FOR NURSERY STOCK", LATEST EDITION, AS PUBLISHED BY THE AMERICAN ASSOCIATION OF

6. ALL MATERIAL SHALL BE PLANTED IN

GUIDELINES" PUBLISHED BY THE LANDSCAPE

CONTRACTORS ASSOCIATION.

2. FINANCIAL SURETY FOR THE REQUIRED LANDSCAPING MUST BE POSTED AS PART OF THE

34 SHADE TREES @ \$300 = \$10,200 43 EVERGREEN TREES @ \$150 = \$6,450

Dafit McCune Walker, Inc. A Teamof Land Planners, 200 East Pennsylvania Avenue Towson, Maryland 21286 (410) 296-3333 Fax 296-4705

Landscape Architects, Golf Course Architects, Engineers, Surveyors & Environmental Professionals

DATE NO. REVISION OWNER/DEVELOPER

THE HOWARD RESEARCH AND DEVELOPMENT CORPORATION THE ROUSE BUILDING 10275 LITTLE PATUXENT PARKWAY COLUMBIA, MARYLAND 21044 410-992-6000

PROJECT

EMERSON SECTION THREE AREA TWO

TAX MAP 47 BLOCK 8 & 9 ZONED: PEC-MXD-3 PARCEL: 462 6th ELECTION DISTRICT HOWARD COUNTY, MARYLAND

PRELIMINARY NOTES AND TABULATIONS

Patton Harris Rust & Associates, pc Engineers. Surveyors. Planners. Landscape Architects.

8818 Centre Park Drive

PROJECT NO: DATE: JUNE 5, 2002

* The gross site area includes 1.07 acres of land outside the phase limit, for a sewer and utility easement. The easement also includes 0.08 acre of floodplain. When the easement area is platted with a future phase, the acreage will be excluded from the Worksheet since it is already addressed on this plan.

ACRES (1/100)

46.04

51.84

46.04

51.84

46.04

0.00

11.51

11.51

16.10

0.00 ACRES

5.03 ACRES

5.03 ACRES

COMMERCIAL/INDUSTRIAL/OFFICE

264.81 * 26.57 *

FOREST CONSERVATION CALCULATIONS

AREA WITHIN AGRICULTURAL USE OR PRESERVATION PARCEL (IF APPLICABLE)

BASIC SITE DATA

NET TRACT AREA

LAND USE CATEGORY

A. NET TRACT AREA

A. NET TRACT AREA

AREA WITHIN 100 YEAR FLOODPLAIN

INFORMATION FOR CALCULATIONS

E. FOREST AREAS TO BE CLEARED F. FOREST AREAS TO BE RETAINED

REFORESTATION CALCULATIONS

REFORESTATION THRESHOLD (15% x A)
AFFORESTATION MINIMUM (15% x A)

EXISTING FOREST ON NET TRACT AREA

REFORESTATION THRESHOLD (15% x A) EXISTING FOREST ON NET TRACT AREA

FOREST AREAS CLEARED ABOVE REFORESTATION THRESHOLD G. FOREST AREAS CLEARED BELOW REFORESTATION THRESHOLD H. FOREST AREAS RETAINED ABOVE REFORESTATION THRESHOLD

(IF E IS GREATER THAN B), THE FOLLOWING CALCULATIONS APPLY:

IF FOREST AREAS TO BE RETAINED ARE GREATER THAN THE REFORESTATION THRESHOLD

FOREST AREAS TO BE CLEARED

FOREST AREAS TO BE RETAINED

CLEARING ABOVE THE THRESHOLD ONLY

TOTAL REFORESTATION REQUIRED

(Fx1/4) + (Gx2)

REFORESTATION REQUIRED

REFORESTATION PROVIDED

REFORESTATION FOR CLEARING ABOVE THRESHOLD

REFORESTATION FOR CLEARING BELOW THRESHOLD

CREDIT FOR RETENTION ABOVE CONSERVATION THRESHOLD

FOREST CONSERVATION TRACKING CHART

Section/ Phase No.	Gross Area	Floodplain Area	Net Tract Area	Ex. Forest Area	Forest * Cleared	Forest Retained	Refor./Affor. Required	Refor./Affor. Provided	Excess Refor./Affor.	Future For. Clearing	Future Refor./Affor.	Comments
2/1A&1B	106.20	3.50	102.70	24.70	7.93	16.77	0.61	5.03	4.42	4.48	3.41	
2/2	118.90	3.50	115.40	24.80	8.03	16.77	2.95	5.03	2.08	4.48	3.41	Washin
2/3	137.35	4.00	133.35	34.40	12.53	21.87	1.27	5.03	3.76	4.48	3.91	
3/1	206.85	21.19	185.66	85.30	39.35	45.95	0.00	5.03	5.03	4.48	3.91	Diller II
2/4	251.39	26.49	224.90	95.68	43.84	51.84	0.00	5.03	5.03	4.48	3.91	
3/2	264.81	26.57	238.24	97.88	46.04	51.84	0.00	5.03	5.03	4.48	3.91	
		-				Name of the last o						
											530	

THE TABULATIONS SHOWN ABOVE FOR EACH PHASE WILL REFLECT CUMULATIVE TOTALS FOR THIS PHASE AND ALL

* THE FOREST CLEARED INCLUDES THE ACREAGE OF POSSIBLE FUTURE FOREST CLEARING.

TENTATIVELY APPROVED DEPT. OF PLANNING AND ZONING OF HOWARD COUNTY

CHRISTOPHER J. REID #19949

P-02-22

T 410.997.8900 DESIGNED BY : A.C.R

SCALE : NOT TO SCALE DRAWING NO. _ 5 OF _ 6

DRAWN BY: DAM

CHECKED BY : C.J.R.

22456 C-PREL5.DWG

