# HOLIDAY HILLS **RIVERSIDE ESTATES JOHNS** HOPKINS UNIVERSITY **LABORATORY** ÁDC MAP/GRID NO: MAP 32, GRID C

### **VICINITY MAP** SCALE: 1"=2000

	Sheet Index								
Sheet Number	Sheet Title	Sheet Name							
01	G-001	COVER SHEET							
02	C-201	ENVIRONMENTAL CONCEPT PLAN I							
03	C-202	ENVIRONMENTAL CONCEPT PLAN II							
04	C-601	EROSION SEDIMENT CONTROL PLAN I							
05	C-602	EROSION SEDIMENT CONTROL PLAN II							

	ADDRESS CHART	
LOT/PARCEL#	STREET ADDRESS	
1/123	11100 JOHNS HOPKINS ROAD	

PERMIT INFORMATION CHART									
SUBDIVISION NAME			SECTION/AREA	<del>lyglimiteritin an inchi ili supra il merca il 1</del>	LOT/PARCE	L NO.			
	N/A		N/A		1/	/123			
PLAT # or L/F.	GRID#	ZONING	TAX MAP NO.	ELECT DISTI	STRICT	CENSUS TRACT			
18968	16	PEC	41	5		605102			
WATER CODE			SEWER CODE						
	E21			6480	0000				

### SITE ANALYSIS DATA SHEET

ENVIRONMENT	AL AREAS	SITE AREAS					
WETLANDS	NONE	TOTAL PROJECT AREA	357.976 acres				
FLOODPLAIN	NONE	LOD AREA	2.28 acres				
FORESTS	NONE	PROPOSED SITE USE	LIGHT INDUSTRIAL				
STEEP SLOPES	0 acres	GREEN OPEN AREA	0.70 acres				
ERODIBLE SOILS	0 acres	IMPERVIOUS AREA	1.58 acres				

\*IMPERVIOUS AREA INCLUDES AREAS OF UTILITY TRENCHING.

NOTE: INFORMATION IS FOR WORK IN THE PROPOSED LOD ONLY. HIGHLY ERODIBLE SOILS CRITERIA ARE: SLOPE > 15% OR K-FACTOR = Kw-FACTOR > 0.35 WITH SLOPES >

### SITE ANALYSIS DATA CHART

TOTAL PROJECT AREA: 357.976 AC. AREA OF PLAN SUBMISSION: 2.69 AC LIMIT OF DISTURBANCE: 2.28 AC. PRESENT ZONING: PEC PROPOSED USE: LIGHT INDUSTRIAL USES

EXISTING NUMBER OF JHU/APL EMPLOYEES: 4,600 EXISTING MAXIMUM NUMBER OF PARKING SPACES REQUIRED BY ZONING: EXISTING ONSITE PARKING SPACES: 4,798 (SDP 05-133)

PROPOSED ONSITE PARKING SPACES: 4,786

PROPOSED ASSIGNABLE OFFICE SPACE: 0 GSF NO ADDITIONAL JHU/APL EMPLOYEES ARE PROPOSED AS PART OF THIS PROPOSED BUILDING GROSS FT<sup>2</sup>: 2,525 GSF

EXISTING OPEN SPACE AREA: 278.89 ACRES (77.9% OF TOTAL LOT AREA)

PROPOSED OPEN SPACE AREA: 279.22 ACRES (78.0% OF TOTAL LOT AREA)

NATURAL STEEP SLOPES (>15%) = 0.03 ACRES

HIGHLY ERODIBLE SOILS = 0.00 ACRES

CASE NUMBERS APPLICABLE: F-02-40, SDP-02-140

SANITARY SEWER / WATER SERVICE: PRIVATE ONSITE SYSTEM, PUBLIC CONNECTION


**EXISTING TOTAL BUILDING COVERAGE:** 25.57 ACRES (7.1%)

PROPOSED BUILDING COVERAGE: 0.05 ACRES (2,525 ft<sup>2</sup>)

TOTAL PROPOSED BUILDING COVERAGE: 25.62 ACRES (7.2%)

NO FLOODPLAINS OR FOREST CONSERVATION EASEMENTS PRESENT WITHIN THE LIMITS OF

# JOHNS HOPKINS UNIVERSITY APPLIED PHYSICS LABORATORY GATE 4 IMPROVEMENTS ECP SUBMISSION

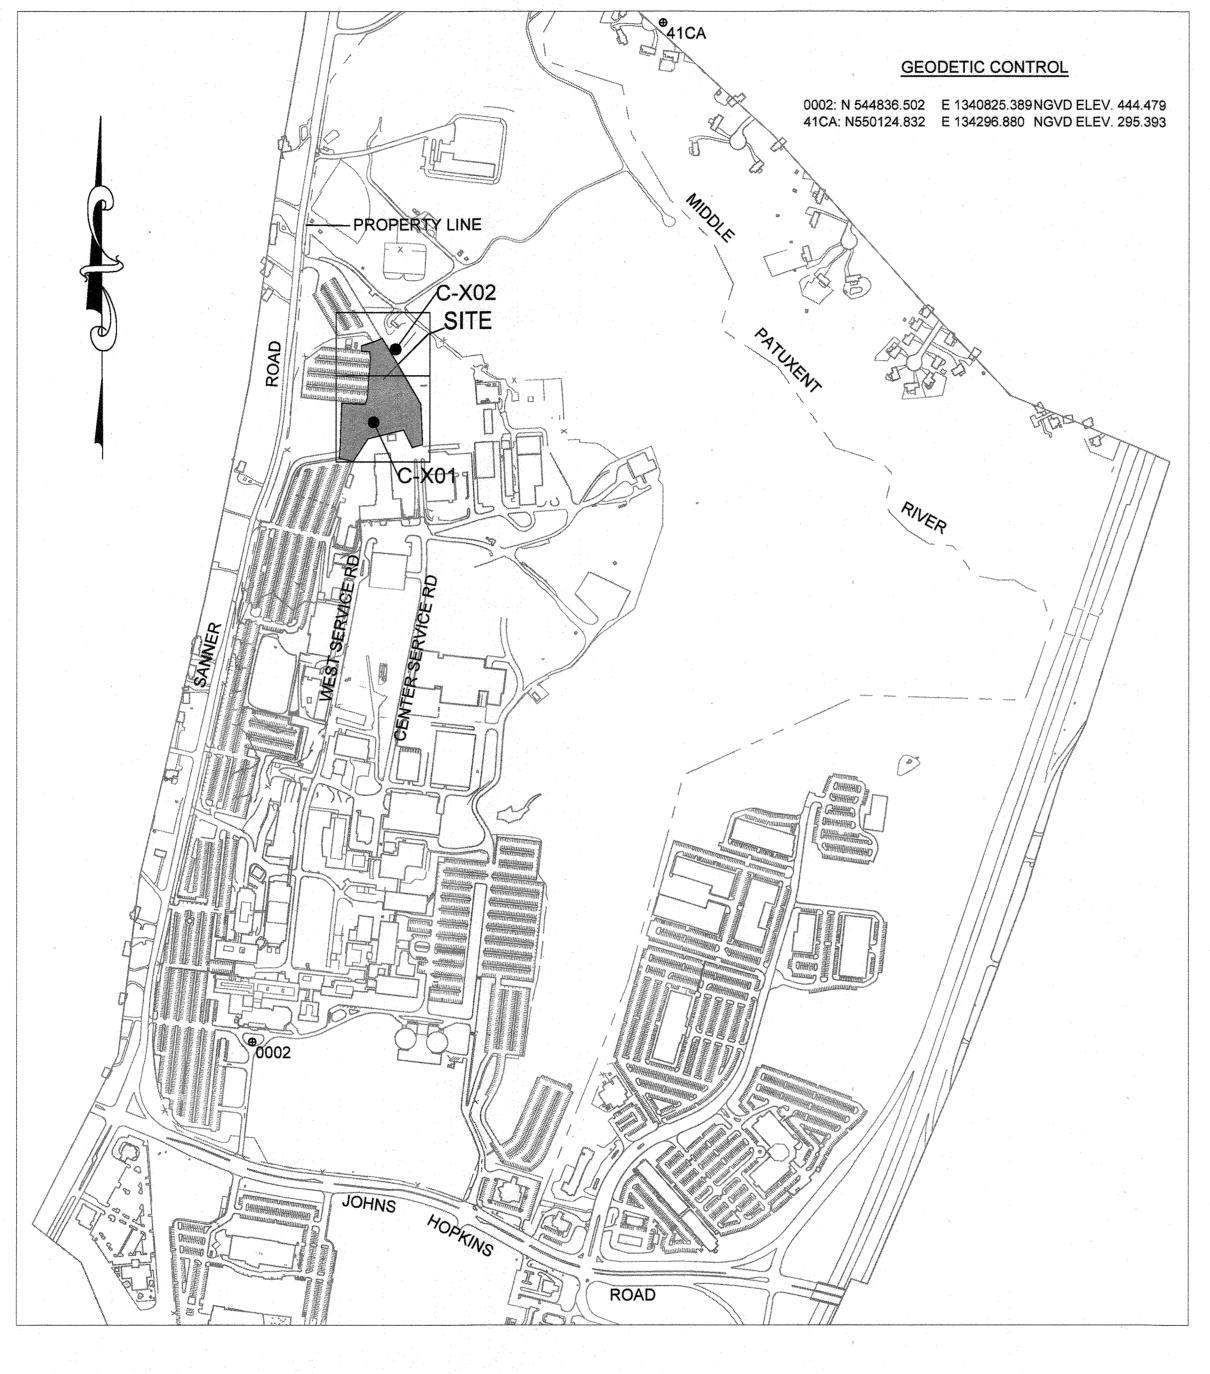

CAMPUS SITE PLAN

### **NARRATIVE**

THE GATE 4 SITE WILL INCLUDE A 2,525 SQUARE FOOT BUILDING WITH CONCRETE UTILITY PADS AND SURROUNDING GRAVEL. THE SITE DRAINS TOWARD EXISTING BASINS B AND G ON THE JHU-APL CAMPUS. THIS PROJECT IS LOCATED WITHIN THE PATUXENT RIVER WATERSHED. NEITHER FOREST CONVERSATION EASEMENTS NOR FLOODPLAINS EXIST WITHIN THE PROJECT LIMITS

TO ACHIEVE STORMWATER MANAGEMENT REQUIREMENTS REQUIRED BY THE MARYLAND DEPARTMENT OF THE ENVIRONMENT (MDE) AND HOWARD

STORMWATER MANAGEMENT REQUIREMENTS WILL BE ACHIEVED WITH THREE FOCAL POINT FACILITIES. THE FOCAL POINT FACILITY IS LISTED AS AN ACCEPTABLE PRACTICE BY HOWARD COUNTY AND MDE. QUANTITY CONTROL REQUIREMENTS ARE MET THROUGH THE REDUCTION OF CONTRIBUTING IMPERVIOUS AREA AND FLOW RATES TO BASINS B AND G IN THE PROPOSED CONDITION FROM THE EXISTING CONDITION. THROUGH THE USE OF THESE STORMWATER MANAGEMENT DEVICES, ESD TO THE MEP IS ACHEIVED.

### PURPOSE STATEMENT

THE PURPOSE OF THESE PLANS IS TO PROVIDE INFORMATION ON EXISTING SITE CONDITIONS AND PROPOSED IMPROVEMENTS FOR A 2,525 GSF GUARD CENTER **BUILDING AND SECURITY INFRASTRUCTURE** 

### **GENERAL NOTES**

- THE SUBJECT PROPERTY ZONED PEC (PLANNED EMPLOYMENT CENTER) PER THE OCTOBER 6, 2013 COMPREHENSIVE ZONING PLAN.
- COORDINATES, BEARINGS AND DISTANCES SHOWN HEREON ARE REFERRED TO THE MARYLAND COORDINATE SYSTEM (NAD83/2011). ELEVATIONS SHOWN HEREON ARE REFERRED TO THE NAVD88 DATUM.
- TOPOGRAPHIC, SURFACE, AND UTILITY INFORMATION SHOWN WAS OBTAINED FROM FIELD SURVEY BY ACCURATE INFRASTRUCTURE DATA, INC.,
- NO CEMETERIES EXIST ON THIS SITE BASED ON A SITE VISIT AND ON AN EXAMINATION OF THE HOWARD COUNTY CEMETERY INVENTORY MAP
- NO HISTORIC STRUCTURES EXIST ON THE SUBJECT PROPERTY
- THERE ARE NO EXISTING DWELLINGS ON THIS SITE.
- PREVIOUS DEPARTMENT OF PLANNING AND ZONING FILE NUMBERS

SDP-04-76: SERVICES AREA COMPLEX F-02-40: SWM BASIN 'A', APFO, FOREST CONSERVATION SDP-05-042: JHU/LIBRARIES SERVICES CENTER (FOREST CONSERVATION & WETLANDS UPDATES) SDP-03-043: SANNER ROAD IMPROVEMENTS (NEW AFPO NUMBER: 4,600) F-04-188: FOREST CONSERVATION EASEMENTS RE-PLAT

F-07-035: FOREST CONSERVATION, RE-PLAT EASEMENT

SDP-08-084: SERVICES AND SUPPORT AREA INFRASTRUCTURE FACILITY PHASE I F-02-077: FINAL PLAN STORMWATER MANAGEMENT FACILITIES DRAINAGE AREA B AS-BUILT SDP-04-035: STORMWATER MANAGEMENT BASIN G AS-BUILT

- THIS PLAN HAS BEEN PREPARED IN ACCORDANCE WITH THE PROVISIONS OF SECTION 16.124 OF THE HOWARD COUNTY CODE AND LANDSCAPE
- THE PROPERTY IS LOCATED WITHIN THE METROPOLITAN DISTRICT
- EXISTING WATER WITHIN THE PROPERTY BOUNDARIES IS PRIVATE. EXISTING SEWER WITHIN THE PROPERTY BOUNDARIES IS PRIVATE.
- SOILS INFORMATION TAKEN FROM NRCS WEB SOIL SURVEY DATED OCTOBER 13, 2023.
- 13. STORMWATER MANAGEMENT WILL BE PROVIDED IN ACCORDANCE WITH THE 2010 MDE, CHAPTER 5 REGULATIONS (ESD TO MEP) AND THE LATEST HOWARD COUNTY DESIGN MANUAL, VOL. 1, CHAPTER 5, ADOPTED ON OR ABOUT OCTOBER 7, 2019. ALL FACILITIES WILL BE PRIVATELY OWNED AND MAINTAINED BY JOHNS HOPKINS UNIVERSITY
- 14. THIS PROJECT COMPLIES WITH THE REQUIREMENTS OF SECTION 16.1200 OF THE HOWARD COUNTY CODE FOR FOREST CONSERVATION BY F-02-40, F-04-188 AND F-07-035 FOREST CONSERVATION OBLIGATION WAS FULFILLED UNDER F-04-188 AND F-07-035
- HEALTH DEPARTMENT APPROVAL OF THIS DEVELOPMENT PLAN DOES NOT ENSURE APPROVAL OF BUILDING PERMIT APPLICATIONS ASSOCIATED WITH THIS PLAN. PLANS FOR CERTAIN FACILITIES TO BE CONSTRUCTED WITHIN THE LIMITS DESCRIBED BY THIS PLAN WILL REQUIRE REVIEW AND APPROVAL BY THE HEALTH DEPARTMENT. SUCH FACILITIES MAY INCLUDE, BUT ARE NOT LIMITED TO, THOSE WHICH HAVE SWIMMING POOLS, OR THAT SELL PREPARED OR PACKAGED FOODS, OR THAT MAY HAVE EQUIPMENT THAT EMITS RADIATION.
- NO WORK IS PROPOSED IN THE COUNTY RIGHT-OF-WAY. ALL PROPOSED WORK IS INTERIOR TO THE SITE.
- 17. ALL CONSTRUCTION SHALL BE IN ACCORDANCE WITH THE LATEST STANDARDS AND SPECIFICATIONS OF HOWARD COUNTY PLUS MD-SHA STANDARDS
- 18. THE CONTRACTOR SHALL NOTIFY THE DEPARTMENT OF PUBLIC WORKS/BUREAU OF ENGINEERING/CONSTRUCTION INSPECTION DIVISION AT 410-313-1880 AT LEAST (5) WORKING DAYS PRIOR TO START OF WORK.
- THE CONTRACTOR SHALL NOTIFY "MISS UTILITY" AT 1-800-257-7777 AT LEAST FIVE DAYS PRIOR TO ANY EXCAVATION WORK.
- 20. ALL PLAN DIMENSIONS ARE TO FACE OF CURB UNLESS OTHERWISE NOTED.
- 21. THERE ARE NO FLOODPLAIN, WETLANDS, OR STREAMS WITHIN THE PROJECT BOUNDARY AREA
- 22. STEEP SLOPES (GREATER THAN 15%) EXIST ON SITE; SEE SITE ANALYSIS DATA SHEET.
- 23. TRASH PICK UP WILL BE PRIVATELY MAINTAINED.
- NO OFF-SITE ACTIVITIES ARE PROPOSED FOR THIS PROJECT.
- THE SITE IS NOT IN THE AIRPORT ZONE.
- 26. THE CONTRACTOR IS REQUIRED TO OBTAIN ALL NECESSARY PERMITS AND INSPECTIONS.
- 27. ALL GRADING AND EXCAVATION SHALL BE PERFORMED IN ACCORDANCE WITH THE GEOTECHNICAL ENGINEER'S REPORT AND INSPECTED BY A
- 28. CONSTRUCTION OF SUBGRADE, UNDERDRAINS, AND PAVING SHALL BE INSPECTED AND APPROVED BY THE GEOTECHNICAL ENGINEER.
- EXISTING UTILITIES WHICH ARE NOT TO BE REMOVED OR ABANDONED SHALL REMAIN OPERATIONAL AT ALL TIMES. APPROPRIATE EXISTING UTILITIES SHALL REMAIN IN SERVICE UNTIL REPLACEMENT/RELOCATED UTILITIES ARE OPERATIONAL.
- 30. ALL DISTURBED AREAS NOT STABILIZED WITH STRUCTURES, PAVING, AND/OR PLANTINGS SHALL BE STABILIZED WITH FOUR INCHES OF TOPSOIL, SEED, MULCH AND WATERED TO ESTABLISH AN ADEQUATE GROWTH OF GRASS AS SPECIFIED ON THE EROSION AND SEDIMENT CONTROL PLANS.
- 31. NUMERICAL DIMENSIONS AND ELEVATIONS SHOWN SHALL SUPERSEDE ANY DISCREPANCY IN THE SCALING ON THE DRAWINGS.
- CONTRACTOR SHALL PROVIDE POSITIVE DRAINAGE AWAY FROM ALL EXISTING AND PROPOSED BUILDING ENTRANCES DURING ALL PHASES OF CONSTRUCTION, UNLESS OTHERWISE NOTED IN THESE DOCUMENTS. CONTRACTOR SHALL NOTIFY ENGINEER / OWNER IF EXISTING OR PROPOSED CONDITIONS RESTRICT ABILITY TO ACHIEVE POSITIVE DRAINAGE FROM BUILDINGS PRIOR TO THE START OF CONSTRUCTION.
- 33. PERIMETER LANDSCAPING IS NOT REQUIRED WITH THIS SDP BECAUSE THE PROPOSED BUILDING IS LOCATED INTERNAL TO THE SITE.
- 34. NO WAIVERS OR ALTERNATIVE COMPLIANCE ARE REQUESTED.
- APPROVAL OF THIS ECP DOES NOT CONSTITUTE AN APPROVAL OF ANY SUBSEQUENT AND ASSOCIATED SUBDIVISION PLAN, SITE DEVELOPMENT PLAN, OR GRADING OR BUILDING PERMIT PLAN. REVIEW OF THIS PROJECT FOR COMPLIANCE WITH THE HOWARD COUNTY SUBDIVISION AND LAND DEVELOPMENT REGULATIONS AND THE HOWARD COUNTY ZONING REGULATIONS SHALL OCCUR AT THE SUBDIVISION, SITE DEVELOPMENT PLAN, OR GRADING AND BUILDING PERMIT STAGES. THE APPLICANT AND CONSULTANT SHOULD EXPECT ADDITIONAL AND MORE DETAILED REVIEW COMMENTS AS THIS PROJECT PROGRESSES THROUGH THE PLAN REVIEW PROCESS.

APPROVED: DEPARTMENT OF PLANNING AND ZONING

Chief, Development Engineering Division

Chief, Division of Land Development

4.25.24 4/23/24

700 East Pratt Street, Suite 500 Baltimore, MD 21202

Contact: Matt Thomasson

PROFESSIONAL CERTIFICATION. I HEREBY CERTIFY THAT THESE DOCUMENT WERE PREPARED OR APPROVED BY ME, AND THAT I AM A DULY LICENSED PROFESSIONAL ENGINEER UNDER THE LAWS OF THE STATE OF MARYLAND,



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OWNER/DEVELOPER

JOHNS HOPKINS APPLIED PHYSICS LABORATORY 11100 JOHNS HOPKINS ROAD LAUREL. MARYLAND 20723

**COVER SHEET** 

JOHNS HOPKINS UNIVERSITY - APPLIED PHYSICS LABORATORY **B108 GATE4 IMPROVEMENTS PROJECT** 

> 11100 JOHNS HOPKINS ROAD TAX MAP: 41 PARCEL: 123 GRID: 16 ZONED: PEC ELECTION DISTRICT 5 - HOWARD COUNTY, MARYLAND

SHEET 01 OF 05


G-001

**RK&K PROJECT** 

NUMBER

SCALE:

As Shown

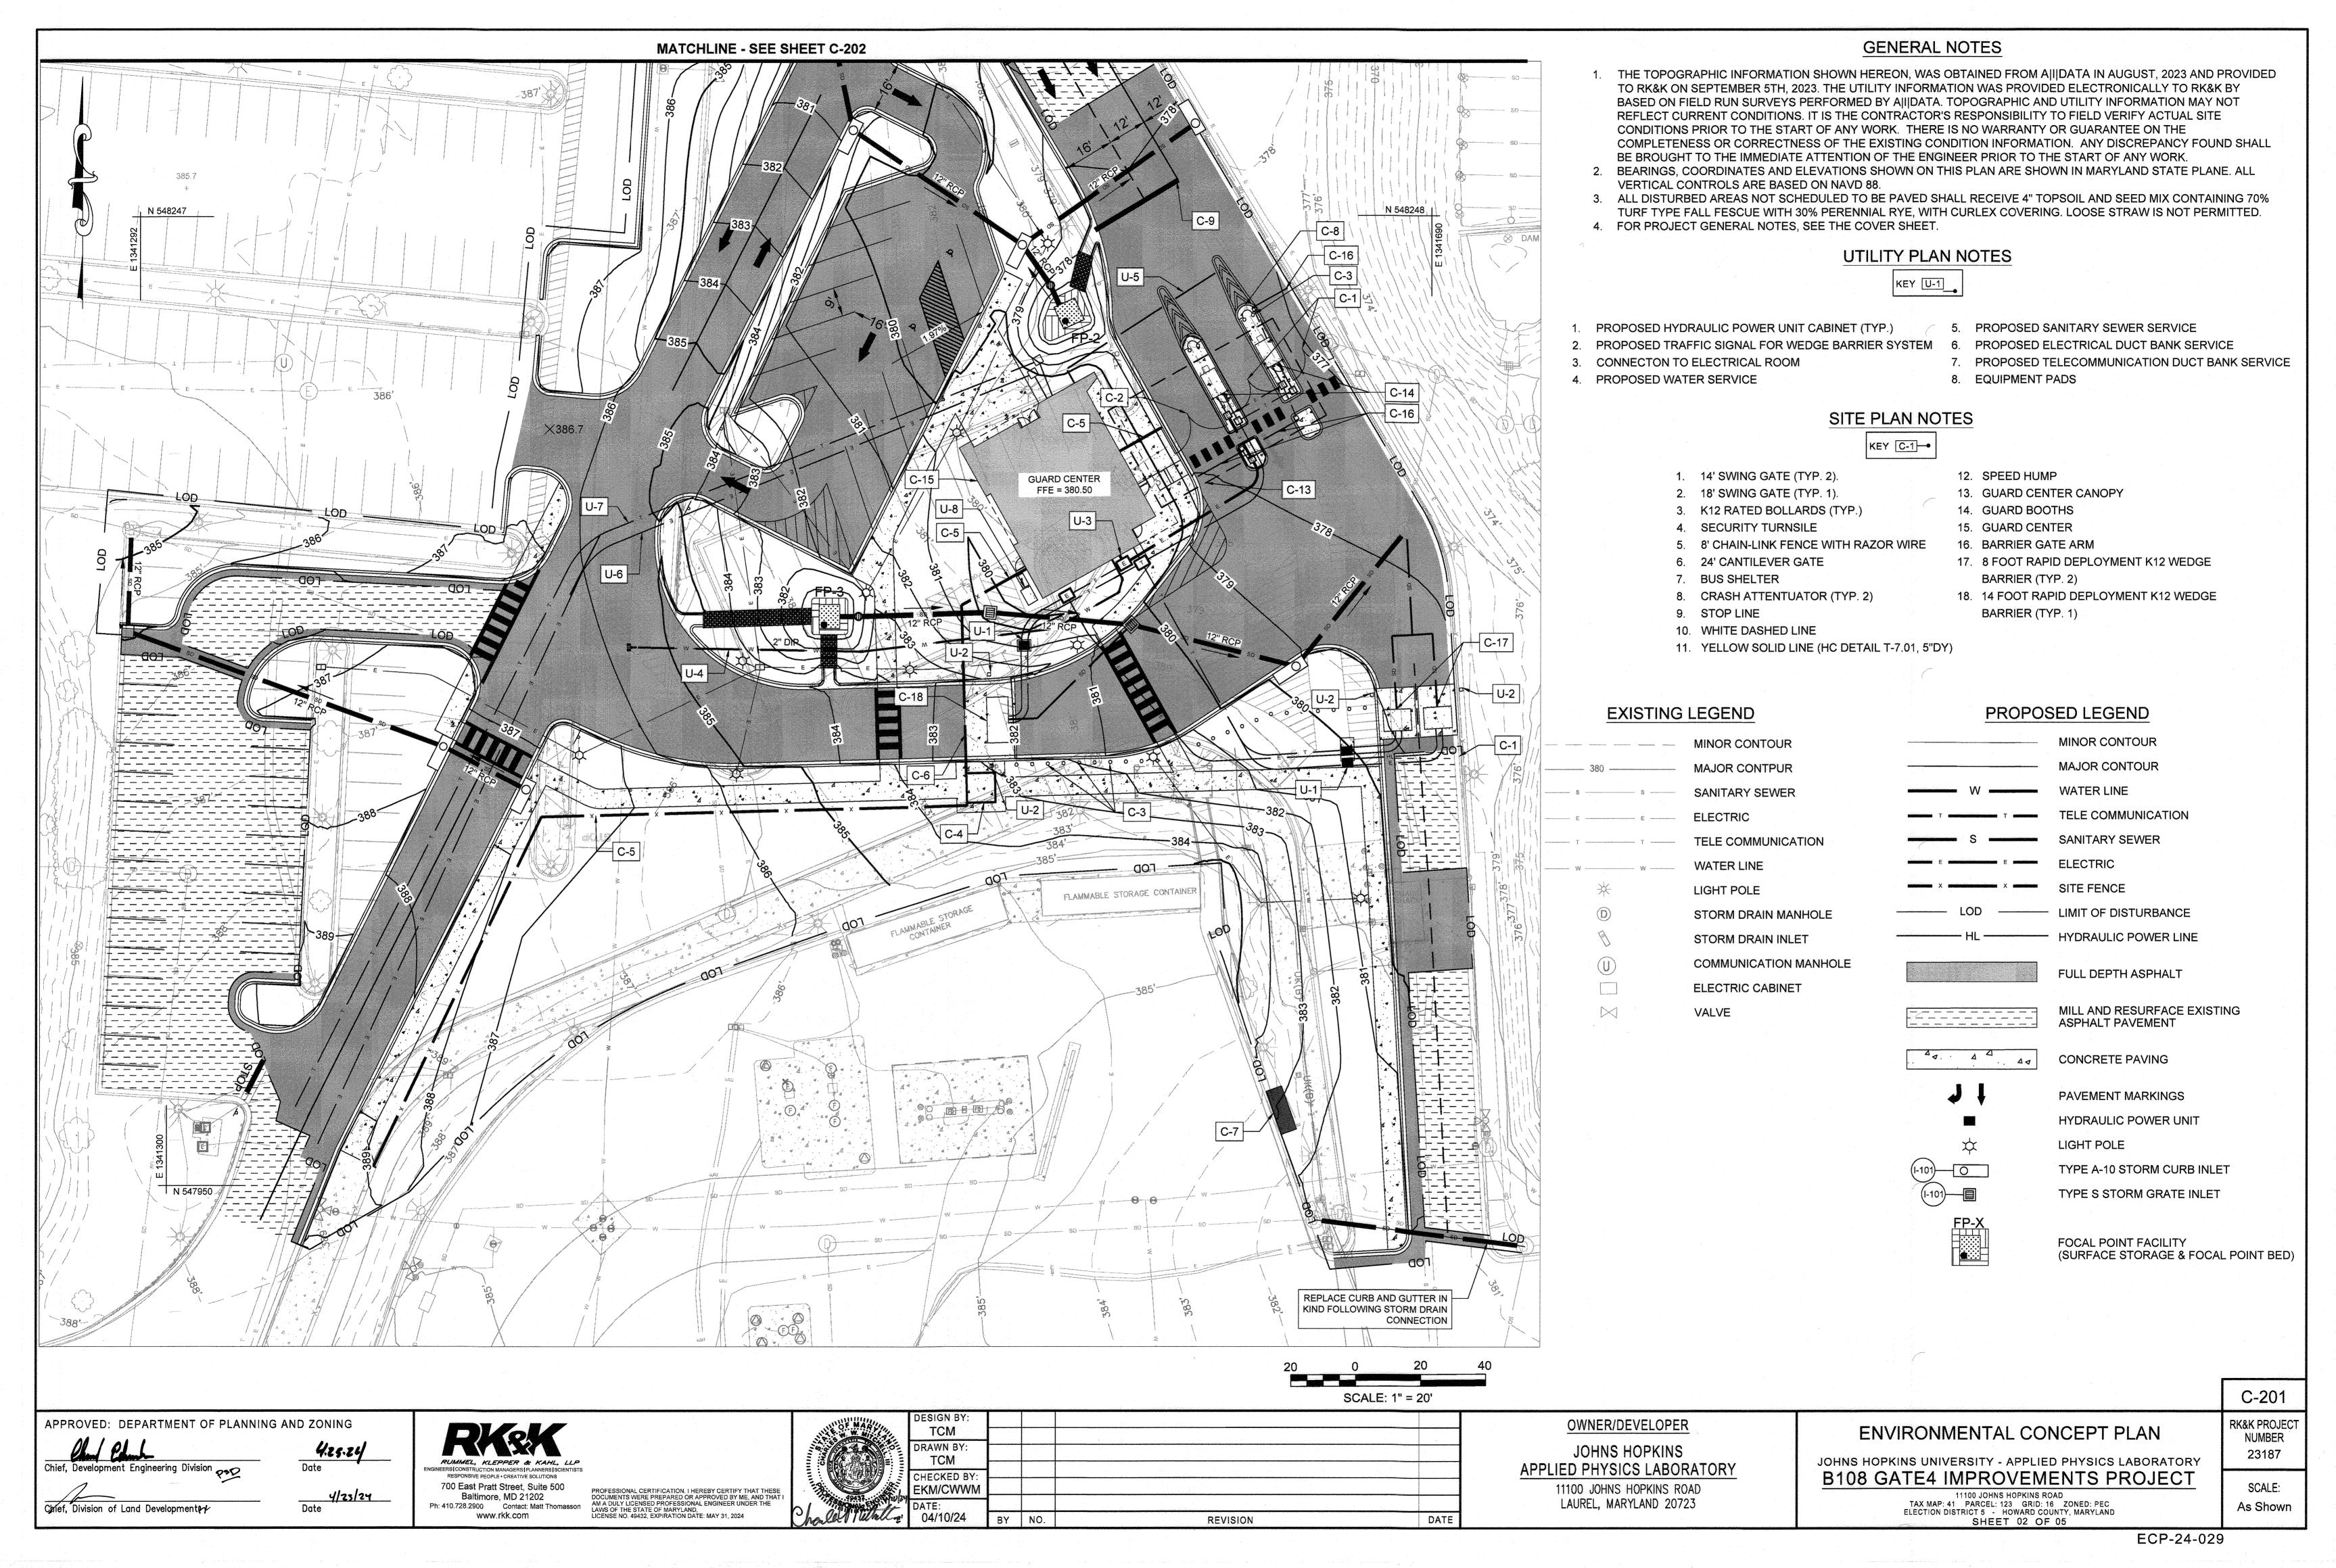

# N 548322 **MATCHLINE - SEE SHEET C-201**

# SCALE: 1" = 20'

DATE

REVISION

### **GENERAL NOTES**

- 1. THE TOPOGRAPHIC INFORMATION SHOWN HEREON, WAS OBTAINED FROM A|I|DATA IN AUGUST, 2023 AND PROVIDED TO RK&K ON SEPTEMBER 5TH, 2023. THE UTILITY INFORMATION WAS PROVIDED ELECTRONICALLY TO RK&K BY BASED ON FIELD RUN SURVEYS PERFORMED BY AJIJDATA. TOPOGRAPHIC AND UTILITY INFORMATION MAY NOT REFLECT CURRENT CONDITIONS. IT IS THE CONTRACTOR'S RESPONSIBILITY TO FIELD VERIFY ACTUAL SITE CONDITIONS PRIOR TO THE START OF ANY WORK. THERE IS NO WARRANTY OR GUARANTEE ON THE COMPLETENESS OR CORRECTNESS OF THE EXISTING CONDITION INFORMATION. ANY DISCREPANCY FOUND SHALL BE BROUGHT TO THE IMMEDIATE ATTENTION OF THE ENGINEER PRIOR TO THE START OF ANY WORK.
- 2. BEARINGS, COORDINATES AND ELEVATIONS SHOWN ON THIS PLAN ARE SHOWN IN MARYLAND STATE PLANE. ALL VERTICAL CONTROLS ARE BASED ON NAVD 88.
- 3. ALL DISTURBED AREAS NOT SCHEDULED TO BE PAVED SHALL RECEIVE 4" TOPSOIL AND SEED MIX CONTAINING 70% TURF TYPE FALL FESCUE WITH 30% PERENNIAL RYE, WITH CURLEX COVERING. LOOSE STRAW IS NOT PERMITTED.
- 4. FOR PROJECT GENERAL NOTES, SEE THE COVER SHEET.

## **UTILITY PLAN NOTES**

- PROPOSED HYDRAULIC POWER UNIT CABINET (TYP.)
- 2. PROPOSED TRAFFIC SIGNAL FOR WEDGE BARRIER SYSTEM
- 3. CONNECTON TO ELECTRICAL ROOM
- 4. PROPOSED WATER SERVICE

- 5. PROPOSED SANITARY SEWER SERVICE
- PROPOSED ELECTRICAL DUCT BANK SERVICE
- 7. PROPOSED TELECOMMUNICATION DUCT BANK SERVICE
- 8. EQUIPMENT PADS

### SITE PLAN NOTES

### KEY C-1

- 1. 14' SWING GATE (TYP. 2).
- 18' SWING GATE (TYP. 1). 3. K12 RATED BOLLARDS (TYP.)
- 4. SECURITY TURNSILE
- 5. 8' CHAIN-LINK FENCE WITH RAZOR WIRE
- 6. 24' CANTILEVER GATE
- . BUS SHELTER
- 8. CRASH ATTENTUATOR (TYP. 2)
- STOP LINE

MINOR CONTOUR

MAJOR CONTPUR

TELE COMMUNICATION

10. WHITE DASHED LINE


11. YELLOW SOLID LINE (HC DETAIL T-7.01, 5"DY)


- 12. SPEED HUMP
- 13. GUARD CENTER CANOPY
- 14. GUARD BOOTHS
- 15. GUARD CENTER
- 16. BARRIER GATE ARM 17. 8 FOOT RAPID DEPLOYMENT K12 WEDGE
- BARRIER (TYP. 2)
- 18. 14 FOOT RAPID DEPLOYMENT K12 WEDGE
- BARRIER (TYP. 1)

# **EXISTING LEGEND**

SANITARY SEWER

### PROPOSED LEGEND

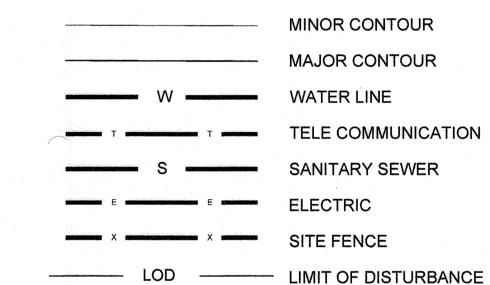

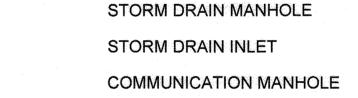


**ELECTRIC CABINET** 


WATER LINE

LIGHT POLE

VALVE FULL DEPTH ASPHALT

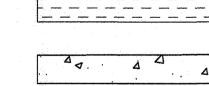


MILL AND RESURFACE EXISTING ASPHALT PAVEMENT

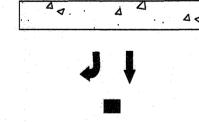

PAVEMENT MARKINGS

CONCRETE PAVING

----- HYDRAULIC POWER LINE

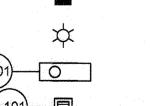

LIGHT POLE

HYDRAULIC POWER UNIT



TYPE A-10 STORM CURB INLET AT GRADE STORM GRATE INLET



FOCAL POINT FACILITY (SURFACE STORAGE & FOCAL POINT BED)

APPROVED: DEPARTMENT OF PLANNING AND ZONING

Chief, Division of Land Development

4.25.24 4/23/24

700 East Pratt Street, Suite 500 Baltimore, MD 21202

Ph: 410.728.2900 Contact: Matt Thomasson

www.rkk.com

LAWS OF THE STATE OF MARYLAND, LICENSE NO. 49432, EXPIRATION DATE: MAY 31, 2024

PROFESSIONAL CERTIFICATION. I HEREBY CERTIFY THAT THESE DOCUMENTS WERE PREPARED OR APPROVED BY ME, AND THAT AM A DULY LICENSED PROFESSIONAL ENGINEER UNDER THE

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### OWNER/DEVELOPER

JOHNS HOPKINS APPLIED PHYSICS LABORATORY 11100 JOHNS HOPKINS ROAD LAUREL, MARYLAND 20723

### **ENVIRONMENTAL CONCEPT PLAN**

JOHNS HOPKINS UNIVERSITY - APPLIED PHYSICS LABORATORY **B108 GATE4 IMPROVEMENTS PROJECT** 

11100 JOHNS HOPKINS ROAD TAX MAP: 41 PARCEL: 123 GRID: 16 ZONED: PEC ELECTION DISTRICT 5 - HOWARD COUNTY, MARYLAND SHEET 03 OF 05


SCALE: As Shown

C-202

**RK&K PROJECT** 

NUMBER

23187

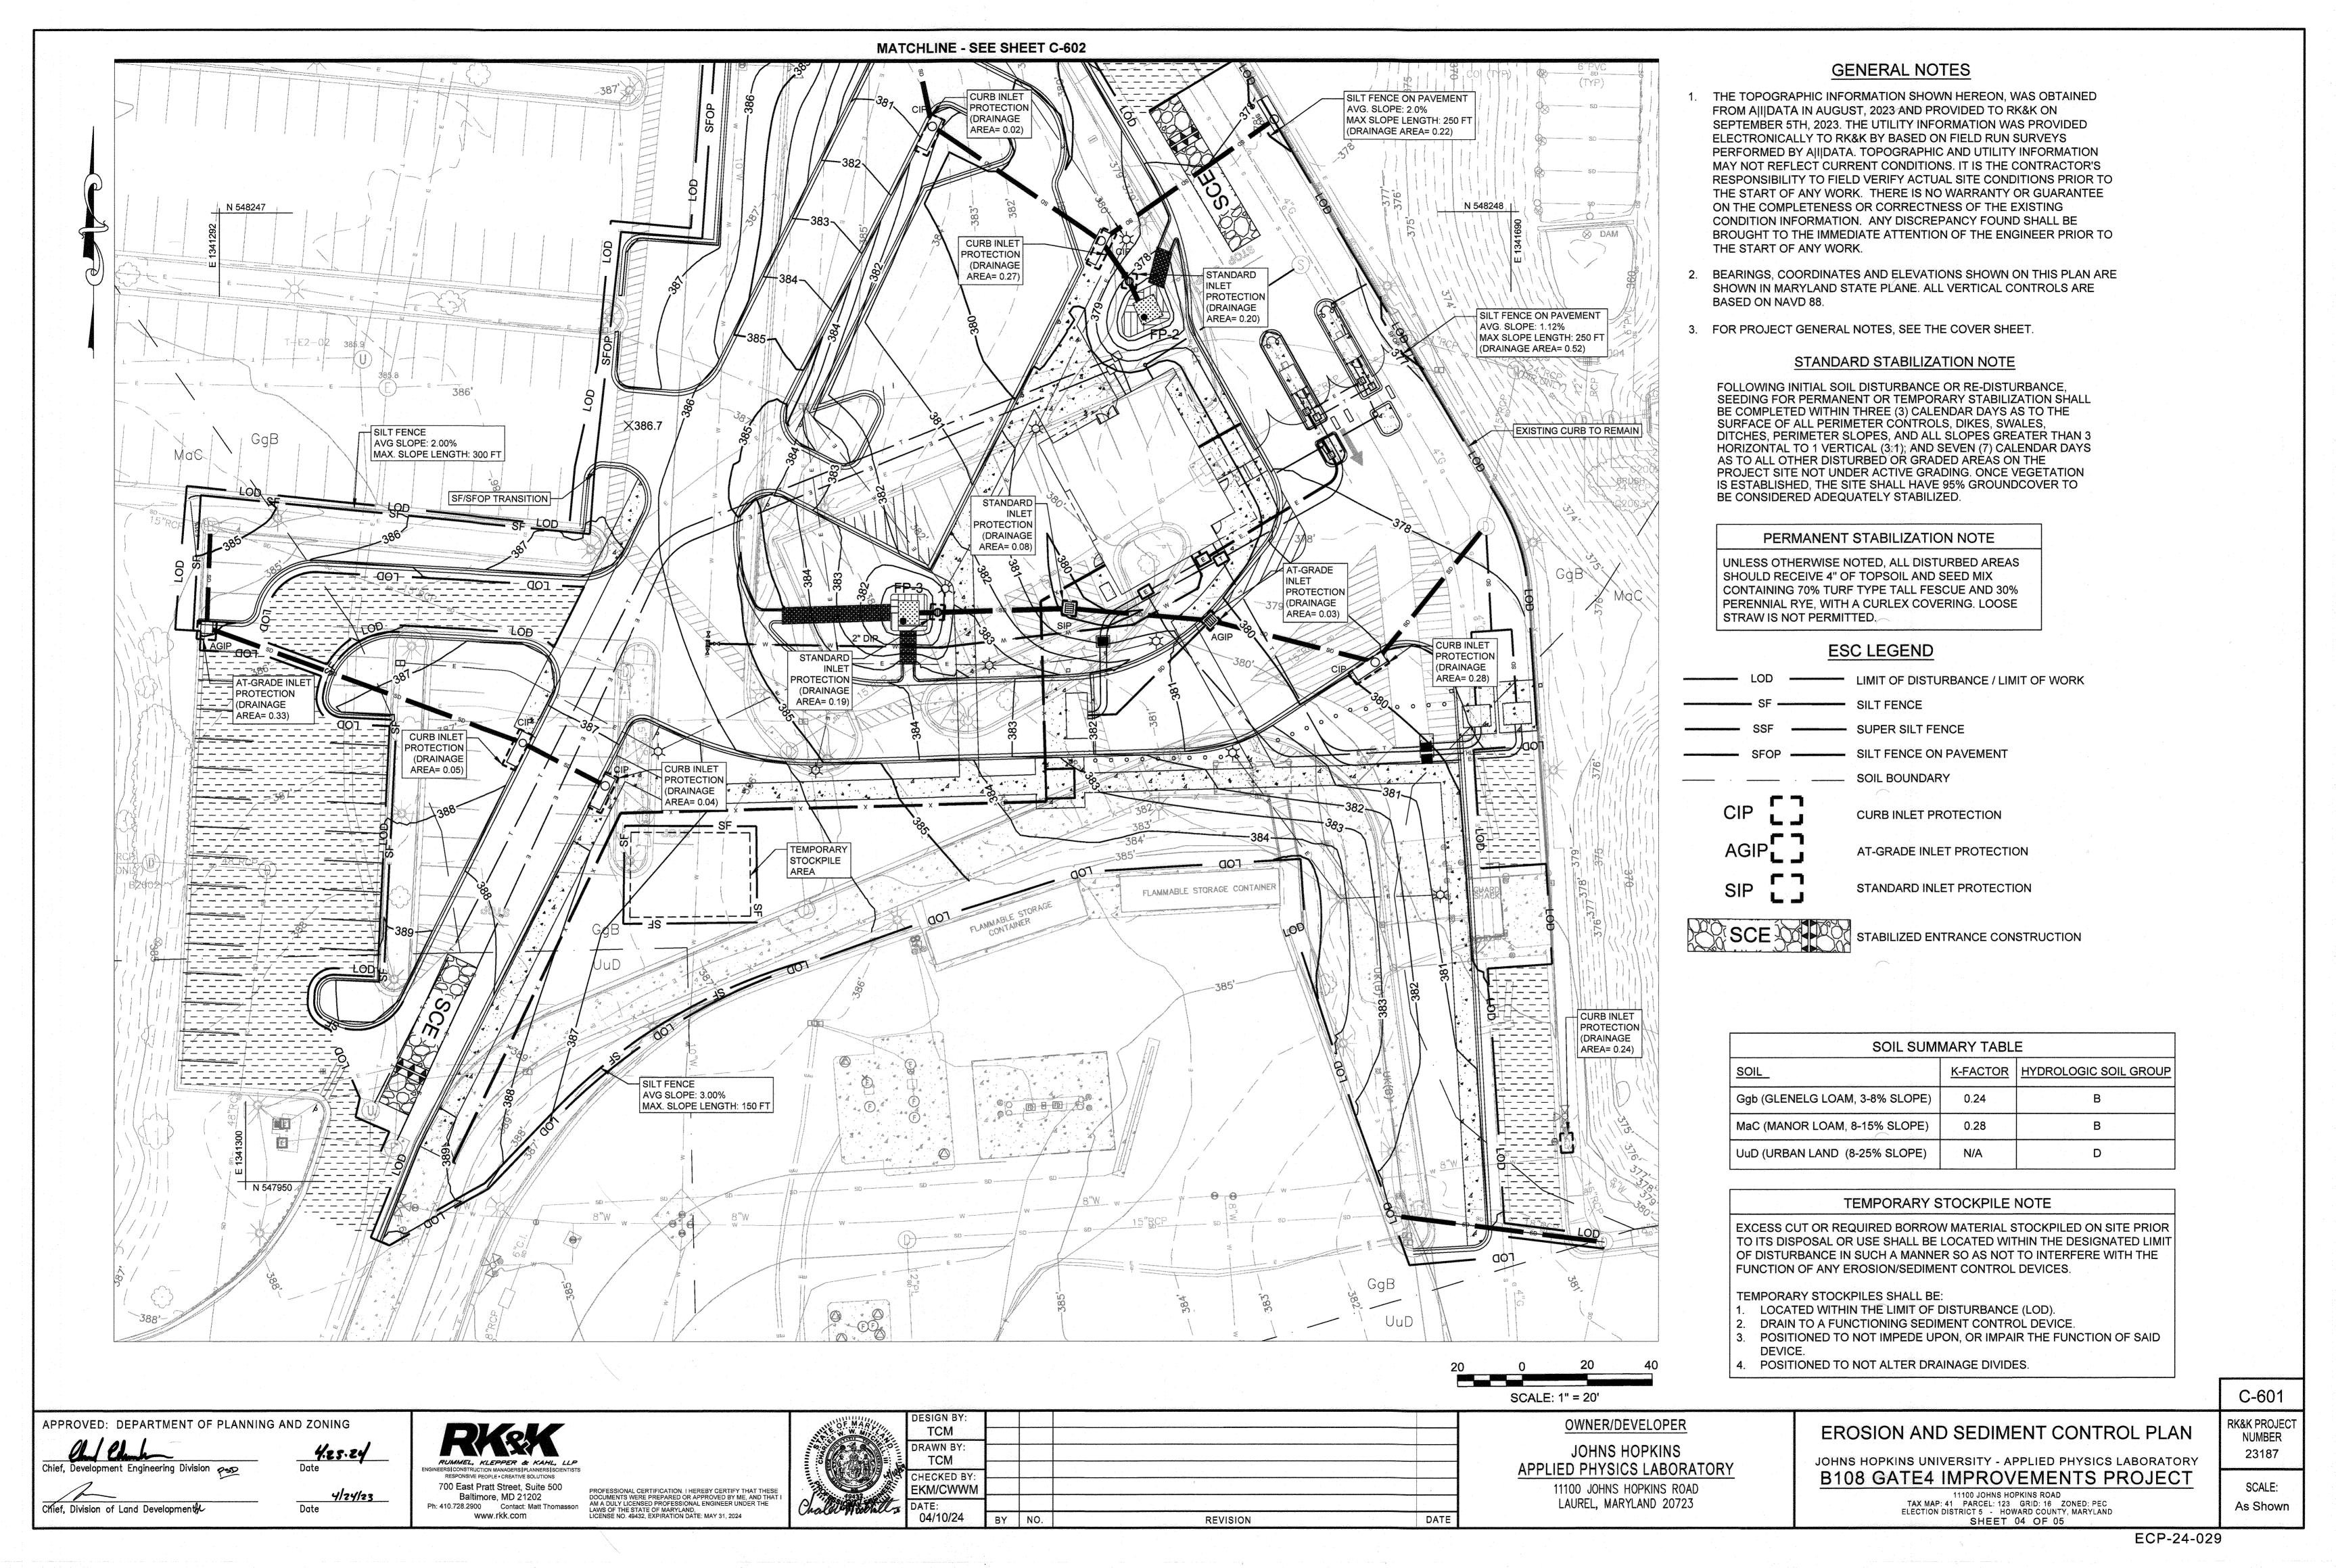

# N 548600 SUPER SILT FENCE AVG SLOPE: 0.97% MAX. SLOPE LENGTH: UNLIMITED CURB INLET PROTECTION (DRAINAGE AREA= 0.11) SSF/SFOP TRANSITION — CURB INLET (DRAINAGE AREA= 0.11) SILT FENCE ON PAVEMENT AVG SLOPE: 1.90% EXISTING CURB TO REMAIN MAX. SLOPE LENGTH: 250 FT. PROTECTION N 548322 (DRAINAGE AREA= 0.19) **MATCHLINE - SEE SHEET C-601** SCALE: 1" = 20'

### **GENERAL NOTES**

- THE TOPOGRAPHIC INFORMATION SHOWN HEREON, WAS OBTAINED FROM AJIJDATA IN AUGUST, 2023 AND PROVIDED TO RK&K ON SEPTEMBER 5TH, 2023. THE UTILITY INFORMATION WAS PROVIDED ELECTRONICALLY TO RK&K BY BASED ON FIELD RUN SURVEYS PERFORMED BY AJJUATA. TOPOGRAPHIC AND UTILITY INFORMATION MAY NOT REFLECT CURRENT CONDITIONS. IT IS THE CONTRACTOR'S RESPONSIBILITY TO FIELD VERIFY ACTUAL SITE CONDITIONS PRIOR TO THE START OF ANY WORK. THERE IS NO WARRANTY OR GUARANTEE ON THE COMPLETENESS OR CORRECTNESS OF THE EXISTING CONDITION INFORMATION. ANY DISCREPANCY FOUND SHALL BE BROUGHT TO THE IMMEDIATE ATTENTION OF THE ENGINEER PRIOR TO THE START OF ANY WORK.
- BEARINGS, COORDINATES AND ELEVATIONS SHOWN ON THIS PLAN ARE SHOWN IN MARYLAND STATE PLANE. ALL VERTICAL CONTROLS ARE BASED ON NAVD 88.
- FOR PROJECT GENERAL NOTES, SEE THE COVER SHEET.


### STANDARD STABILIZATION NOTE

FOLLOWING INITIAL SOIL DISTURBANCE OR RE-DISTURBANCE, SEEDING FOR PERMANENT OR TEMPORARY STABILIZATION SHALL BE COMPLETED WITHIN THREE (3) CALENDAR DAYS AS TO THE SURFACE OF ALL PERIMETER CONTROLS, DIKES, SWALES, DITCHES, PERIMETER SLOPES, AND ALL SLOPES GREATER THAN 3 HORIZONTAL TO 1 VERTICAL (3:1); AND SEVEN (7) CALENDAR DAYS AS TO ALL OTHER DISTURBED OR GRADED AREAS ON THE PROJECT SITE NOT UNDER ACTIVE GRADING. ONCE VEGETATION IS ESTABLISHED, THE SITE SHALL HAVE 95% GROUNDCOVER TO BE CONSIDERED ADEQUATELY STABILIZED.

### PERMANENT STABILIZATION NOTE

UNLESS OTHERWISE NOTED, ALL DISTURBED AREAS SHOULD RECEIVE 4" OF TOPSOIL AND SEED MIX CONTAINING 70% TURF TYPE TALL FESCUE AND 30% PERENNIAL RYE, WITH A CURLEX COVERING. LOOSE STRAW IS NOT PERMITTED.

### **ESC LEGEND**

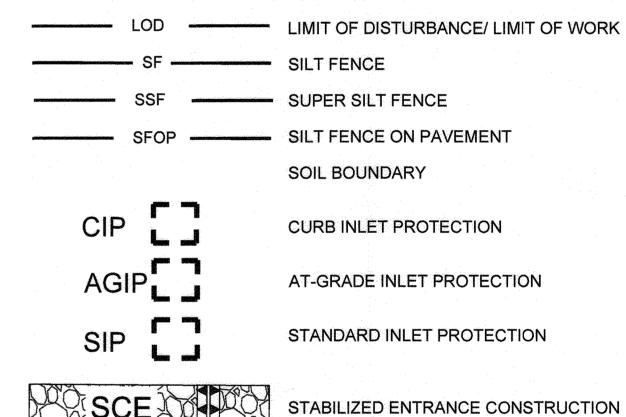

**EROSION AND SEDIMENT CONTROL PLAN** 

C-602

**RK&K PROJEC** 

SCALE:

As Shown

NUMBER 23187

11100 JOHNS HOPKINS ROAD TAX MAP: 41 PARCEL: 123 GRID: 16 ZONED: PEC ELECTION DISTRICT 5 - HOWARD COUNTY, MARYLAND SHEET 05 OF 05

APPROVED: DEPARTMENT OF PLANNING AND ZONING

4/24/23

4.25.24

Chief, Development Engineering Division PSP Chief, Division of Land Development

700 East Pratt Street, Suite 500 PROFESSIONAL CERTIFICATION. I HEREBY CERTIFY THAT THESE DOCUMENTS WERE PREPARED OR APPROVED BY ME, AND THAT I AM A DULY LICENSED PROFESSIONAL ENGINEER UNDER THE LAWS OF THE STATE OF MARYLAND, LICENSE NO. 49432, EXPIRATION DATE: MAY 31, 2024 Baltimore, MD 21202 Ph: 410.728.2900 Contact: Matt Thomasson

www.rkk.com

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OWNER/DEVELOPER JOHNS HOPKINS APPLIED PHYSICS LABORATORY 11100 JOHNS HOPKINS ROAD LAUREL, MARYLAND 20723

DATE

JOHNS HOPKINS UNIVERSITY - APPLIED PHYSICS LABORATORY **B108 GATE4 IMPROVEMENTS PROJECT**