GENERAL NOTES

- SUBJECT PROPERTY ZONED RC-DEO PER 10-06-2013 COMPREHENSIVE ZONING PLAN. DEED REFERENCE: LIBER 18220, FOLIO 230
- SUBJECT PROPERTY IS LOCATED ON FREDERICK ROAD, A SCENIC ROAD.

- PRIVATE WELL AND SEWAGE DISPOSAL AREAS ARE USED WITHIN THIS SITE. THERE ARE NO WELLS O

- AFFORESTATION/REFORESTATION AND/OR RETENTION. THIS OBLIGATION WILL BE MET AT THE SITE

BEARING & DISTANCE CHART DISTANCE **BEARING** N 68°31'50" W 115.67' N 65°51'31" W 150.16' N 72°32'05" W 100.24' N 68°31'50" W 98.99' N 57°13'14" W 101.98' N 71°23'35" W 101.12' N 77°03'41" W 101.12' N 77°03'41" W 100.12' N 65°41'40" W 60.63' N 85°13'47" W 104.40' N 44°46'52" W 54.63' N 68°31'50" W 200.00' N 67°05'54" W 200.06' N 71°57'51" W 150.27' N 82°22'32" W 65.92' N 55°40'45" W 138.50' N 56°16'53" W 50.41' N 59°33'00" W 60.33' N 6°7'43" E 129.98' N 19°28'32" E 19.02' N 21°3'1" E 21.14' N 13°12'9" E 24.84' N 19°28'32" E 19.03' N 14°9'43" E 98.69' N 12°13'45" E 114.89' N 68°48'38" W 118.00'

APPROVED: HOWARD COUNTY DEPARTMENT OF PLANNING AND ZONING


SITE ANALYSIS I	DATA SHEET
ENVIRONMENTAL AREA	SIZE OR USE (1)
TOTAL PROJECT AREA	119.88 ACRES ±
LIMIT OF DISTURBANCE	36.64 ACRES ±
GREEN OPEN AREA (LAWN)	34.93 ACRES ±
IMPERVIOUS AREA	0.87 ACRES ±
PROPOSED SITE USES	SOLAR FACILITY
WETLANDS	121,999 SQ FT± *
WETLAND BUFFERS	136,378 SQ FT± *
FLOODPLAINS	681,174 SQ FT± *
FLOODPLAIN BUFFERS	430,831 SQ FT± *
EXISTING FOREST	30,789 SQ FT±
SLOPES GREATER THAN 15%	144,379 SQ FT±
HIGHLY ERODIBLE SOILS (3)	3.31 ACRES±

AREAS LISTED WITH AN ASTERISK ARE NOT WITHIN THE DEVELOPMENT AREA. 2. SOIL INFORMATION HAS BEEN TAKEN FROM THE UNITED STATES DEPARTMENT OF AGRICULTURE;


- NATURAL RESOURCES CONSERVATION SERVICE; WEB SOIL SURVEY 3. HIGHLY ERODIBLE SOILS ARE THOSE SOILS WITH A

ENVIRONMENTAL CONCEPT PLAN SED PJM HOLDINGS LLC CLEAR VIEW FARM SOLAR FACILITY, COMMERCIAL

HOWARD COUNTY, MARYLAND TAX MAP 9 PARCEL 73

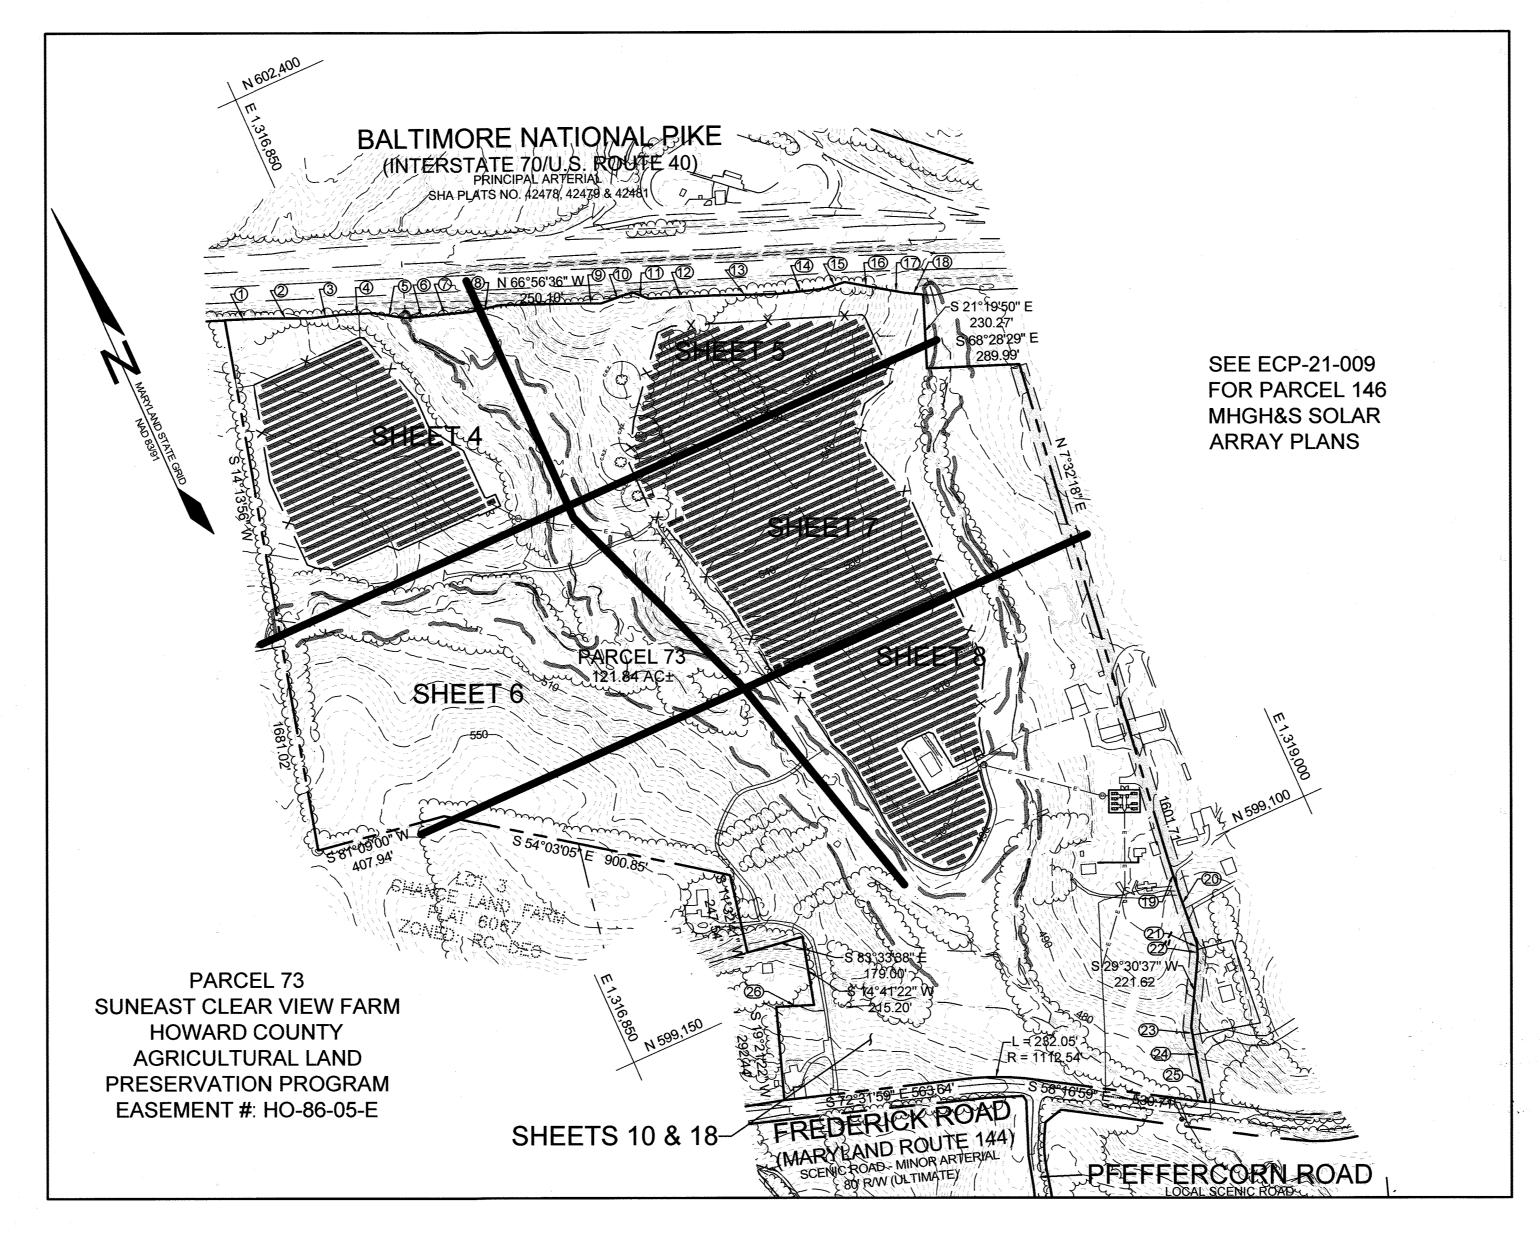

LOCATION MAP

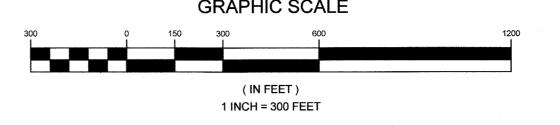

LEGEND		OLD FREDE
EXISTING CONTOUR PROPOSED CONTOUR	382	HEATHERWOOD WAY WAY
EXISTING SPOT ELEVATION PROPOSED SPOT ELEVATION	₃₈ 2, ³ + 82 ^{<u>53</u>}	HEAT TANK
DIRECTION OF FLOW		
EXISTING TREELINE PROPOSED TREELINE		
EXISTING SPECIMEN TREE	ST#2	70
EXISTING WETLAND	——— W ———	HOWARD
EXISTING WETLAND BUFFER	WB	SITE
EXISTING STREAM		
EXISTING STREAM BUFFER	SB	15BB 15BB
EXISTING 100-YEAR FLOODPLAIN		15B.
PROPOSED SOLAR ARRAY AREA		PATUXENT PA
PROPOSED LEVEL SPREADER	60 LF	HOWARD COUNTY, MARYLAND ADC MAP 17 GRIDS F1 & F2 AND MAP 18 GRIDS A1
PROPOSED 7' FENCE (NO BARBED WIRE)	x x	VICINITY MAP SCALE: 1"=2000'

USE RIGHT-OF-WAY MAINTENANCE AGREEMENT

	BENCH	HMARKS	
NUMBER	NORTHING	EASTING	ELEVATION
15BA	597,228.1254	1,321,719.2760	590.296'
15BB	597,926.9029	1,319,949.8262	527.586'

SHEET INDEX		
SHEET NO.	DESCRIPTION	
1	COVER SHEET	
2	EXISTING CONDITIONS AND FOREST STAND & SLOPE DELINEATION	
3	SOILS MAP	
4	SEDIMENT & EROSION CONTROL AND STORMWATER MANAGEMENT PLAN	
5	SEDIMENT & EROSION CONTROL AND STORMWATER MANAGEMENT PLAN	
6	SEDIMENT & EROSION CONTROL AND STORMWATER MANAGEMENT PLAN	
7	SEDIMENT & EROSION CONTROL AND STORMWATER MANAGEMENT PLAN	
8	SEDIMENT & EROSION CONTROL AND STORMWATER MANAGEMENT PLAN	
9	STORMWATER MANAGEMENT DRAINAGE AREA MAP	
10	FLOODPLAIN STUDY - EXISTING CONDITION DRAINAGE AREA MAP	
11	FLOODPLAIN STUDY - EXISTING CONDITION DRAINAGE AREA MAP	
12	FLOODPLAIN STUDY - PROPOSED CONDITION DRAINAGE AREA MAP	
13	FLOODPLAIN STUDY - PROPOSED CONDITION DRAINAGE AREA MAP	
14	NOTES AND DETAILS	
15	LANDSCAPING PLAN	
16	LANDSCAPING PLAN	

STORMWATER MANAGEMENT **NOTES & DESIGN NARRATIVE**

BELOW IS A LIST TO DESCRIBE THE STORMWATER MANAGEMENT REQUIREMENTS AND ACHIEVEMENTS FOR THE SITE PER THE 2000 MARYLAND STORMWATER DESIGN MANUAL, VOLUMES I AND II, AS AMENDED BY THE STORMWATER MANAGEMENT ACT OF 2007.

- 1. ENVIRONMENTALLY SENSITIVE AREAS HAVE BEEN AVOIDED. THERE IS AN EXISTING STREAM CROSSING SHOWN ON SHEET 6 WHICH WILL BE UTILIZED FOR ACCESS TO THE SOLAR ARRAY AREAS. 2 TO THE GREATEST EXTENT PRACTICABLE THE NATURAL FLOW PATTERNS OF THE SITE HAVE BEEN MAINTAINED
- THE DESIGN INCORPORATES THE LEAST IMPERVIOUS AREA POSSIBLE. 4. STABILIZED CONSTRUCTIONS ENTRANCES, SILT FENCES AND SUPER SILT FENCES ARE USED AS SEDIMENT AND EROSION CONTROL DEVICES. 5. ESD PLANNING TECHNIQUES AND PRACTICES HAVE BEEN IMPLEMENTED, TO THE MAXIMUM EXTENT
- PRACTICABLE, THROUGH USE OF NON-ROOFTOP (N-2) DISCONNECTS, SHEET FLOW TO CONSERVATION AREAS 6. AN ALTERNATIVE COMPLIANCE, WP-21-098, HAS BEEN APPROVED FOR THE REMOVAL OF ONE (1) SPECIMEN
- 7. THE PROPÓSED SOLAR AREAS WILL UTILIZE GRASSES, MEADOWS, AND POLLINATOR HABITATS FOR MOST OF
- THE COVER, WITH RUNOFF FLOWING OFF OF THE SOLAR PANELS INTO THE GRASSES.
- 8. THE TEE TURNAROUNDS AND EQUIPMENT PADS WILL BE TREATED VIA NON-ROOF DISCONNECTS

COVER SHEET CLEAR VIEW FARM SOLAR FACILITY 13370 ROUTE 144

TAX MAP 15 GRID 3 3RD ELECTION DISTRICT CLEAR VIEW FARM, LLC WEST FRIENDSHIP, MD 21794

OWNER

13370 ROUTE 144

GEORGE STREAKER, JR. 443-834-2402

GFSJR17@GMAIL.COM

DEVELOPER

SUNEAST CLEAR VIEW SOLAR, LLC

110 PHOENIXVILLE PIKE

MALVERN, PA 19355

484-983-3130 REED.WILLS@SUNEASTPOWER.COM

16005 Frederick Road, 2nd Floor Woodbine, Maryland 21797 Phone: 443.325.5076

DRAWN BY: CHECKED BY: PS SCALE: AS SHOWN DATE: AUGUST 2, 2021 PROJECT #: _____19-044_


HOWARD COUNTY, MARYLAND


Fax: 410.696.2022 Email: info@sillengineering.com


CHIEF, DEVELOPMENT ENGINEERING DIVISION, N


DESIGN BY: PS ENGINEERING GROUP, LLC Civil Engineering for Land Development


ICENSED PROFESSIONAL ENGINEER UNDER THE LAWS OF THE STATE OF MARYLAND, LICENSE NO. 32025, EXPIRATION DATE: JUNE 20, 202:

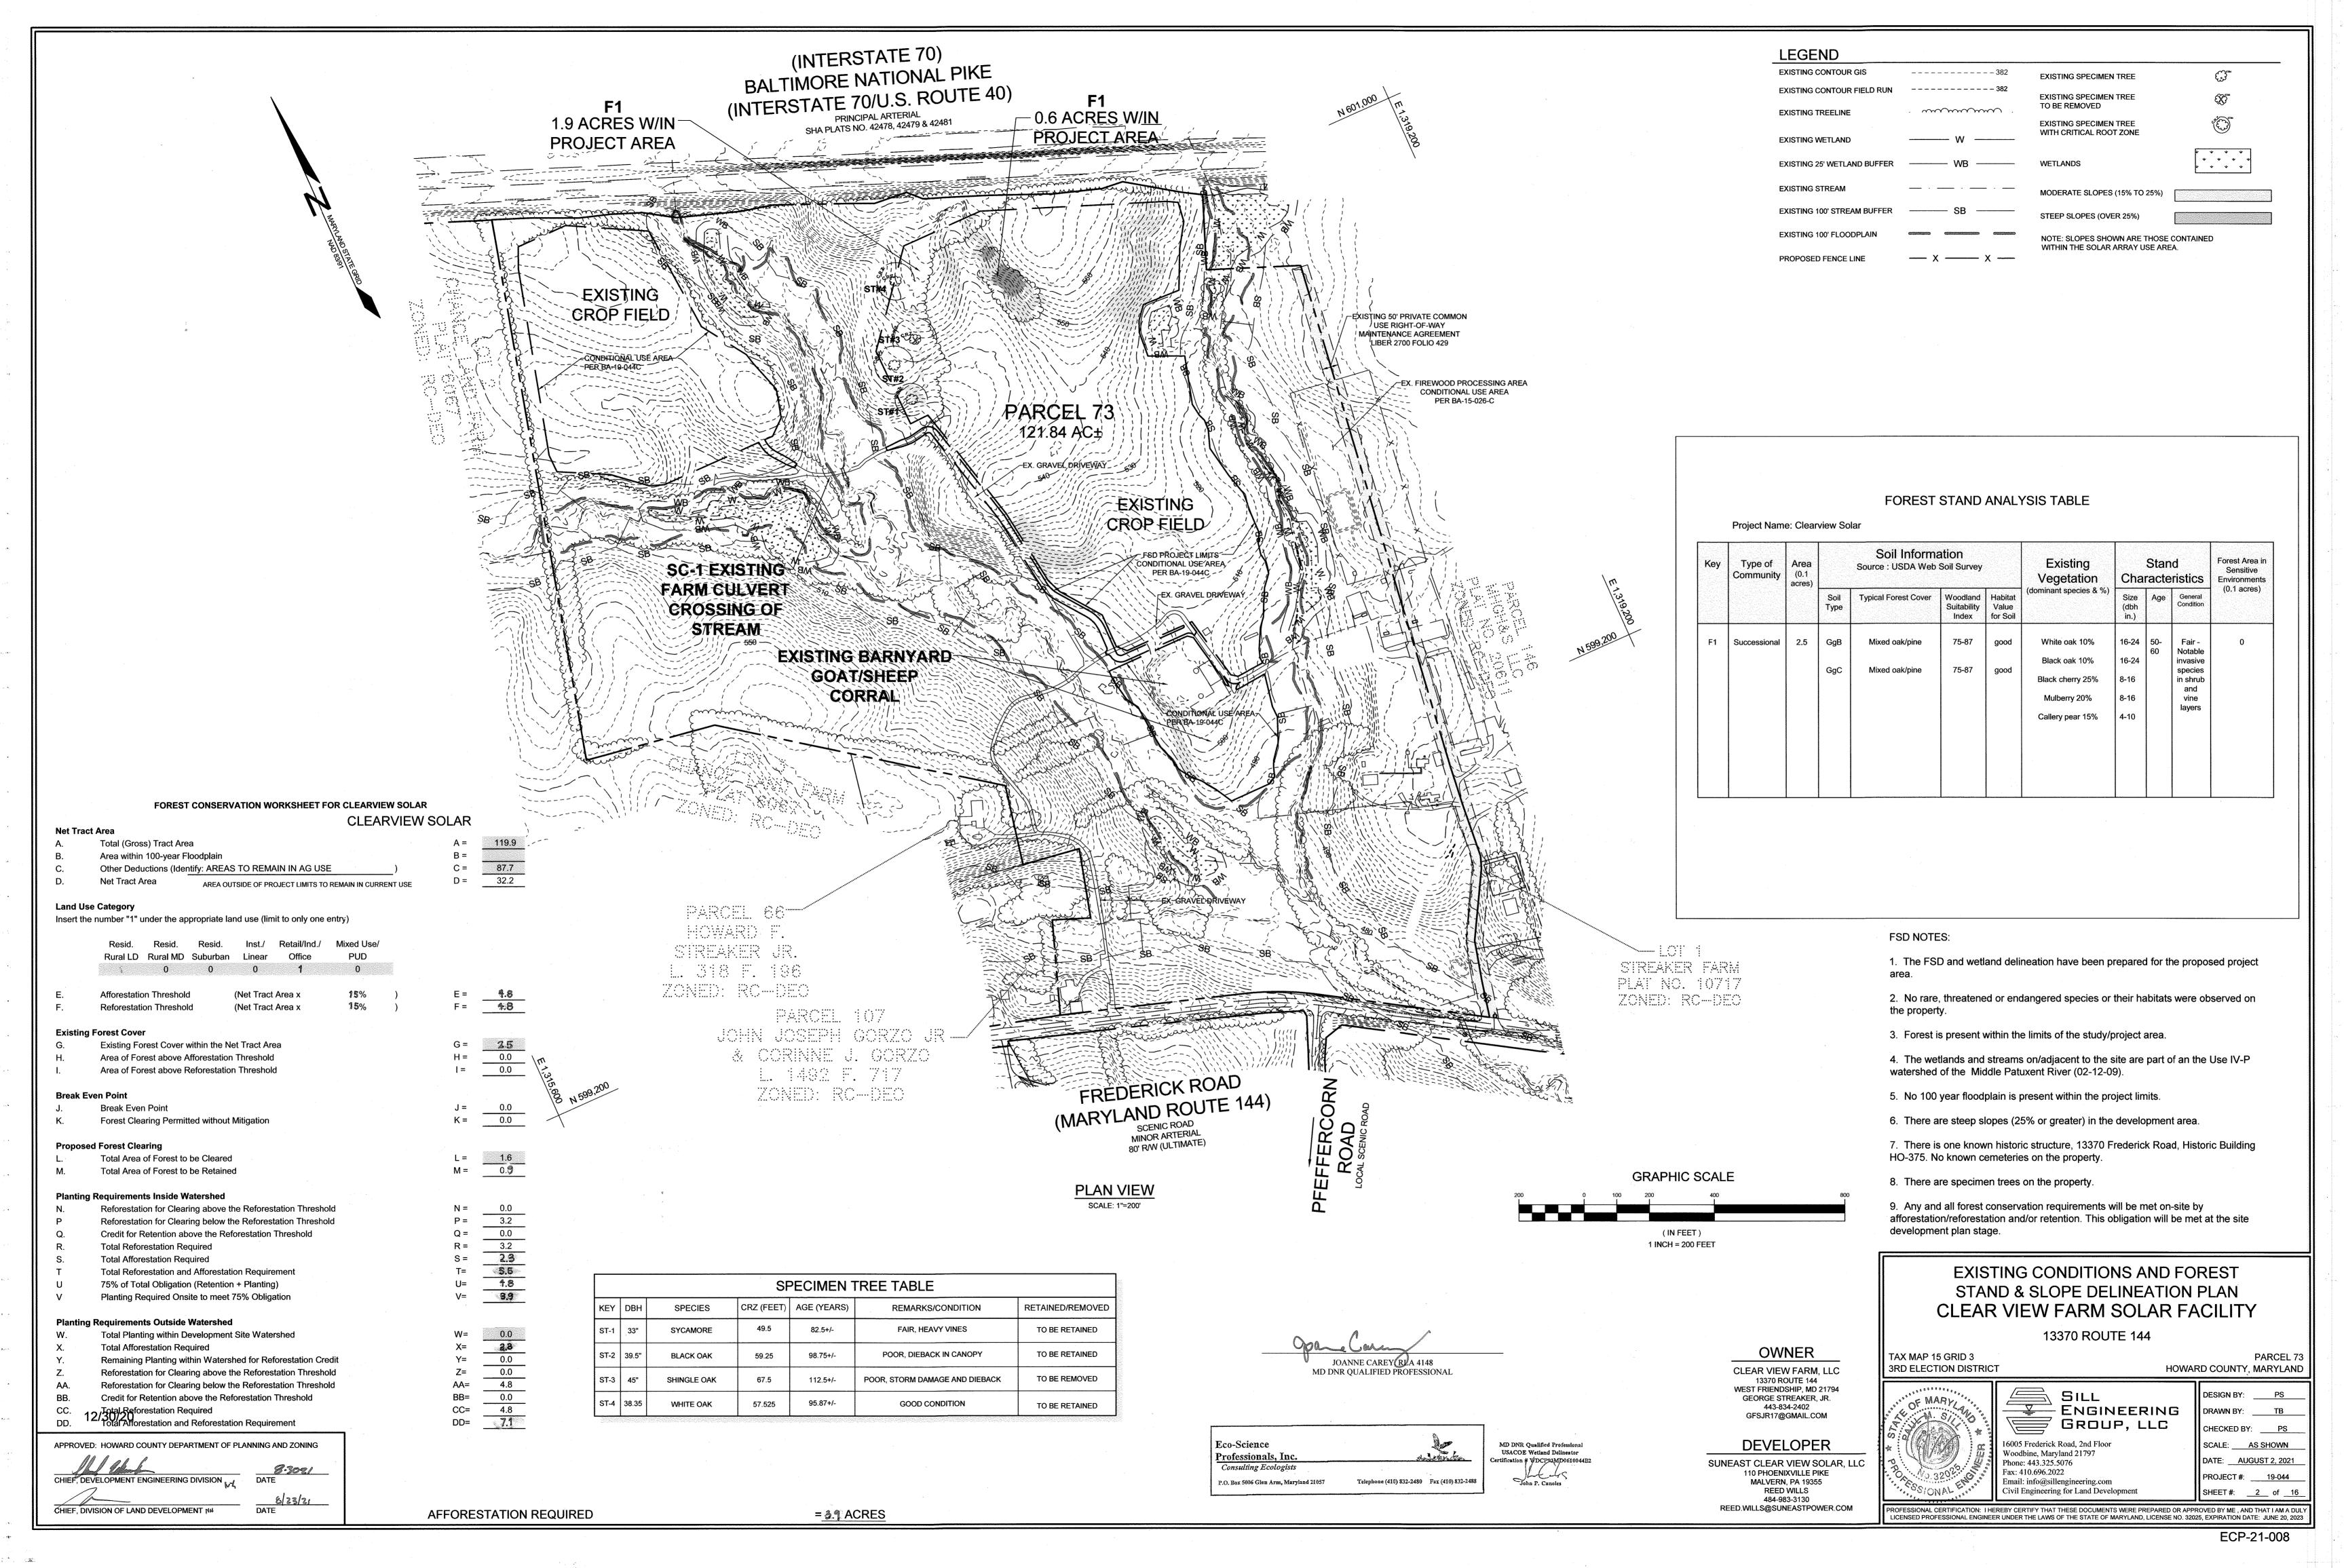


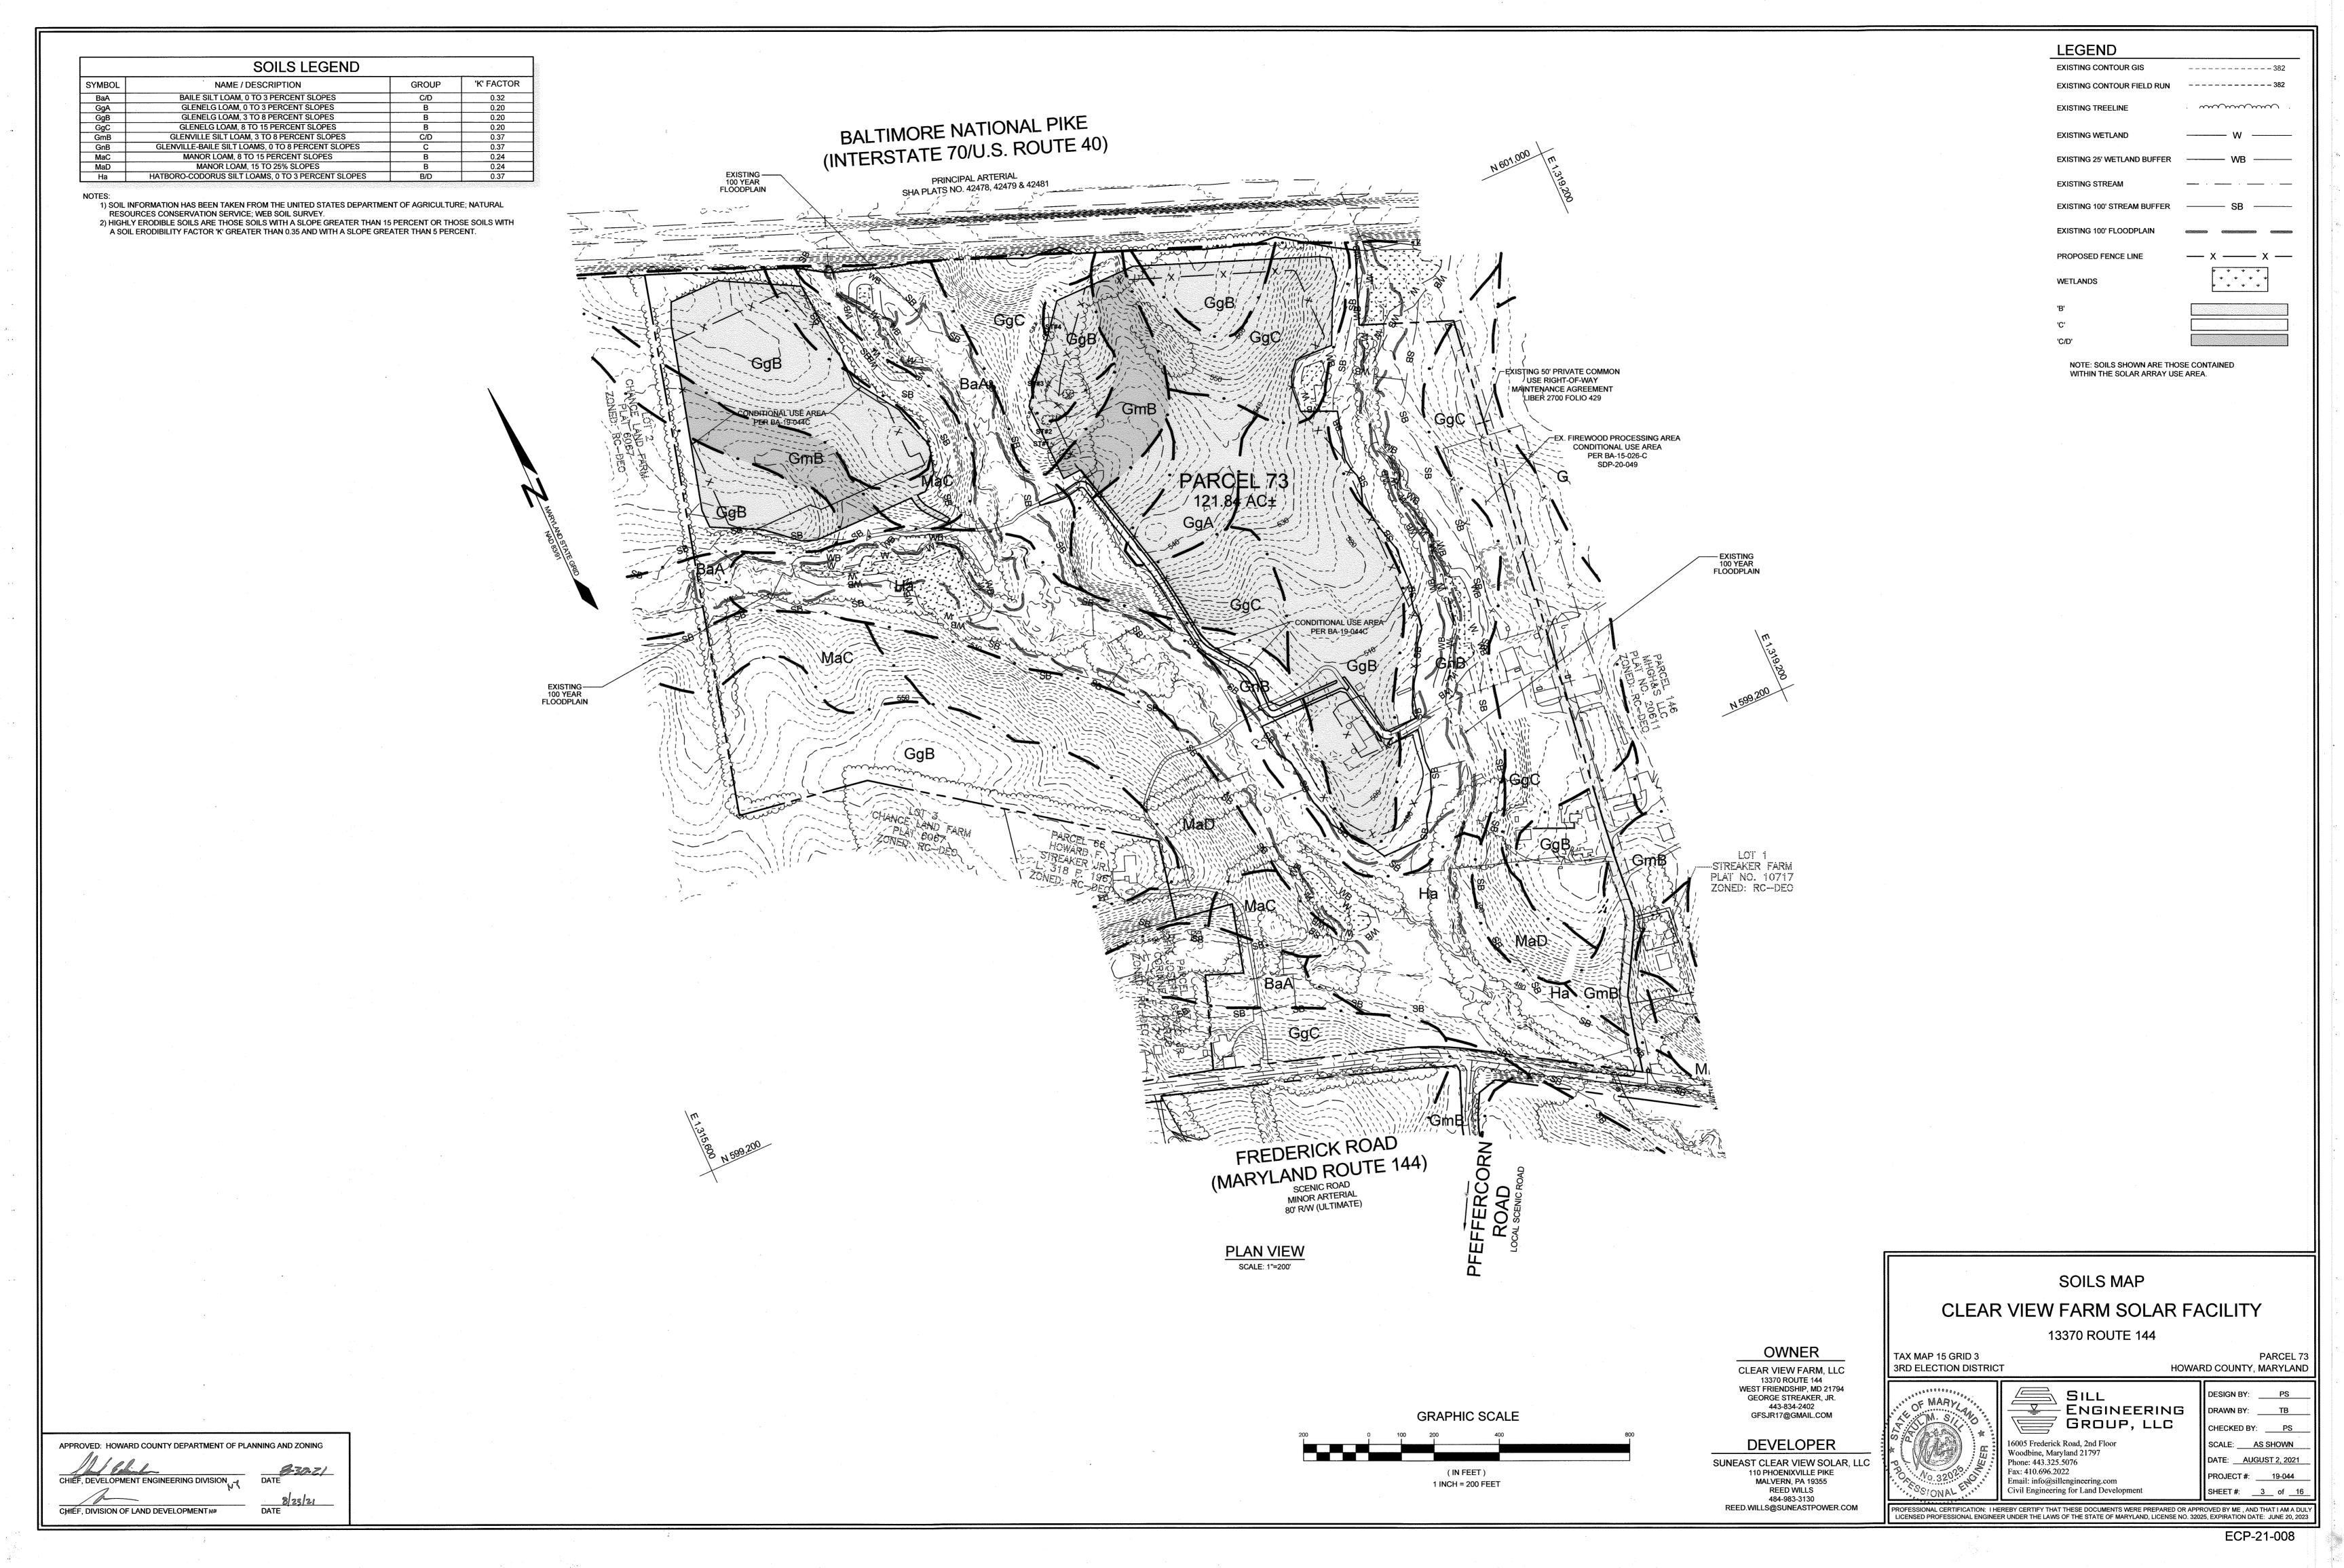


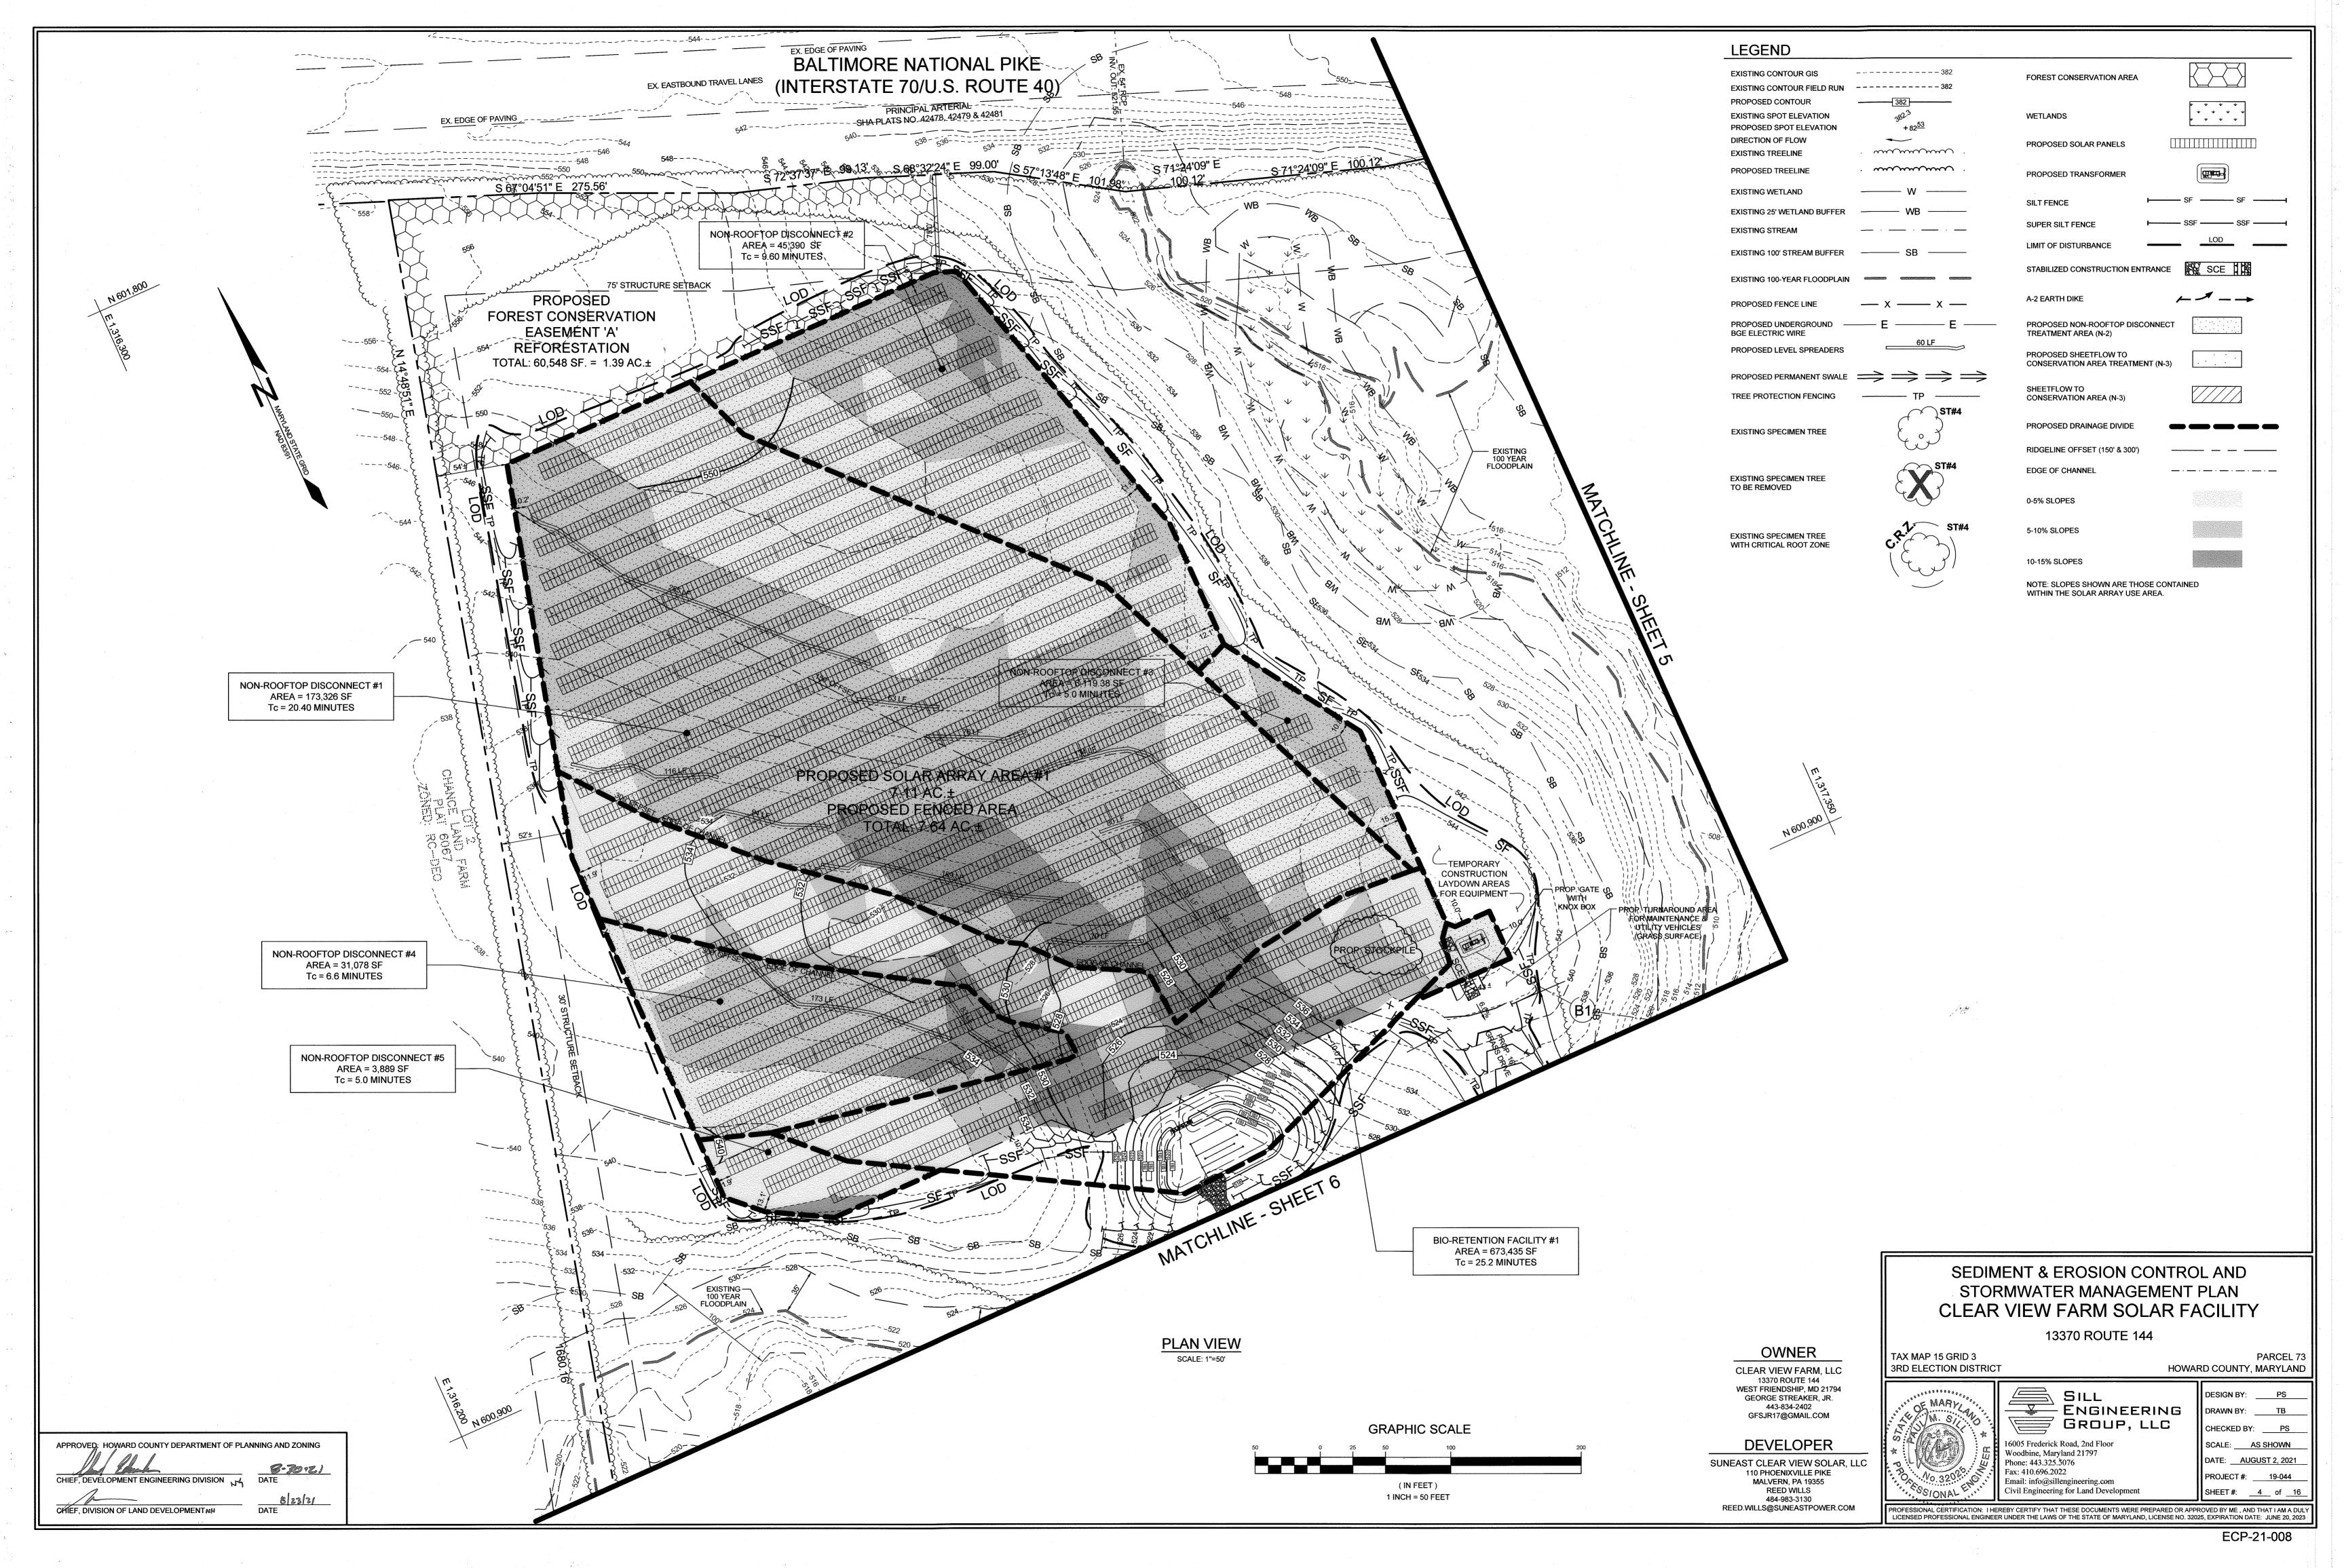


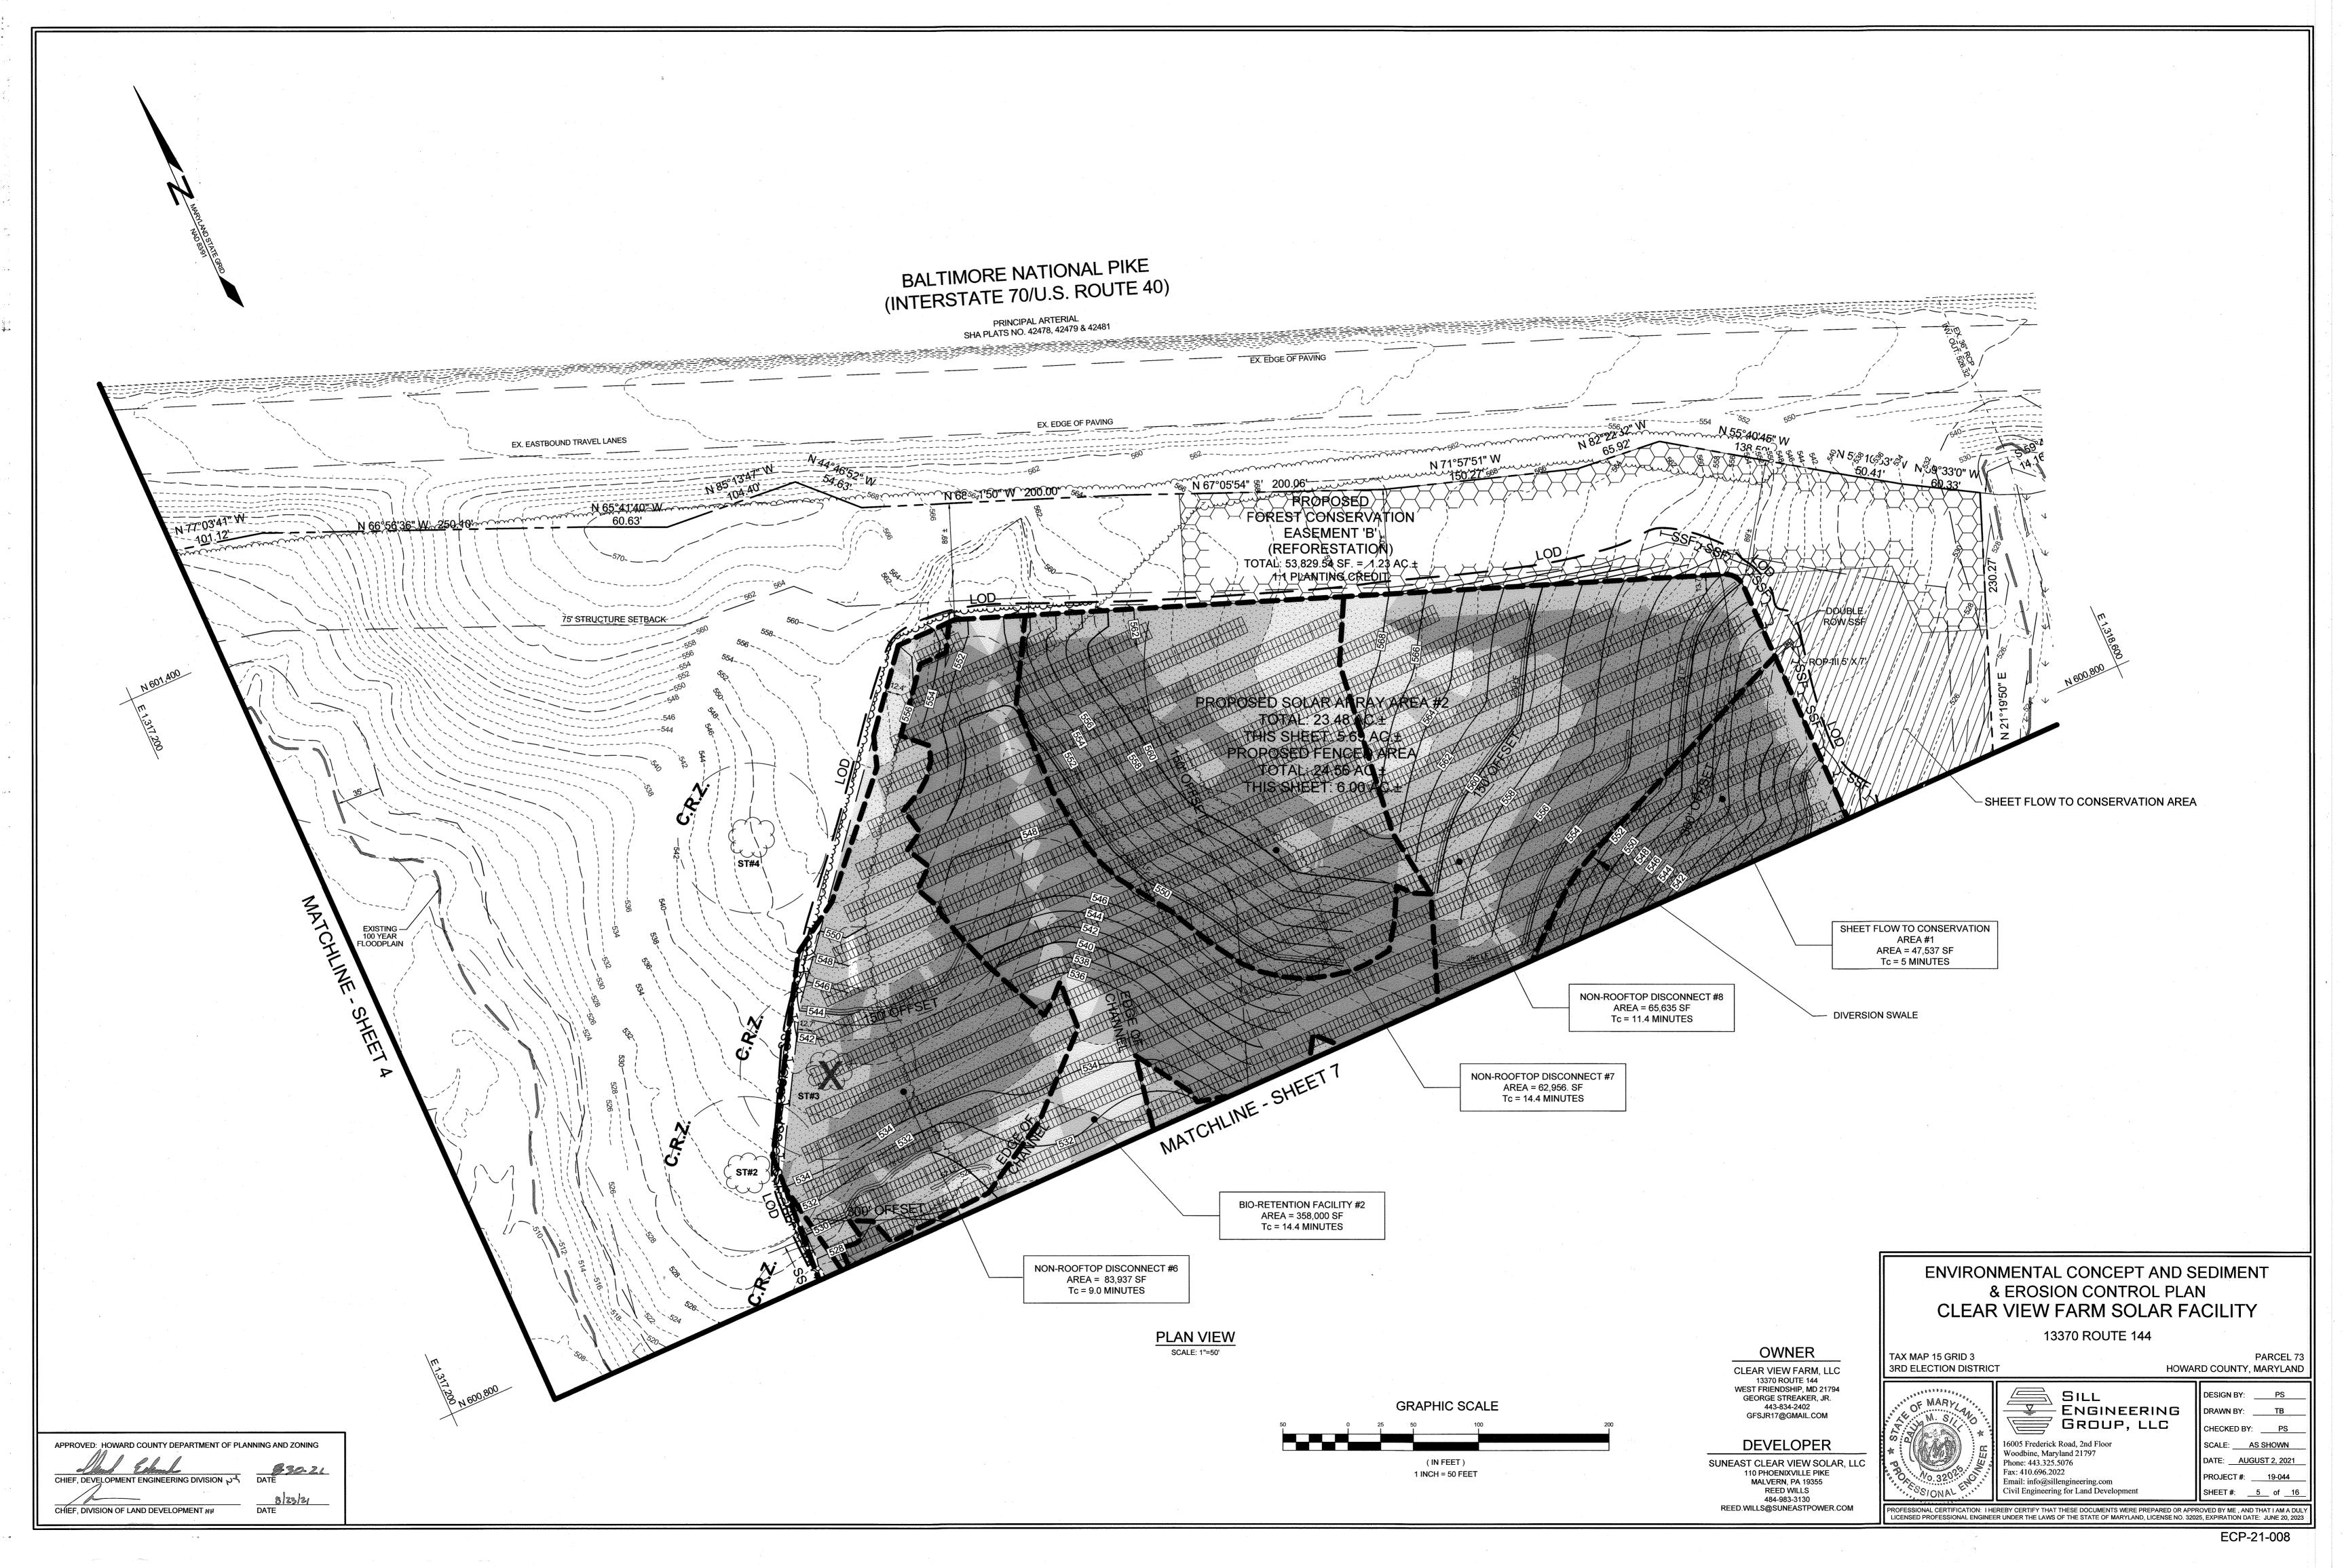


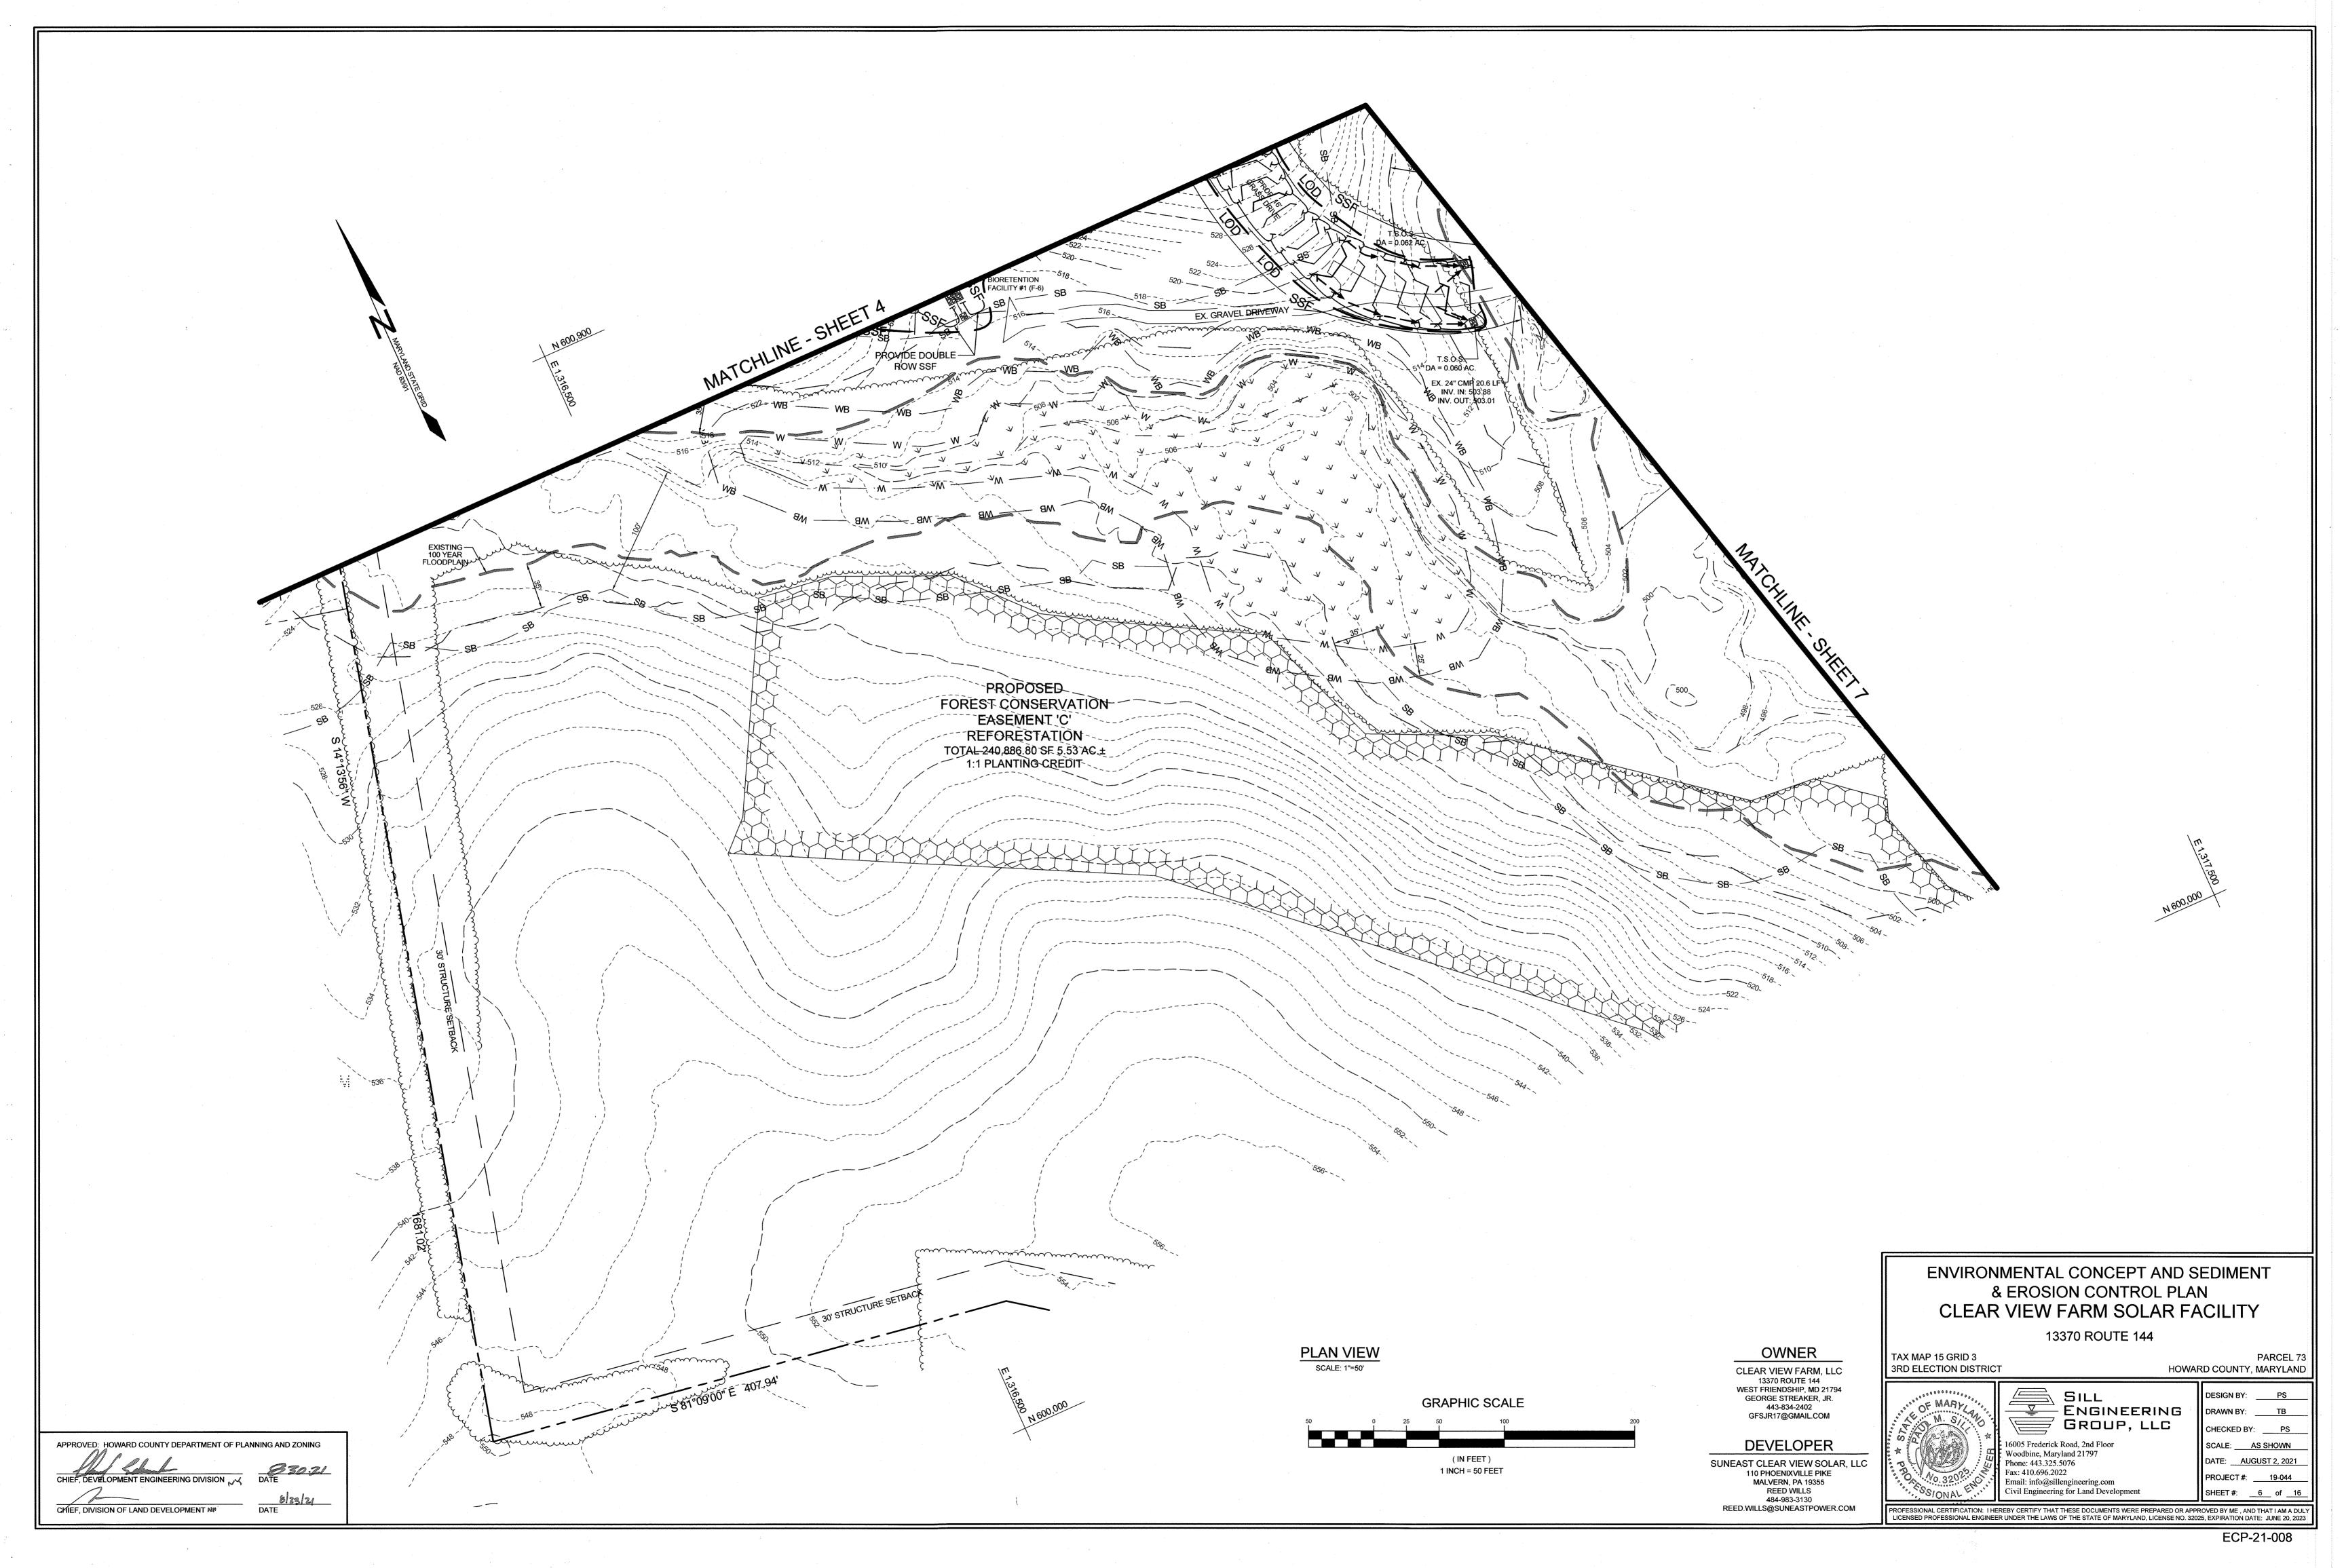


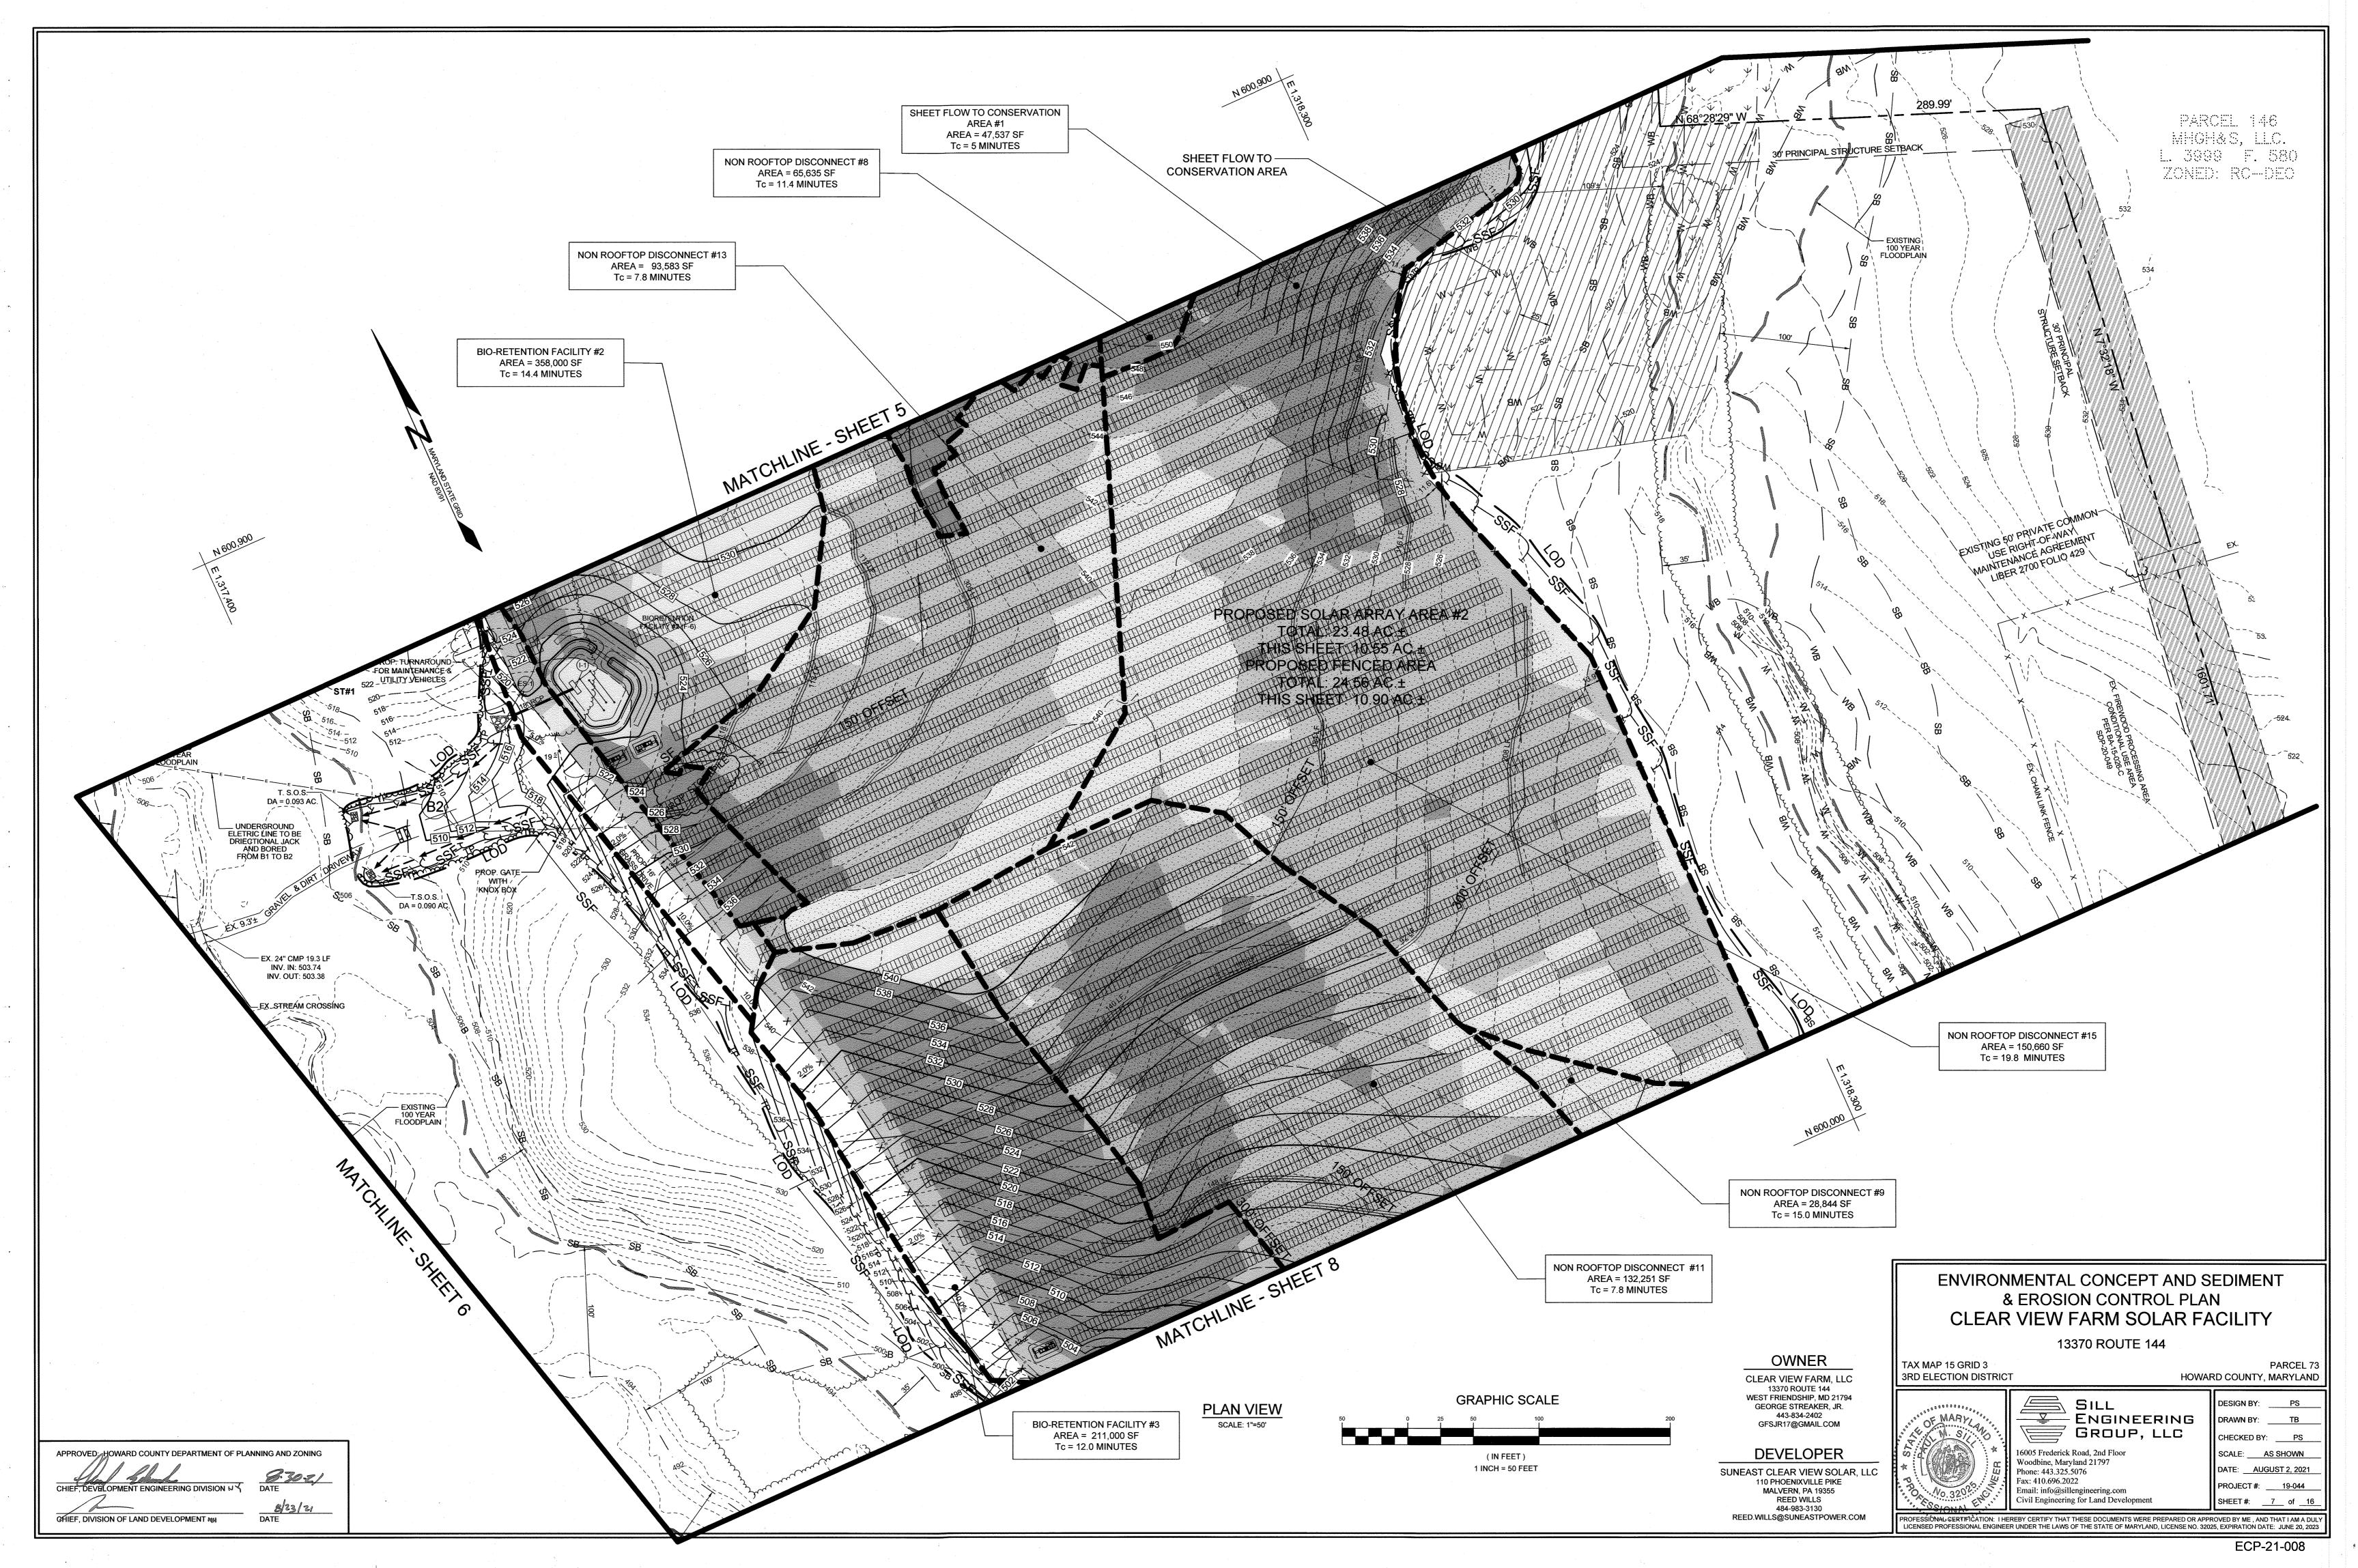


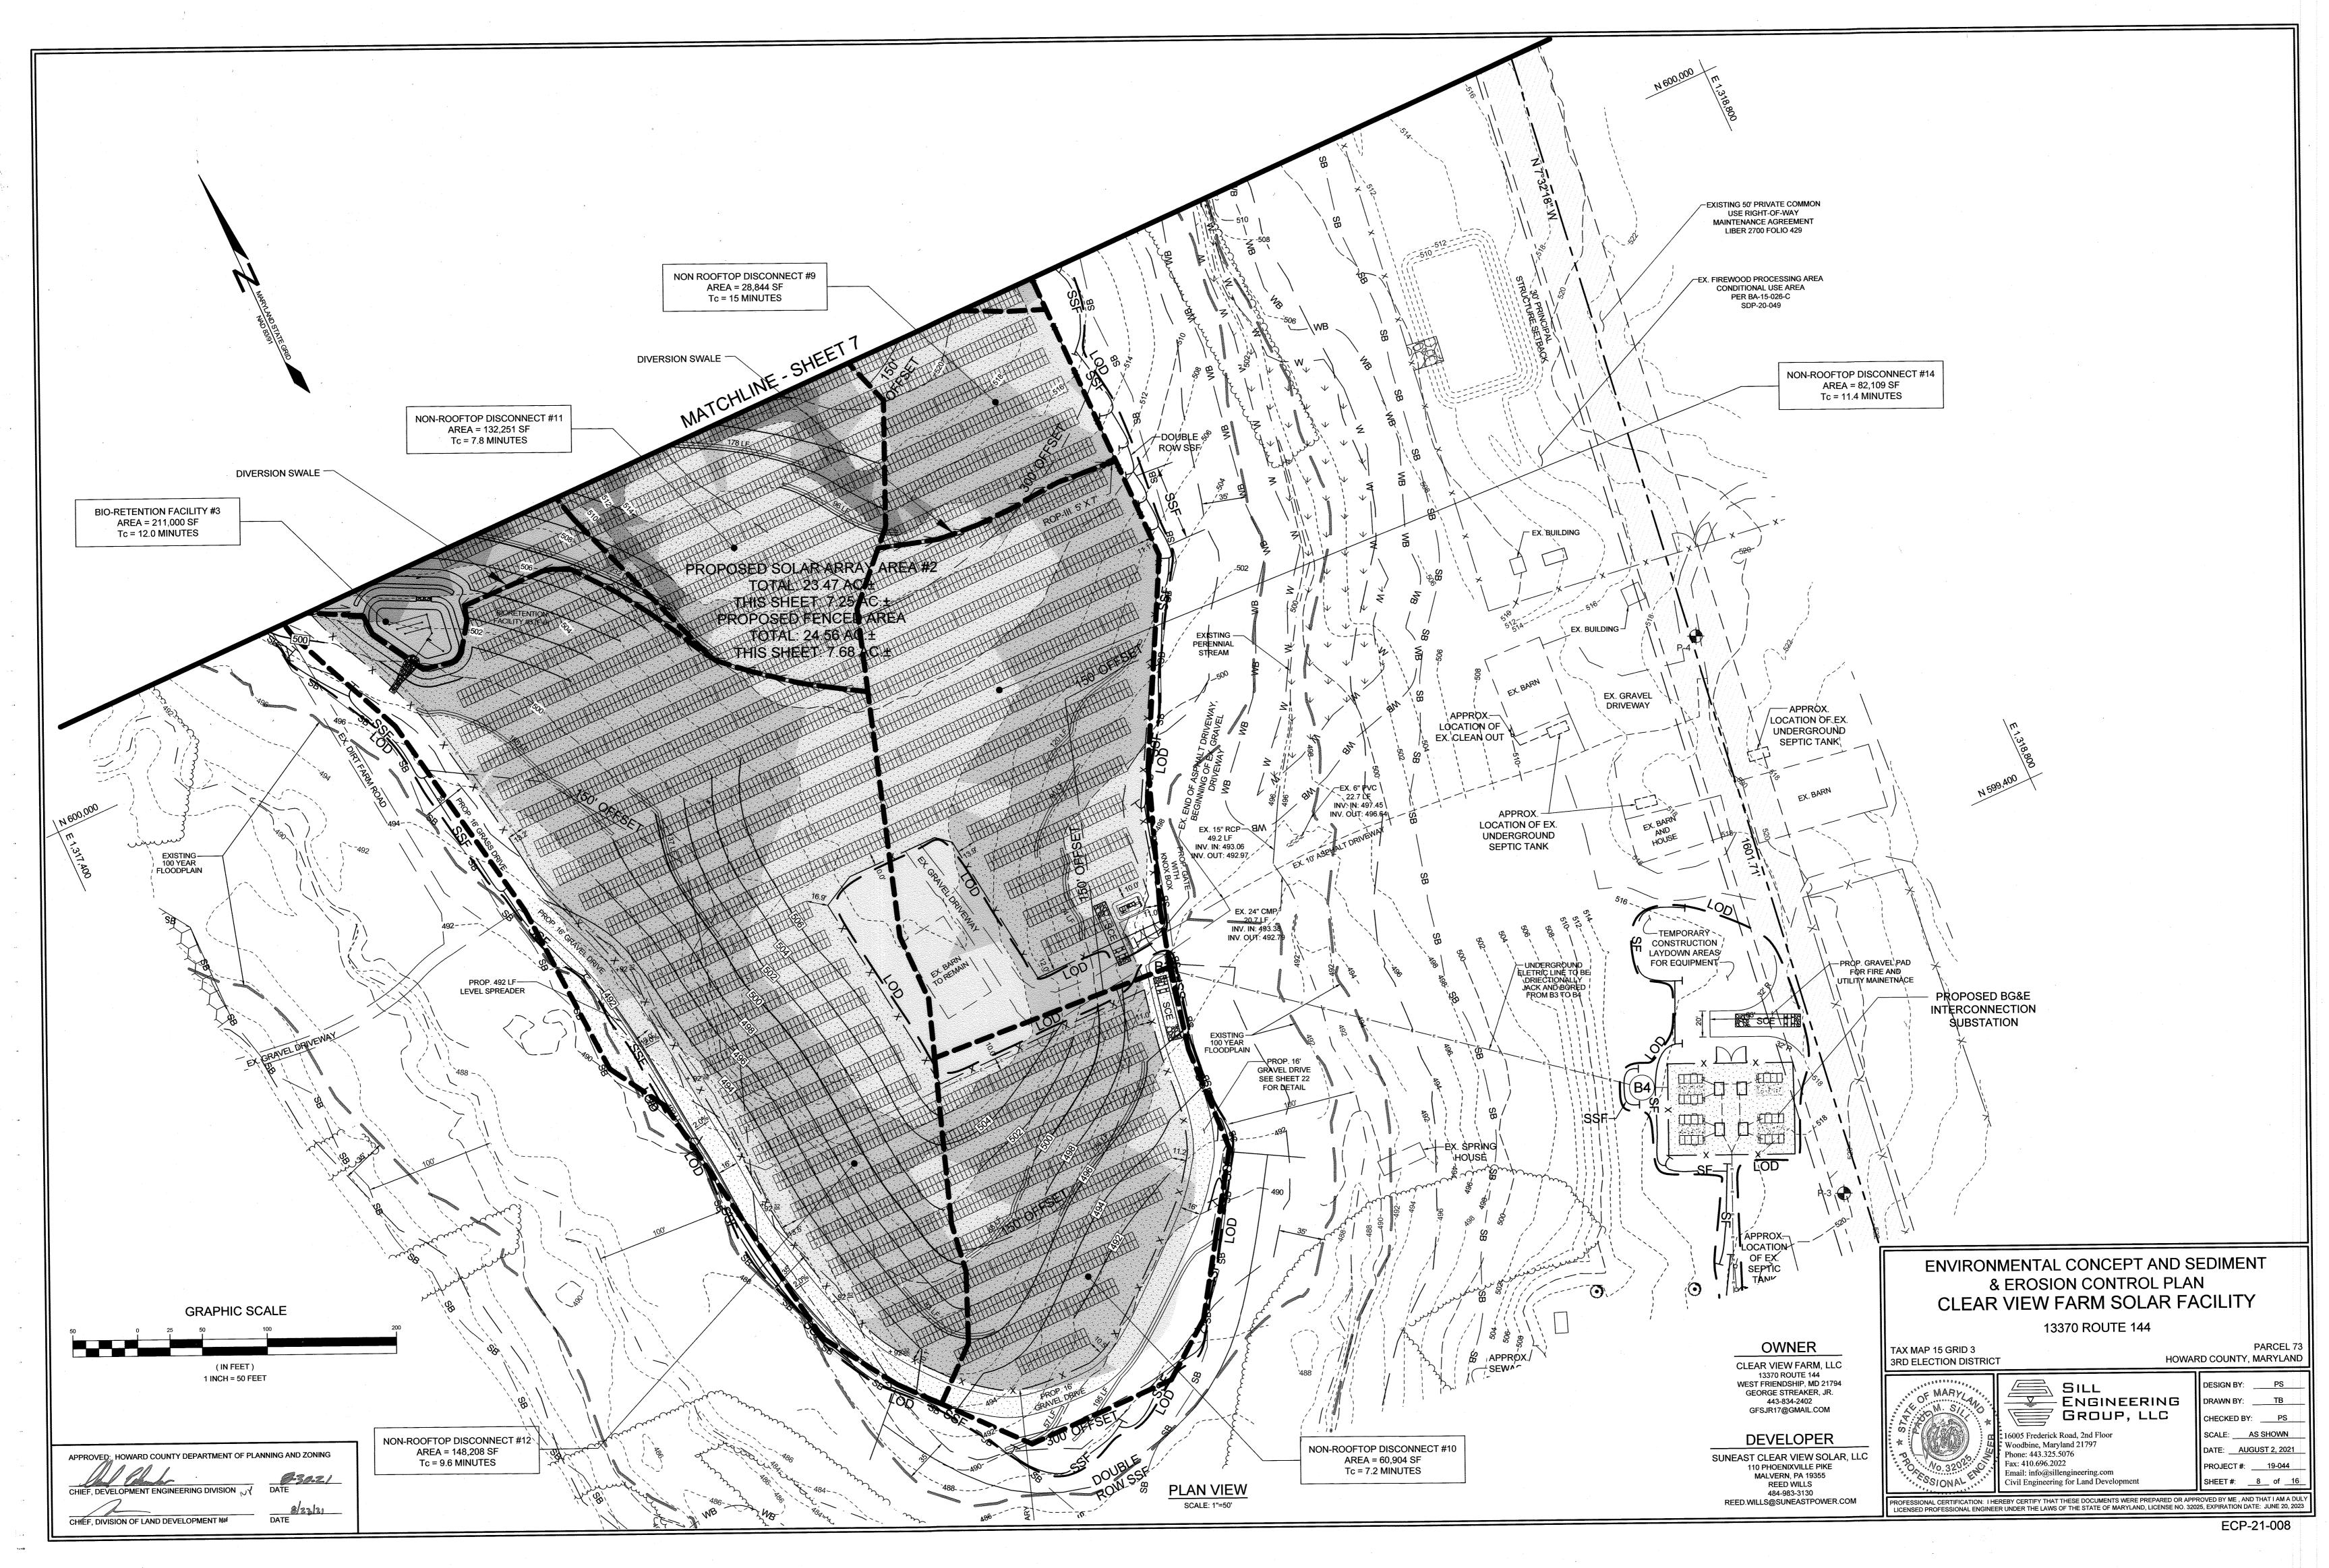


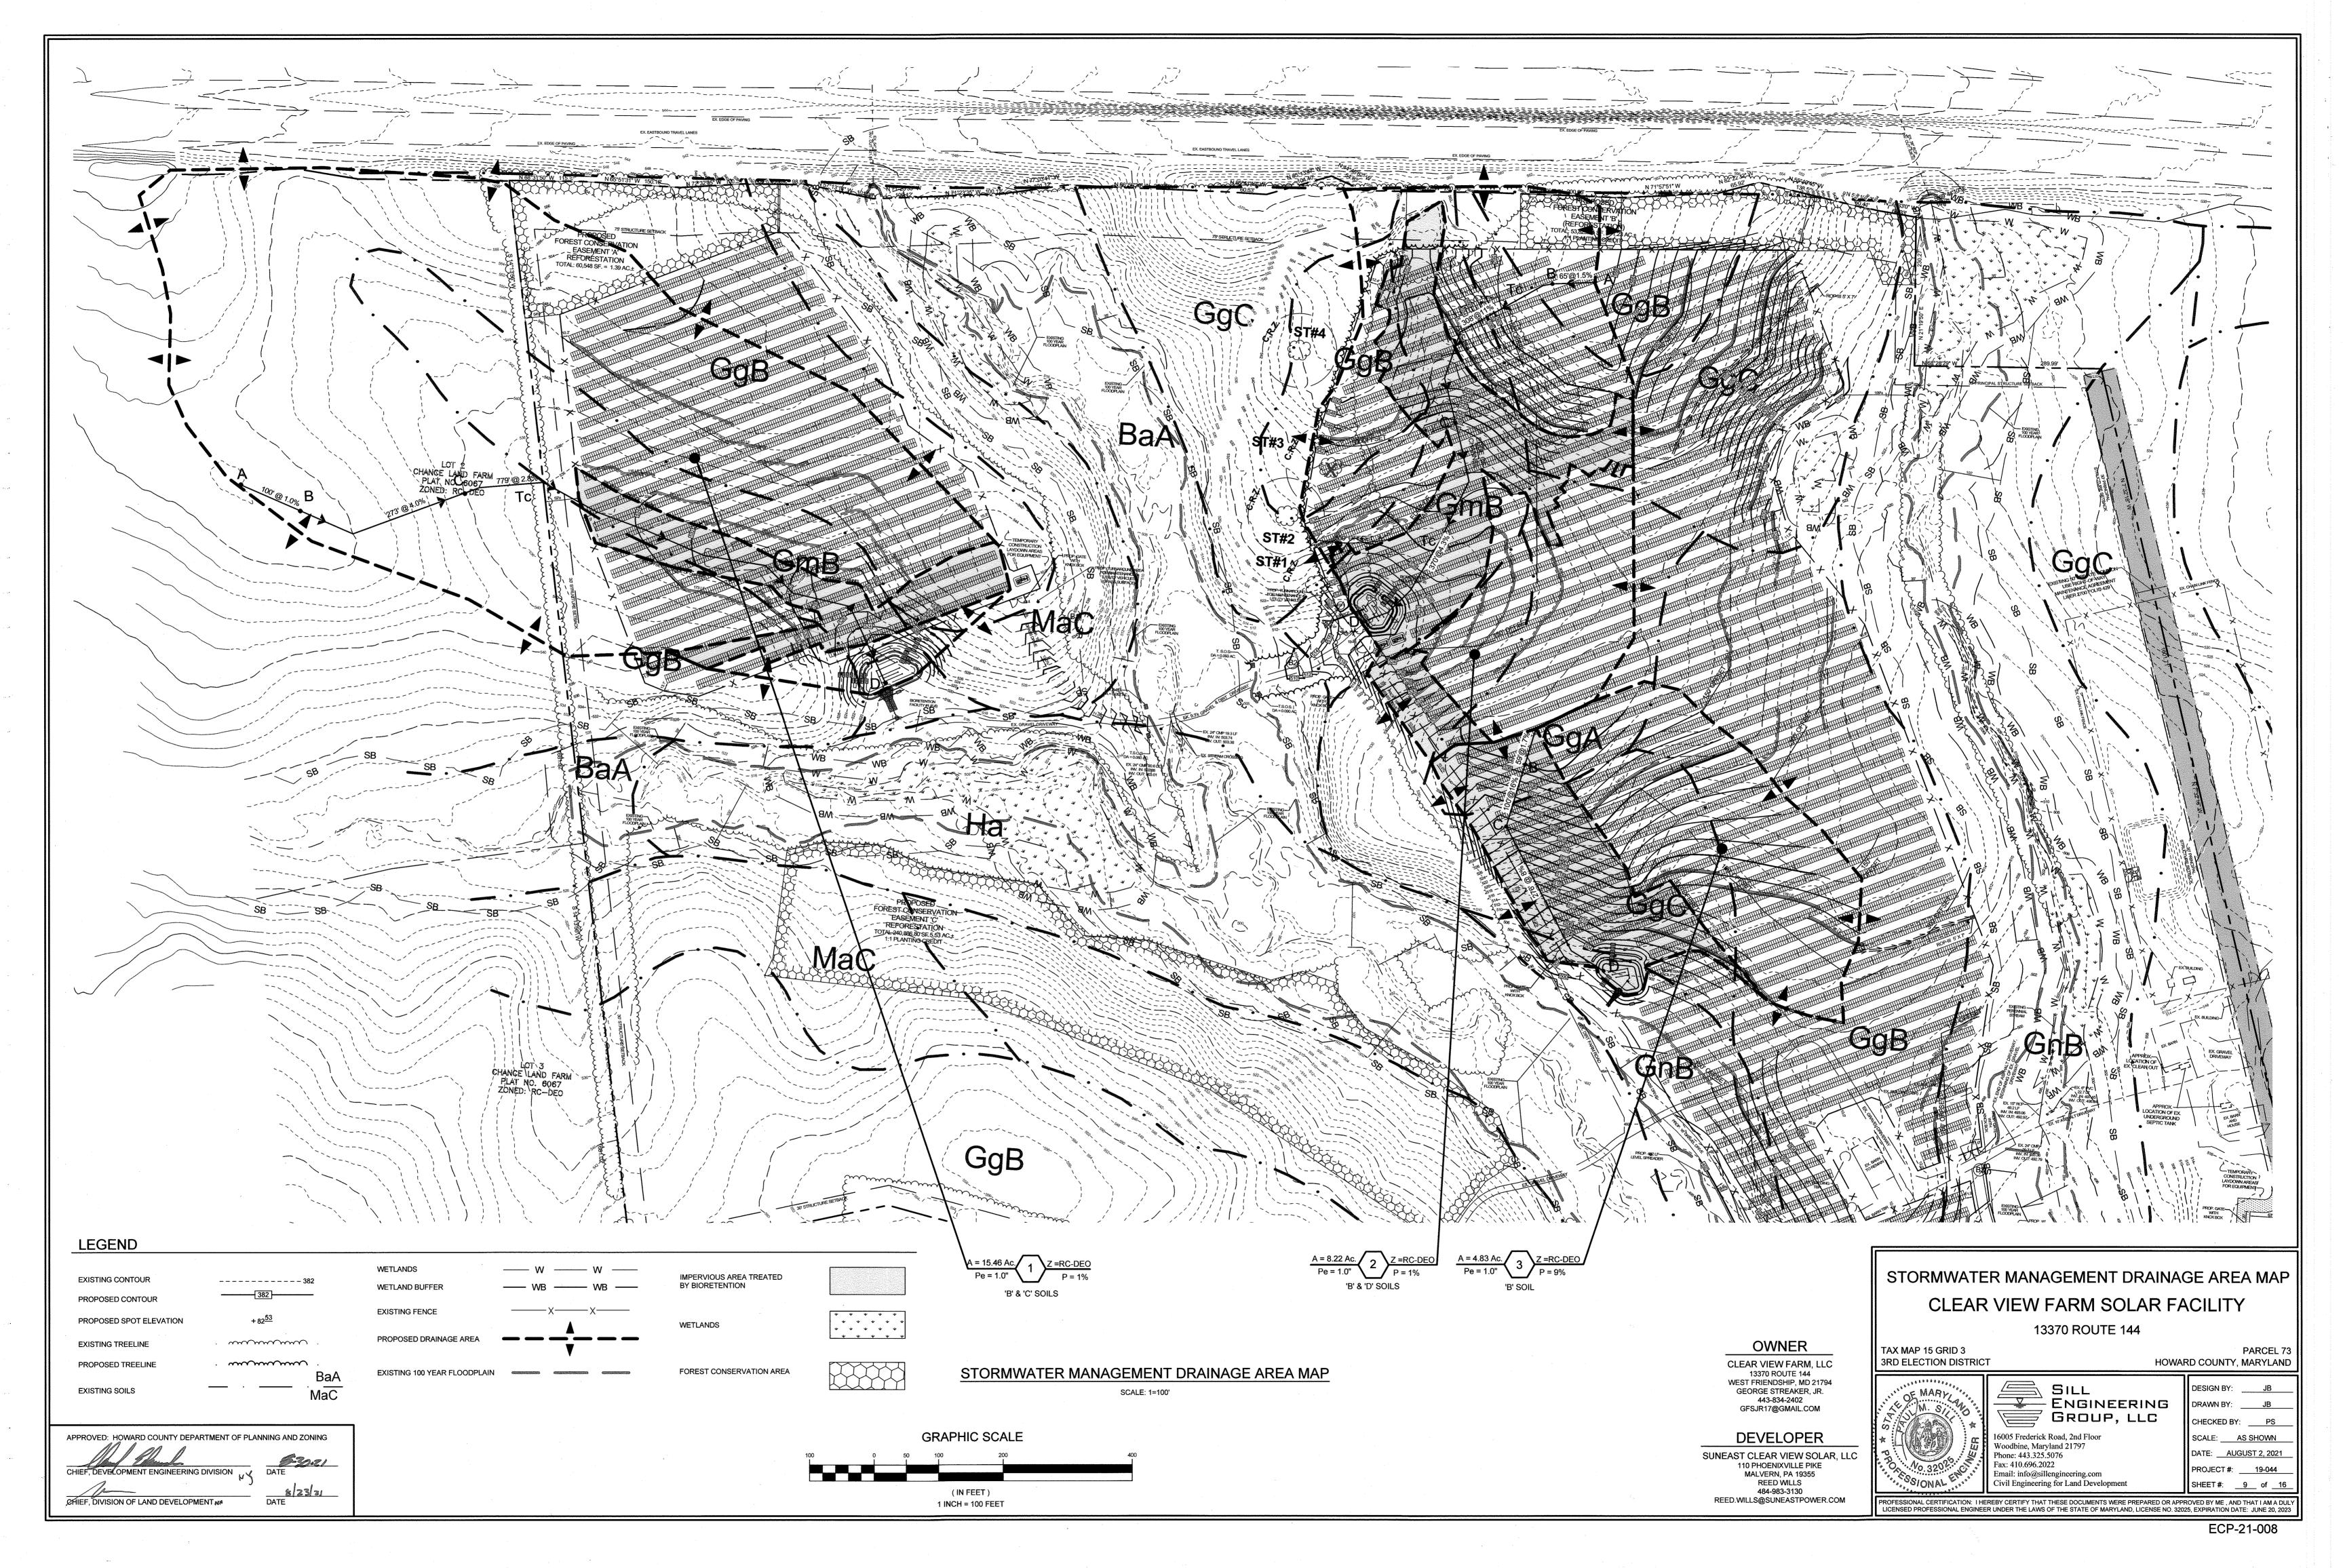

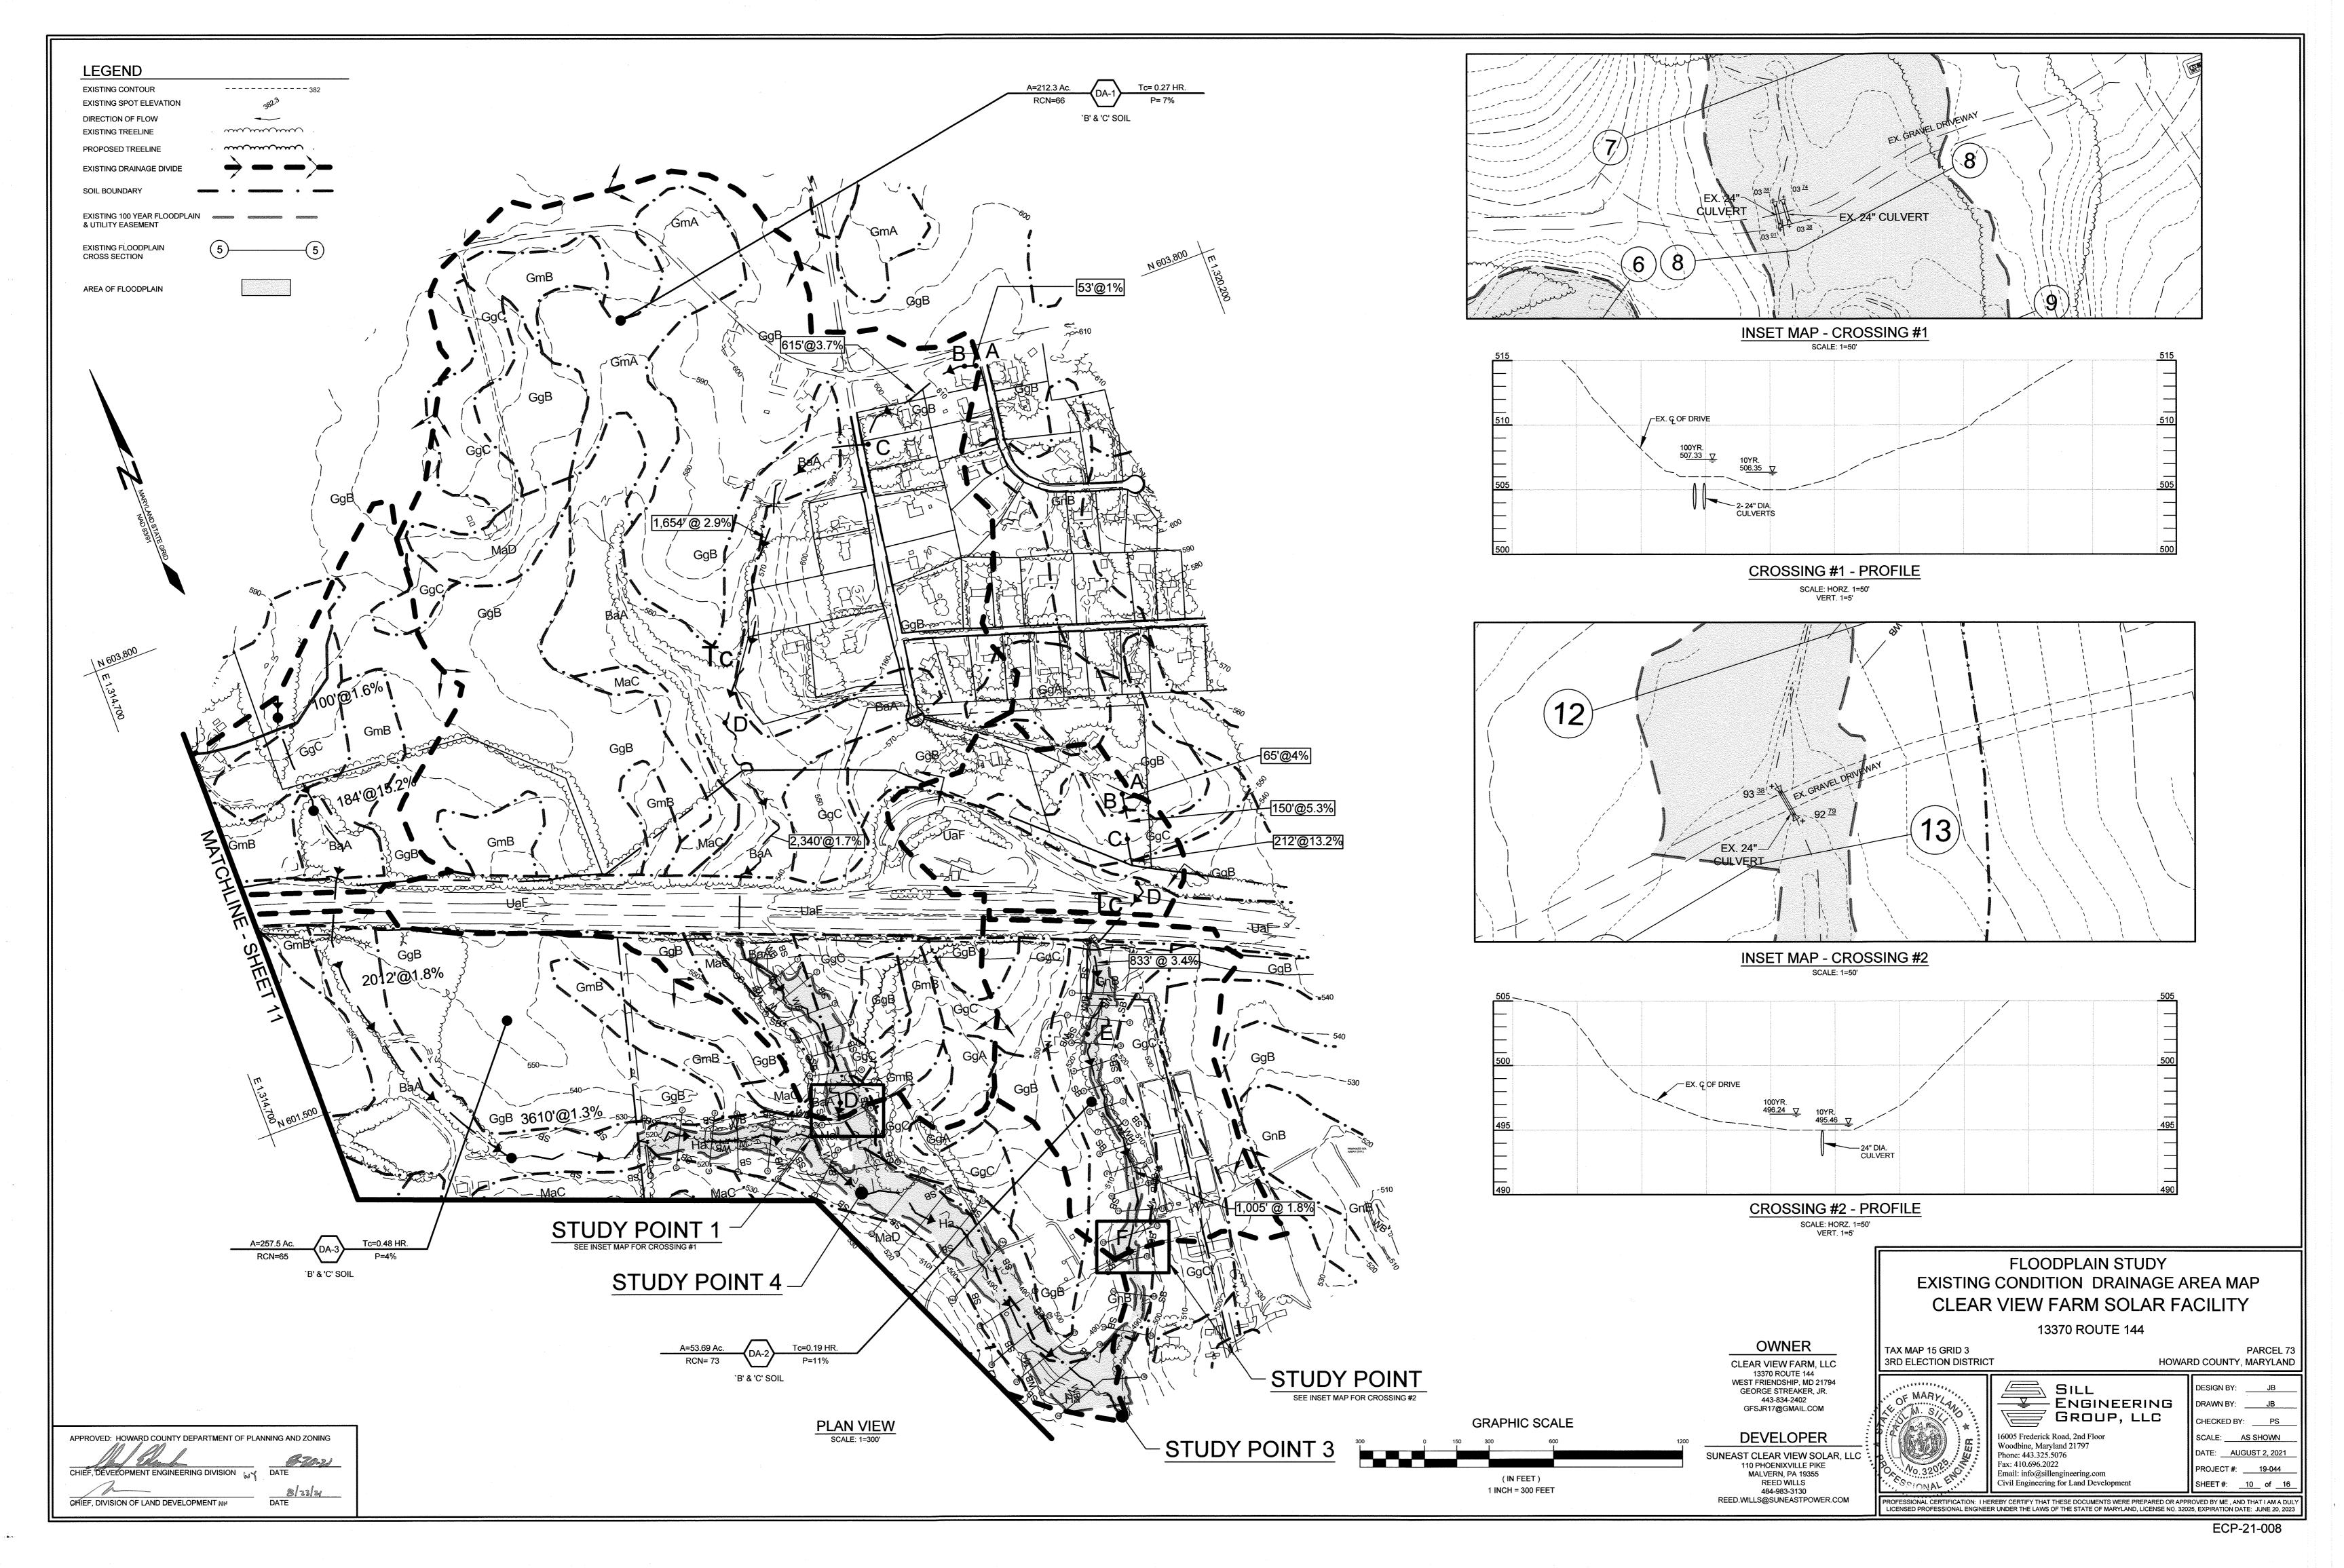

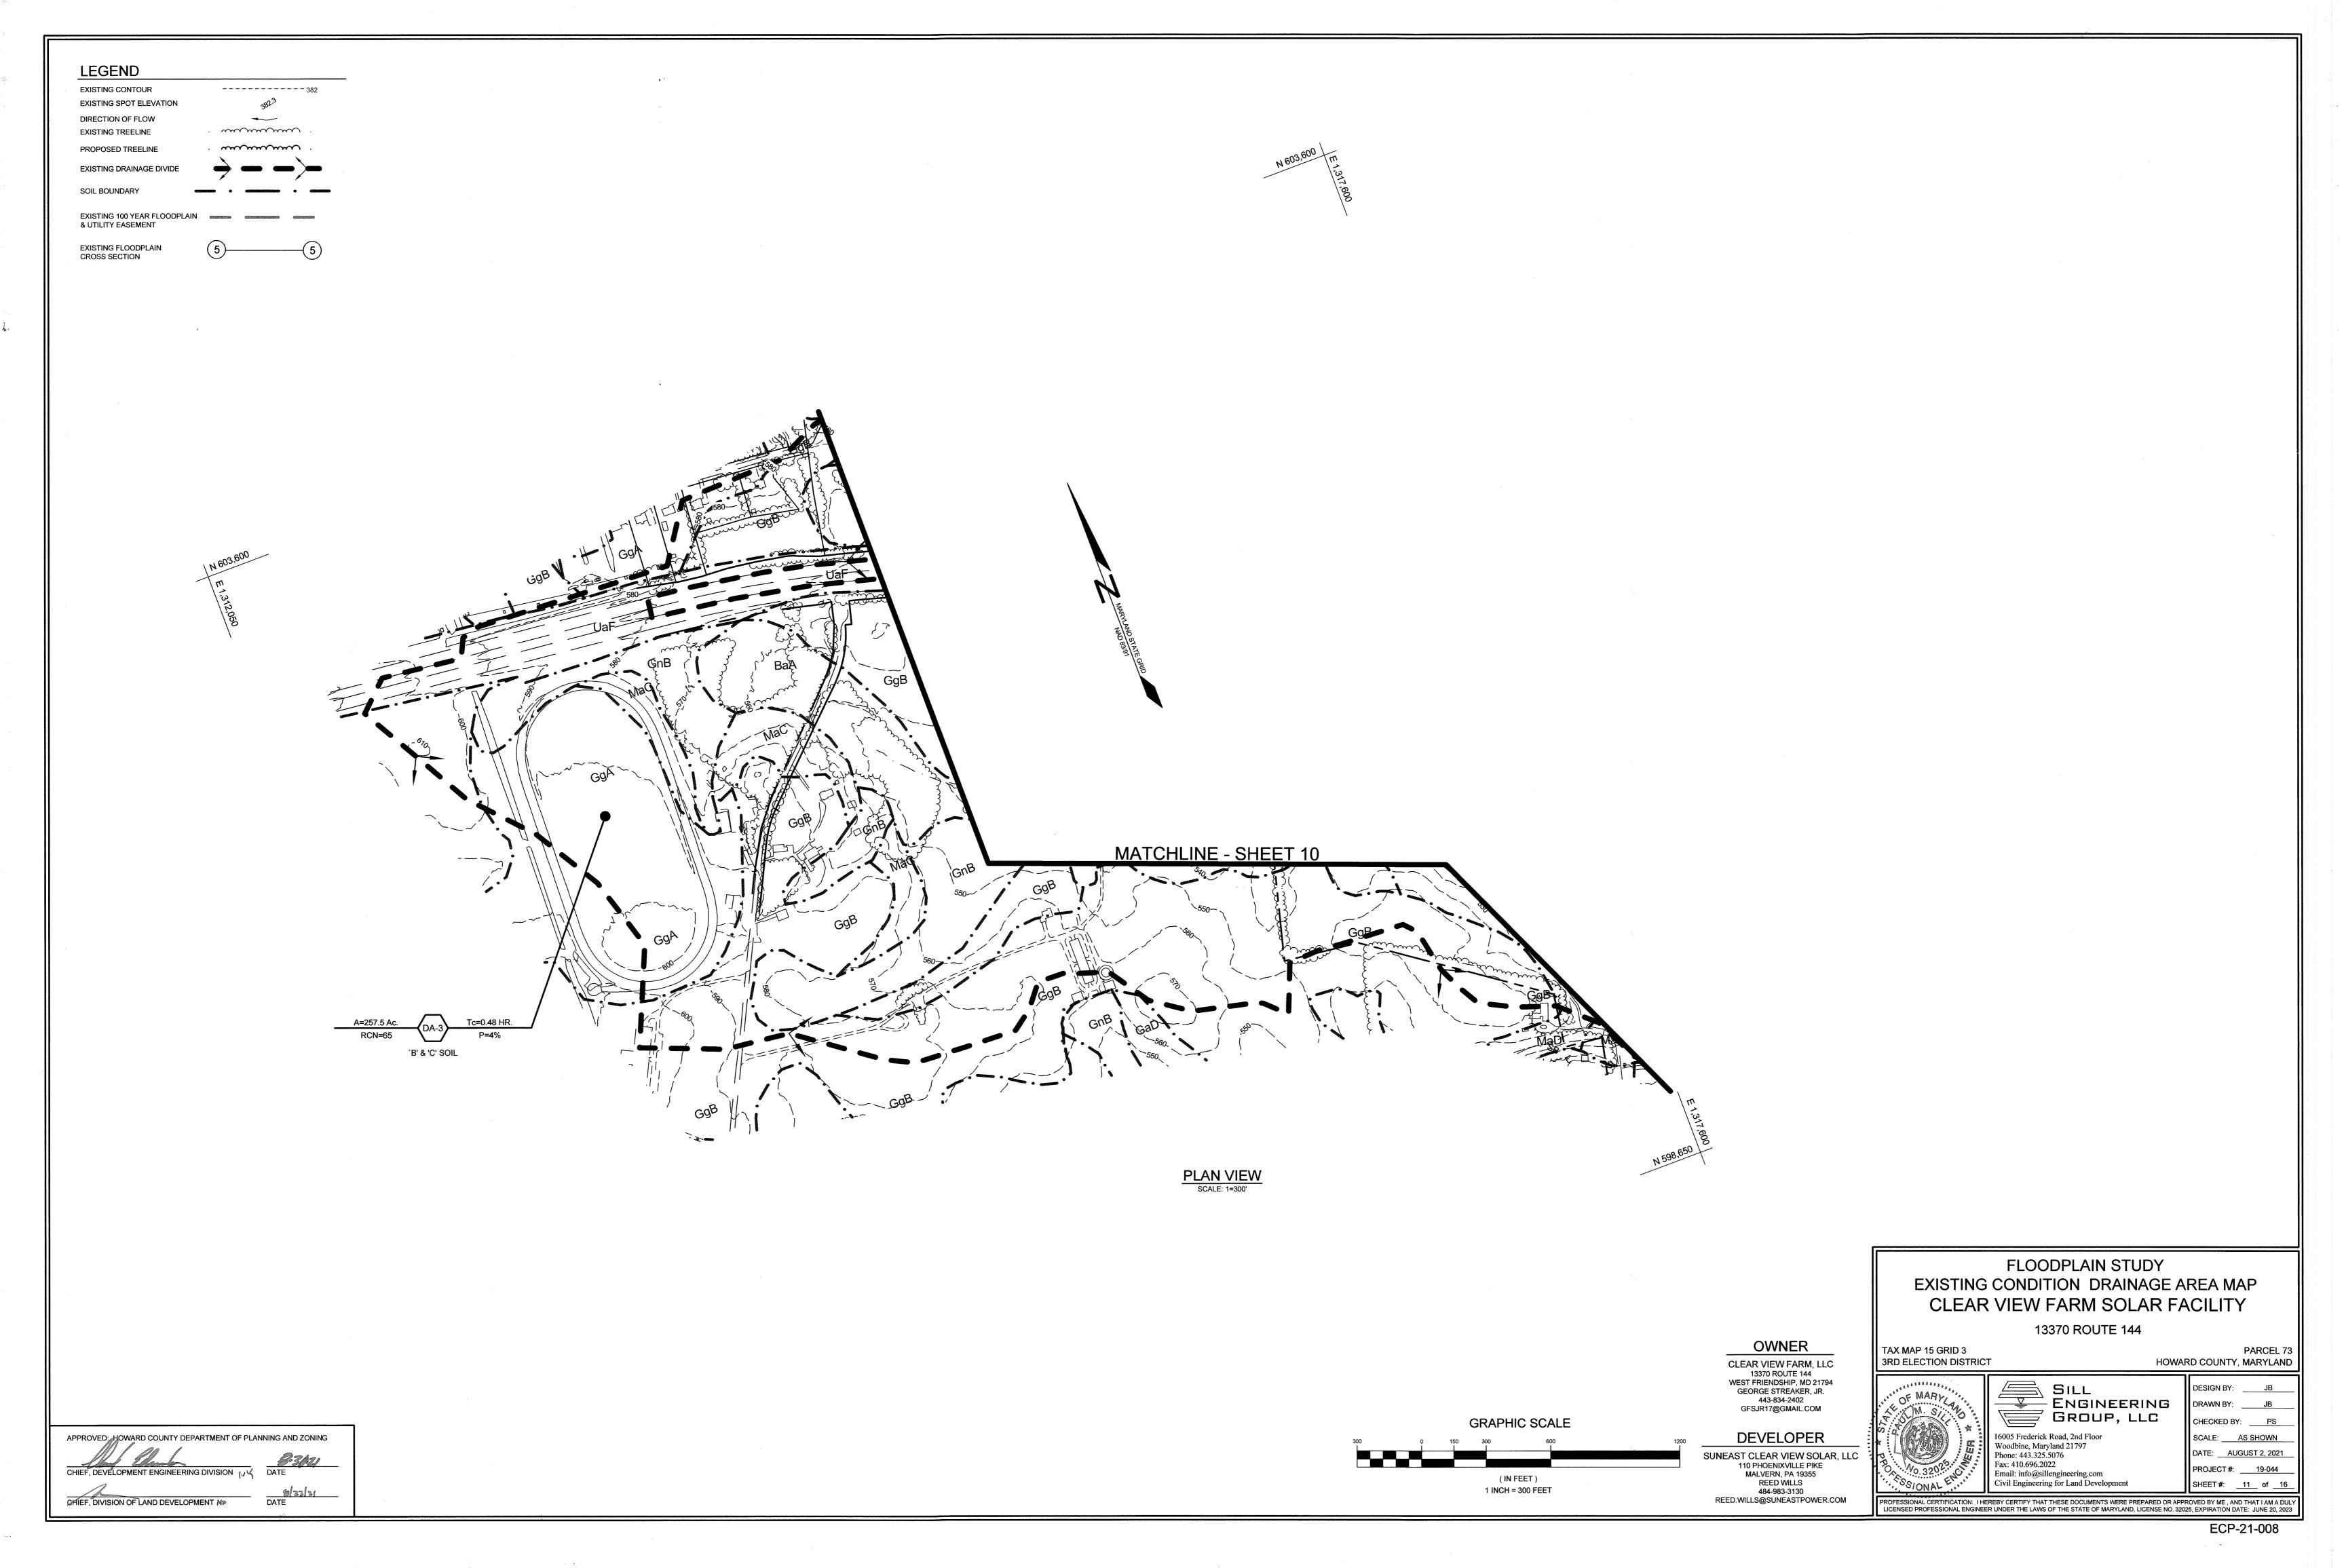

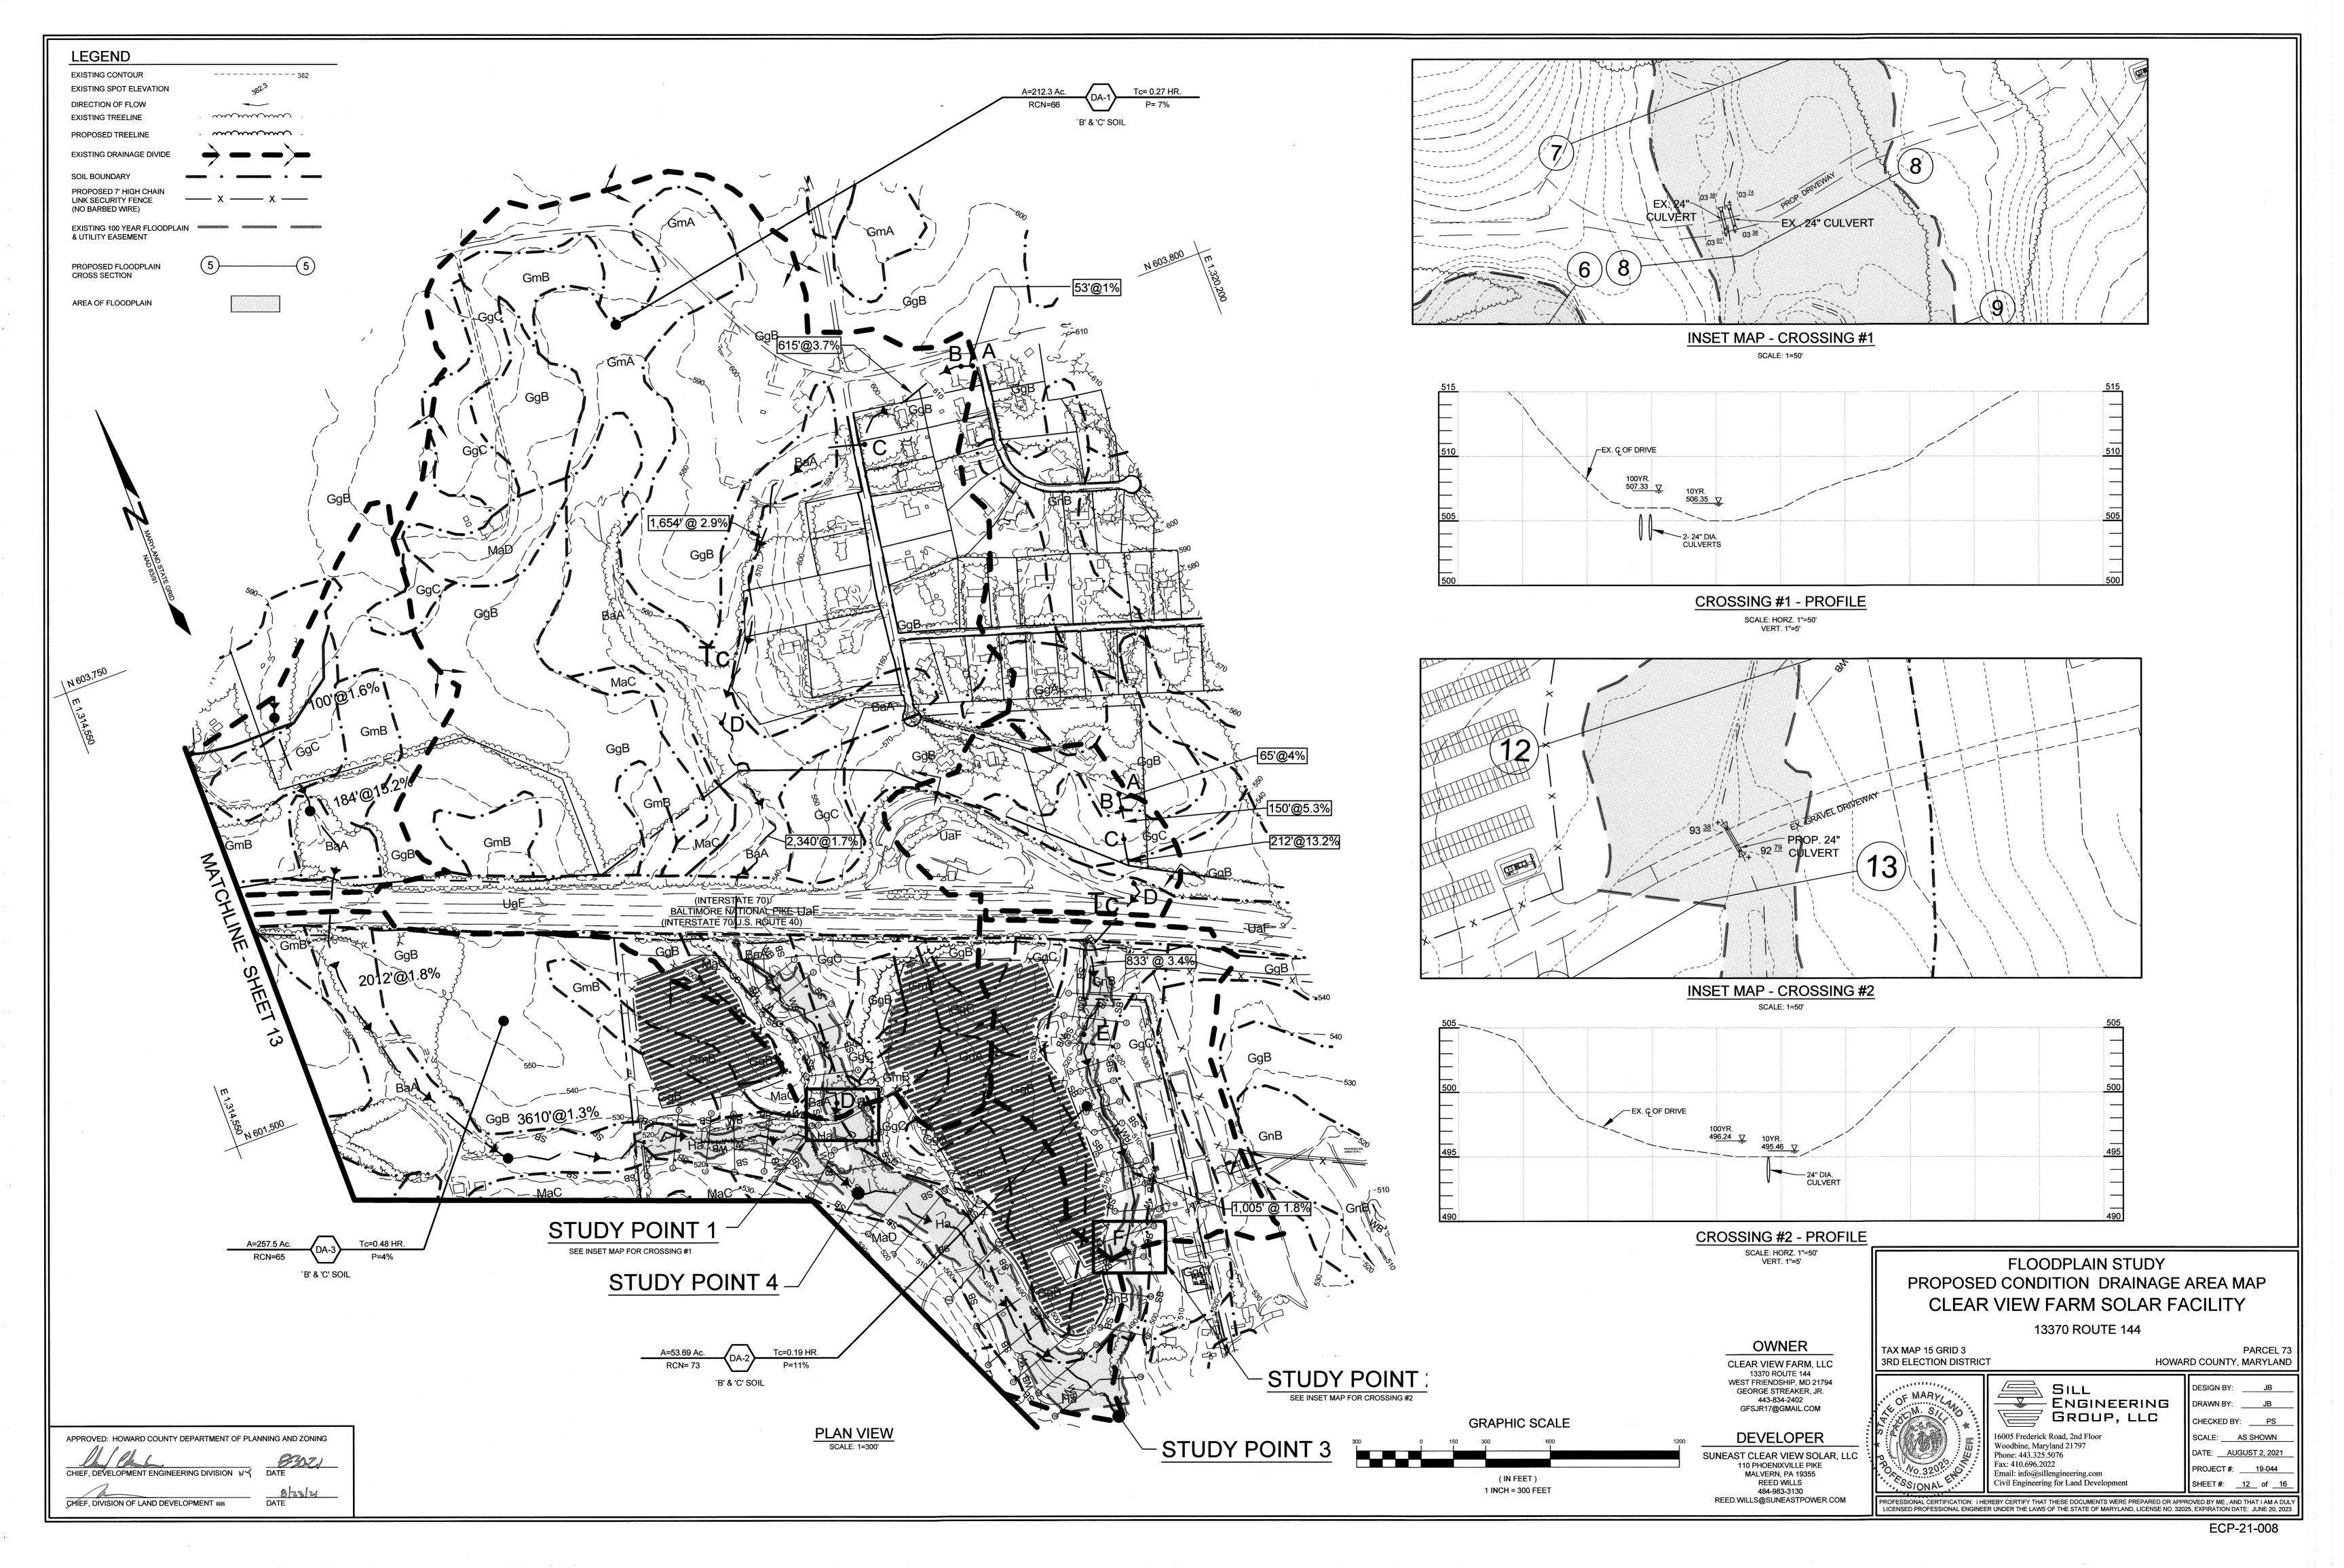

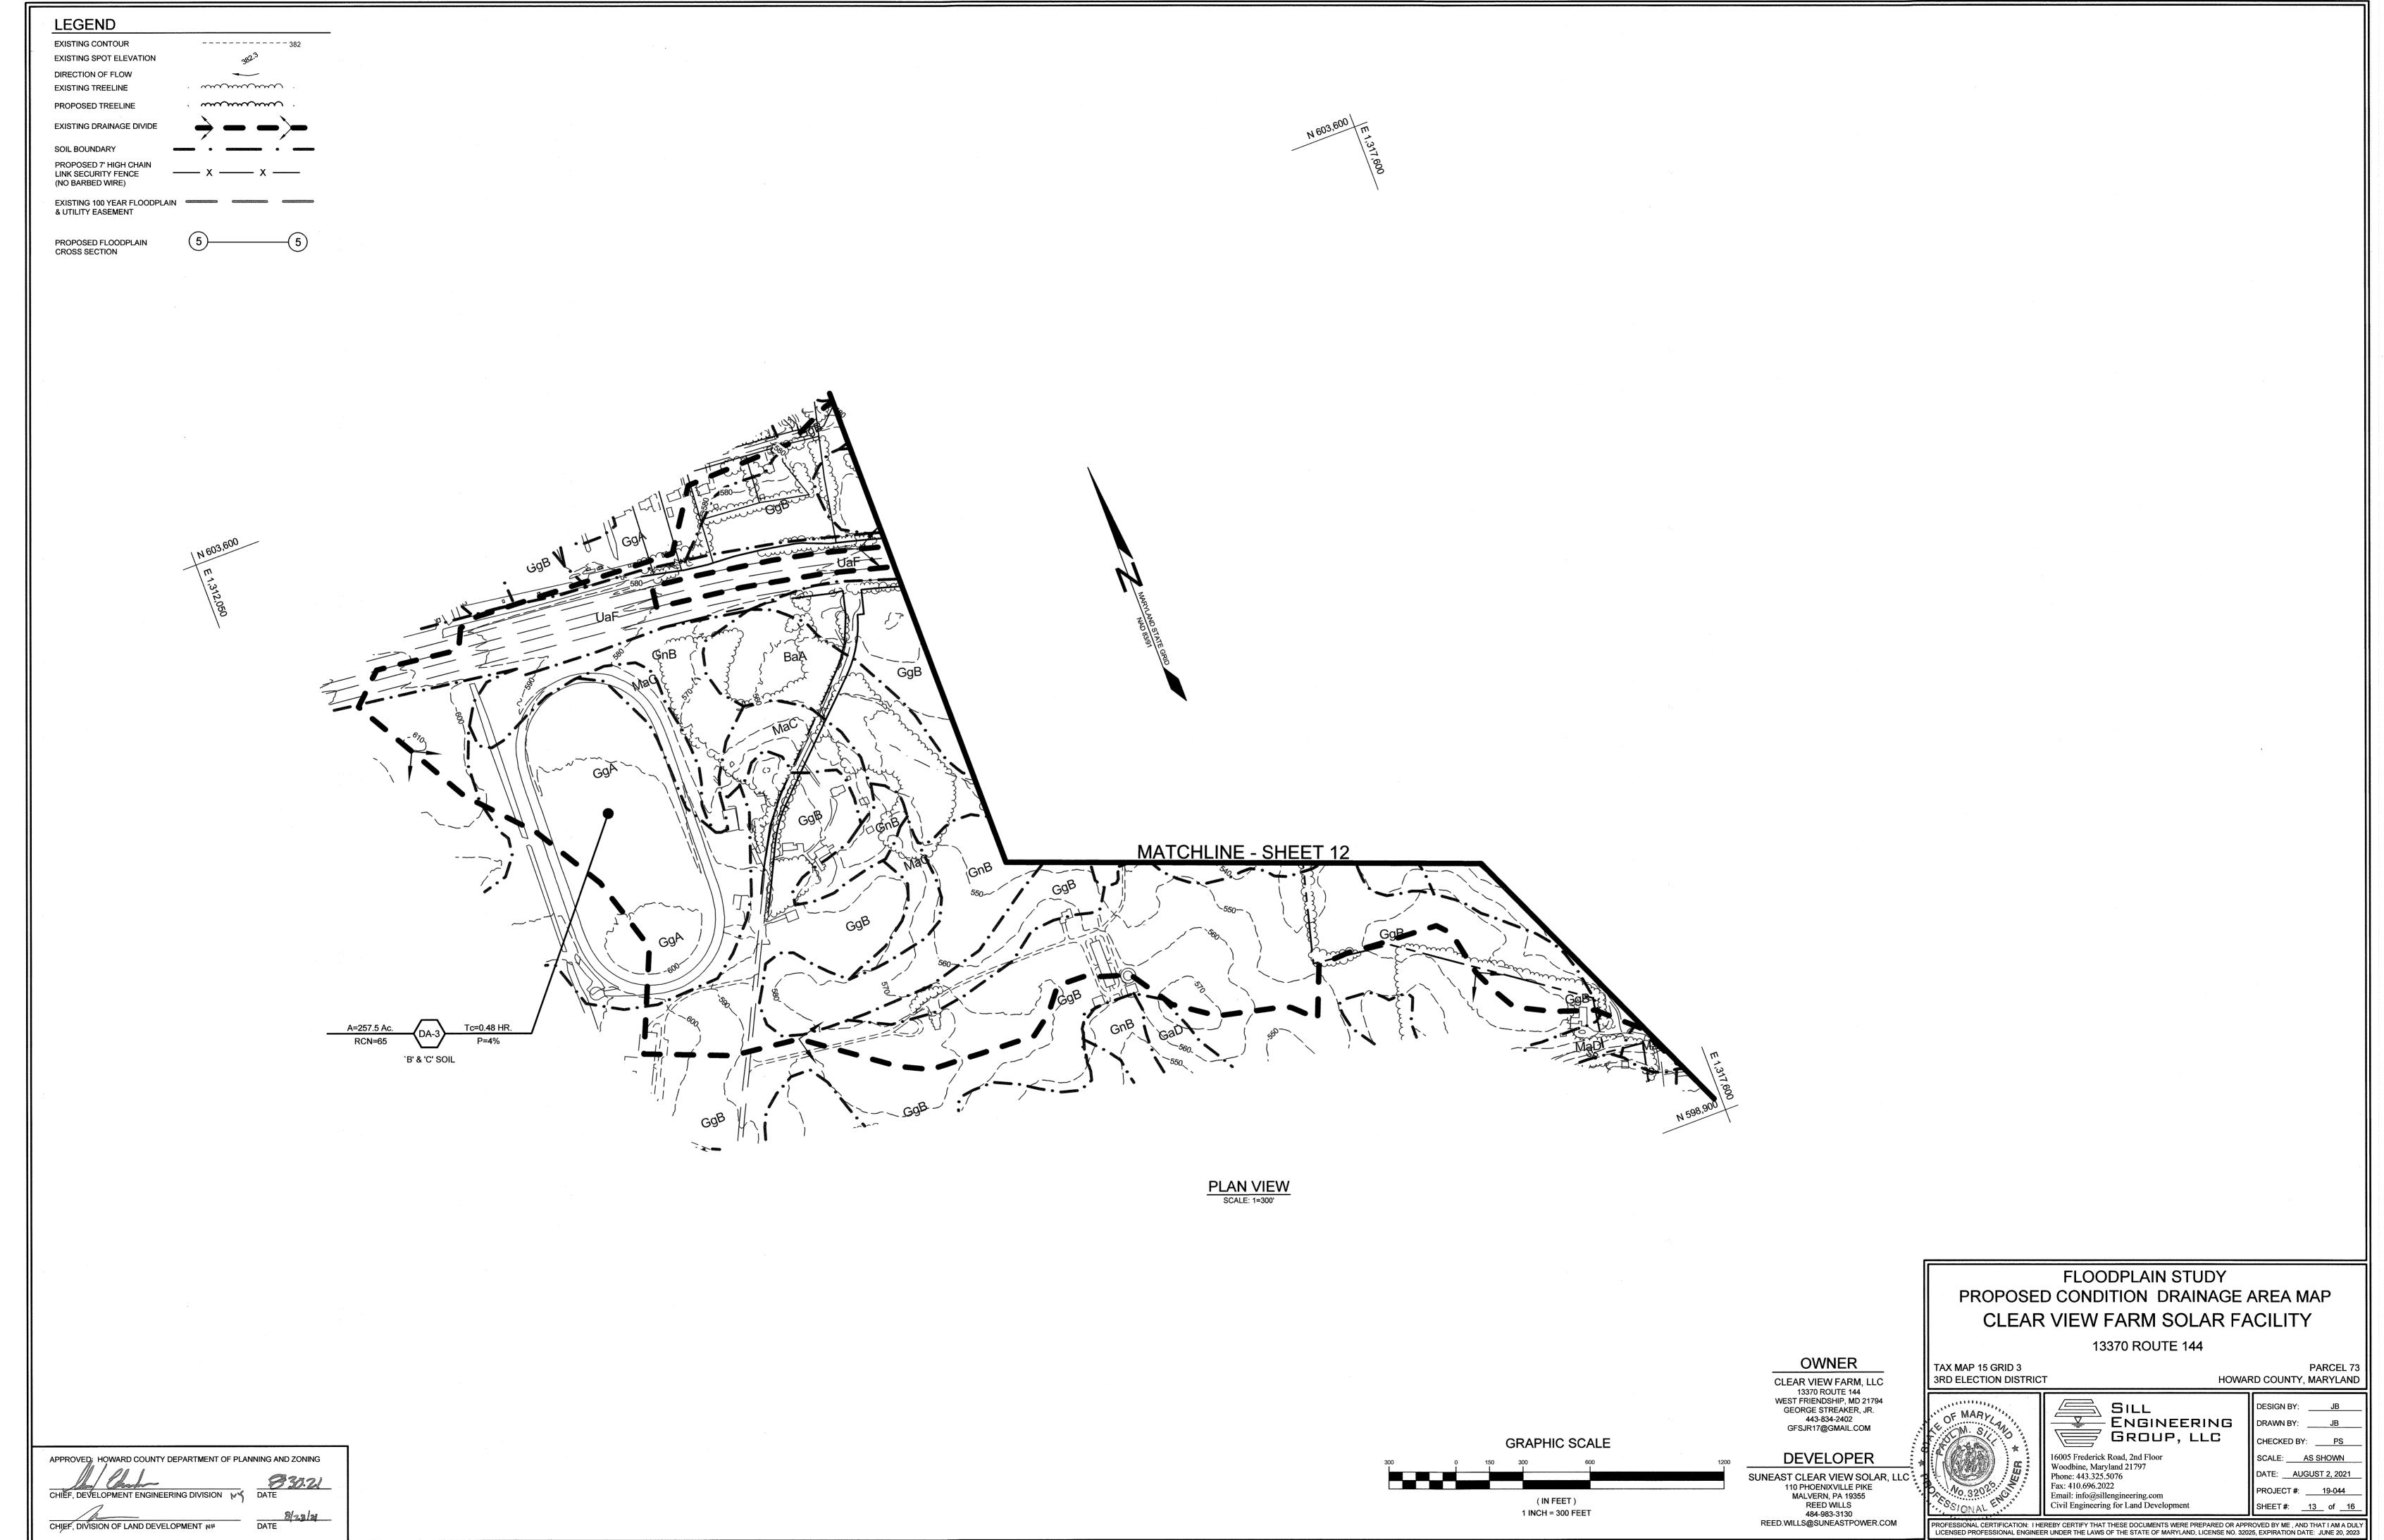

ECP-21-008

