#### **GENERAL NOTES**

- SUBJECT PROPERTY ZONED RC-DEO PER 10-06-2013 COMPREHENSIVE ZONING PLAN. DEED REFERENCE:
- LIBER 3999, FOLIO 580 PARCEL 146:

3. PREVIOUS HOWARD COUNTY FILE NUMBERS:

- 4. THE BOUNDARY SHOWN FOR PARCEL 146 WAS FIELD RUN BY SILL, ADCOCK & ASSOCIATES, LLC ON OR
- ABOUT MAY, 2006. THE BOUNDARY SHOWN FOR PARCEL 73 IS BASED ON TAX RECORD INFORMATION. & ASSOCIATES ON 8/17/2018. THE CONTOURS ARE SHOWN AT TWO-FOOT CONTOUR INTERVALS. ALL OTHER TOPOGRAPHY IS BASED OFF OF AERIAL TOPOGRAPHY FLOWN IN 2011.
- THERE ARE NO CEMETERIES WITHIN THE CONDITIONAL USE AREA.
- 8. EXISTING UTILITIES ARE LOCATED BY THE USE OF ANY OR ALL OF THE FOLLOWING: ROAD CONSTRUCTION PLANS, FIELD SURVEYS, PUBLIC WATER AND SEWER PLANS AND OTHER AVAILABLE RECORD DRAWINGS. APPROXIMATE LOCATION OF THE EXISTING UTILITIES ARE SHOWN FOR
- 9. DRIVEWAY(S) SHALL BE PROVIDED PRIOR TO ISSUANCE OF A USE AND OCCUPANCY PERMIT FOR ANY
- WIDTH 12 FEET (16 FEET SERVING MORE THAN ONE RESIDENCE) 2) SURFACE - SIX (6") INCHES OF COMPACTED CRUSHER RUN BASE WITH TAR AND CHIP COATING (1-1/2"
- GEOMETRY MAXIMUM 15% GRADE, MAXIMUM 10% GRADE CHANGE AND 45-FOOT TURNING RADIUS; 4) STRUCTURES (CULVERTS/BRIDGES) - CAPABLE OF SUPPORTING 25 GROSS TONS (H25-LOADING);
- 9. APPROVAL OF THE ECP DOES NOT CONSTITUTE APPROVALS OF SUBSEQUENT OR ASSOCIATED SITE DEVELOPMENT PLANS, SUBDIVISION PLANS, GRADING OR BUILDING PERMITS, PLAN REVISIONS OR FOREST CONSERVATION PLANS. THE APPLICANT AND CONSULTANT SHOULD EXPECT ADDITIONAL COMMENTS AS THE DEVELOPMENT PLAN PROGRESSES THROUGH THE PLAN REVIEW OR PERMIT
- 10. THE AREA CURRENTLY USED FOR FIREWOOD PROCESSING IS TO BE RELOCATED TO THE CONDITIONAL USE AREA AND RETURNED TO ITS NATURAL STATE.
- 11. PER CODE SECTION 16.1202(b)(2)(i), THIS DEVELOPMENT IS CONDITIONALLY EXEMPT FROM THE REQUIREMENTS OF SECTION 16.1200 OF THE HOWARD COUNTY CODE FOR FOREST CONSERVATION
- SHAPE, AND LOCATION, IT IS UNDERSTOOD THAT THIS SYSTEM HAS NOT BEEN DESIGNED AND THE ACTUAL DESIGN MAY CHANGE, ALTERING THE NUMBER OF UNITS ALLOCATED FOR THIS DEVELOPMENT 13. ON FEBRUARY 22, 2018, THE DECISION AND ORDER, BA 15-026C WAS GRANTED BY THE BOARD OF
- RC-DEO (RURAL CONSERVATION-DENSITY EXCHANGE OPTION OVERLAY) ZONING DISTRICT, IS HEREBY
- THE CONDITIONAL USE SHALL APPLY ONLY TO THE BULK FIREWOOD PROCESSING CONDITIONAL USE AS DESCRIBED IN THE PETITION AND AS DEPICTED ON THE REVISED CONDITIONAL USE PLAN SUBMITTED TO THE BOARD ON OCTOBER 27, 2016 AS PETITIONER'S
- BULK FIREWOOD PROCESSING CONDITIONAL USE TRUCK TRAFFIC IS LIMITED TO THE HOURS OF 8 A.M. TO 6 P.M. MONDAY THROUGH FRIDAY AND TO THE HOURS OF 8 A.M. TO 1 P.M. ON
- PROCESSING OF BULK FIREWOOD HOURS OF OPERATION MAY TAKE PLACE MONDAY THROUGH SATURDAY FROM 7 A.M. UNTIL 6 P.M.
- PETITIONER SHALL REMOVE THE PORTION OF THE EXISTING SHARD DRIVEWAY FROM LOT 1 AND RELOCATE SAID PORTION OF THE DRIVEWAY TO THE WEST AS PER PETITIONER'S EXHIBIT
- THE PETITIONER SHALL COMPLY WITH ALL APPLICABLE FEDERAL, STATE, AND COUNTY LAWS

#### STORMWATER MANAGEMENT **NOTES & DESIGN NARRATIVE**

BELOW IS A LIST TO DESCRIBE THE STORMWATER MANAGEMENT REQUIREMENTS AND ACHIEVEMENTS FOR THE SITE PER THE 2000 MARYLAND STORMWATER DESIGN MANUAL, VOLUMES I AND II, AS AMENDED BY THE STORMWATER MANAGEMENT ACT OF 2007.

- ENVIRONMENTALLY SENSITIVE AREAS HAVE BEEN AVOIDED
- TO THE GREATEST EXTENT PRACTICABLE THE NATURAL FLOW PATTERNS OF THE SITE HAVE BEEN MAINTAINED. THE DESIGN INCORPORATES THE LEAST IMPERVIOUS AREA POSSIBLE.
- SILT FENCES AND A SEDIMENT TRAP ARE USED AS SEDIMENT AND EROSION CONTROL. ESD PLANNING TECHNIQUES AND PRACTICES HAVE BEEN IMPLEMENTED TO THE MAXIMUM EXTENT
- PRACTICABLE, THROUGH USE OF A BIO RETENTION FACILITY (M-6) AND ROOFTOP (N-1) & NON-ROOFTOP (N-2)
- 6. NO DESIGN MANUAL WAIVERS OR WAIVER PETITIONS ARE BEING REQUESTED.

| BEARING & DISTANCE CHART |               |          |  |
|--------------------------|---------------|----------|--|
| TAG                      | BEARING       | DISTANCE |  |
| 1                        | N 72°37'37' W | 99.13'   |  |
| 2                        | N 68°32'24" W | 99.00'   |  |
| 3                        | N 57°13'48" W | 101.98'  |  |
| 4                        | N 71°24'9" W  | 100.12'  |  |
| 5                        | N 71°24'9" W  | 100.12'  |  |
| 6                        | N 77°4'15" W  | 101.12'  |  |
| 7                        | N 65°42'14" W | 60.63'   |  |
| 8                        | N 71°35'34" W | 150.21'  |  |
| 9                        | N 68°32'24" W | 200.00'  |  |
| 10                       | N 67°6'28" W  | 200.06'  |  |
| 11                       | N 71°58'25" W | 150.27'  |  |
| 12                       | N 64°50'54" W | 193.57'  |  |
| 13                       | S 56°17'27" E | 50.41'   |  |
| 14                       | S 59°43'44" E | 60.17'   |  |
| 15                       | S 59°45'9" E  | 14.16'   |  |
| 16                       | S 67°10'36" E | 24.67'   |  |
| 17                       | N 78°18'37" E | 100.78'  |  |
| 18                       | S 58°25'37" E | 49.91'   |  |
| 19                       | S 68°25'56" E | 98.90'   |  |
| 20                       | S 64°27'18" E | 98.85'   |  |
| 21                       | S 84°35'21" E | 104.98'  |  |
| 22                       | S 64°44'21" E | 49.56'   |  |
| 23                       | S 50°52'20" E | 50.97'   |  |
| 24                       | S 56°37'51" E | 99.82'   |  |
| 25                       | S 61°25'24" E | 49.49'   |  |
| 26                       | S 64°51'5" E  | 197.92'  |  |

APPROVED: HOWARD COUNTY DEPARTMENT OF PLANNING AND ZONING


HIEF, DEVELOPMENT ENGINEERING DIVISION LIX

CHIEF DIVISION OF LAND DEVELOPMENT,


|   |   | BEA | RING & DISTANCE ( | CHART   |
|---|---|-----|-------------------|---------|
| = |   | TAG | BEARING           | DISTANC |
| _ |   | 27  | S 70°17'7" E      | 150.03' |
|   |   | 28  | S 61°49'21" E     | 16.60'  |
|   |   | 29  | S 61°46'53" E     | 81.15'  |
|   |   | 30  | S 40°38'9" E      | 55.40'  |
|   |   | 31  | S 61°47'45" E     | 150.00' |
|   |   | 32  | S 78°29'42" E     | 52.20'  |
|   |   | 33  | S 56°5'7" E       | 100.50' |
|   |   | 34  | S 56°5'7" E       | 178.78' |
|   |   | 35  | S 18°47'3" E      | 56.64'  |
|   |   | 36  | S 0°28'53" E      | 94.97'  |
|   |   | 37  | S 9°43'15" E      | 164.83' |
|   |   | 38  | N 13°7'20" E      | 30.98'  |
|   | : | 39  | N 2°33'53" W      | 18.80'  |
|   | - | 40  | N 70°33'53" W     | 136.00' |
|   |   | 41  | S 70°48'53" E     | 118.00' |
|   |   | 42  | S 84°30'57" E     | 172.40' |
|   |   | 43  | S 84°30'57" E     | 172.40' |
|   |   | 44  | S 75°50'58" E     | 214.66' |
|   |   | 45  | S 80°45'16" E     | 113.12' |
|   |   | 46  | N 12°13'45" E     | 114.89' |
|   |   | 47  | N 14°9'43" E      | 98.69'  |
|   |   | 48  | N 13°12'9" E      | 24.84'  |
|   |   | 49  | N 21°3'1" E       | 21.14'  |
|   |   | 50  | N 19°28'32" E     | 19.03'  |
|   |   | 51  | N 4°55'7" E       | 158.57' |
|   |   | 52  | N 6°7'43" E       | 129.98' |
|   |   |     |                   |         |

# ENVIRONMENTAL CONCEPT PLAN STREAKER FIREWOOD

TAX MAP 9 PARCEL 73 TAX MAP 15 PARCEL 146

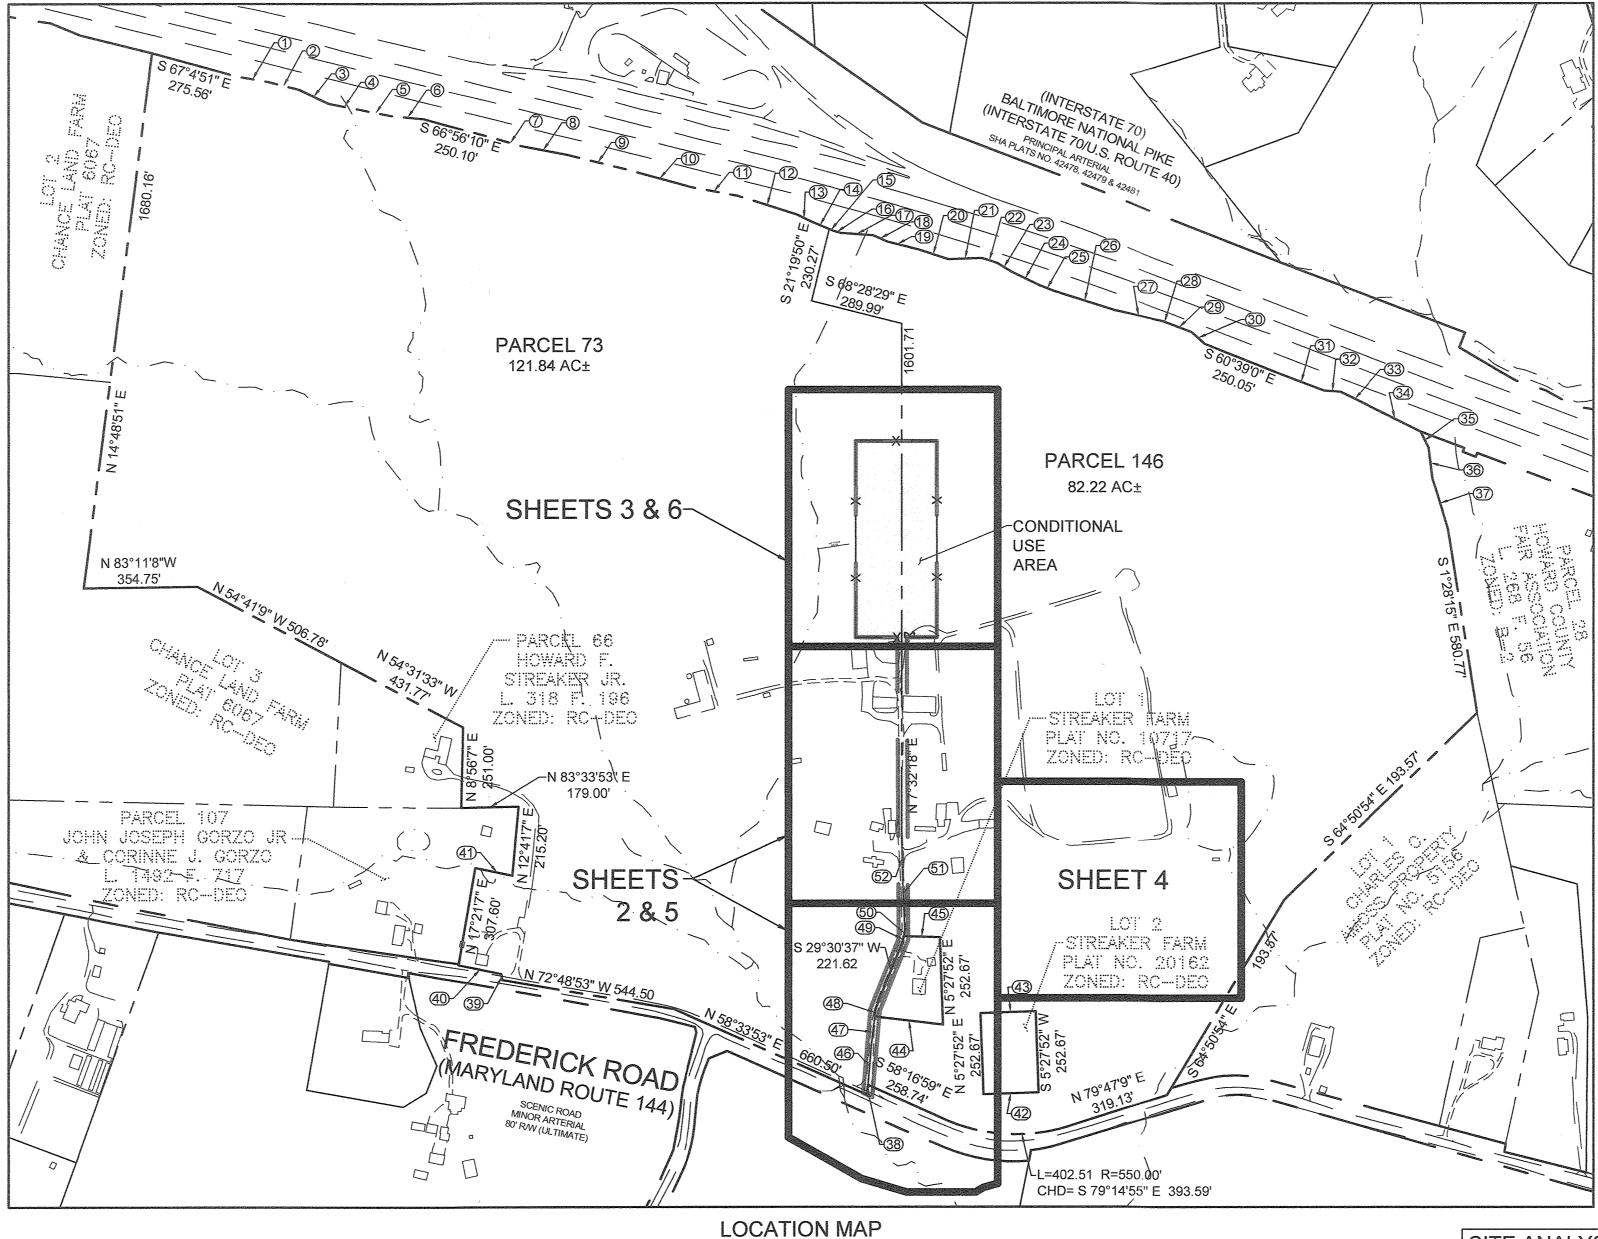

SCALE: 1"=300'

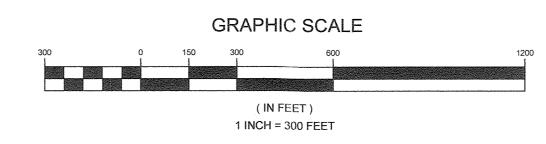


| SITE ANALYSIS I           | DATA SHEET               |
|---------------------------|--------------------------|
| ENVIRONMENTAL AREA        | SIZE OR USE (1)          |
| TOTAL PROJECT AREA        | 4.08 ACRES ±             |
| LIMIT OF DISTURBANCE      | 4.08 ACRES ±             |
| GREEN OPEN AREA (LAWN)    | 0 ACRES ±                |
| IMPERVIOUS AREA           | 0.07 ACRES ±             |
| PROPOSED SITE USES        | BULK FIREWOOD PROCESSING |
| WETLANDS                  | 0 SQ FT±*                |
| WETLAND BUFFERS           | 0 SQ FT±*                |
| FLOODPLAINS               | 0 SQ FT±                 |
| FLOODPLAIN BUFFERS        | 0 SQ FT±                 |
| EXISTING FOREST           | 0 SQ FT±                 |
| SLOPES GREATER THAN 15%   | 10,321 SQ FT±            |
| HIGHLY ERODIBLE SOILS (3) | 0.51 ACRES±              |

#### \* NONE WITHIN THE PROJECT AREA

- AREAS LISTED ABOVE ARE WITHIN THE CONDITIONAL USE AREA ONLY. 2. SOIL INFORMATION HAS BEEN TAKEN FROM THE UNITED STATES DEPARTMENT OF AGRICULTURE; NATURAL RESOURCES CONSERVATION SERVICE
- WEB SOIL SURVEY. 3. HIGHLY ERODIBLE SOILS ARE THOSE SOILS WITH A SLOPE GREATER THAN 15 PERCENT

| LEGEND                  |                    |
|-------------------------|--------------------|
| EXISTING CONTOUR        | 382                |
| PROPOSED CONTOUR        | 382                |
| EXISTING SPOT ELEVATION | 380.3              |
| PROPOSED SPOT ELEVATION | + 82 <sup>53</sup> |
| DIRECTION OF FLOW       |                    |
| EXISTING TREELINE       |                    |
| PROPOSED TREELINE       |                    |
| EXISTING SPECIMEN TREE  |                    |

**EXISTING WETLAND** 

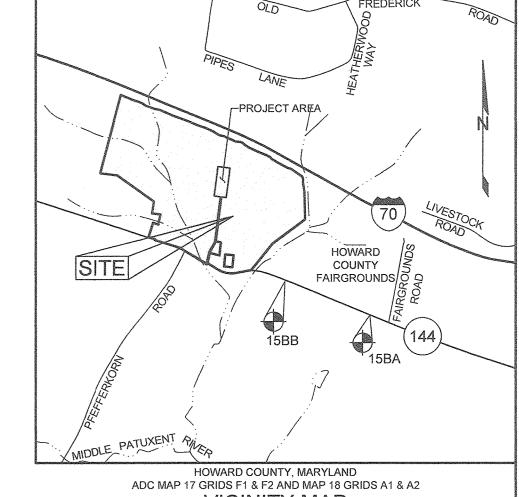

VICINITY MAP

| BENCHMARKS |              |                |           |  |
|------------|--------------|----------------|-----------|--|
| NUMBER     | NORTHING     | EASTING        | ELEVATION |  |
| 15BA       | 597,228.1254 | 1,321,719.2760 | 590.296'  |  |
| 15BB       | 597,926.9029 | 1,319,949.8262 | 527.586'  |  |

|        | ADDRESS CHART        |  |
|--------|----------------------|--|
| PARCEL | STREET ADDRESS       |  |
| 73     | 13370 FREDERICK ROAD |  |
| 146    | 13300 FREDERICK ROAD |  |
| 146    | 13300 FREDERICK ROAD |  |

|           | SHEET INDEX                       |
|-----------|-----------------------------------|
| SHEET NO. | DESCRIPTION                       |
| 1         | COVER SHEET                       |
| 2         | ENVIRONMENTAL CONCEPT PLAN        |
| 3         | ENVIRONMENTAL CONCEPT PLAN        |
| 4         | ENVIRONMENTAL CONCEPT PLAN        |
| 5         | SEDIMENT AND EROSION CONTROL PLAN |
| 6         | SEDIMENT AND EROSION CONTROL PLAN |
| 7         | BIORETENTION FACILITY DETAILS     |

| SOILS LEGEND |   |       |            |
|--------------|---|-------|------------|
| SYMBOL       | NAME / DESCRIPTION  | GROUP | 'K' FACTOR |
| GgA          | GLENELG LOAM, 0 TO 3 PERCENT SLOPES                         | В     | 0.37       |
| GgB          | GLENELG LOAM, 3 TO 8 PERCENT SLOPES                         | В     | 0.37       |
| GgC          | GLENELG LOAM, 8 TO 15 PERCENT SLOPES                        | В     | 0.43       |
| GmB          | GLENVILLE SILT LOAM, 3 TO 8 PERCENT SLOPES                  | C/D   | 0.55       |
| GnB          | GLENVILLE-BAILE SILT LOAMS, 0 TO 8 PERCENT SLOPES           | С     | 0.49       |
| MaD          | MANOR LOAM, 15 TO 25% SLOPES                                | В     | 0.32       |
| Ha           | HATBORO-CODORUS SILT LOAMS, 0 TO 3 PERCENT SLOPES           | B/D   | 0.43       |
| MkF          | MANOR-BRINKLOW COMPLEX, 25 TO 65 PERCENT SLOPES, VERY ROCKY | В     | 0.32       |

1) SOIL INFORMATION HAS BEEN TAKEN FROM THE UNITED STATES DEPARTMENT OF AGRICULTURE; NATURAL RESOURCES CONSERVATION SERVICE; WEB SOIL SURVEY. 2) HIGHLY ERODIBLE SOILS ARE THOSE SOILS WITH A SLOPE GREATER THAN 15 PERCENT OR THOSE SOILS WITH A SOIL ERODIBILITY FACTOR 'K' GREATER THAN 0.35 AND WITH A SLOPE GREATER THAN 5 PERCENT.

### OWNER/DEVELOPER

HOWARD F STREAKER, JR WEST FRIENDSHIP, MD 21794

#### **COVER SHEET**

#### STREAKER FIREWOOD

13370 & 13300 FREDERICK ROAD

TAX MAP 9 GRID 3 & TAX MAP 15 GRID 3

3RD ELECTION DISTRICT



DESIGN BY: MPO ENGINEERING DRAWN BY: MPO GROUP, LLC CHECKED BY: PS

SCALE: AS SHOWN DATE: DECEMBER 10, 2019 Phone: 443.325.5076 Fax: 410.696.2022 PROJECT#: 18-053 Email: info@sillengineering.com Civil Engineering for Land Development SHEET#: \_\_1\_\_ of \_\_7\_


ROFESSIONAL CERTIFICATION: 1 HEREBY CERTIFY THAT THESE DOCUMENTS WERE PREPARED OR APPROVED BY ME , AND THAT I AM A DULY

ICENSED PROFESSIONAL ENGINEER UNDER THE LAWS OF THE STATE OF MARYLAND, LICENSE NO. 32025, EXPIRATION DATE: JUNE 20, 202

ECP-19-039

PARCELS 73 & 176

HOWARD COUNTY, MARYLAND

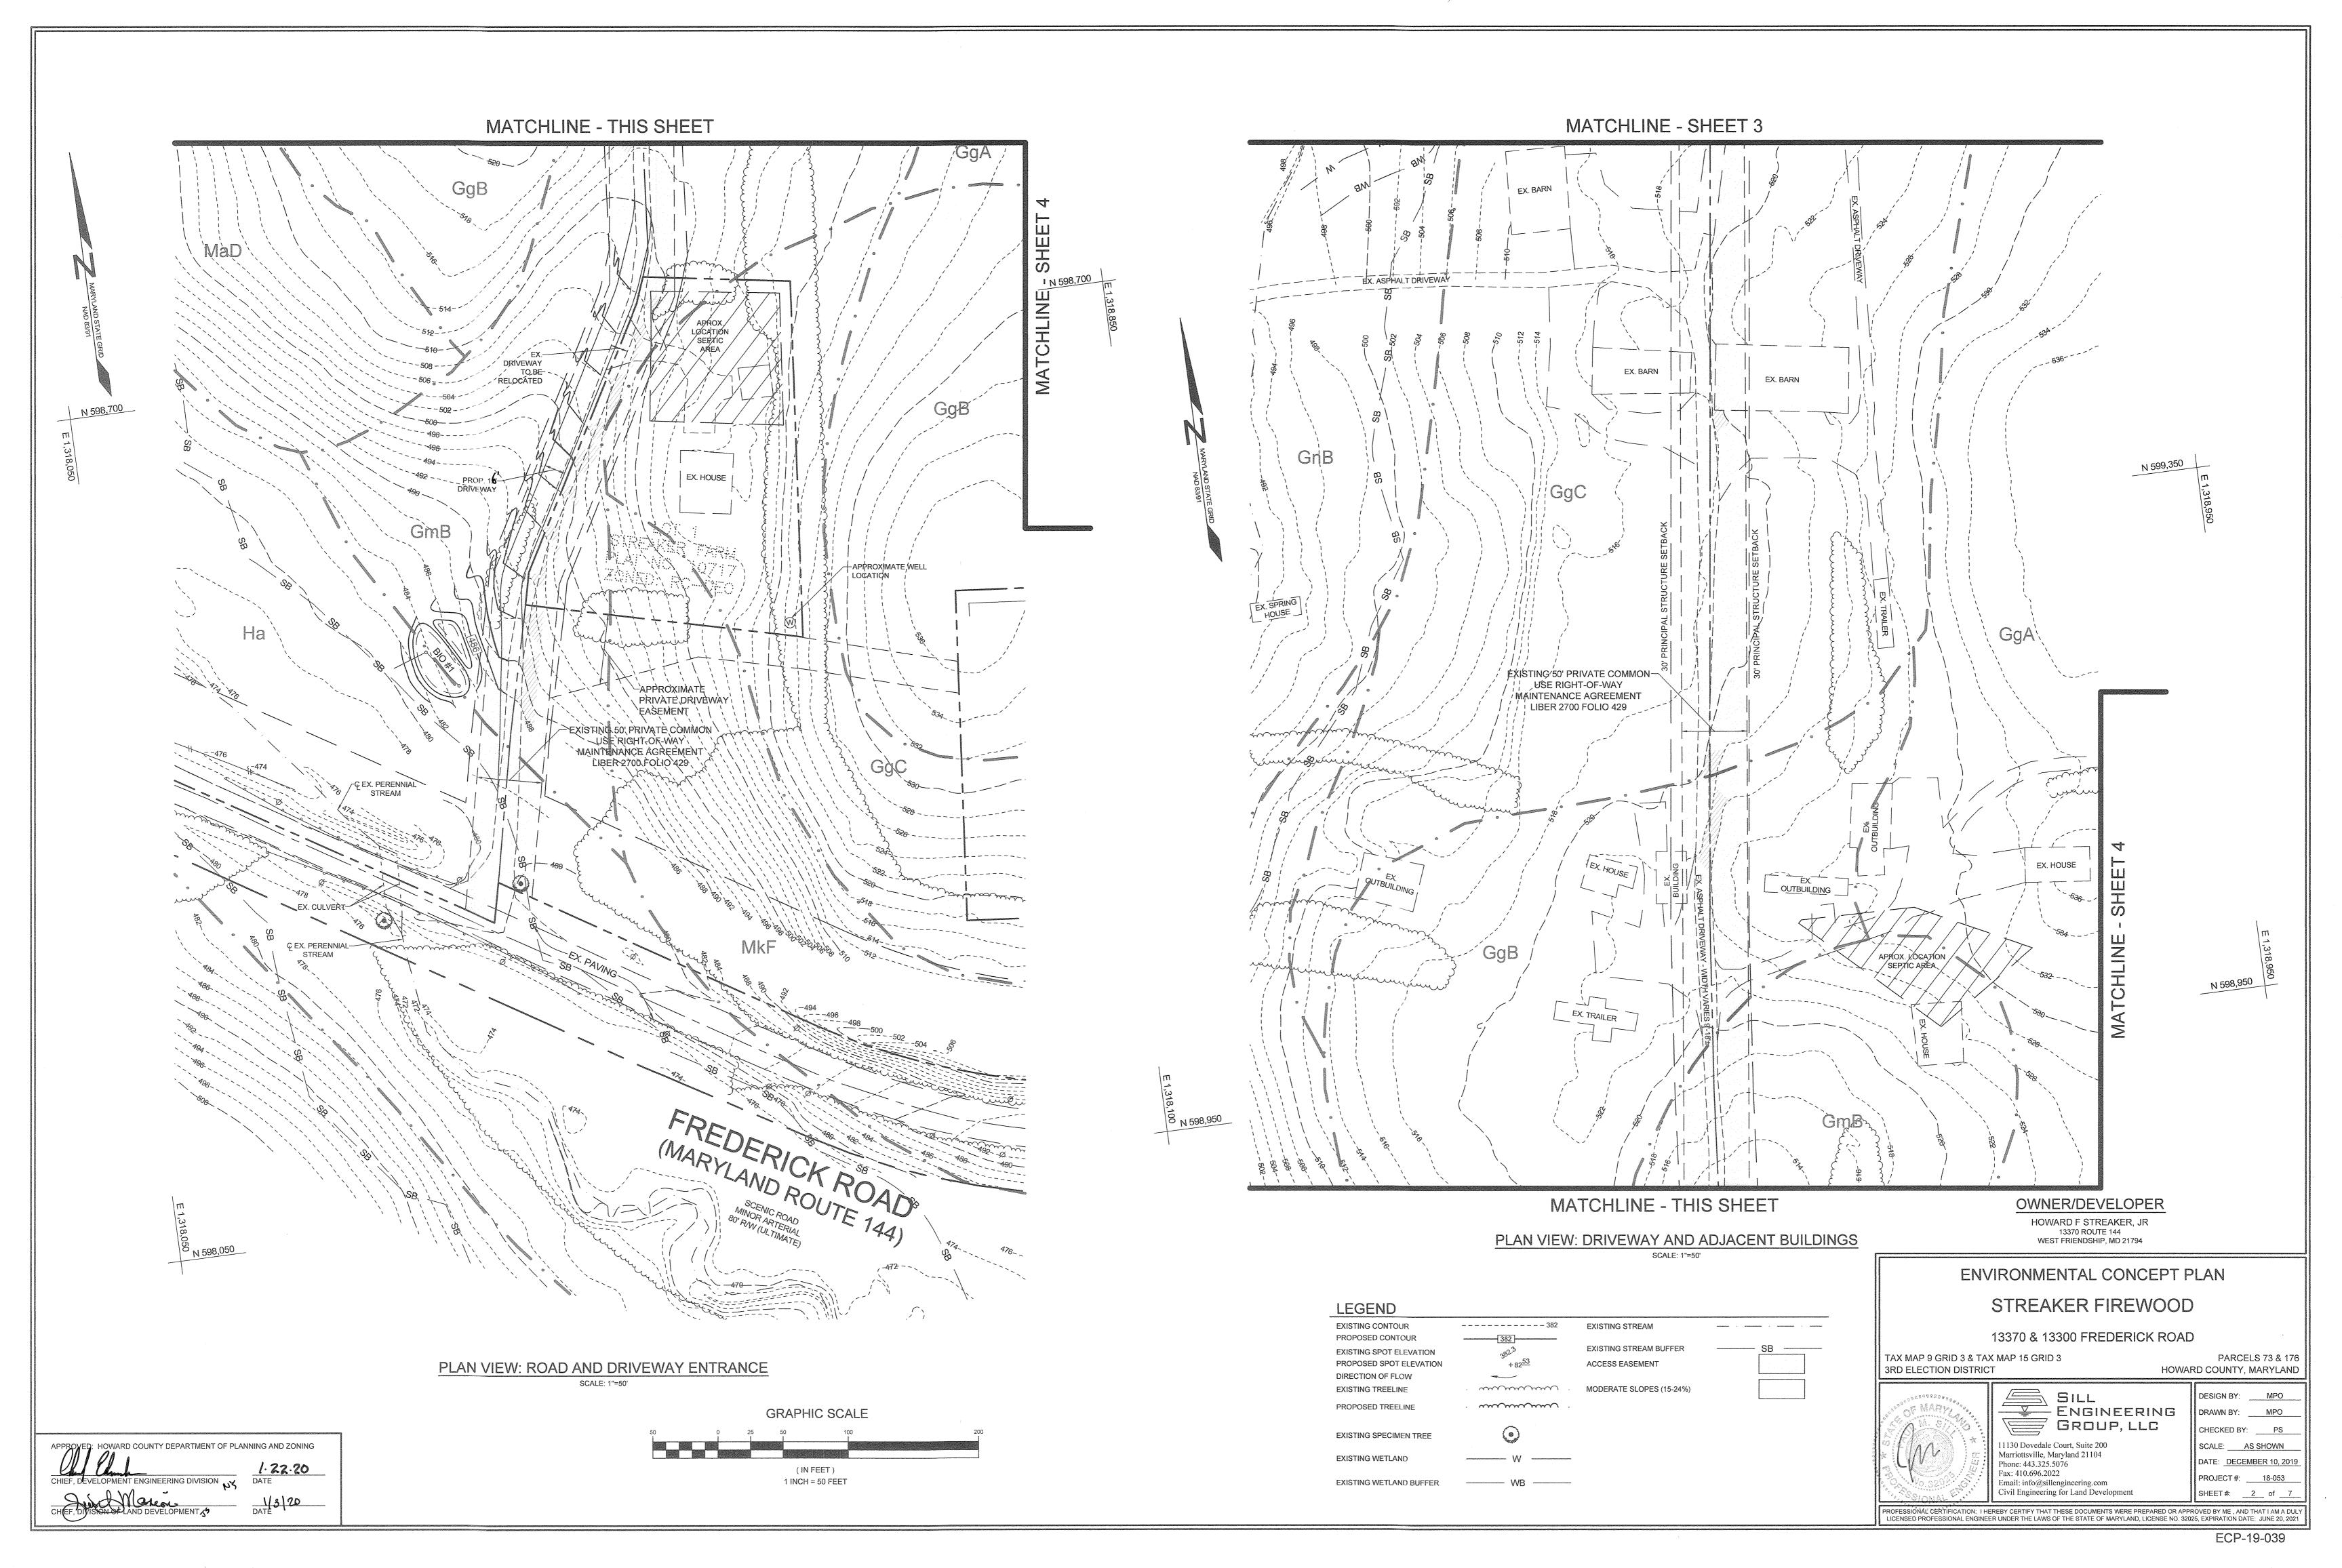



LEGEND EXISTING CONTOUR -----382 PROPOSED CONTOUR 382 EXISTING SPOT ELEVATION PROPOSED SPOT ELEVATION DIRECTION OF FLOW -EXISTING TREELINE mPROPOSED TREELINE EXISTING SPECIMEN TREE EXISTING WETLAND EXISTING WETLAND BUFFER EXISTING STREAM EXISTING STREAM BUFFER ----- SB -----ACCESS EASEMENT HIGHLY ERODIBLE SOILS MODERATE SLOPES PROPOSED SWALE PROPOSED MULCH TRAFFIC AREA

OWNER/DEVELOPER HOWARD F STREAKER, JR 13370 ROUTE 144 WEST FRIENDSHIP, MD 21794

ENVIRONMENTAL CONCEPT PLAN

# STREAKER FIREWOOD

13370 & 13300 FREDERICK ROAD

TAX MAP 9 GRID 3 & TAX MAP 15 GRID 3

3RD ELECTION DISTRICT

SILL ENGINEERING

GROUP, LLG

11130 Dovedale Court, Suite 200 Marriottsville, Maryland 21104 Phone: 443.325.5076 Fax: 410.696.2022 Email: info@sillengineering.com

PROFESSIONAL CERTIFICATION: I HEREBY CERTIFY THAT THESE DOCUMENTS WERE PREPARED OR APPROVED BY ME , AND THAT I AM A DULY LICENSED PROFESSIONAL ENGINEER UNDER THE LAWS OF THE STATE OF MARYLAND, LICENSE NO. 32025, EXPIRATION DATE: JUNE 20, 2021

Civil Engineering for Land Development

DRAWN BY: MPO CHECKED BY: PS SCALE: AS SHOWN DATE: DECEMBER 10, 2019 PROJECT#: 18-053 SHEET#: 3 of 7

DESIGN BY: MPO

HOWARD COUNTY, MARYLAND

PARCELS 73 & 176

APPROXIMATE WELL LOCATION EXISTING POND EX. PERENNIAL-

PLAN VIEW: EXISTING FIREWOOD PROCESSING AREA (TO BE RELOCATED)

LEGEND EXISTING CONTOUR -----382 EXISTING STREAM PROPOSED CONTOUR EXISTING STREAM BUFFER EXISTING SPOT ELEVATION PROPOSED SPOT ELEVATION SUPER SILT FENCE DIRECTION OF FLOW EXISTING TREELINE LIMIT OF DISTURBANCE mPROPOSED TREELINE EXISTING SPECIMEN TREE EXISTING WETLAND EXISTING WETLAND BUFFER

> OWNER/DEVELOPER HOWARD F STREAKER, JR 13370 ROUTE 144 WEST FRIENDSHIP, MD 21794

# ENVIRONMENTAL CONCEPT PLAN

# STREAKER FIREWOOD

13370 & 13300 FREDERICK ROAD

TAX MAP 9 GRID 3 & TAX MAP 15 GRID 3 HOWARD COUNTY, MARYLAND

3RD ELECTION DISTRICT

SILL ENGINEERING GROUP, LLC

11130 Dovedale Court, Suite 200 Marriottsville, Maryland 21104 Phone: 443.325.5076 Fax: 410.696.2022 Email: info@sillengineering.com Civil Engineering for Land Development PROFESSIONAL CÉRTIFICATION: I HEREBY CERTIFY THAT THESE DOCUMENTS WERE PREPARED OR APPROVED BY ME, AND THAT I AM A DULY LICENSED PROFESSIONAL ENGINEER UNDER THE LAWS OF THE STATE OF MARYLAND, LICENSE NO. 32025, EXPIRATION DATE: JUNE 20, 2021

**GRAPHIC SCALE** 1 INCH = 50 FEET

PARCELS 73 & 176

DESIGN BY: MPO


DRAWN BY: MPO


CHECKED BY: PS

SCALE: AS SHOWN DATE: DECEMBER 10, 2019

PROJECT#: 18-053

SHEET#: 4 of 7

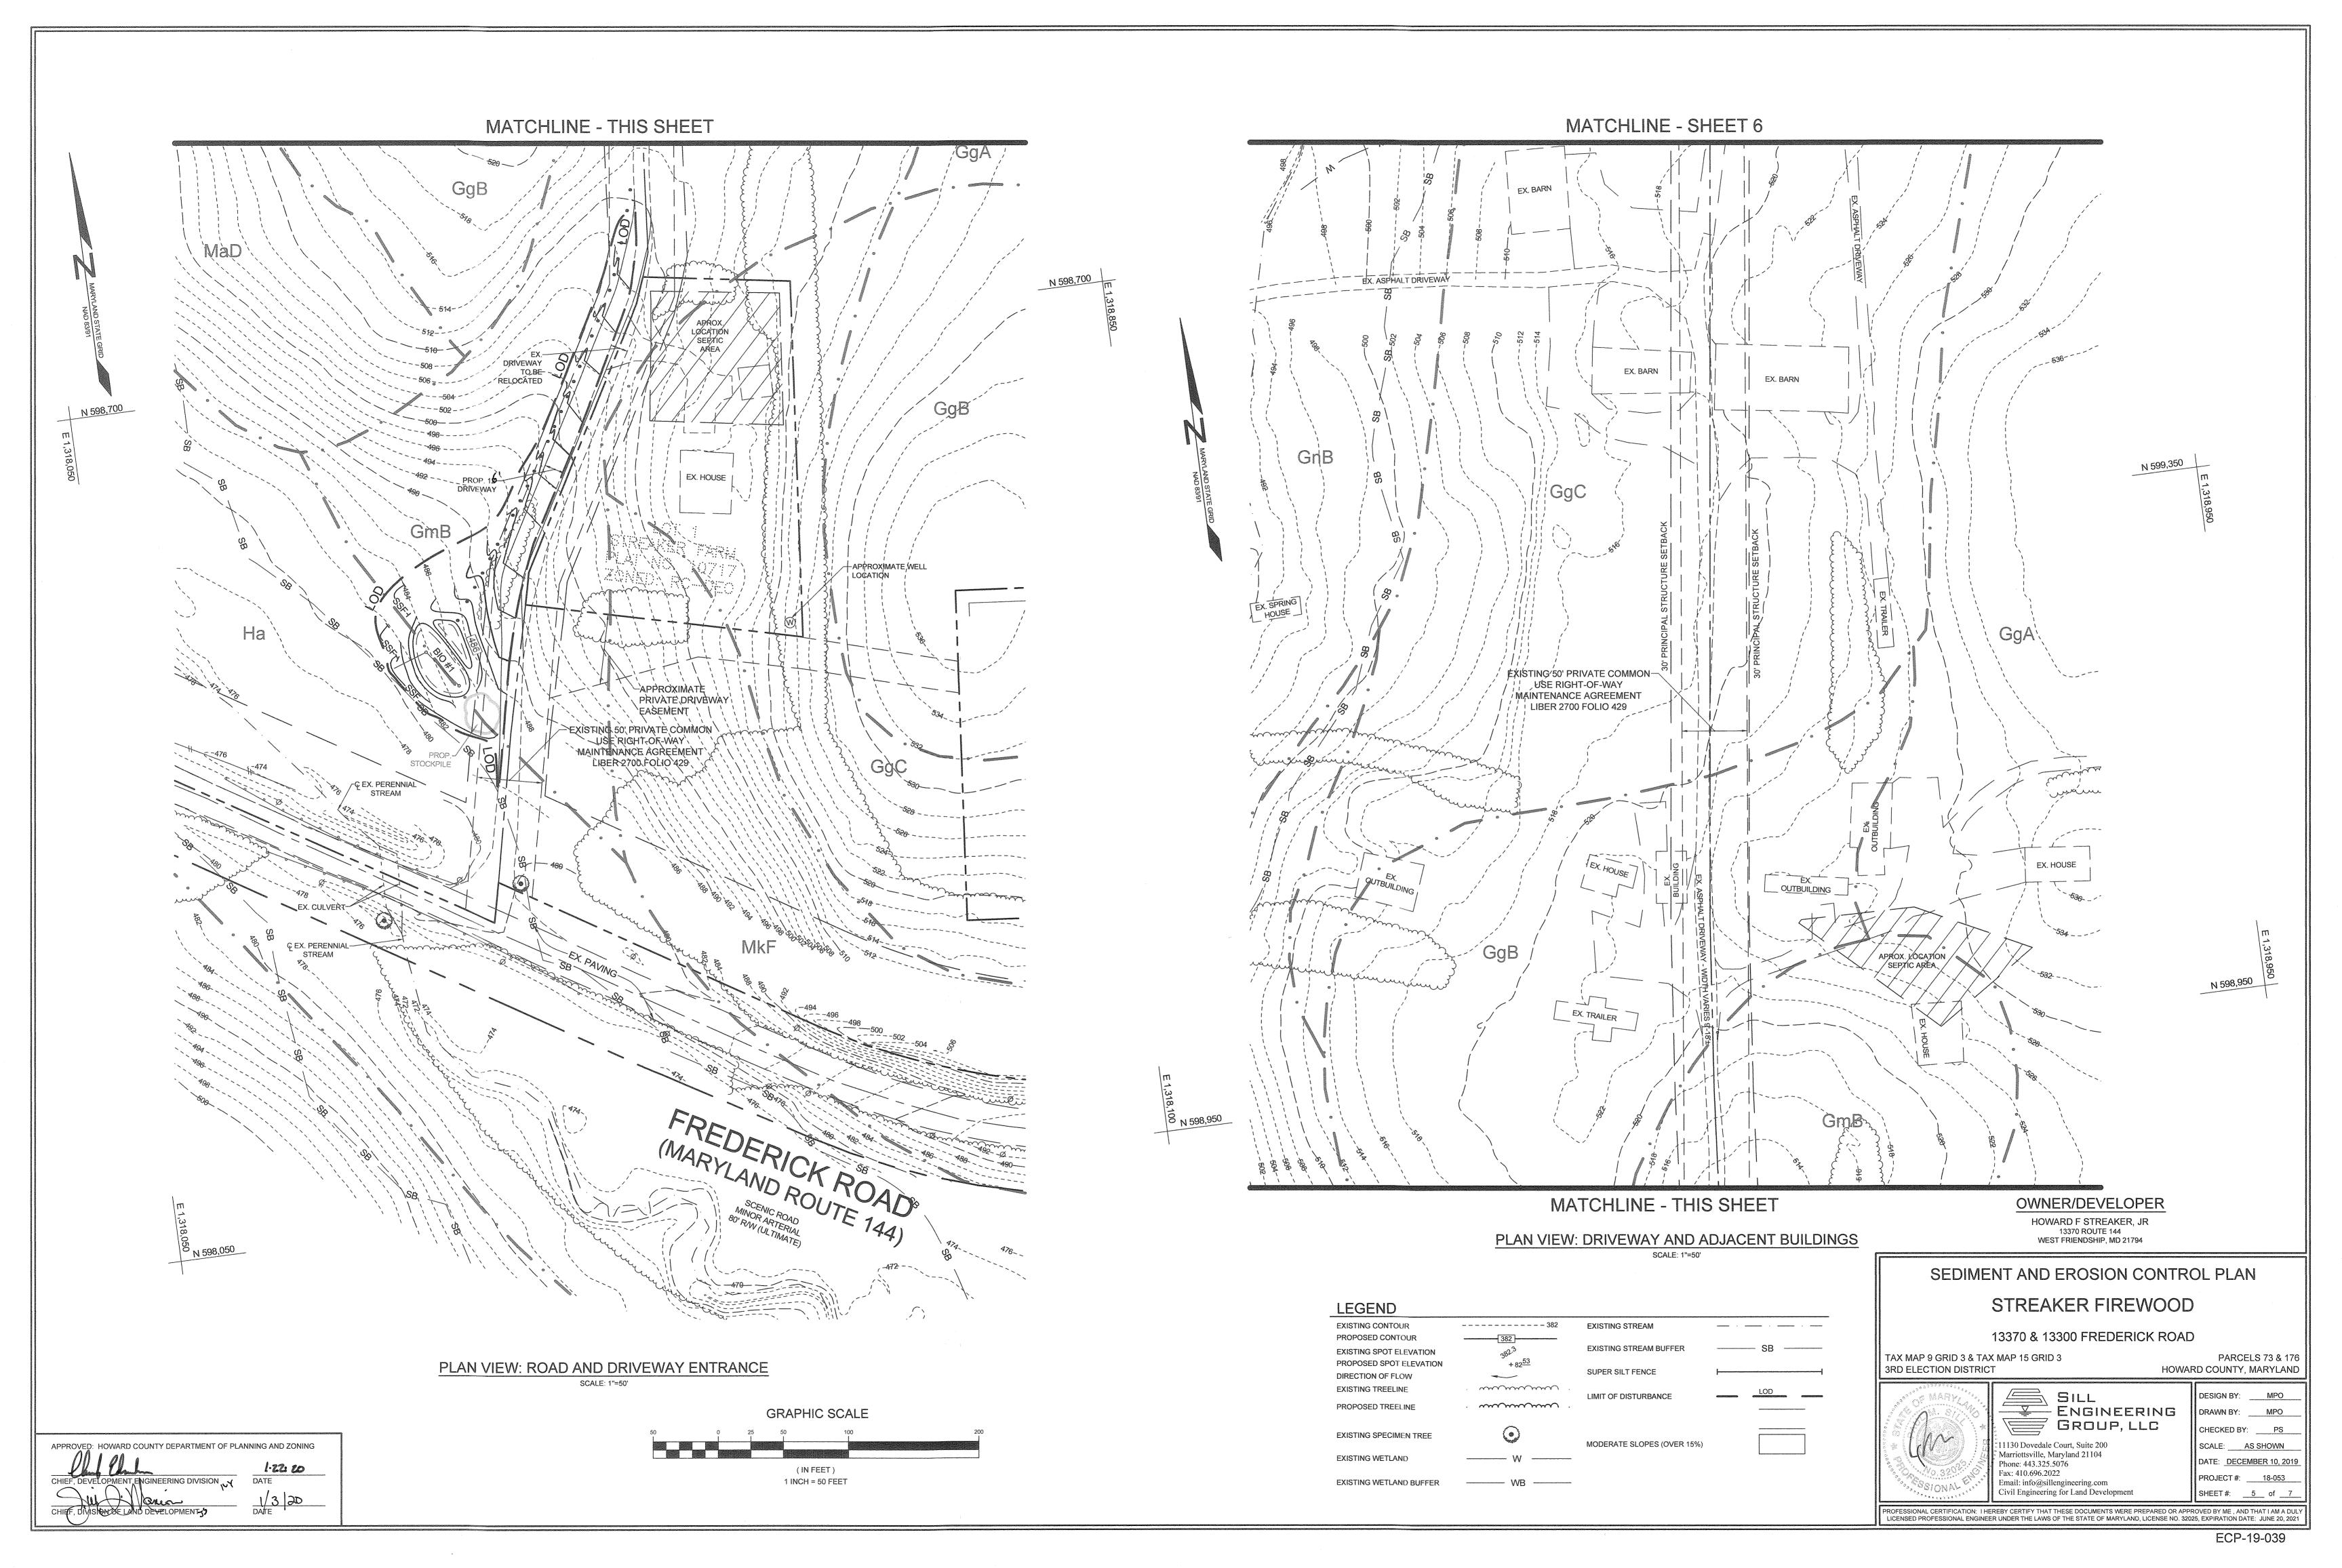

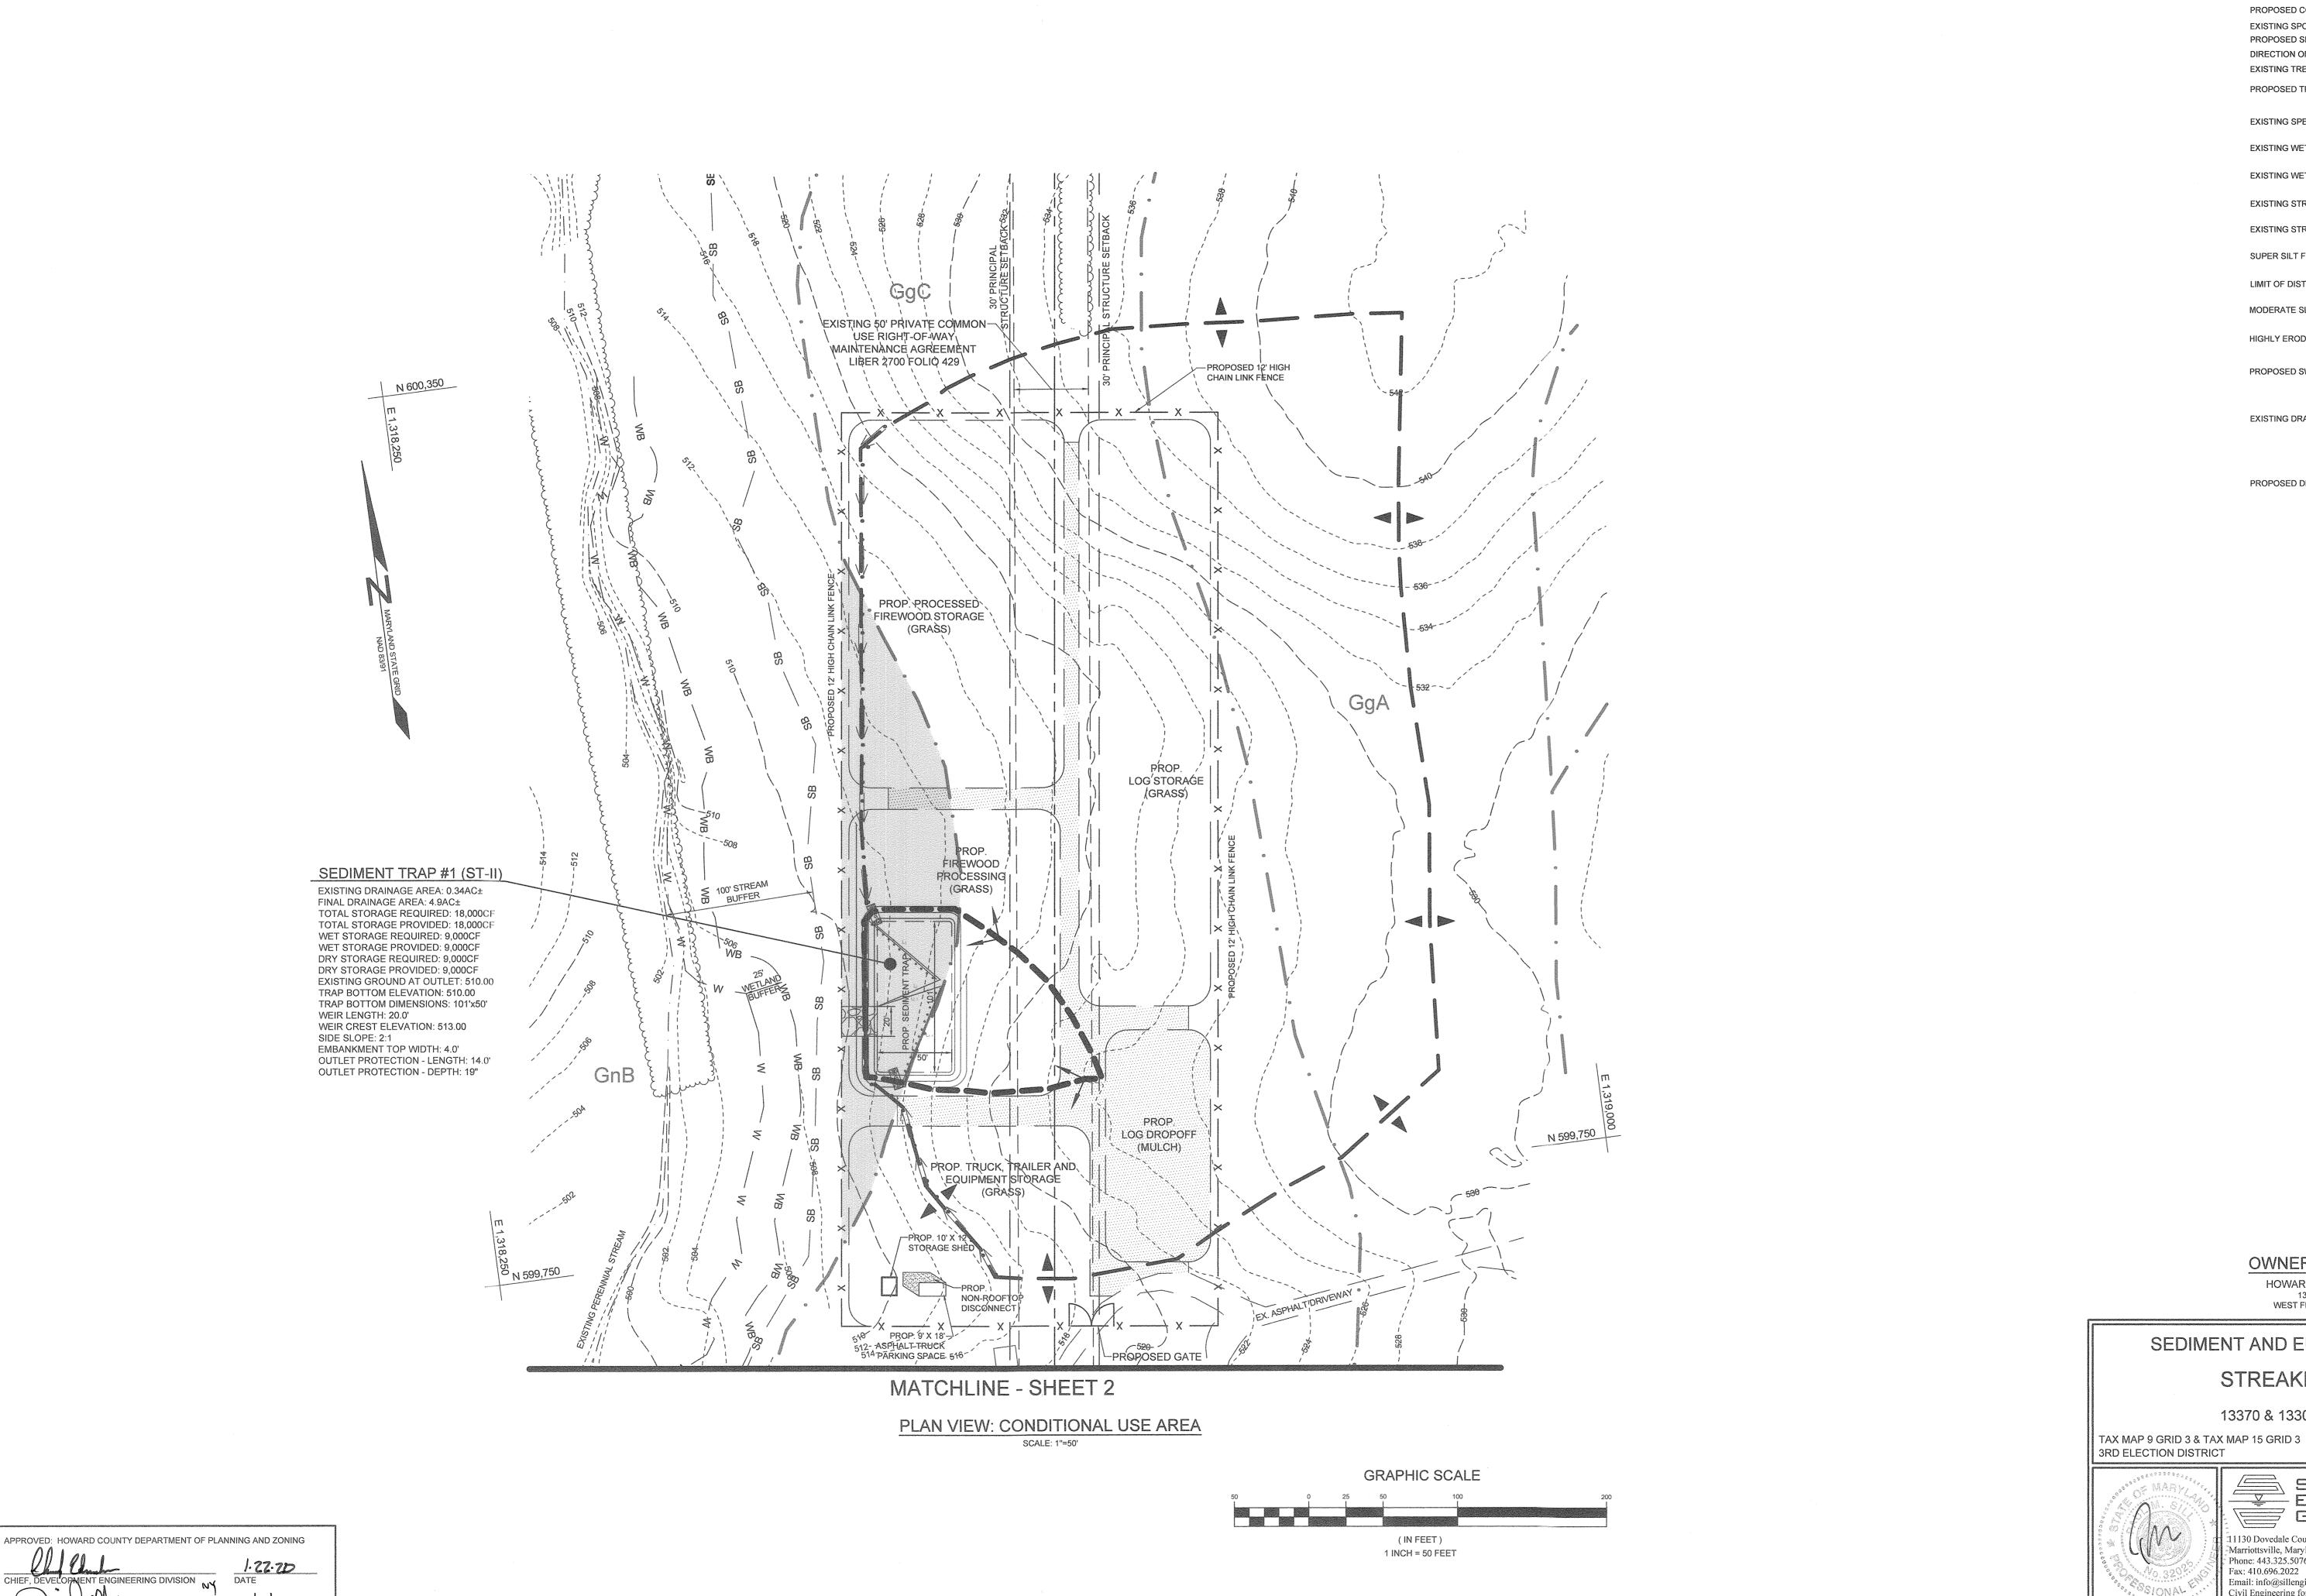

LEGEND **EXISTING CONTOUR** -----382 PROPOSED CONTOUR 382 EXISTING SPOT ELEVATION + 82<sup>53</sup> PROPOSED SPOT ELEVATION DIRECTION OF FLOW  $\sim$ EXISTING TREELINE mPROPOSED TREELINE EXISTING SPECIMEN TREE **EXISTING WETLAND** EXISTING WETLAND BUFFER **EXISTING STREAM** EXISTING STREAM BUFFER SUPER SILT FENCE LIMIT OF DISTURBANCE MODERATE SLOPES (OVER 15%) HIGHLY ERODIBLE SOILS PROPOSED SWALE EXISTING DRAINAGE DIVIDE PROPOSED DRAINAGE DIVIDE

OWNER/DEVELOPER

HOWARD F STREAKER, JR 13370 ROUTE 144 WEST FRIENDSHIP, MD 21794

# SEDIMENT AND EROSION CONTROL PLAN

## STREAKER FIREWOOD

13370 & 13300 FREDERICK ROAD

SILL ENGINEERING 11130 Dovedale Court, Suite 200 Marriottsville, Maryland 21104

GROUP, LLC Phone: 443.325.5076

Fax: 410.696.2022 PROJECT#: 18-053 Email: info@sillengineering.com Civil Engineering for Land Development SHEET#: 6 of 7 PROFESSIONAL CERTIFICATION: I HEREBY CERTIFY THAT THESE DOCUMENTS WERE PREPARED OR APPROVED BY ME , AND THAT I AM A DULY LICENSED PROFESSIONAL ENGINEER UNDER THE LAWS OF THE STATE OF MARYLAND, LICENSE NO. 32025, EXPIRATION DATE: JUNE 20, 2021

PARCELS 73 & 176

HOWARD COUNTY, MARYLAND

DESIGN BY: MPO DRAWN BY: MPO

CHECKED BY: PS

SCALE: AS SHOWN

DATE: DECEMBER 10, 2019

