SITE DATA

LOCATION: ELLICOTT CITY, MD.; TAX MAP 31, BLOCK 7, PARCEL 294 AND 310 2ND ELECTION DISTRICT PRESENT ZONING: R-20

PARCEL AREA: 8.56 AC.

DPZ REFERENCES: PLAT 22168, BA 12-012 C

USE OF STRUCTURES: RELIGIOUS FACILITY

TOTAL BUILDING COVERAGE: 8,592 SF (4,200 SF NEW ADDITION / REMAINDER EXISTING)

=0.197 AC. OR 2.30% OF GROSS AREA PAVED PARKING LOT/AREA ON SITE: 52,050 SF (1.19 AC. OR 13.96% OF GROSS AREA) AREA OF LANDSCAPE ISLAND: 1278 SF (0.03 AC. OR 0.34% OF GROSS AREA) LIMIT OF DISTURBED AREA (DEVEOPMENT AREA FOR FULL BUILD-OUT): 129,532 SF/2.97 AC

WETLANDS ON SITE: 1.54 AC.
WETLAND BUFFERS ON SITE: 2.78 AC.
STREAMS AND THEIR BUFFERS ON SITE: 2.39 AC.
AREA OF ON-SITE 100 YEAR FLOODPLAIN: 0.00 AC.
AREA OF EXISTING FOREST ON SITE: 3.20 AC.
AREA OF STEEP SLOPES (GREATER THAN 20,000 SF CONTIGUOUS): 0.00 AC
AREA OF EROBBLE SOILS: 2.40 AC.

APPROVED: HOWARD COUNTY DEPARTMENT OF PLANNING AND ZONING


CHIEF, DIVISION OF LAND DEVELOPMENT DATE

AREA MANAGED BY ESDV (FULL BUILD-OUT) 2.97 AC.
\*IMPERVIOUS AREA: 1.39 AC.
\*GREEN AREA: 1.58 AC.

ENVIRONMENTAL CONCEPT PLAN YALE PRESBYTERIAN CHURCH

4852 AND 4862 MONTGOMERY ROAD

PARCEL 294, L. 8321/F. 546: PARCEL 310, L. 1153/F. 329 RELIGIOUS FACILITY

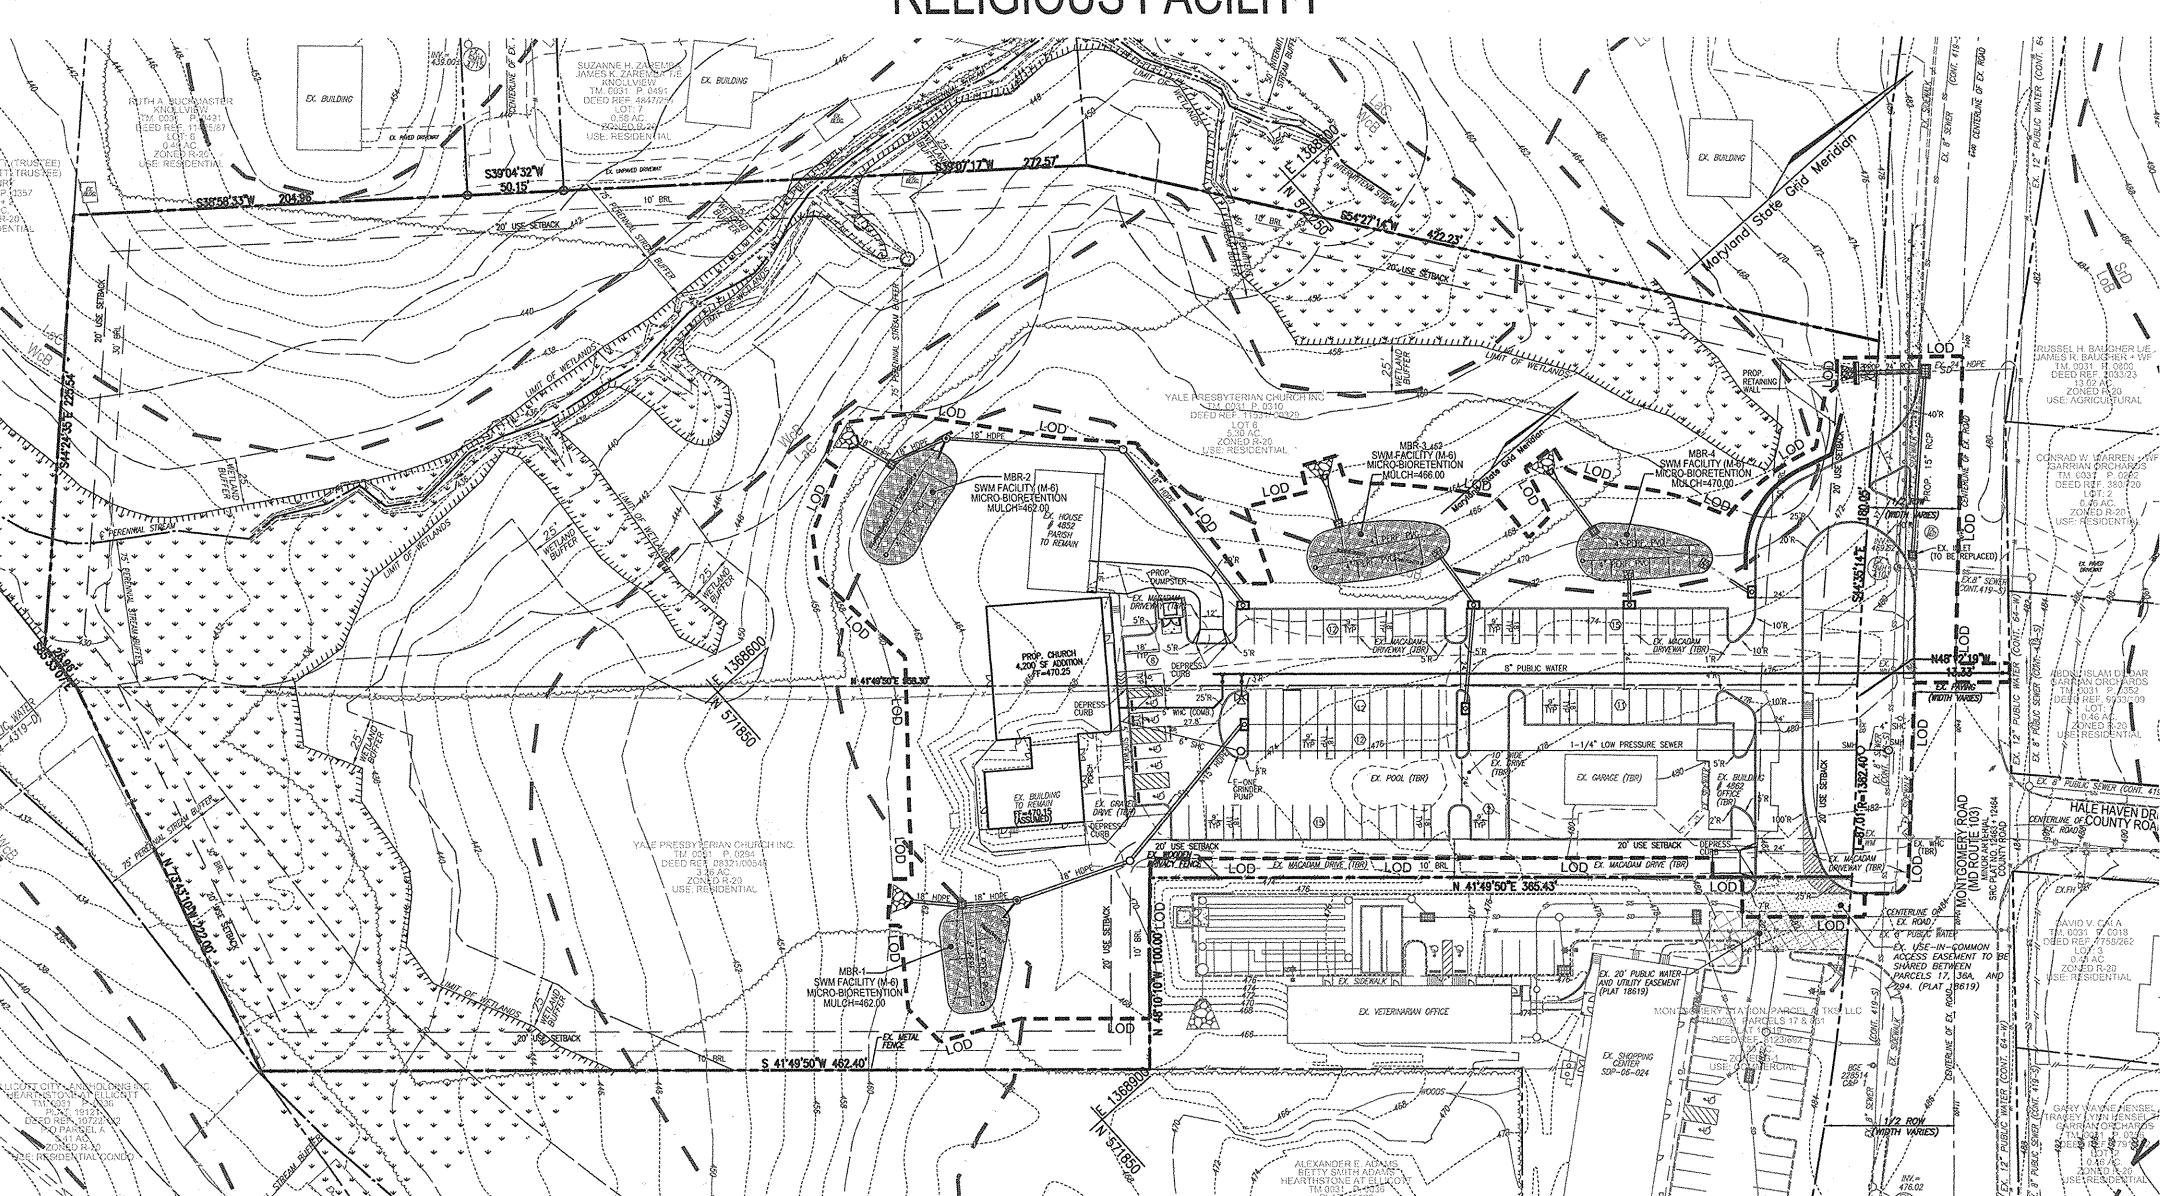

LAYOUT PLAN

SCALE 1"=50"

**GENERAL NOTES** 1. ALL CONSTRUCTION SHALL BE IN ACCORDANCE WITH THE LATEST HOWARD COUNTY STANDARDS AND SPECIFICATIONS, ALL WORK AND MATERIALS SHALL COMPLY WITH O.S.H.A. STANDARDS.

2. THE CONTRACTOR SHALL NOTIFY "MISS UTILITY" AT 1-800-257-7777 AT LEAST 48 HOURS PRIOR TO ANY EXCAVATION WORK. 3. THE CONTRACTOR SHALL NOTIFY THE DEPARTMENT OF PUBLIC WORKS/BUREAU OF ENGINEERING/CONSTRUCTION INSPECTION DIVISION AT (410) 313-1880 AT LEAST FIVE (5) WORKING DAYS PRIOR TO START OF WORK.

4. ANY DAMAGE TO PUBLIC RIGHT-OF-WAY, PAVING, OR EXISTING UTILITIES WILL BE CORRECTED AT THE CONTRACTOR'S EXPENSE. 5. EXISTING UTILITIES LOCATED FROM ROAD CONSTRUCTION PLANS, FIELD SURVEYS, PUBLIC WATER AND SEWER EXTENSION PLANS AND AVAILABLE RECORD DRAWINGS. APPROXIMATE LOCATION OF EXISTING UTILITIES ARE SHOWN FOR THE CONTRACTORS INFORMATION. CONTRACTOR SHALL LOCATE EXISTING UTILITIES WELL IN ADVANCE OF CONSTRUCTION ACTIVITIES AND TAKE ALL NECESSARY PRECAUTIONS TO PROTECT THE EXISTING UTILITIES AND TO MAINTAIN UNINTERRUPTED SERVICE. ANY DAMAGE NCURRED DUE TO CONTRACTOR'S OPERATION SHALL BE REPAIRED IMMEDIATELY AT THE CONTRACTOR'S EXPENSE. 6. THE EXISTING TOPOGRAPHIC INFORMATION SHOWN HEREON IS BASED ON FIELD RUN TOPOGRAPHICAL SURVEY BY ROBERT H. VOGEL ENGINEERING, INC., DATED JUNE 2012, AND HOWARD COUNTY GIS.

7. THE PROJECT BOUNDARY SHOWN HEREON IS BASED ON A BOUNDARY SURVEY PREPARED BY ROBERT H. VOGEL ENGINEERING, INC., DATED JUNE 2012, 8. THE COORDINATES SHOWN HEREON ARE BASED UPON THE HOWARD COUNTY GEODETIC CONTROL, WHICH IS BASED UPON THE MARYLAND STATE PLANE COORDINATE SYSTEM. HOWARD COUNTY MONUMENT NOS. 31AB AND 31D4

9. THE SUBJECT PROPERTY IS ZONED "R-20" IN ACCORDANCE WITH THE 10/06/13 COMPREHENSIVE ZONING PLAN. 10. THIS PROJECT IS SUBJECT TO COMPLIANCE WITH THE AMENDED FIFTH EDITION OF THE SUBDIVISION AND LAND DEVELOPMENT REGULATIONS. DEVELOPMENT OR CONSTRUCTION ON THIS PROPERTY MUST COMPLY WITH SETBACK AND BUFFER REGULATIONS IN EFFECT AT THE TIME OF SUBMISSION OF THE SITE DEVELOPMENT PLAN, WAIVER PETITION APPLICATION OR BUILDING/GRADING PERMIT APPLICATIONS.

11. THIS SITE IS NOT LOCATED IN A HISTORIC DISTRICT. 12. PUBLIC WATER AVAILABLE THROUGH CONTRACT NO. 64-W

PUBLIC SEWER AVAILABLE THROUGH CONTRACT NO. 419-S. 13. THERE ARE NO BURIAL GROUNDS, CEMETERIES, OR HISTORIC STRUCTURES LOCATED ON THIS PROPERTY.

14. SEDIMENT AND EROSION CONTROL WILL BE PROVIDED FOR THIS SITE. 15. STORMWATER MANAGEMENT FOR THIS PROJECT IS BEING PROVIDED BY ENVIRONMENTAL SITE DESIGN UTILIZING MICRO-BIORETENTION FACILITIES (M-6) TO ACCOMMODATE THE TOTAL ESD VOLUME REQUIRED. SWM FACILITIES TO

BE PRIVATELY OWNED AND MAINTAINED. 16. THERE ARE NO SPECIMEN TREES LOCATED ON THE SUBJECT PROPERTY. 17. NO RARE, THREATENED OR ENDANGERED SPECIES WERE OBSERVED ON THE PROPERTY.

18. FOREST STAND DELINEATION PLAN WAS PREPARED BY ECO-SCIENCE PROFESSIONALS, INC., DATED AUGUST 21, 2013. 19. WETLANDS SHOWN ON-SITE ARE BASED ON A FIELD INVESTIGATION PREPARED BY ECO-SCIENCE PROFESSIONALS, INC. DATED AUGUST 21, 2013. IMPACTS TO THE WETLAND BUFFER RESULTING FROM DRIVEWAY CONSTRUCTION WAS DETERMINED TO BE A NECESSARY DISTURBANCE BY THE DEPARTMENT OF PLANNING AND ZONING.
20. NO GRADING, REMOVAL OF VEGETATIVE COVER OR TREES, PAVING AND NEW STRUCTURES SHALL BE PERMITTED WITHIN THE LIMITS OF WETLANDS, STREAM(S), OR THEIR REQUIRED BUFFERS, FLOODPLAIN AND FOREST CONSERVATION EASEMENT AREAS, WITHOUT OBTAINING NECCESARY WAIVERS AND PERMITS.

21. PROPOSED INGRESS AND EGRESS LOCATION TO MD ROUTE 103 WAS REQUESTED BY MSHA (TO BE LOCATED AS FAR FROM THE EXISTING DRIVEWAY AS POSSIBLE).

THE SECOND ACCESS WAS A CONDITION OF APPROVAL OF BA-12-012 C. THE MSHA ROUTE 103 ACCESS WAS CONFIGURED TO AVOID THE WETLAND BUFFER TO THE GREATEST EXTENT POSSIBLE.

22. THERE IS NO 100-YR FLOODPLAIN WITHIN THE LIMITS OF THIS SITE. 23. APPROVAL OF THIS ECP DOES NOT CONSTITUTE AN APPROVAL OF ANY SUBSEQUENT AND ASSOCIATED SUBDIVISION PLAN/PLAT AND/OR SITE DEVELOPMENT PLAN AND/OR RED-LINE REVISION PLAN. REVIEW OF THIS PROJECT FOR COMPLIANCE WITH THE HOWARD COUNTY SUBDIVISION AND LAND DEVELOPMENT REGULATIONS SHALL OCCUR AT THE SUBDIVISION PLAN/PLAT AND/OR SITE DEVELOPMENT PLAN STAGES AND/OR RED-LINE REVISION PROCESS. THE APPLICANT AND CONSULTANT SHOULD EXPECT ADDITIONAL AND MORE DETAILED REVIEW COMMENTS (INCLUDING COMMENTS THAT MAY ALTER THE OVERAL. SITE DESIGN) AS THIS PROJECT PROGRESSES THROUGH THE PLAN REVIEW PROCESS. 24. REFERENCE GEOTECHNICAL REPORT PREPARED BY ECS MID-ATLANTIC, LLC DATED DECEMBER 13, 2013 FOR SUBSURFACE EXPLORATION TESTING AT BORINGS B-1 THROUGH B-4.

## **ENVIRONMENTAL SITE DESIGN NARRATIVE**

THIS PLAN PROPOSES THE DEVELOPMENT FOR THE CONDITIONAL USE OF A STRUCTURE USED PRIMARILY FOR RELIGIOUS ACTIVITIES, REFERENCE BA-12-012C, FILED PURSUANT TO SECTION 131.N.40 OF THE HOWARD COUNTY ZONING REGULATIONS, APPROVED SEPTEMBER 06, 2012.

THERE ARE NO DISTURBANCES TO ENVIRONMENTAL FEATURES INCLUDING, STREAMS, STREAM BUFFERS, WETLANDS, AND A MINIMAL, NECESSARY DISTURBANCE TO WETLAND BUFFERS FOR THE CONSTRUCTION OF THE ENTRANCE DRIVE. THERE IS NO DFIRM 100-YEAR FLOODPLAIN OR CONTIGUOUS STEEP SLOPES > 20,000 SF ON SITE. THERE IS SOME DISTURBANCE TO EXISTING WOODED RESOURCES PRESENT ON SITE, WHICH ARE NOT CONSIDERED FOREST STAND AND ARE ADDRESSED BY THE FOREST CONSERVATION PLAN.

THE SITE SLOPES NATURALLY FROM EAST TO WEST AND THE SITE IS GRADED TO MAINTAIN THESE NATURAL FLOW PATTERNS.


ENVIRONMENTAL SITE DESIGN (ESD) IS PROVIDED TO THE MAXIMUM EXTENT PRACTICABLE (MEP) BY THE REDUCTION OF IMPERVIOUS SURFACES THROUGH BETTER SITE DESIGN, AND FOUR (4) MICRO-BIORETENTION FACILITIES (M-6). THE MBR (M-6) WILL DISCHARGE INDEPENDENTLY TO THE ENVIRONMENTAL BUFFERS AT THE NORTH AND WEST SIDE OF THE SITE. THE PROPOSED ESD PRACTICES SHALL BE PRIVATELY OWNED AND MAINTAINED.

SEDIMENT CONTROL FOR THIS SPECIFIC SITE PLAN WILL BE PROVIDED THROUGH THE USE OF PERIMETER CONTROLS, SILT FENCE, SUPER SILT FENCE, AND INLET PROTECTION. SEDIMENT CONTROL SHALL BE IN ACCORDANCE WITH THE CURRENT REQUIREMENTS AND SHALL BE APPROVED BY THE HOWARD SOIL CONSERVATION DISTRICT.

AS STATED IN #4 ABOVE, STORMWATER MANAGEMENT FOR THE PROJECT SHALL BE MET THROUGH THE USE OF FOUR (4) MICRO BIORETENTION FACILITIES (M-6).

A WAIVER REQUEST FOR NECESSARY DISTURBANCE TO THE WETLAND BUFFER WILL BE SUBMITTED UNDER SEPERATE COVER.

**BENCHMARKS** HOWARD COUNTY STATION 31A3 N 573217.88 E 1368237.66 ELEVATION 486.96 HOWARD COUNTY STATION 31D4 N 587,380.458 E 1,352,603.488 ELEVATION 494.50

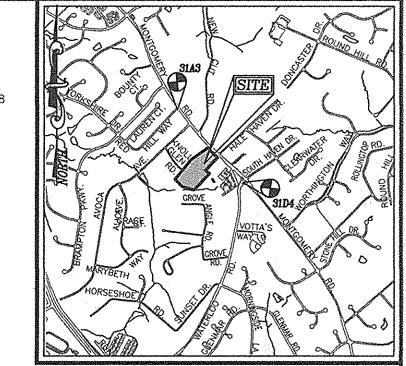

VICINITY MAP SCALE: 1"=2,000'

	ADC MAP : 16 F-2
LEGEND:	
	PROPERTY LINE RIGHT-OF-WAY LINE ADJACENT PROPERTY LINE EXISTING CURB AND GUTTER
à	EXISTING UTILLITY POLE
<b>**</b>	EXISTING LIGHT POLE
	EXISTING MAILBOX
	EXISTING SIGN
(SAF) () ss	EXISTING SANITARY MANHOLE EXISTING SANITARY LINE
000	EXISTING CLEANOUT
₹ FH	EXISTING FIRE HYDRANT
	EXISTING WATER LINE
	EXISTING TREELINE
and a substitution of $f$ is the substitution of the substitution of $f$ is the substitution of $f$	EXISTING FENCE
Ø.	CENTERLINE OF EXISTING STREAM PROPOSED DECORATIVE PEDESTRIAN LIGHTING
Ů···	PROPOSED PARKING LOT LIGHTING
	PROPOSED STORMDRAIN
	PROPOSED STORMDRAIN INLET
	PROPOSED SIDEWALK
$\sim$	PROPOSED TREELINE
	PROPOSED CURB
	UNDEVELOPABLE AREA
	EXISTING 20' PUBLIC WATER AND UTILITY EASEMENT (PLAT 18619)
Accountance accountance accountance	EXISTING 30' PRIVATE USE-IN-COMMON
B-1 -	BORING LOCATIONS
TP-3	TEST PIT LOCATIONS
LOD LOD	LIMIT OF DISTURBANCE/DEVELOPMENT AREA

DESCRIPTION	SHE	ET	NO
COVER SHEET	1	OF	3
GRADING, SEDIMENT, AND EROSION CONTROL PLAN AND SOILS MAP	1 2	OF	3
SWM DRAINAGE AREA MAP; SWM NOTES AND DETAILS	3	OF	3

OWNER/DEVELOPER YALE PRESBYTERIAN CHURCH INC. C/O PASTOR WOO YONG JUNG 4862 MONTGOMERY ROAD ELLICOTT CITY, MD 21043 PHONE: (301) 490-7032

## **ENVIRONMENTAL CONCEPT PLAN**


## **COVER SHEET**

YALE PRESBYTERIAN CHURCH 4852 AND 4862 MONTGOMERY ROAD (PARCEL 294 - L.8321/F.546; PARCEL 310 - L.11531/F.329)
RELIGIOUS FACILITY

ZONED: R-20

TAX MAP 31 BLOCK 7 2ND ELECTION DISTRICT




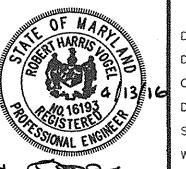

DRAWN BY: CHECKED BY: DATE: FEBRUARY 2013 AS SHOWN W.O. NO.: 05-43


PROFESSIONAL CERTIFICATE I HEREBY CERTIFY THAT THESE DOCUMENTS WERE PREPARED OR APPROVED BY ME, AND THAT I AM A DULY LICENSED PROFESSIONAL ENGINEER UNDER THE LAWS OF THE STATE OF MARYLAND, UCENSE NO. 16193 EXPIRATION DATE: 09-27-2014

SHEET \_\_ OF \_\_

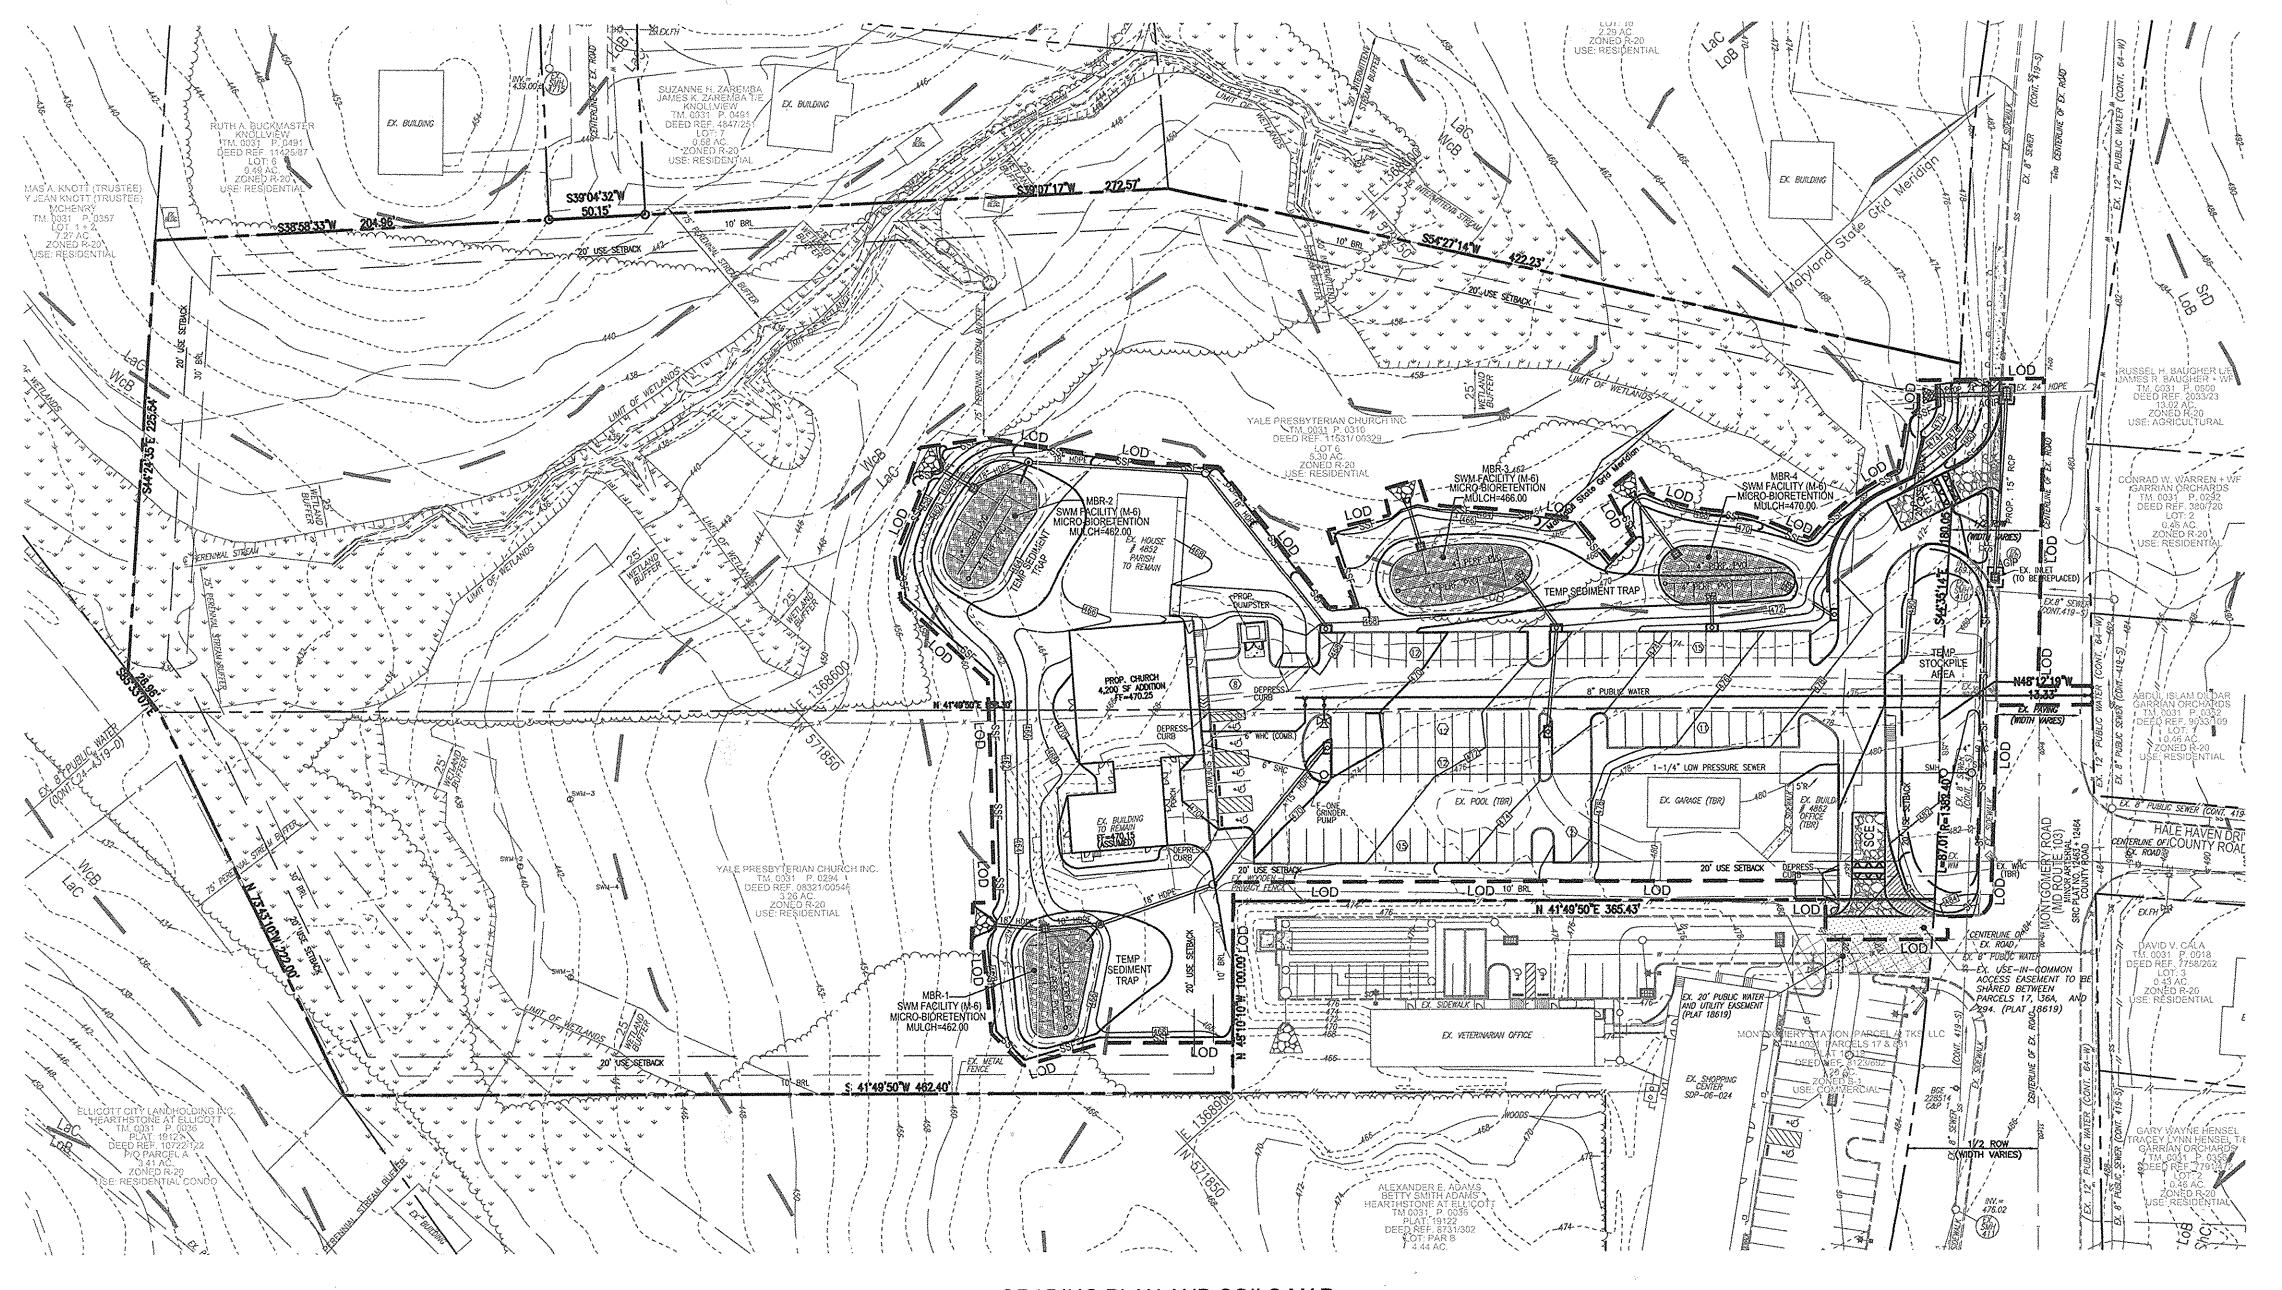

GRADING PLAN AND SOILS MAP

SCALE: 1"=50"

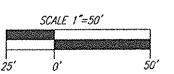

PROJECT: Yale Presbyterian STORMWATER MANAGEMENT PRACTICE BREAKOUT DESIGNER: gah 02/12/16 ROBERT H. VOGEL ENGINEERING, INC. ENVIRONMENTAL SITE DESIGN PRACTICE PERMEABLE ADD UNDER SHEETFLOW LANDSCAPE GRAVEL CISTERN MICRO BIO TOTAL DRAINAGE **FACILITY** AREA PAVEMENT PAVE TO BUFFER INFILTRATION TREATED NUM BER AREA# A-2 (N-3)(M-3)(M-5)(M-7)VOLUME A-2 2184 MBR #1 23620 0 0 2520 2520 26469 MBR #2 0 0 2 0 MBR #3 0 0 0 2517 2517 3 19378 0 2266 2266 25847 MBR #4 0 0 0 9487 9487 TOTALS: 0 0 SITE ESDV REQ'd: CF +/-

SITE ESDv REQ'd: 9365 CF +/
\*Micro-bioretentions utilized in each subarea at the rate of 75%. TOTAL ESDv PROVIDED (CF): 9,487

TOTAL AREA 95314 SF

2.19 AC

APPROVED: HOWARD COUNTY DEPARTMENT OF PLANNING AND ZONING

CHIEF, DEVELOPMENT ENGINEERING DIVISION OF DATE

VetsCeOpple
CHIEF, DIVISION OF LAND DEVELOPMENT DATE

V min=1.0" rainfall Vmax= 1yr rainfall=2.6"		(1.0xRvxA)/12 (2.6xRvxA)/12		\$1.00 Mark 180 1 1 1 2 1 2 1 1 1 1 1 1 1 1 1 1 1 1 1		The second secon	a januarian kanan	The state of the s	a maja saariina. Wa ka a dhaa dhaa dhaa dhaa a dhaa dhaa d		The same supplies to the same state of the same supplies to the same state of the sa
Rv=0.05+		] } {					Date:				ļ
ESDv=(Pe	xRvxA)/12						Chk. By:	make a state of the control of the c			
Pe=	1.80	i Language page (al. 18 page 18 page				: : ::	Date:	Feb. 12, 2016			
I die Fi	<u>esbyterian</u>	Comp	<u>itation Su</u>	mmary u	y Subare	<b>d</b>	Des. By:	GAH	and the second s	ing Singapore (Mariana Santana Santana Santana Singapore (Mariana Santana San	

DA	% IIVIPERV	KV	UA	ESDV KEQ	M	VOLUME	PROVIDED *	ESDV PACILITY TYPE	AREA SP	PERV AREA	IIVIF MACA
1A	38.43	0.40	0.33					SUBAREA MBR#1	14265	8783	5482
18	86.16	0.83	0.21					SUBAREA MBR#1	9355	1295	8060
MBR-1	57.33	0.57	0.54	2005	1114	2897	2184	MICRO-BIORETENTION (M-7)	23620	10078	13542
2A	28.23	0.30	0.25					SUBAREA MBR#2	11015	7905	3110
2B	81.22	0.78	0.35					SUBAREA MBR#2	15454	2903	12551
MBR-2	59.17	0.58	0.61	2313	1285	3341	2520	MICRO-BIORETENTION (M-7)	26469	10808	15661
3A	72.83	0.71	0.32					SUBAREA MBR#3	13948	3789	10159
3B	82.06	0.79	0.12		*			SUBAREA MBR#3	5430	974	4456
MBR-3	75.42	0.73	0.44	2118	1177	3060	2517	MICRO-BIORETENTION (M-7)	19378	4763	14615
4A	43.35	0.44	0.33					SUBAREA MBR#4	14351	8130	6221
48	57.14	0.56	0.26					SUBAREA MBR#4	11496	4927	6569
MBR-4	49.48	0.50	0.59	1921	1067	2774	2266	MICRO-BIORETENTION (M-7)	25847	13057	12790
Bypass	14.76	0.18	0.86				0		34232	29180	5052
	TOT	AL ESDV BY	SUBAREA	9365		5 5	9487	:	129546	67886	61660
with the state of the state of the state of						3			2.97	1.56	1.42

MAPPED SOILS TYPES - CLARKSVILLE SE MAP #23

SYMBOL NAME / DESCRIPTION GROUP HYDRIC NOUSIONS K FACTOR FARMAND POLEMIAL

LOB LEGORE - MONTALTO - URBAN LAND COMPLEX, 0 TO 8 PERCENT SLOPES C NO NO 0.30 NO NO NO


LoC LEGORE SILT LOAM, 8 TO 15 PERCENT SLOPES C NO NO 0.28 YES NO

WCB WATCHUNG SILT LOAM, 3 TO 8 PERCENT SLOPES, STONEY C/D YES YES 0.43 NO YES

TAKEN FROM: USDA, SCS-WEB SOIL SURVEY, HOWARD COUNTY HIGHI

\*Micro-bioretentions utilized in each subarea at the rate of 75%.

HIGHLY ERODIBLE SOILS ARE THOSE SOILS WITH A SLOPE GREATER THAN 15 PERCENT OR THOSE SOILS WITH A SOIL ERODIBILITY FACTOR K GREATER THAN 0.35 AND WITH A SLOPE GREATER THAN 5 PERCENT

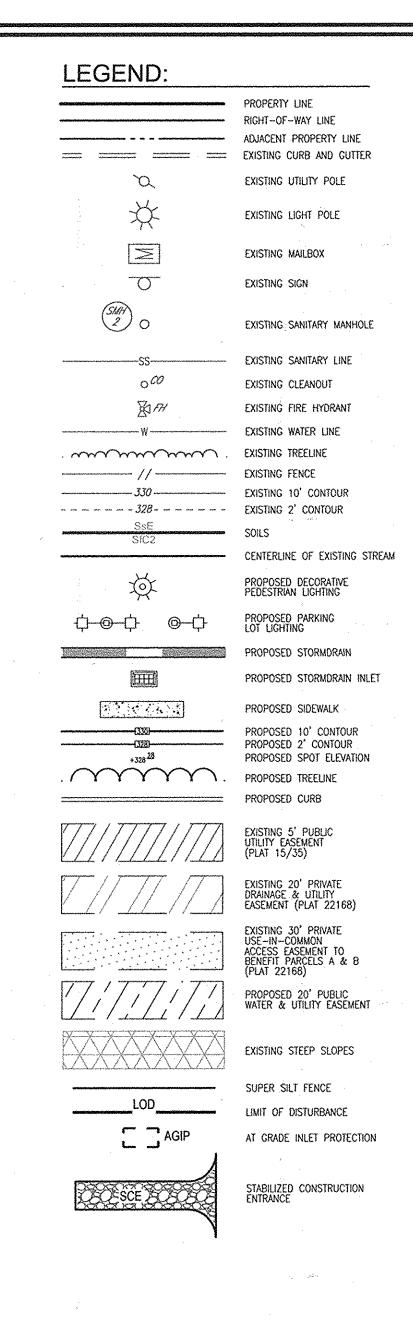

HSCD NOTE:

APPROVAL OF THIS ENVIRONMENTAL CONCEPT PLAN (ECP) BY THE HOWARD SOIL CONSERVATION DISTRICT DOES NOT GRANT APPROVAL OF THE PROPOSED SEDIMENT CONTROL SCHEME. THE FINAL PLAN SHALL INCLUDE A SEQUENCE OF CONSTRUCTION WHICH SHALL DETAIL SEDIMENT & EROSION CONTROLS AND PHASING AND ADDRESS THE PROJECT TEMPORARY STORMWATER MANAGEMENT REQUIREMENTS.

OWNER/DEVELOPER

YALE PRESBYTERIAN CHURCH INC.
C/O PASTOR WOO YONG JUNG
4862 MONTGOMERY ROAD
ELLICOTT CITY, MD 21043
PHONE: (301) 490-7032

ENVIRONMENTAL CONCEPT PLAN

GRADING, SEDIMENT, AND EROSION CONTROL PLAN, AND SOILS MAP


YALE PRESBYTERIAN CHURCH
4852 AND 4862 MONTGOMERY ROAD
(PARCEL 294 - L.8321/F.546; PARCEL 310 - L.11531/F.329)
RELIGIOUS FACILITY
ZONED: R-20
PARCELS:
HOWARD COUNTY

TAX MAP 31 BLOCK 7 2ND ELECTION DISTRICT

ROBERT H. VOGEL ENGINEERING, INC.

ENGINEERS • SURVEYORS • PLANNERS

8407 MAIN STREET TEL: 410.461.7666
ELLICOTT CITY, MD 21043 FAX: 410.461.8961

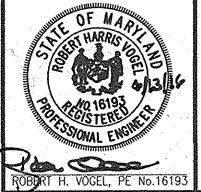

DESIGN BY: GAH
DRAWN BY: GAH
CHECKED BY: RHV
DATE: FEBRUARY 2013
SCALE: AS SHOWN
W.O. NO.: 05-43

PROFESSIONAL CERTIFICATE

I HEREBY CERTIFY THAT THESE DOCUMENT OF APPROVED BY ME, THAT THESE PROFESSION OF MARYLAND LICENSE NO. 16193 EXPIRATION DATE: 09-27-2014

2 SHEET OF

PARCELS: 294 AND 310 HOWARD COUNTY, MARYLAND

ECP-15-64

TAKEN FROM: USDA, SCS-WEB SOIL SURVEY, HOWARD COUNTY NOTE:

HIGHLY ERODIBLE SOILS ARE THOSE SOILS WITH A SLOPE GREATER

THAN 15 PERCENT OR THOSE SOILS WITH A SOIL ERODIBILITY FACTOR

K GREATER THAN 0.35 AND WITH A SLOPE GREATER THAN 5 PERCENT

463.00 | 462.00 | 461.75 | 459.75 | 459.42 | 1.00 | 458.42 | 458.67

467.00 | 466.00 | 465.75 | 463.75 | 463.42 | 1.00 | 462.42 | 462.67

#4 | 471.00 | 470.00 | 469.75 | 467.75 | 467.42 | 1.00 | 466.42 | 466.67

#3

KAProjects105-43/ENGRIdwg1ECP103\_SWM\_DAM.dwg,-4/8/2016 3:27:19 PM

ECP-15-64

3 SHEET 3

SCALE:

AS SHOWN

05-43