
#### GENERAL NOTES

- 1. Approximate location of existing mains is shown. The Contractor shall take all necessary precautions to protect existing mains and services and to maintain all uninterrupted water supply. Any damage incurred shall be repaired immediately to the satisfaction of the Engineer at the Contractor's expense.
- 2. Topographic field surveys were performed on August, 1995 by PATTON HARRIS RUST & ASSOCIATES (formerly Riemer Muegge & Associates).
- 3. Horizontal and Vertical Survey Controls: The coordinates shown on the drawings are based on the Maryland State Plane Coordinate System (NAD '83/91) as projected by Howard County Geodeitc Control Stations No.16IA and No. 16IB. All vertical controls are based on NAVD '88.
- 4. All pipe elevations shown are invert elevations, unless otherwise noted.
- 5. Clear all utilities by a minimum of 12". Clear all poles by 5'-0" minimum or tunnel as required, unless otherwise noted. The Owner has contacted the utility companies and has made arrangements for bracing of poles as shown on the drawings. In the event the Contractor's work requires the bracing of additional poles, any cost incurred by the Owner for the bracing of additional poles or damages shall be deducted from money owed the Contractor. The Contractor shall coordinate with the utility companies to schedule the bracing of the poles.
- 6. For details not shown on the drawings, and for materials and construction methods, use Howard County Design Manual, Volume IV, Standard Specifications and Details for Construction and MSHA Standards and Specifications (latest edition). The Contractor shall have a copy of Volume IV on the job at all times.
- 7. Where test pits have been made on existing utilities, they are noted by the symbol 🖫 at the location of the test pit. A note or notes containing the results of the test pit or pits is included on the Drawings. Existing utilities in the vicinity of the proposed work for which test pits have not been dug shall be located by the Contractor two weeks in advance of construction operations at his own expense.
- 8. Contractor shall notify the following utility companies or agencies at least five working days before starting work shown on these plans:


AT&T	1-800-252-113
BGE (Construction Services)	
BGE (Emergency)	
Bureau of Utilities	
Colonial Pipeline Co	
Miss Utility	
State Highway Administration	
Verizon1-800-743-0	

- 9. Trees and shrubs are to be protected from damage to the maximum extent. Trees and shrubs located within the construction strip are not to be removed or damaged by the Contractor.
- 10. Contractor shall remove trees, stumps and roots along the line of excavation. Payment for such removal shall be included in the unit price bid for construction of the main.
- 11. The contractor shall notify the Bureau of Highways, Howard County, at (410)-313-7450 at least five working days before open cutting or boring/jacking of any County road for laying water/sewer mains or house connections. The approval of these drawings will constitute compliance with DPW requirements per section 18.114(a) of the Howard County Code.
- 12. All water mains to be D.I.P. Class 54, unless otherwise noted.
- 13. Top of all water mains shall have a minimum of 3'-6" of cover unless otherwise noted.
- 14. Valves adjacent to tees shall be strapped to tee.
- 15. All fittings shall be buttressed or anchored with concrete in accordance with the Standard Details, unless otherwise provided for on the drawings.
- 16. The Contractor shall not operate any water main valves on the existing water system.
- 17. Trench repair shall be in accordance with Howard County Standard Details.
- 18. All work shall be in accordance with Howard County Standards and specifications for Soil Erosion and Sediment Control Section 219.
- 19. All mechanical components removed from the water pumping station shall be transported, at the Contractor's expense, to the Little Patuxent Water Reclamation Facility, unless otherwise agreed to by the County.
- 20. Sections and Elevations:

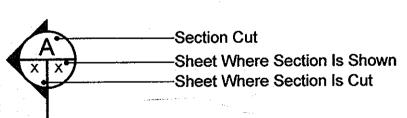

## HOWARD COUNTY

DEPARTMENT OF PUBLIC WORKS ELLICOTT CITY, MARYLAND 21043

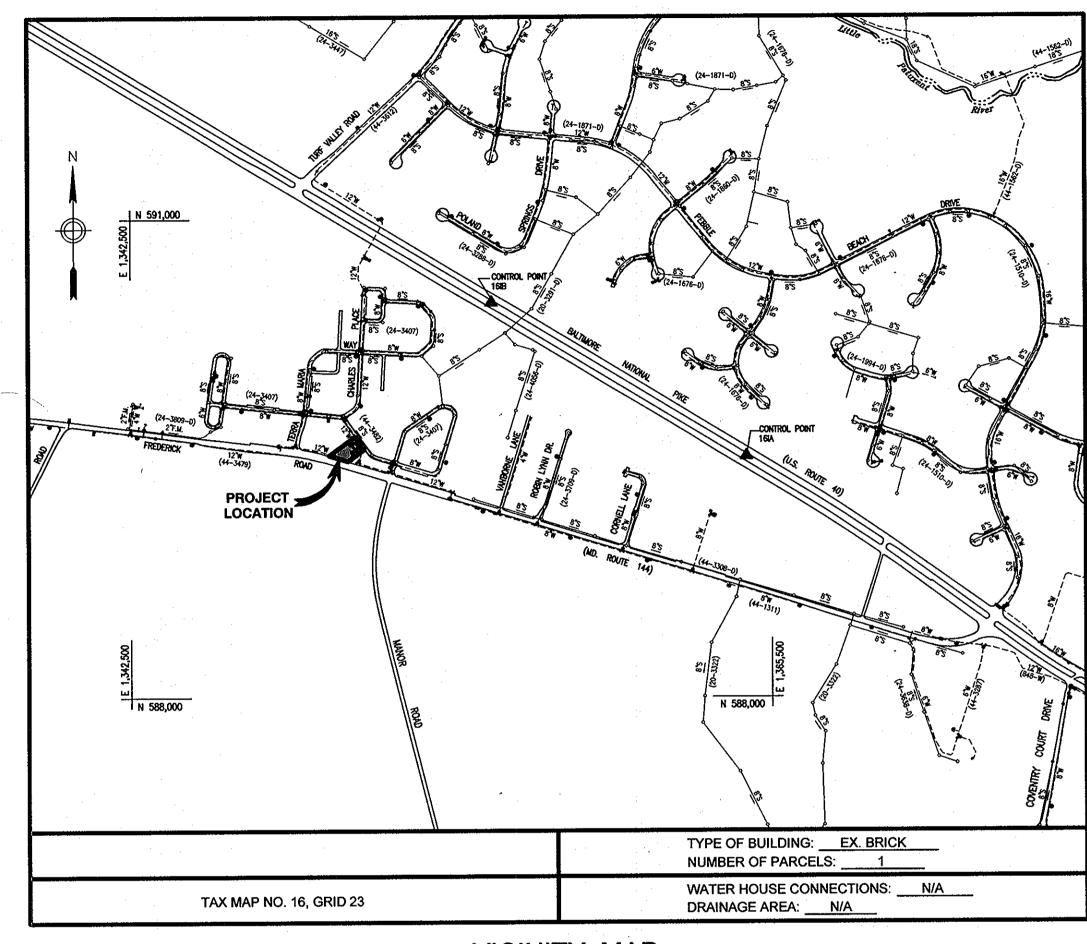

VICINITY MAP

# FREDERICK ROAD PUMPING STATION UPGRADES

CAPITAL PROJECT W-8264 CONTRACT NO. 44-4468

		· _	INDEX OF SHEETS
	SHEET NO.	DWG. NO.	DESCRIPTION
	. 1	C-1	TITLE SHEET
	2	M-1	EXISTING PUMP STATION PLANS, SECTIONS AND DEMOLITION
	- 3	M-2	PROPOSED PUMP STATION PLANS AND SECTIONS
	4	M-3	PUMP CURVE & MISCELLANEOUS DETAILS
٠.	5	H-1	HVAC NOTES, ABBREVIATIONS, SYMBOLS AND DETAILS
	6	E-1	ELECTRICAL ABBREVIATIONS, NOTES AND SYMBOLS
	7	E-2	ELECTRICAL FLOOR PLANS AND DETAILS
	8	E-3	ELECTRICAL SCHEMATICS AND DETAILS
	9	E-4	ELECTRICAL RISER & ONE LINE DIAGRAM
	10	E-5	ELECTRICAL SCHEDULES AND DETAILS
		•	

		NAUC	TITIES			
ITEN	1	UNIT	ESTIMATE	AS-BUILT	SUPPLIER	
FURNISH AND INSTAI PUMPS, VALVES AND		EACH	3	3	Gould/Kennedy	
MISC. PIPING, PRESSURE/SURGE VALVES FLOW ELEMENT AND SPOOL PIECES		LOT			LOBE & COMPANY CLAVAL	
DIESEL GENERATOR SYSTEMS	AND SUPPORT	EACH	1		Kohler	
VFD DRIVES		EACH		3	GEMENS (CUTLER	HAMME
ELECTRICAL WIRING CONNECTIONS	, DEVICES, AND	LOT	1	<b>t</b>	CME	
CONTROL WIRING, DEVICES, CONNECTIONS AND PROGRAMMING		LOT	<b>.</b>	1	SIEMENS	
REPLACE/REPAIR QUOINS		EACH	4	4	N/A	
NAME OF UTILITY CONTRACTOR:		EM	H ENVIRO	UMENTAL,	INC.	21 C
	CHECK BOX			a.		
	AS-BUILT DATE :				the state of the state of the	

establish materials and augntities needed for this project.

NOTE: BUILDING WAS TREATED FOR TERMITIES ON 11-19-12 AND IS
GUARANTEED FOR ONE (1) YEAR. INFESTATION WITHIN THAT
YEAR WILL BE TREATED BY TERMINIX AFTER THEIR
CONFIRMATION OF INFESTATION FREE OF CHARGE.

02-04-13

DWG. NO.

SCALE:

SHOWN

**DEPARTMENT OF PUBLIC WORKS** 

HOWARD COUNTY, MARYLAND

Dewberry Dewberry & Davis LLC

BALTIMORE, MD 21244-2662

FAX: 410.265.8875



DES: FRN	EDN	- 1				
	FIXIN					
DRN:	AZW					
CHK:	TND		ļ	<u> </u>	·.	· · · · · · · · · · · · · · · · · · ·
DATE:	0 /11 /00					
	2/11/09	BY	NO.			REVISIONS

TITLE SHEET

BLOCK NO. 23

600' SCALE MAP NO. 16


FREDERICK ROAD **PUMPING STATION UPGRADES CAPITAL PROJECT W-8264** 


**ELECTION DISTRICT NO. 2** 


**CONTRACT 44-4468** 

HOWARD COUNTY, MARYLAND

SHEET 1 OF 10

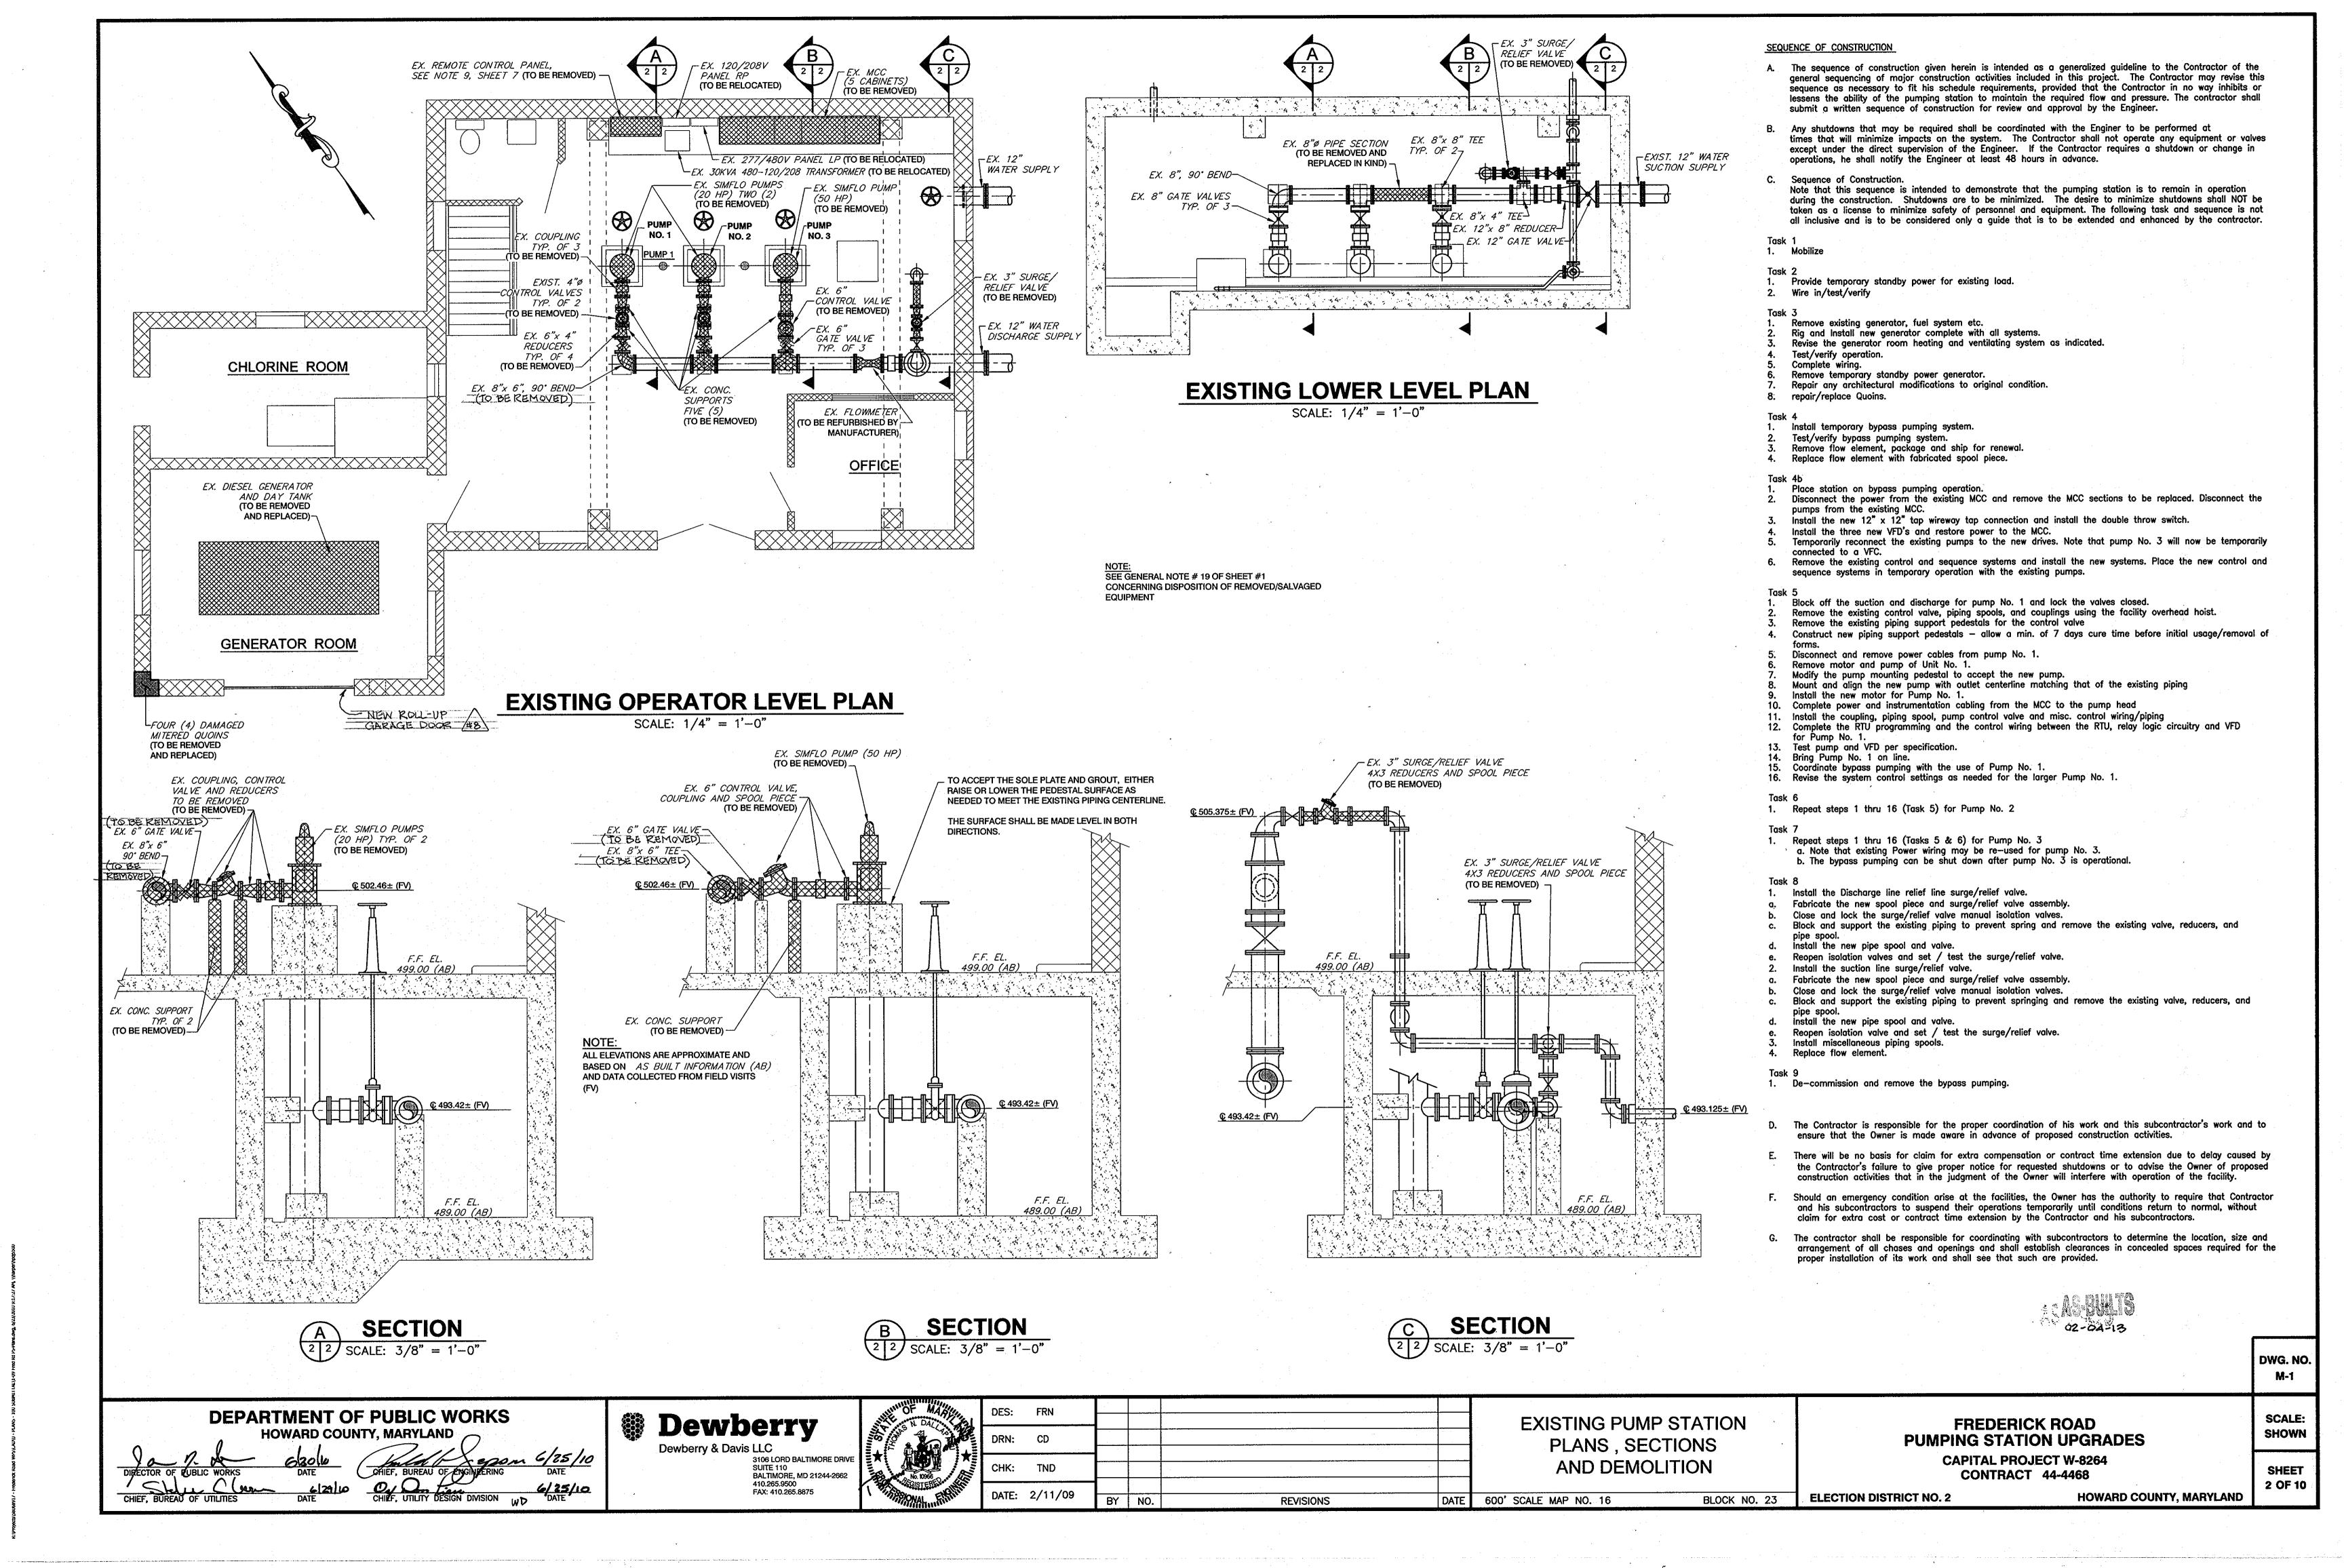


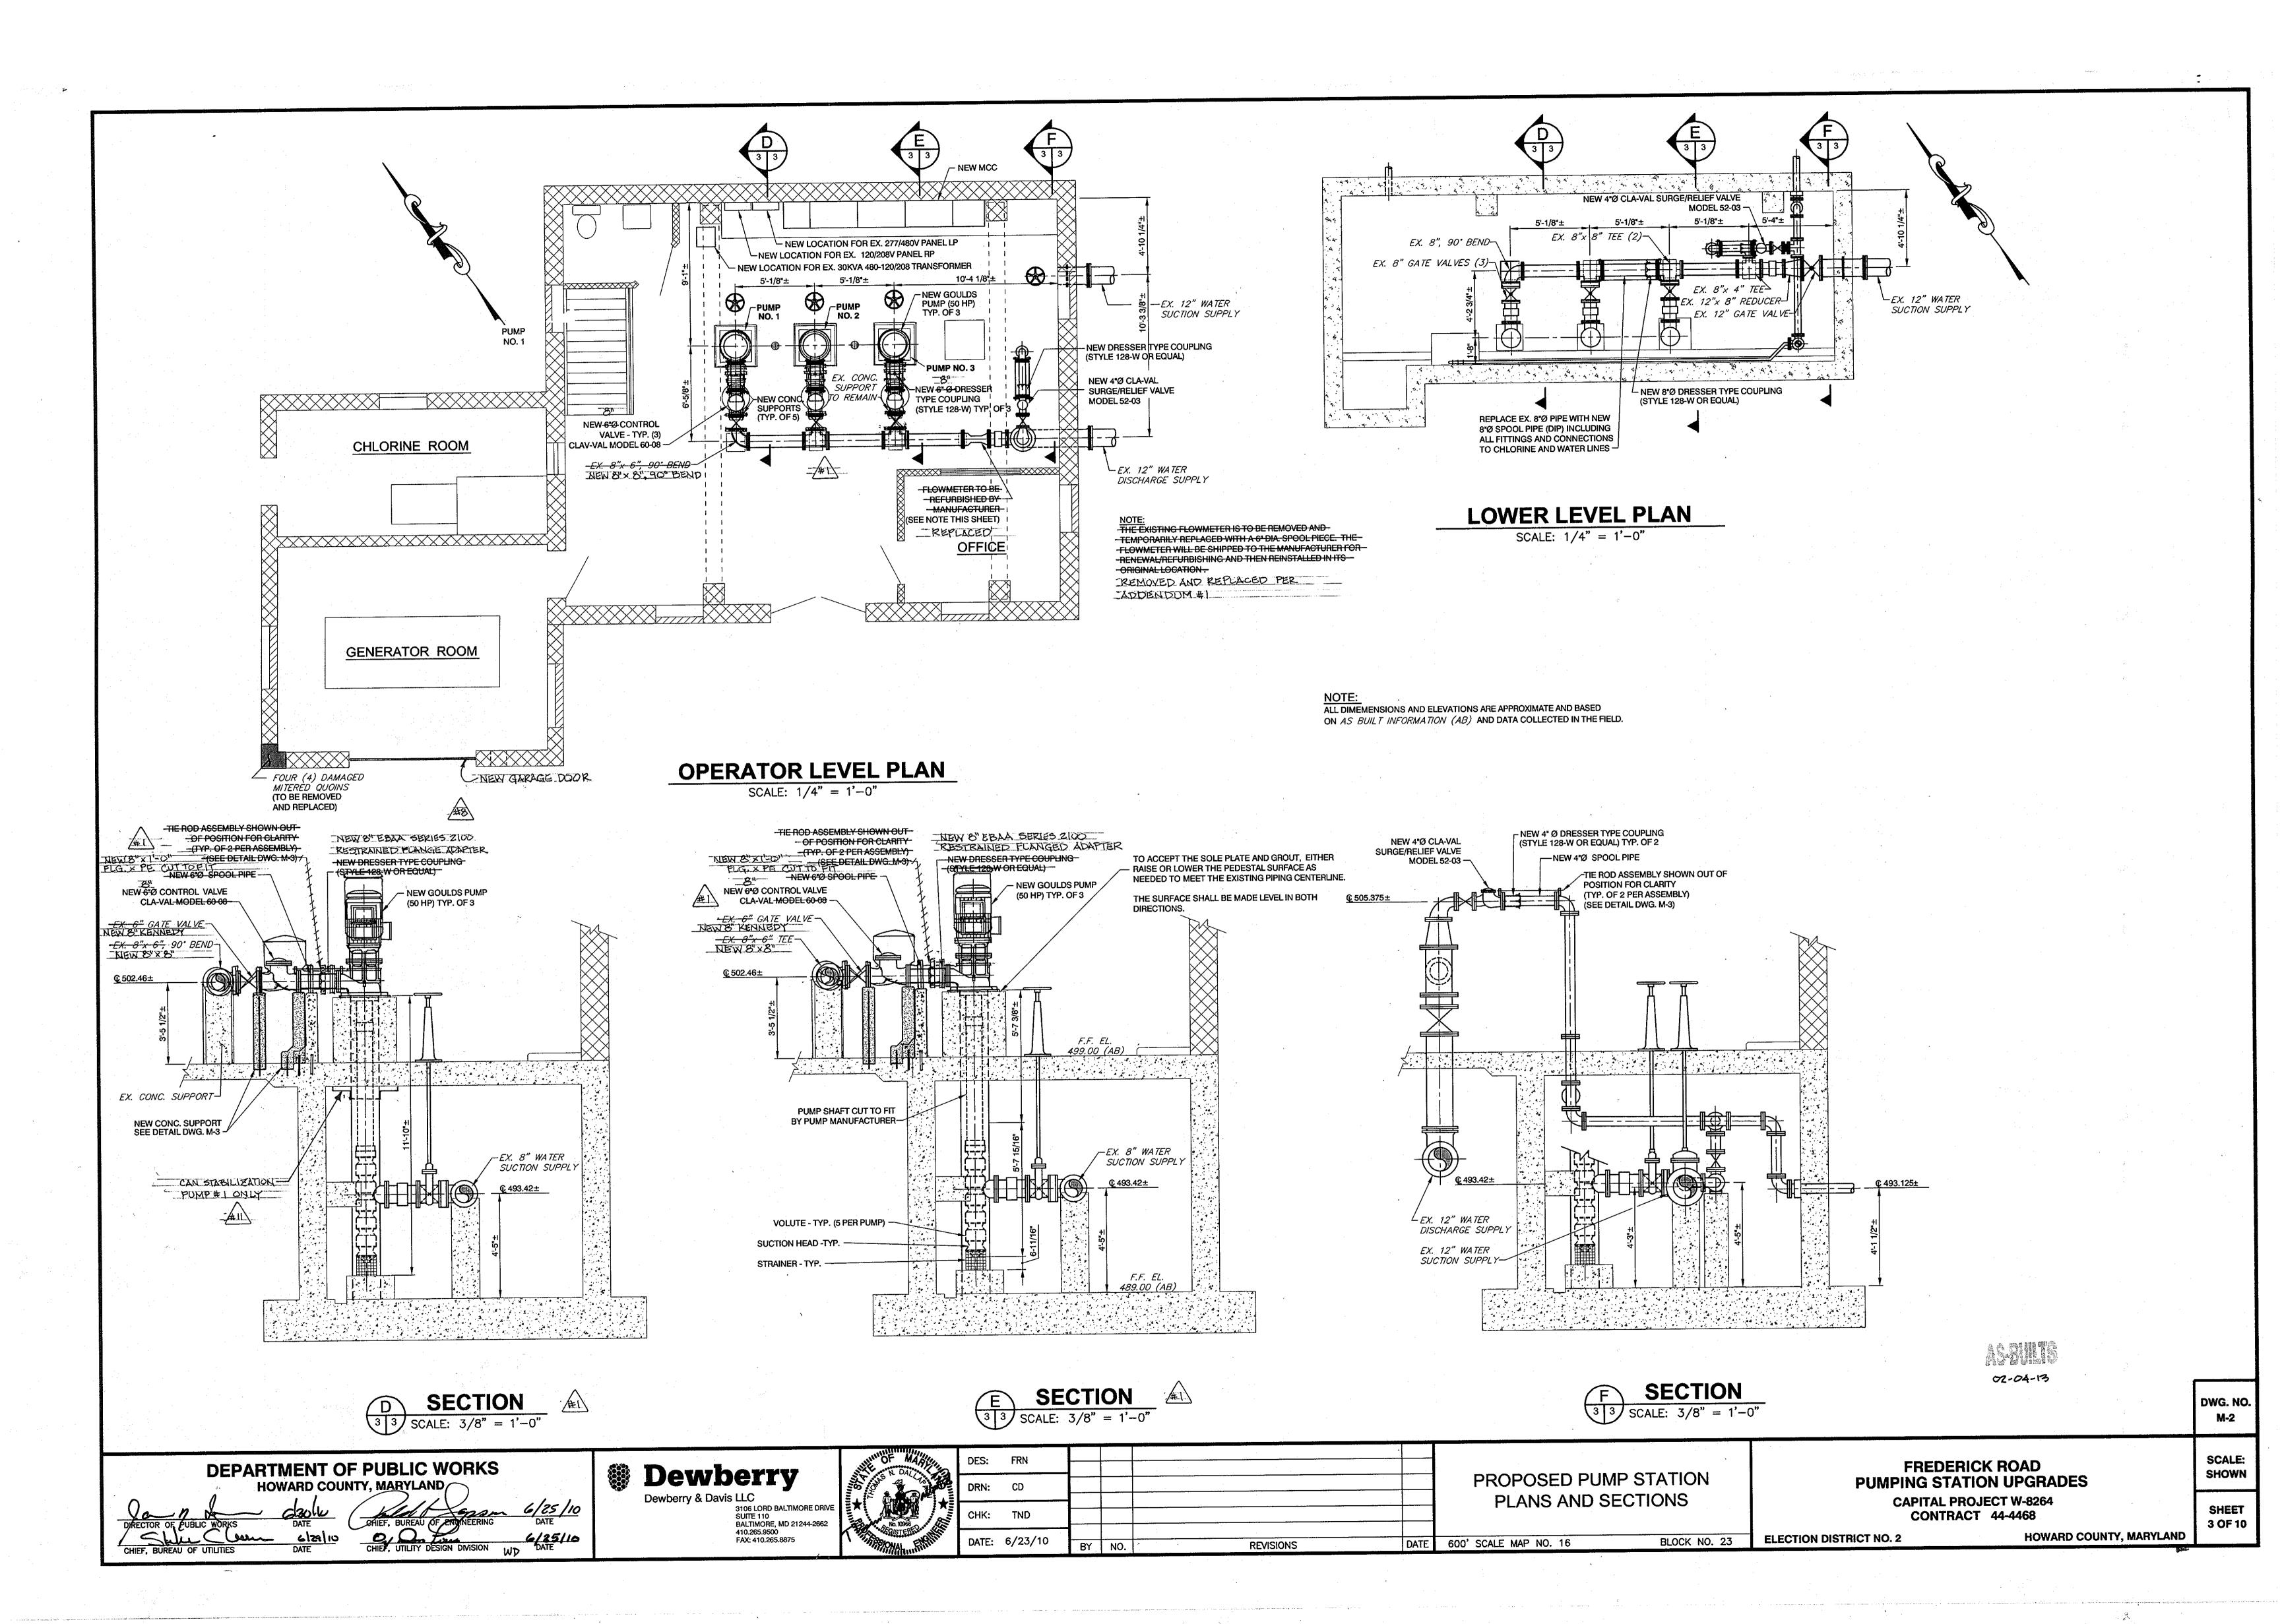

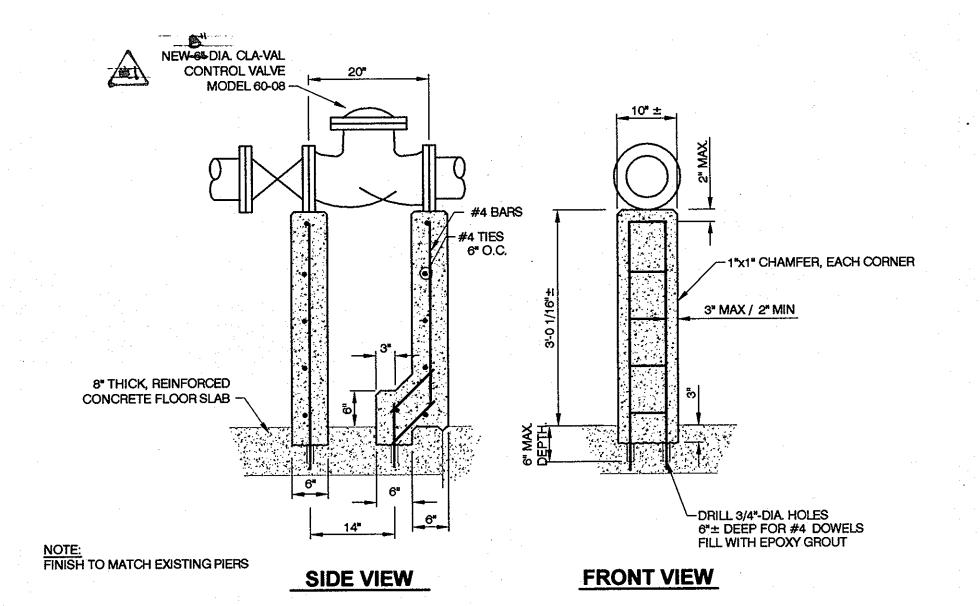


## **DETAIL - NEW CONCRETE SUPPORTS**

SCALE: 3/4" = 1'-0"

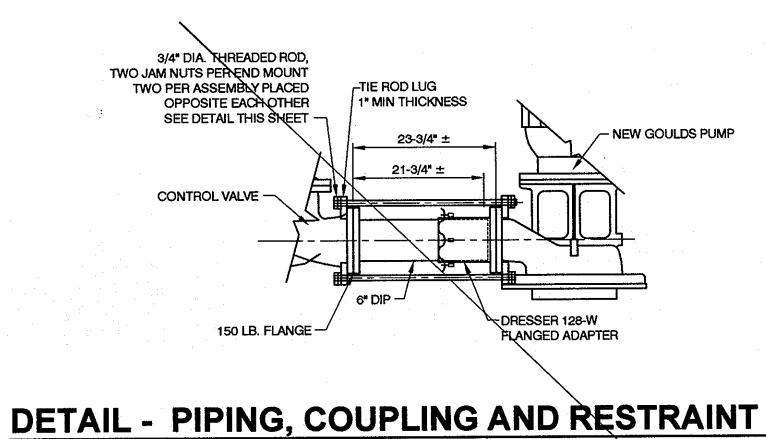


SCALE: 3/4" = 1'-0"

SEE M-2 SECTION E

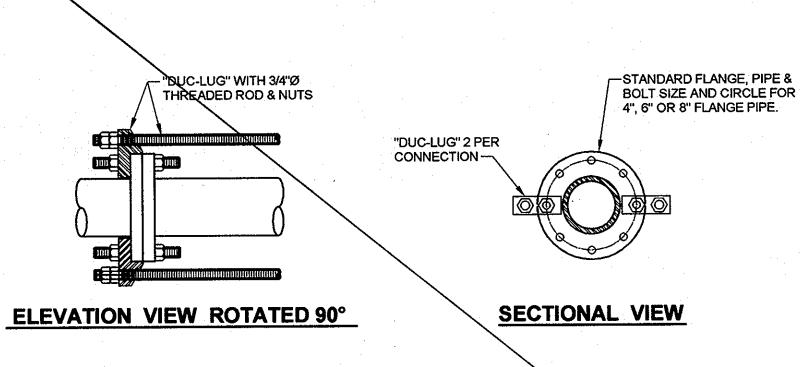


DETAIL - TIE ROD LUG FOR 4", 6" & 8" PIPE

SCALE: 1-1/2" = 1'-0"

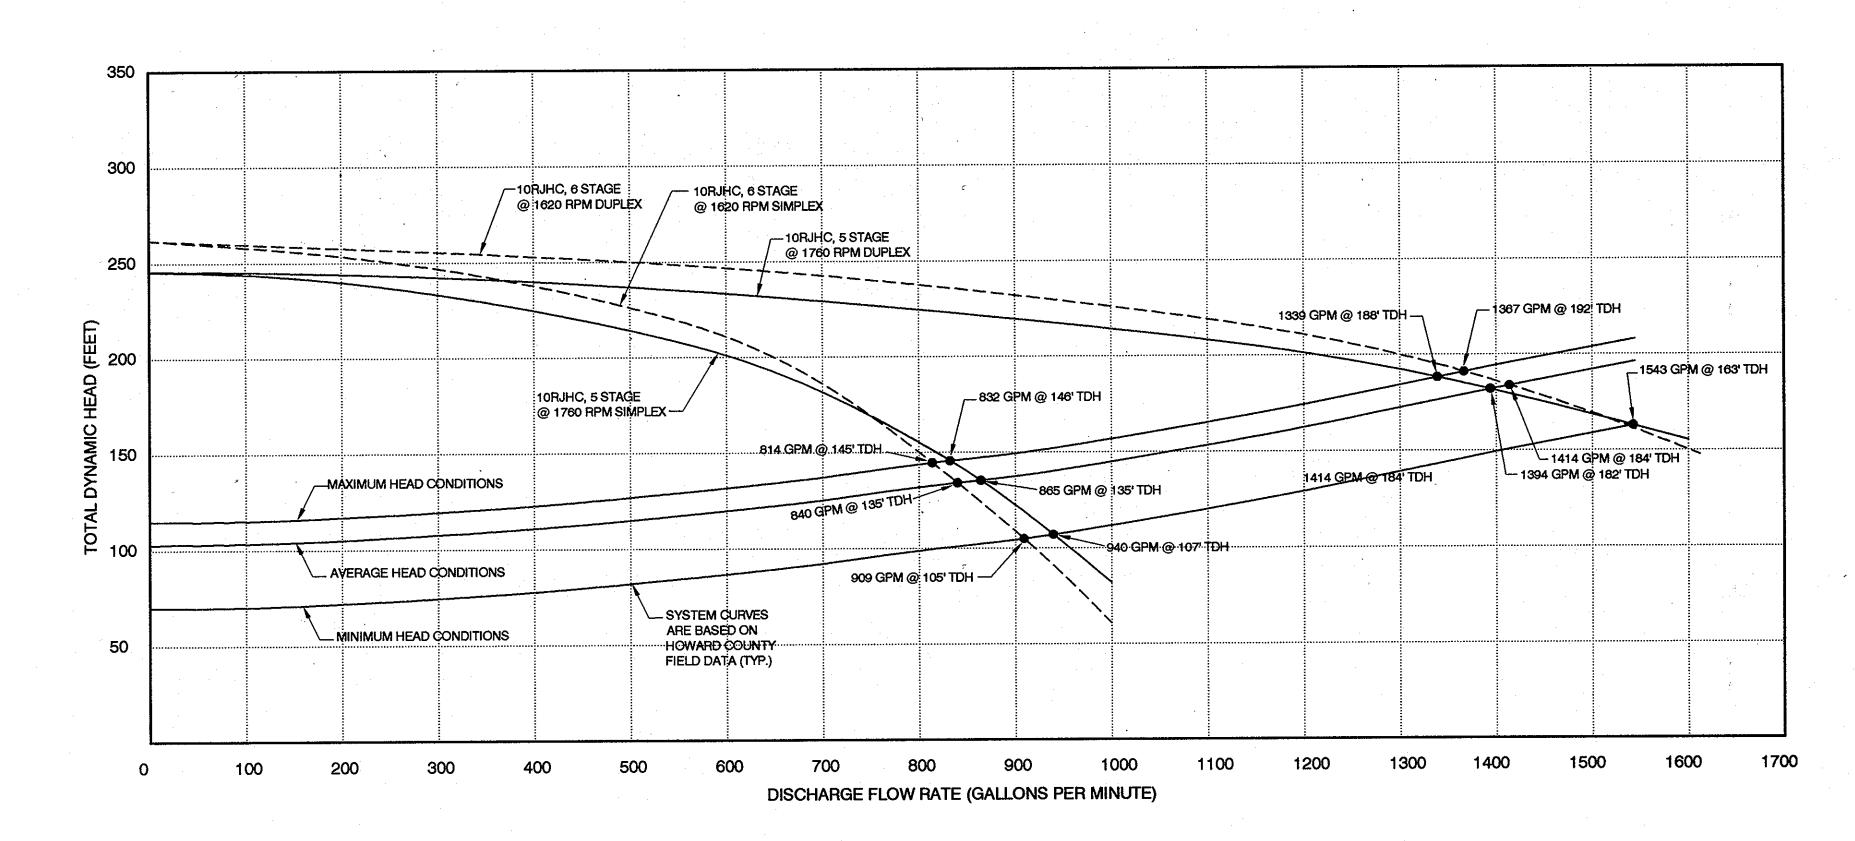


## PUMPING STATION SYSTEM CURVE FOR THE 730 ZONE USING GOULDS 10RJHC 5 STAGE @ 1760 RPM VERTICAL TURBINE PUMPS

SCALE: H: 1" = 100 gpm V: 1" = 50 feet

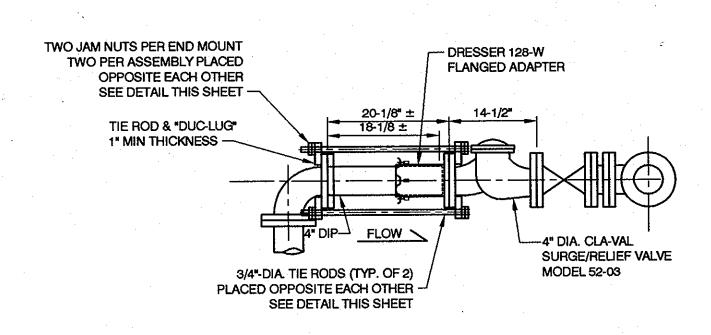

SUPPLY LINE LOWER LEVEL

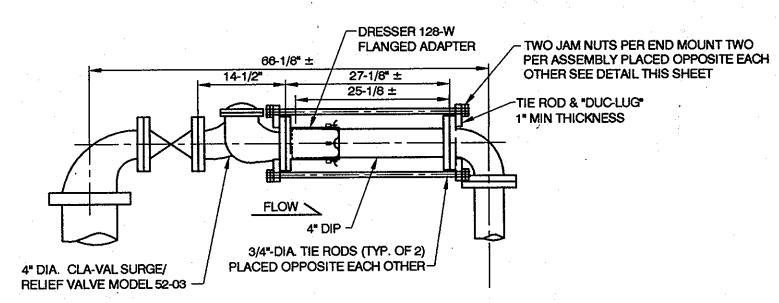

DISCHARGE LINE UPPER LEVEL

## DETAIL - NEW SURGE/RELIEF VALVE INSTALLATION

SCALE: 3/4" = 1'-0"

BLOCK NO. 23

AS-BUILTS

43°DUILI3 °C- 04-13

-13 DWG. 1 M-3

DEPARTMENT OF PUBLIC WORKS

HOWARD COUNTY, MARYLAND

DIRECTOR OF PUBLIC WORKS

DATE

CHIEF, BUREAU OF ENGINEERING

DATE

Dewberry & Davis LLC

SUITE 110 BALTIMORE, MD 21244-2662

410.265.9500 FAX: 410.265.8875



		·····		, -			
Mar.	DES:	FRN			<u> </u>		PUMP (
	DRN:	CD					MISCELLANE
THE WARREN	СНК:	TND					
All frit	DATE:	6/23/10	BY	NO.	REVISIONS	DATE	600' SCALE MAP NO. 16

PUMP CURVE &
MISCELLANEOUS DETAILS

FREDERICK ROAD
PUMPING STATION UPGRADES
CAPITAL PROJECT W-8264
CONTRACT 44-4468


**ELECTION DISTRICT NO. 2** 


HOWARD COUNTY, MARYLAND


SHEET 4 OF 10

SCALE:

SHOWN

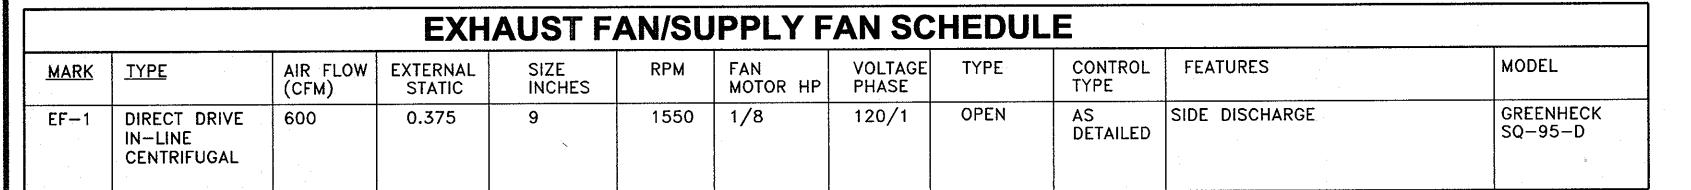

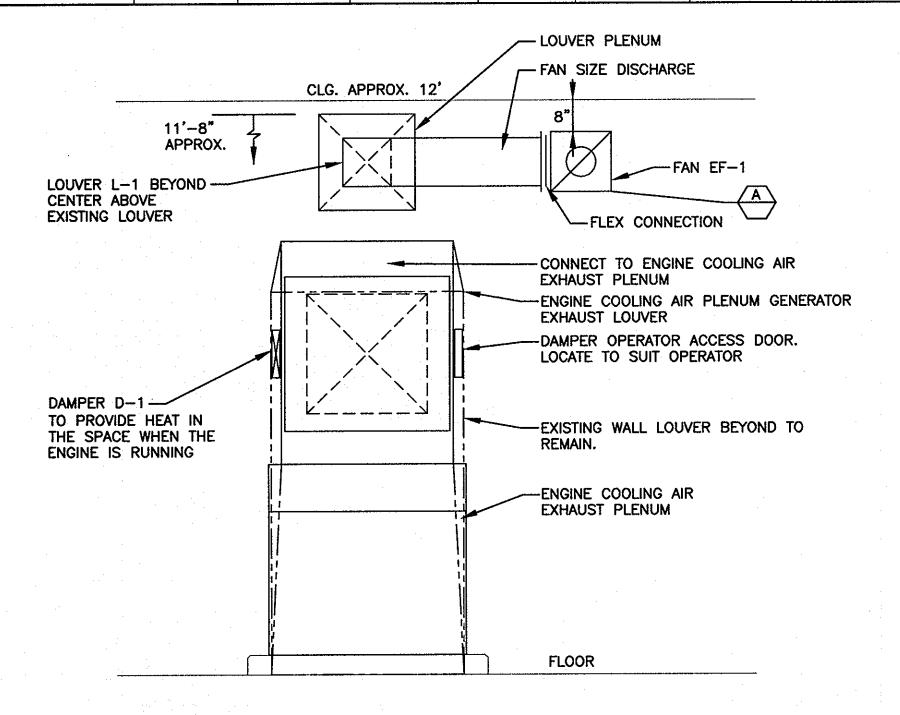

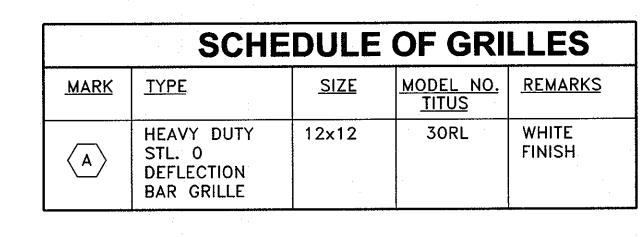

## HEATING AND **VENTILATING ABBREVIATIONS**

HORSEPOWER

		11011021 011211
ÇFI	M	CUBIC FEET PER MINUTE
CL(	G	CEILING
DN		DOWN
EX		EXISTING
EA		EACH
EF		EXHAUST FAN
FLF	?	FLOOR
ELE	EC	ELECTRICAL
ESI	P	EXTERNAL STATIC PRESSURE
IN	WG	INCH WATER GAUGE
KW	<b>,</b>	KILOWATT
MT	D	MOUNTED
SP		STATIC PRESSURE
T'S	SAT -	THERMOSTAT
TYF	· .	TYPICAL


		•			:		
SCHEDULE OF LOUVERS AND DAMPERS							
MARK	TYPE	USE	HxW IN.	FREE AREA SQ. FT.	REMARKS	TYPE	
L-1	LOUVER	EXHAUST	24×24	0.70	NOTE 1	DUAL COMBINATION	
D-1	DAMPER	SUPPLY	16×24	2.1	NOTE 1	LOW LEAKAGE CONTROL	

1. MOTOR OPEN, SPRING CLOSED 120VAC OPERATOR.

#### TYPE:

L-1 TO MATCH EXISTING IN FINISH. EXTRUDED ALUMINUM DUAL COMBINATION, BAKED ENAMEL FINISH WITH REMOVABLE ALUMINUM BIRD SCREEN. EQUAL TO C/S MODEL 4115/4830.


D-1 LOW LEAKAGE AIR FOIL CONTROL DAMPER. GALVANIZED STEEL CONSTRUCTION EQUAL TO RUSKIN CD-60.

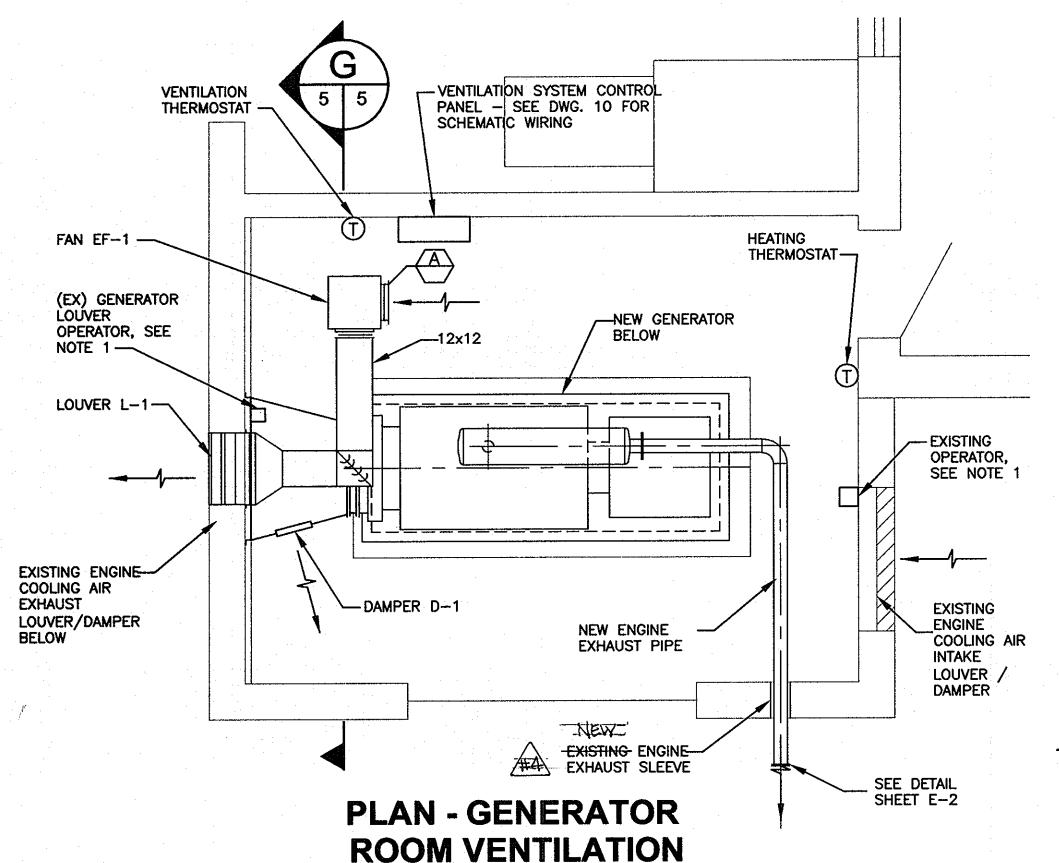

SCALE: 3/8" = 1'-0"


**SECTION** 

 $5 \mid 5$  SCALE: 1/2" = 1'-0"

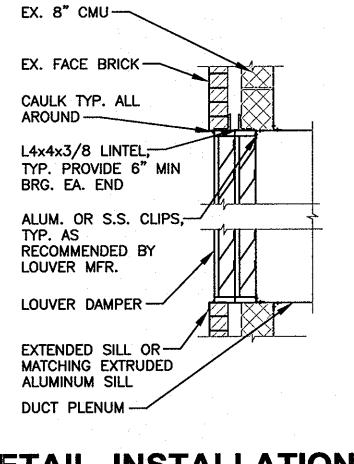



6/23/10

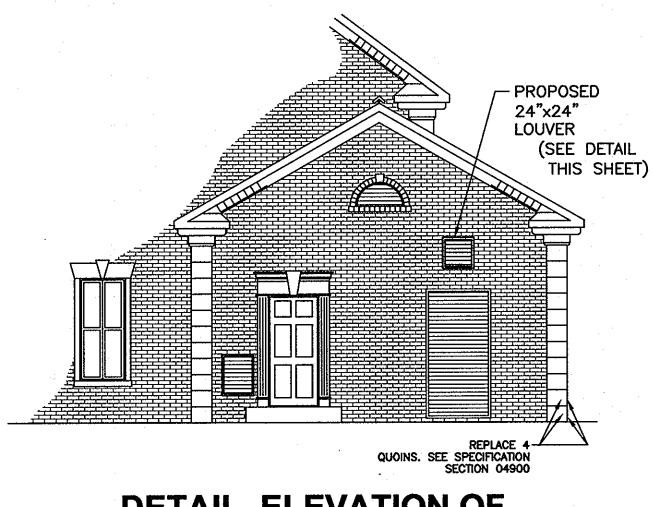


**DETAIL, ELEVATION OF LOUVER L-1 IN EX. WALL** SCALE: NTS

## HEATING AND VENTILATING GENERAL CONSTRUCTION NOTES

- 1- ALL WORK SHALL BE DONE IN ACCORDANCE WITH NATIONAL FIRE PROTECTION ASSOCIATION STANDARD 90A, "INSTALLATION OF AIR CONDITIONING AND VENTILATING SYSTEMS", SHEET METAL AND AIR CONDITIONING CONTRACTOR'S NATIONAL ASSOCIATION, "HVAC DUCT CONSTRUCTION STANDARDS-METAL AND FLEXIBLE", AND THE HOWARD COUNTY BUILDING CODE.
- 2- PRIOR TO BID. THE CONTRACTOR SHALL EXAMINE ALL PROJECT DRAWINGS TO DEVELOP A COMPLETE UNDERSTANDING OF THE PROJECT SCOPE. FAILURE TO REVIEW ALL CONTRACT DOCUMENTS WILL NOT RELIEVE THE CONTRACTOR OF THE RESPONSIBILITY TO PERFORM ALL WORK REQUIRED.
- 3- CONTRACTOR SHALL COORDINATE THE WORK WITH OTHER TRADES BEFORE FABRICATION AND INSTALLATION.
- 4- CONTRACTOR IS RESPONSIBLE TO PROVIDE A COMPLETE AIR DISTRIBUTION SYSTEM(S) AS REQUIRED BY SMACNA STANDARDS AND A COMPLETE INSTALLATION OF ALL EQUIPMENT AS REQUIRED BY CODE AND THE UNIT MANUFACTURER AT NO ADDITIONAL COST TO THE OWNER REGARDLESS WHETHER THE ITEMS ARE SHOWN ON THE PLAN OR COVERED IN THE SPECIFICATIONS. SUCH ITEMS COULD BE, BUT NOT LIMITED TO, SUPPORT, VIBRATION ELIMINATORS, MOTOR CONTROLS, INSULATION, ELECTRICAL WIRING, LUBRICATION, REFRIGERANTS. START-UP AND SERVICE, ETC.
- 5- ALL NEW DUCTWORK SHALL RUN AS HIGH AS POSSIBLE UNLESS NOTED OTHERWISE. ALL DUCT SIZES SHOWN ARE CLEAN INSIDE DIMENSIONS. 90 DEGREE ELBOW DUCTS ARE TO HAVE RADII OF 1.5 TIMES THE DUCT WIDTH.
- 6- MOUNT THERMOSTAT 4'-6" ABOVE FINISHED FLOOR UNLESS OTHERWISE NOTED OR INDICATED.
- 7- SYSTEMS SHALL BE BALANCED AND TESTED AT THE COMPLETION OF THE PROJECT AND SHALL BE CHECKED FOR VIBRATION AND NOISE DEEMED EXCESSIVE BY THE ENGINEER. ALL SUCH CONDITIONS SHALL BE CORRECTED. PROVIDE TEST REPORT TO OWNER.

#### **HEATING AND VENTILATING SYMBOLS**

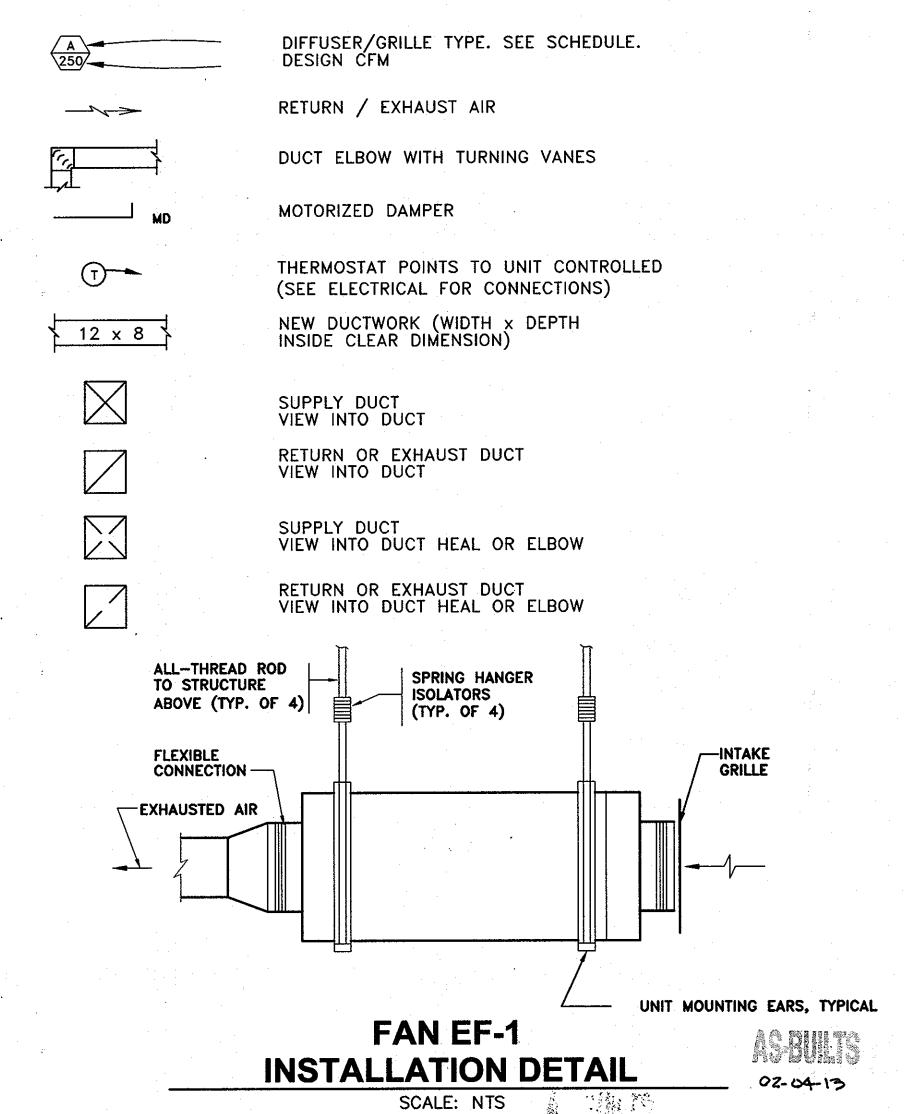

DWG. NO.

SCALE:

SHOWN

**DEPARTMENT OF PUBLIC WORKS** HOWARD COUNTY, MARYLAND

MOTOR CLOSED OPERATORS SIZED TO OPERATE 48"Wx96"H

CONSTRUCTION SPECIALTIES 4115/4830 LOUVER/DAMPERS.

1. REPLACE EXISTING LOUVER OPERATORS WITH 120VAC SPRING OPEN,

Dewberry **Dewberry & Davis LLC** 

3106 LORD BALTIMORE DRIVE

BALTIMORE, MD 21244-2662

FAX: 410.265.8875

I, HEREBY CERTIFY THAT THESE DOCUMENTS WERE PREPARED OR

APPROVED BY ME, AND THAT ! AM A DULY LICENSED PROFESSIONAL ENGINEER UNDER THE LAWS OF THE STATE OF MARYLAND,

LICENSE NO. 11529 EXPIRATION DATE: JULY 9, 2011

PROFESSIONAL CERTIFICATION

Warn Warne Blem


DES: DWB CHK: DWB DATE: 06/23/10 BY NO. DATE 600' SCALE MAP NO. 16 **REVISIONS** 


HVAC NOTES, ABBREVIATIONS, SYMBOLS & DETAILS

BLOCK NO. 23

FREDERICK ROAD **PUMPING STATION UPGRADES CAPITAL PROJECT W-8264 CONTRACT 44-4468** 

**ELECTION DISTRICT NO. 2 HOWARD COUNTY, MARYLAND**  SHEET 5 OF 10

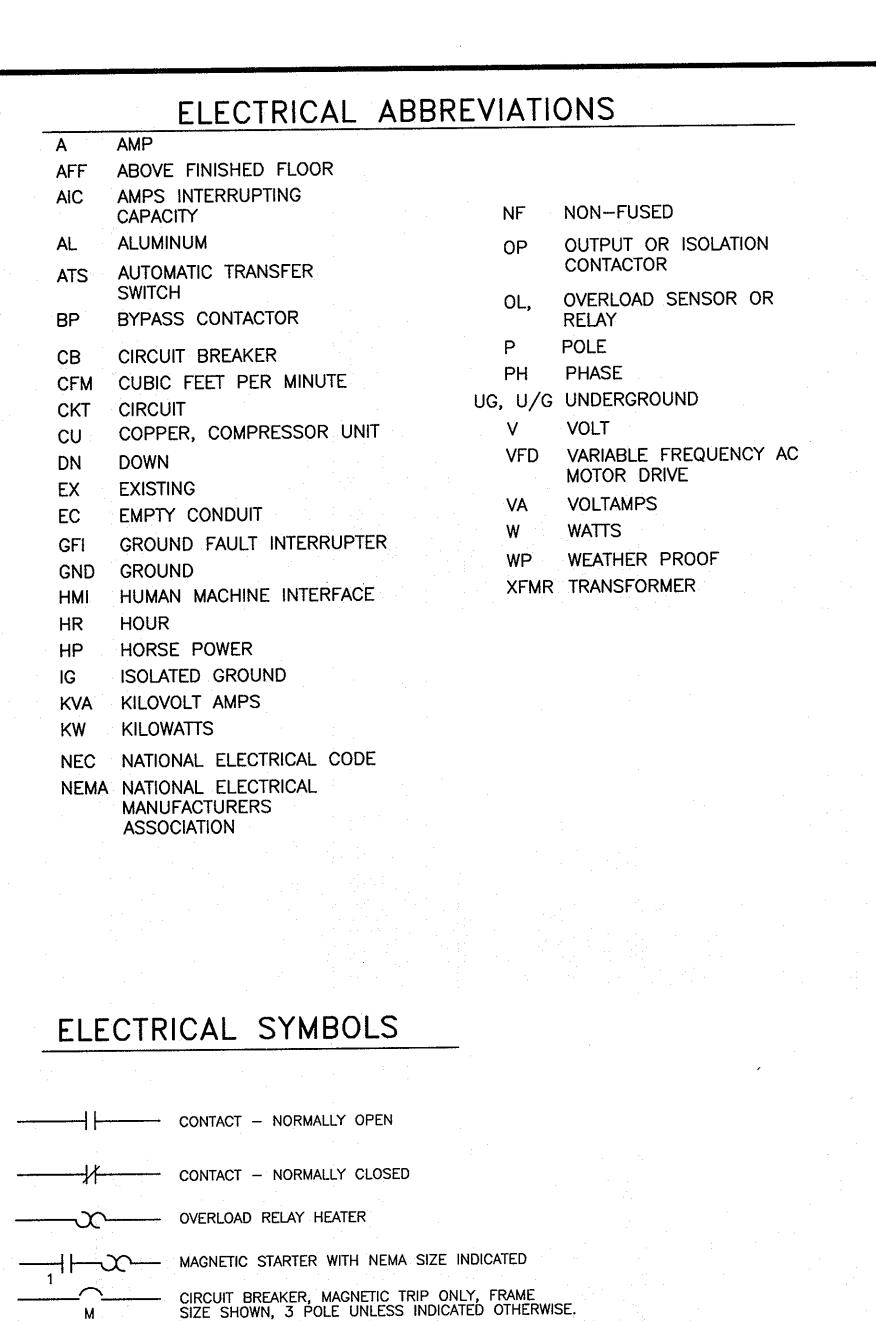

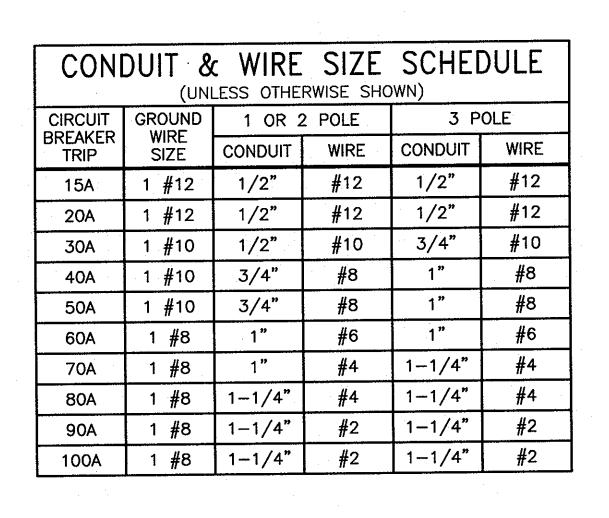

## ELECTRICAL SYMBOLS


- SINGLE POLE TOGGLE SWITCH 20 AMP, 120 VOLT, M.H. 48" AFF, UNLESS NOTED OTHERWISE.
- \$3 THREE WAY TOGGLE SWITCH 20 AMP, 120 VOLT, M.H. 48' AFF, UNLESS NOTED OTHERWISE.
- \$M MOTOR RATED SWITCH WITH THERMAL OVERLOAD PROTECTION, MOUNT ADJACENT TO OR ON THE MOTOR BEING CONTROLLED.
- JUNCTION BOX, CEILING OR WALL MOUNTED.
- DUPLEX GROUNDING TYPE RECEPTACLE 20 AMP, 120 VOLT, NEMA 5-20R, M.H. 18" AFF, UNLESS NOTED OTHERWISE.
- DOUBLE DUPLEX GROUNDING TYPE RECEPTACLE 20 AMP, 120 VOLT, NEMA 5-20R, M.H. 18" AFF, UNLESS NOTED OTHERWISE.
- DUPLEX RECEPTACLE WITH GROUND FAULT CIRCUIT INTERRUPTER PROTECTION - 20 AMP, 120 VOLT, NEMA 5-20R, M.H. 42" AFF, UNLESS NOTED OTHERWISE.
- THE DISCONNECT SWITCH, AMP, VOLT, POLES AND FUSING AS NOTED ON DRAWING.
- ELECTRIC MOTOR CONNECTION HORSEPOWER AS NOTED.
- POWER COMPANY METER, RATING AS INDICATED ON DRAWING.


BRANCH CIRCUIT CONDUIT AND WIRING WITH A DEDICATED EQUIPMENT GROUND WIRE. CROSSMARKS AND NUMERALS INDICATE NUMBER AND SIZE OF CONDUCTORS, AND SHOWN ONLY WHERE REQUIRED FOR CLARITY.

BRANCH CIRCUIT CONDUIT AND WIRING WITH A DEDICATED EQUIPMENT GROUND WIRE, UNDER GROUND OR UNDER SLAB. CROSSMARKS AND NUMERALS INDICATE NUMBER AND SIZE OF CONDUCTORS, AND SHOWN ONLY WHERE REQUIRED FOR

- HOMERUN WIRING WITH A DEDICATED EQUIPMENT GROUND WIRE TO THE REFERENCED PANELBOARD. ARROW HEADS AND NUMERALS INDICATE THE CIRCUIT NUMBERS.
- CONDUIT SEALING FITTING

## ELECTRICAL SYMBOLS CONT'D

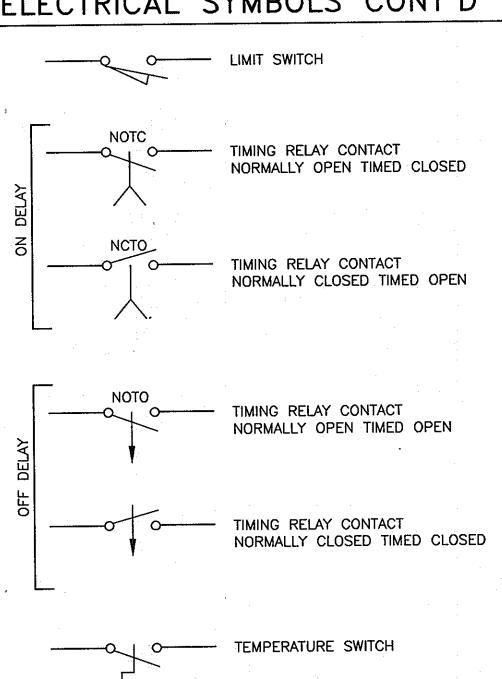

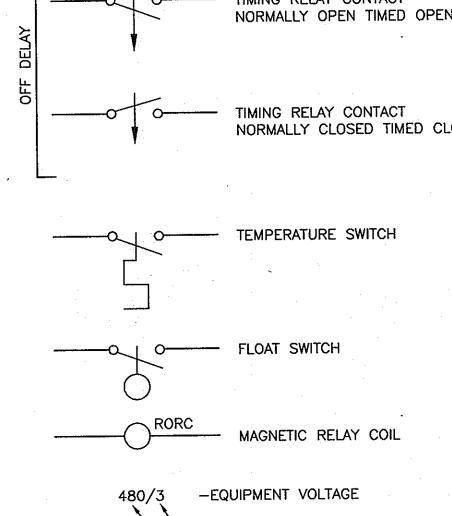

-- INDICATES PHASE

- INDICATES VOLTAGE

### ELECTRICAL DEMOLITION NOTES

- 1. THE CONTRACTOR SHALL REMOVE EXISTING WORK AS CALLED FOR ON THE DRAWINGS OR AS REQUIRED TO CLEAR THE AREAS OF NEW CONSTRUCTION.
- 2. WHERE EXISTING EQUIPMENT IS TO BE RELOCATED, CARE SHALL BE TAKEN TO PREVENT DAMAGE DURING THE REMOVAL AND REINSTALLATION. WHERE DAMAGE OCCURS, THE EQUIPMENT SHALL BE REPLACED OR REPAIRED AT NO ADDITIONAL COST TO THE
- 3. ALL EQUIPMENT REMOVED THAT IS NOT BEING REUSED SHALL REMAIN THE PROPERTY OF THE OWNER AND SHALL BE STORED OR DISPOSED OF AS DIRECTED.
- EXCEPT AS OTHERWISE NOTED, ALL EXTISTING ELECTRICAL MATERIAL AND EQUIPMENT RENDERED OBSOLETE AND WHICH MAY BE DISTURBED DUE TO CHANGES REQUIRED BY THIS WORK SHALL BE RESTORED TO ITS ORIGINAL OPERATING CONDITION. OTHER ELECTRICAL EQUIPMENT AND/OR MATERIAL RENDERED OBSOLETE SHALL BE ABANDONED WHERE CONCEALED AND REMOVED WHERE EXPOSED. OLD UNUSED WIRING SHALL BE REMOVED FROM THE ABANDONED(CONCEALED) CONDUITS. ANY CONDUITS STUBBED OUT OF CONCRETE SURFACE SHALL BE CUT INTO SURFACE AND PATCHED.
- 5. WHERE EXISTING ELECTRICAL WORK INTERFERES WITH NEW WORK AND WHERE SUCH INSTALLATIONS ARE TO REMAIN IN USE, THE INSTALLATIONS SHALL BE DISCONTINUED AND RELOCATED AND/OR RECONNECTED TO COORDINATE WITH THE WORK INDICATED ON THE DRAWINGS AND AS SPECIFIED.
- WHERE EXISTING RACEWAYS THAT ARE NOT TO BE REUSED INTERFERE WITH NEW WORK, THESE RACEWAYS SHALL BE REMOVED BACK TO THE NEAREST JUNCTION BOX OR PULLBOX AND THE OPENINGS BLANKED.
- 7. EXISTING RACEWAYS AND/OR WIRING MAY BE REUSED WHERE PRACTICABLE.
- 8. ALL WORK SHALL BE PERFORMED IN SUCH A MANNER TO CREATE MINIMAL POWER OUTAGES FOR THE OWNER. ALL SUCH OUTAGES SHALL BE CAREFULLY COORDINATED WITH THE OWNER SO THAT POWER TO ESSENTIAL SERVICES CAN BE MAINTAINED.
- 9. CONTRACTOR SHALL MAINTAIN THE CONTINUITY OF CIRCUITS SERVING MULTIPLE ITEMS OF WHICH ONE OR MORE ARE BEING DEMOLISHED. CONDUCTORS AND CONDUITS FOR THOSE ITEMS BEING DEMOLISHED SHALL BE REMOVED AS FAR AS PRACTICABLE.
- 10. ALL EQUIPMENT INDICATED TO REMAIN IN PLACE SHALL REMAIN IN NORMAL OPERATION AT ALL TIMES DURING CONSTRUCTION. IF ANY CIRCUIT WIRING FEEDING THIS EQUIPMENT IS DAMAGED DURING CONSTRUCTION, THE CONTRACTOR SHALL REPLACE WITH NEW WIRING OF THE SAME SIZE AND TYPE.
- 11. WHERE EXISTING FLUORESCENT AND INCANDESCENT LIGHTING FIXTURES ARE INDICATED TO BE REMOVED, REMOVE FIXTURE, ALL MOUNTING APPURTENANCES, AND ALL BRANCH CIRCUIT WIRING FROM THE CONNECTION AT THE CIRCUIT BREAKER PANEL. WHERE THE FIXTURE IS CONTROLLED BY SWITCH, REMOVE THE WIRING, CONDUIT AND SWITCH.

## GENERAL ELECTRICAL CONSTRUCTION NOTES

- THE DRAWINGS INDICATE THE EXTENT AND GENERAL ARRANGEMENT OF THE ELECTRICAL SYSTEMS
- LOCATIONS OF LINES AND EQUIPMENT SHALL BE DETERMINED FROM ACTUAL FIELD CONDITIONS. THE OUTLINES OF THE CONSTRUCTION SHOWN ON THE ELECTRICAL DRAWINGS ARE INTENDED ONLY AS A GUIDE TO INDICATE RELATIVE LOCATIONS OF THE WORK. REFER TO THE EQUIPMENT SUPPLIER'S INSTALLATION INSTRUCTIONS FOR EXACT LOCATIONS AND ARRANGEMENTS.
- THE CONTRACTOR SHALL BE RESPONSIBLE FOR THE COORDINATION AND PROPER RELATION OF HIS WORK TO THE FACILITY STRUCTURES AND TO THE WORK OF OTHER TRADES. NO ADDITIONAL COMPENSATION NOR EXTENSION OF COMPLETION TIME WILL BE GRANTED FOR EXTRA WORK CAUSED BY THE LACK OF COORDINATION.
- DUE TO MINOR DIFFERENCES IN VARIOUS MANUFACTURER'S EQUIPMENT CONNECTIONS THE ELECTRICAL CONTRACTOR SHALL COORDINATE HIS INSTALLATION WITH THAT EQUIPMENT ACTUALLY FURNISHED AND SHALL VERIFY THE CORRECT SIZES AND DETAILS OF INSTALLATION BEFORE ROUGHING IN.
- THE ELECTRICAL CONTRACTOR SHALL CONSULT WITH THE GENERAL CONSTRUCTION SUPERINTENDENT REGARDING THE LOCATION OF EQUIPMENT, DOOR SWINGS, BLOCK COURSING, ALIGNMENT OF THIS AND OTHER SIMILIAR FEATURES BEFORE ROUGHING IN FOR SWITCHES, RECEPTACLES. THERMOSTATS, AND SIMILAR WIRING DEVICES.
- THE CORRECT NUMBER OF WIRES IS NOT INDICATED FOR MOST BRANCH CIRCUITS, ONLY THOSE WHERE CLARIFICATION IS NECESSARY. THE ELECTRICAL CONTRACTOR SHALL PROVIDE ALL WIRES NECESSARY FOR THE PROPER FUNCTION OF THE SYSTEM.
- ALL WORK SHALL COMPLY WITH THE CURRENT EDITION OF THE HOWARD COUNTY BUILDING CODE AND OTHER APPLICABLE LOCAL REGULATIONS.
- PAINTING: (WHERE NOT OTHERWISE SPECIFIED).
  - A. CONCEALED AREAS: ALL METAL SURFACES NOT OTHERWISE PROTECTED IN CONCEALED SPACES SHALL BE PAINTED WITH ONE THOROUGH COAT OF ENAMEL PAINT. COPPER, ALUMINUM, STAINLESS STEEL AND GALVANIZED MATERIAL SHALL NOT BE PAINTED EXCEPT WHERE GALVANIZED FINISH HAS BEEN DAMAGED.
  - B. FINISHED AREAS: ALL EQUIPMENT AND MATERIAL IN OTHER AREAS WILL BE PAINTED WITH TWO COATS OF ENAMEL PAINT APPLIED IN ACCORDANCE WITH THE WRITTEN INSTRUCTIONS OF THE PAINT MANUFACTURER.
  - C. PAINT SHALL BE APPLIED UNDER THE INSTRUCTION OF THE OWNER'S REPRESENTATIVE.

BLOCK NO. 23

9. THE CONTRACTOR SHALL INSTRUCT THE REPRESENTATIVE OF THE OWNER IN THE PROPER OPERATION AND MAINTENANCE OF ALL ELEMENTS OF THE ELECTRICAL SYSTEM

**ELECTION DISTRICT NO. 2** 



DWG. NO. E-1

SCALE:

#### **DEPARTMENT OF PUBLIC WORKS** HOWARD COUNTY, MARYLAND

INDICATING LIGHT - LETTER INDICATES COLOR

G — GREEN

R – RED

W — WHITE

FUSED SWITCH, SWITCH AND FUSE CURRENT RATING

INDICATED, 3 POLE UNLESS INDICATED OTHERWISE.

TRANSFORMER, SECONDARY VOLTAGES, PHASE AND

PUSH-BUTTON SWITCH, MOMENTARY CONTACT,

PUSH-BUTTON SWITCH, MOMENTARY CONTACT,

SELECTOR SWITCH - MAINTAINED CONTACT - CHART

POSITION CKT. HAND OFF AUTO

SWITCH - CURRENT RATING INDICATED, 3 POLE

UNLESS INDICATED OTHERWISE.

LIGHTNING ARRESTER

or RATING INDICATED AS APPLICABLE

NORMALLY OPEN

**IDENTIFIES OPERATION:** 

CURRENT TRANSFORMER

A - AMBER

C - CLEAR

B - BLUE

GROUND

225

120/240V

15 KVA

1 PH

100

 $\overline{\overline{m}}$ 

120V

O X - CLOSED CONTACT X O - OPEN CONTACT

> Dewberry Dewberry & Davis LLC 3106 LORD BALTIMORE DRIVE BALTIMORE, MD 21244-2662



I. HEREBY CERTIFY THAT THESE DOCUMENTS WERE PREPARED OR

ENGINEER UNDER THE LAWS OF THE STATE OF MARYLAND,

LICENSE NO. 11529 EXPIRATION DATE: JULY 9, 2011

APPROVED BY ME, AND THAT I AM A DULY LICENSED PROFESSIONAL

PROFESSIONAL CERTIFICATION

SIGNATURE OF ENGINEER

		_	
	uu	111111111	
NI I		MAR	May.
N. S. S.			15
ella,	V	0. <b>629</b>	
	SSIC	H. W. Co.	Mile
-77	199/PM	4ki	ili.

yn.	DES:
	DRN:
	CHK:
Aller.	DATE: (

6/23/10

	<u> </u>	 	 	بيستنتن		
DES:	DWB	·			···	
DRN:						
CHK:	DWB			خ,		

REVISIONS

**ELECTRICAL ABBREVIATIONS, NOTES & SYMBOLS** 


600' SCALE MAP NO. 16


FREDERICK ROAD **PUMPING STATION UPGRADES CAPITAL PROJECT W-8264 CONTRACT 44-4468** 

SHOWN SHEET

**HOWARD COUNTY, MARYLAND** 

6 OF 10

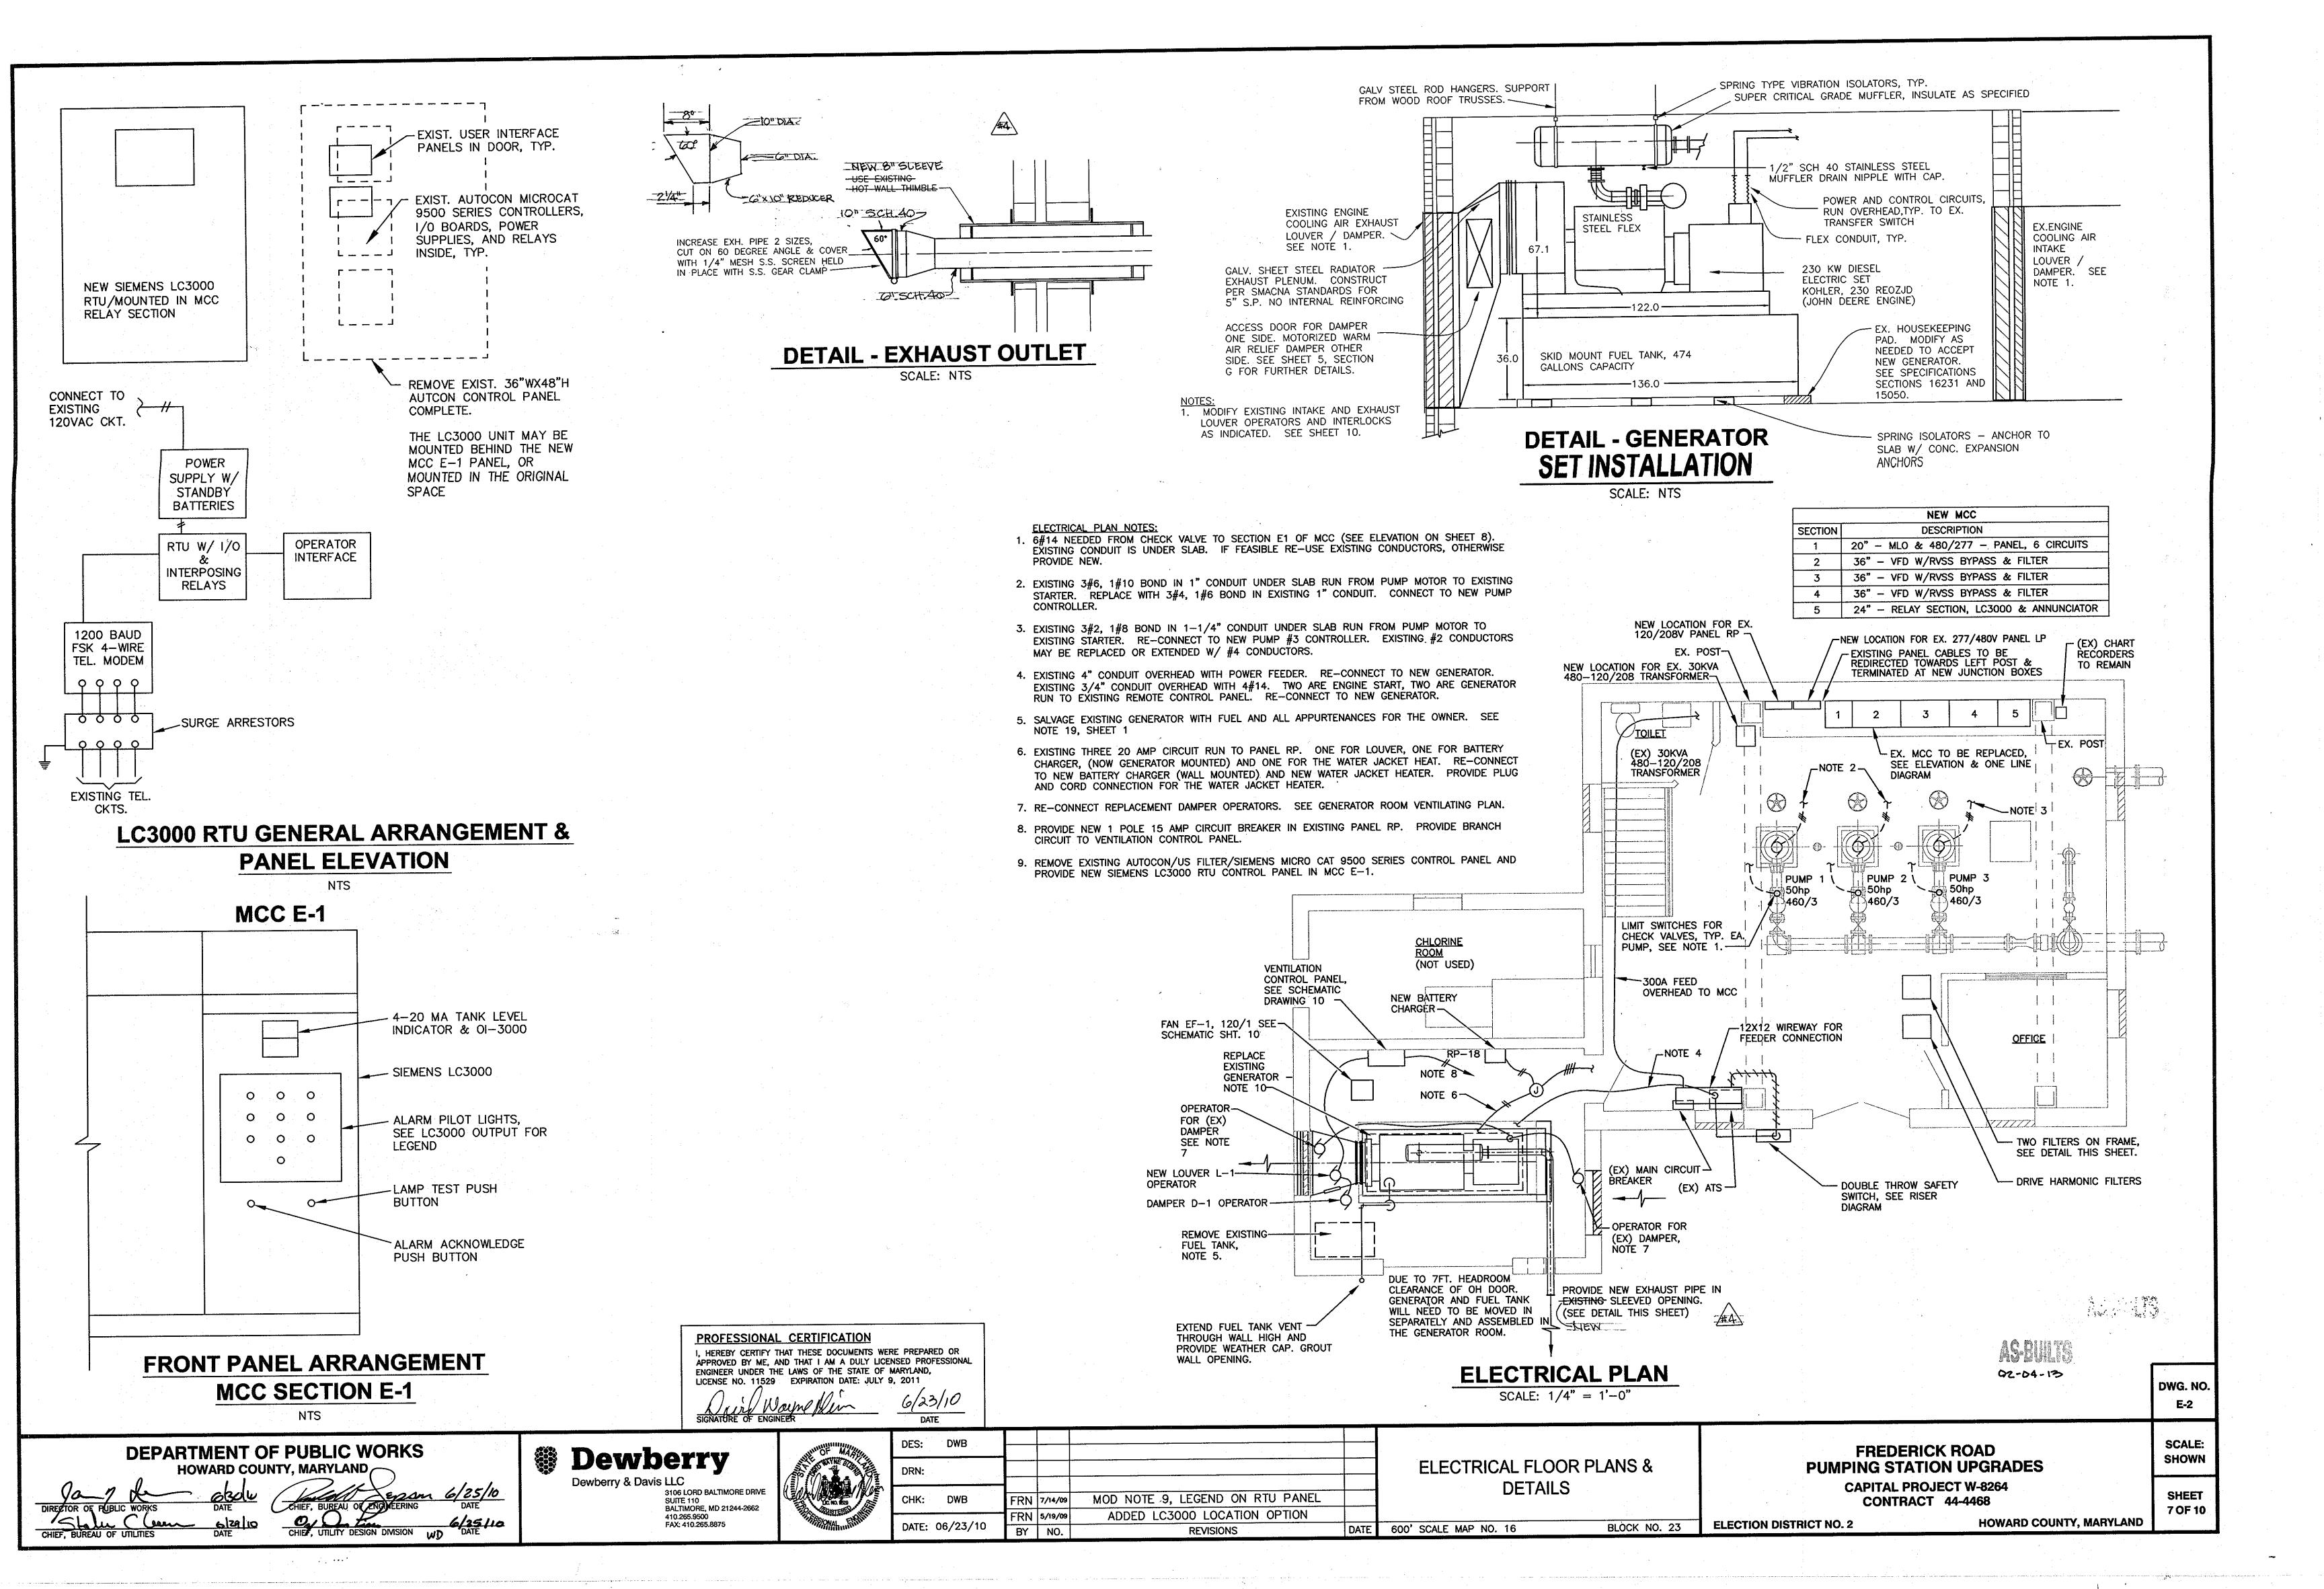


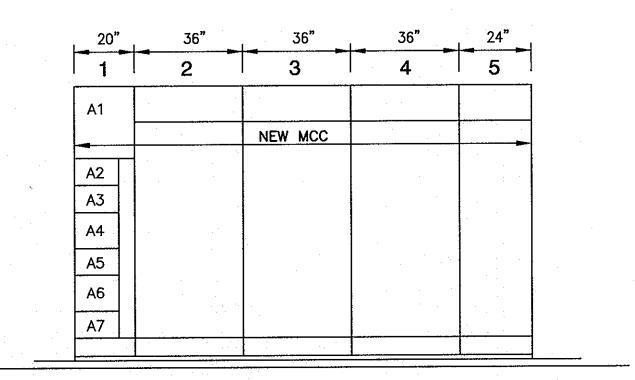

## **ELEVATION:**

**NEW MCC** 

SEE SCHEDULE AND ONE LINE DIAGRAM FOR DEVICES.

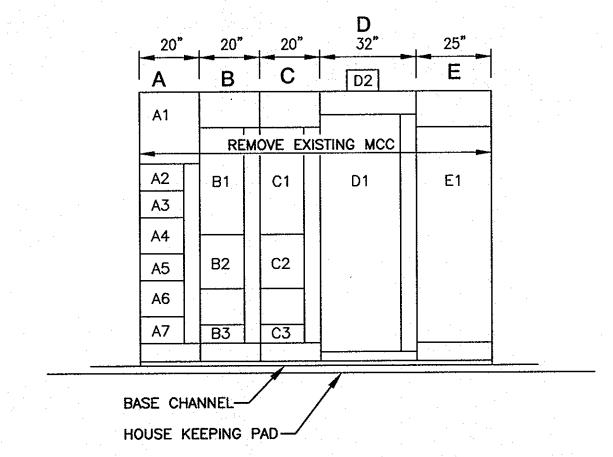



#### **ELEVATION:**



**EXISTING MCC** 

SEE ONE LINE DIAGRAM FOR DEVICES

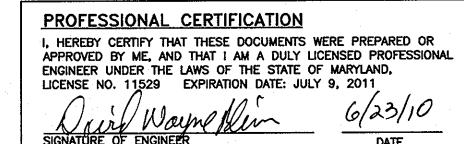

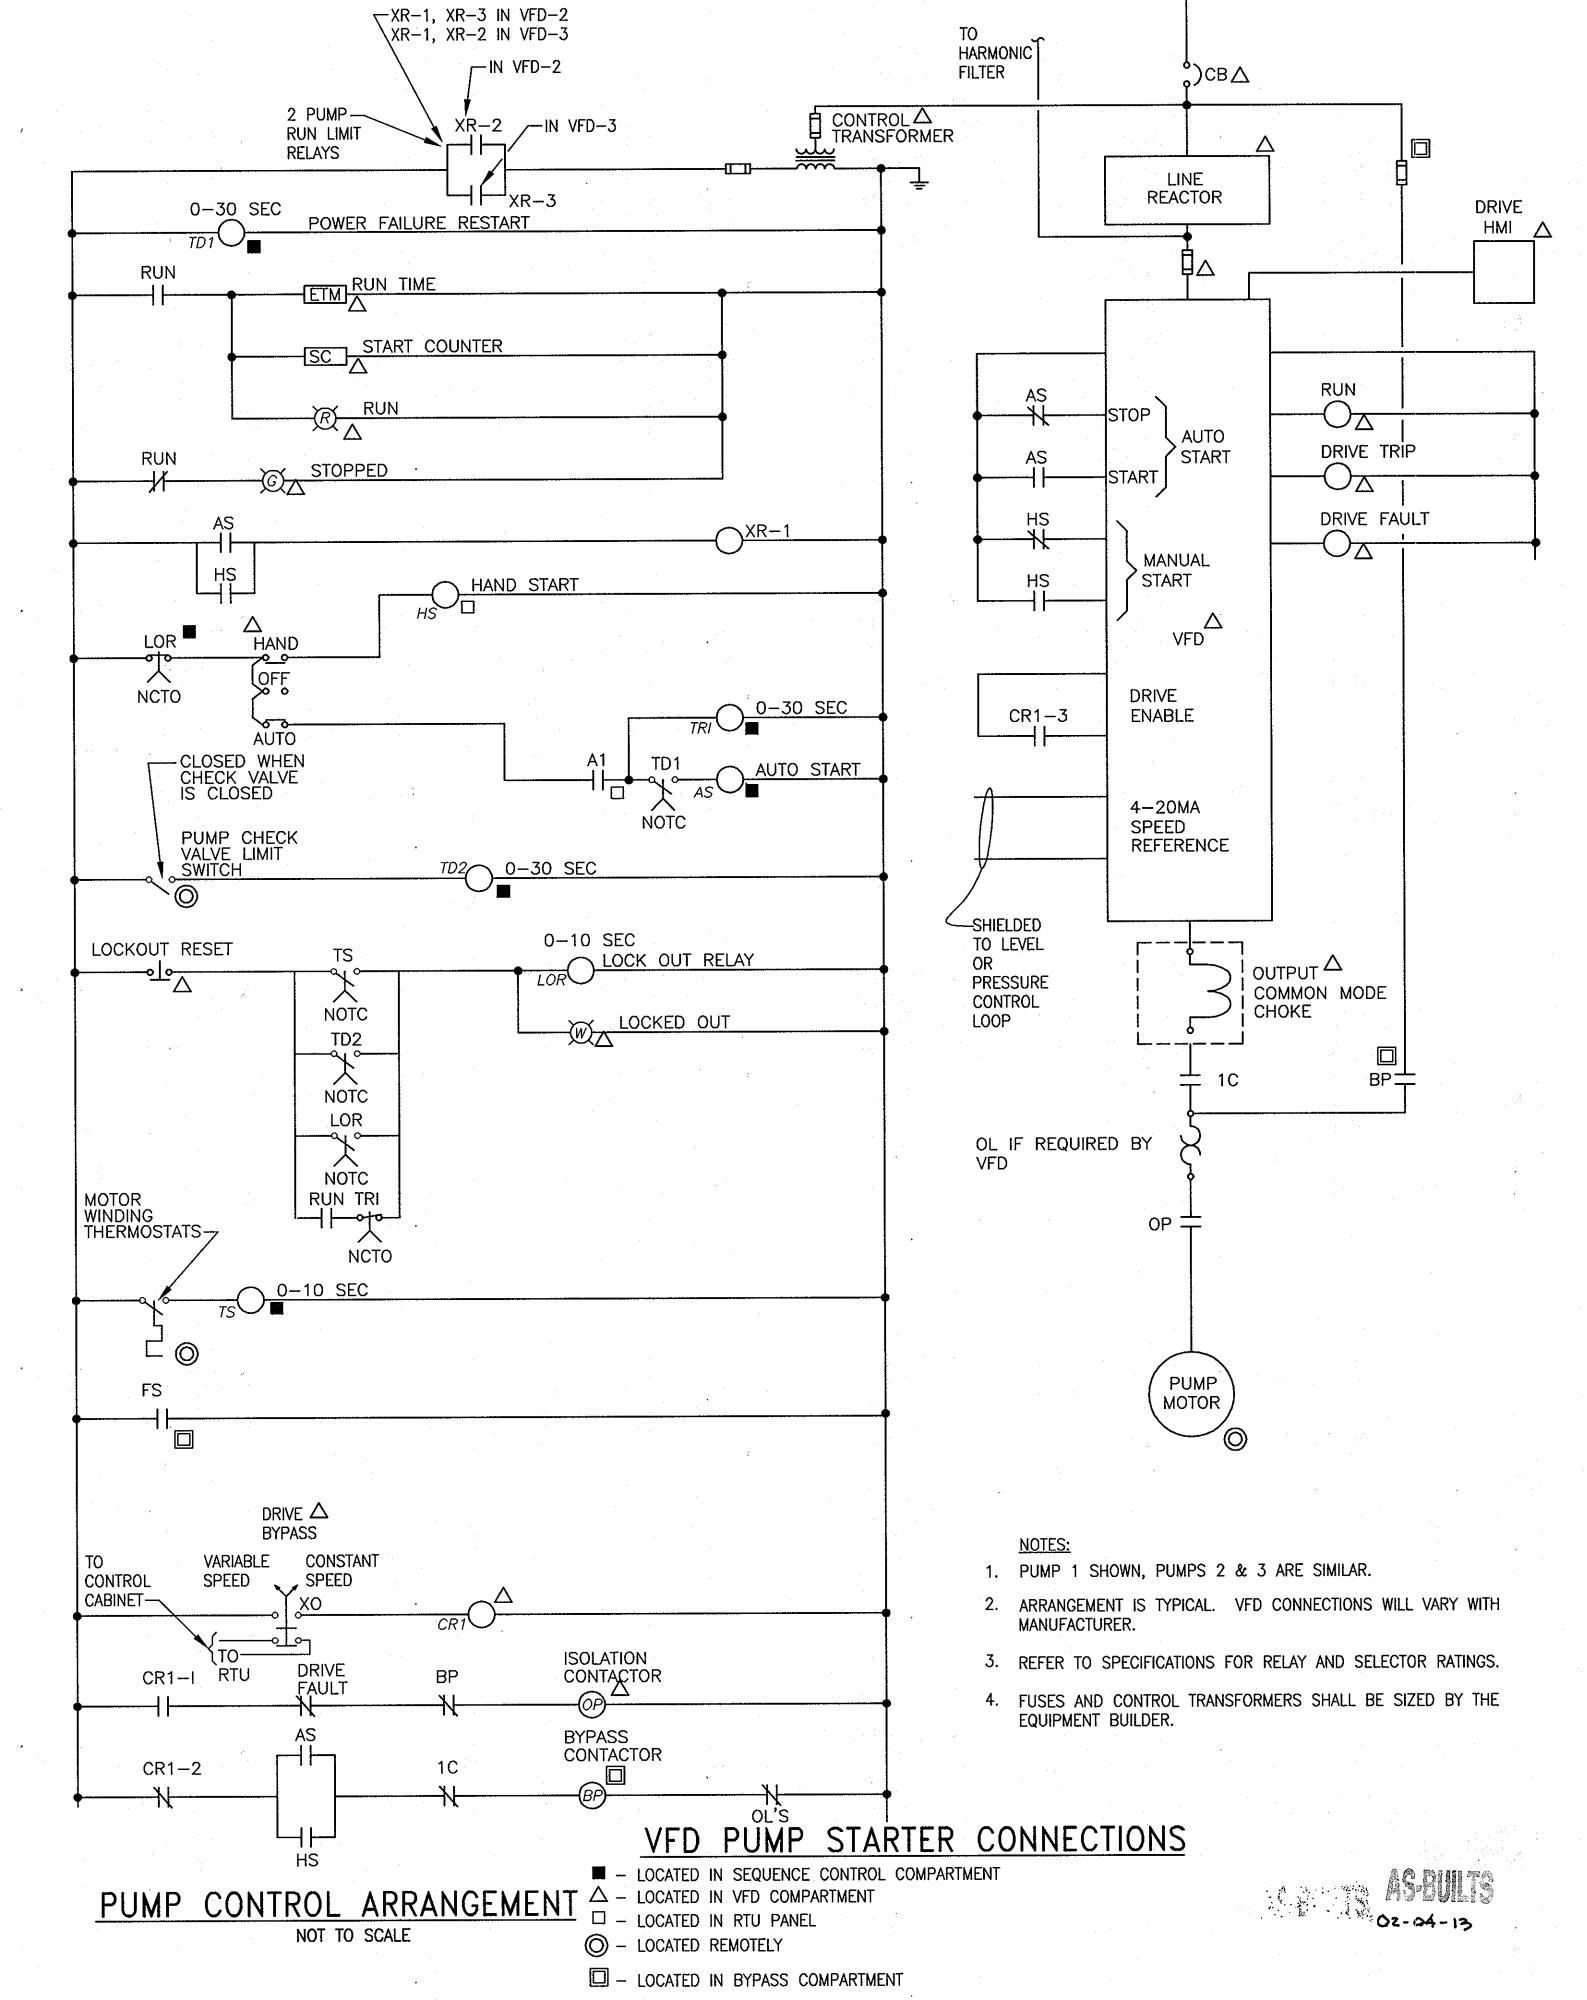

**DEPARTMENT OF PUBLIC WORKS** 

HOWARD COUNTY, MARYLAND

Dewberry & Davis LLC

3106 LORD BALTIMORE DRIVE SUITE 110 BALTIMORE, MD 21244-2662

UAIE						 
DEC. DWP						
DES: DWB						
DRN:						
	-					1
CHK: DWB			٠			
	-					
DATE: 06/23/10	RY	NO		REVISION	S	DATE

**ELECTRICAL SCHEMATICS & DETAILS** 

600' SCALE MAP NO. 16

BLOCK NO. 23

FREDERICK ROAD **PUMPING STATION UPGRADES CAPITAL PROJECT W-8264 CONTRACT 44-4468** 

SHEET 8 OF 10 **ELECTION DISTRICT NO. 2** HOWARD COUNTY, MARYLAND

DWG. NO.

E-3

SCALE:

SHOWN

Dewberry

410.265.9500 FAX: 410.265.8875

