

20170815 10:17A 0:\32322-000-BAL\Drawings\CAD Backup\MJBCAD\SC\HSC-2.dwg LastSaveBy:MBLICKENSTAFF

DEPARTMENT OF PUBLIC WORKS

HOWARD COUNTY, MARYLAND

CHIEF UTILITY DESIGN DIVISON

EXPIRATION DATE 01/06/2018
SIGNED:

HAZEN AND SAWYER 1 SOUTH STREET, SUITE 1150; BALTIMORE, MD 21202

ह्यागित

DATE

PROFESSIONAL CERTIFICATION

I HEREBY CERTIFY THAT THESE DOCUMENTS WERE PREPARED OR APPROVED BY ME, AND THAT I

PROFESSIONAL ENGINEER UNDER THE LAWS OF THE STATE OF MARYLAND, LICENSE NO. 35295.

AM A DULY LICENSED

DESIGNED NH/MJB CHECKED\_\_\_ PROJ. ENGR. JTH **REVISION PER HOWARD COUNTY** 8/2017 JTH 5/2016 JTH CHANGE ORDER NO. 1

NO CHANGES IN REVISIONS 1, 3, 4

**BONNIE BRANCH BYPASS PLAN** 

CIVIL

PATAPSCO INTERCEPTOR RELOCATION AND BLOEDE DAM REMOVAL CAPITAL PROJECT NUMBER S-6282 CONTRACT NUMBER 10-4948

1"=40'-0"

NOTES:

1. THE BYPASS PUMP PLAN SHOWN HEREON IS GENERAL AND SHALL BE USED FOR INFORMATIONAL PURPOSES ONLY. CONTRACTOR SHALL SUBMIT, FOR

PROFESSIONAL ENGINEER REGISTERED IN THE STATE OF MARYLAND.

2. WHERE THE BYPASS ALIGNMENT IS RUNNING ALONG STEEP SLOPES OR


APPROVAL, A DETAILED BYPASS PLAN SIGNED AND SEAL BY A

DRAWING NUMBER HSC-2

SCALE **1"=40**"

AS-BUILT DATE 12/51/2019


2ND ELECTION DISTRICT HOWARD COUNTY, MARYLAND SHEET 74 OF 106

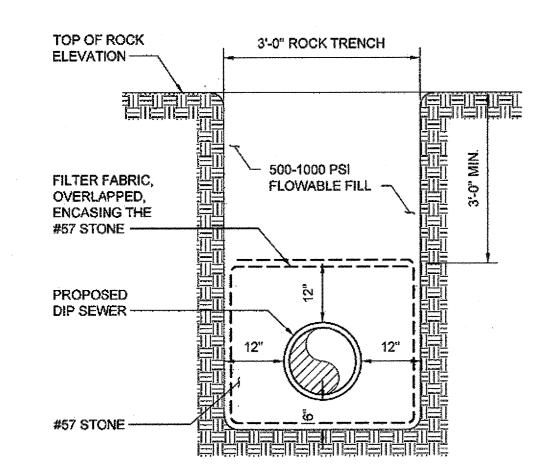


#### NOTES FOR "TYPE A FLOWABLE FILL PROTECTION"

- IT IS ANTICIPATED THAT THE PROPOSED 12" SIPHON WILL BE TRENCHED INTO BEDROCK WHERE "TYPE A FLOWABLE FILL PROTECTION" IS CALLED FOR. CONTRACTOR SHALL PERFORM THREE TEST PITS ALONG THE SIPHON ALIGNMENT AS STATED ON DRAWING HSC-1: ONE AT STATION 0+29, ONE AT STATION 1+03, AND ONE AT THE MIDPOINT STATION 0+66. CONTRACTOR SHALL PROVIDE THE TEST PIT DATA FOR REVIEW PRIOR TO COMMENCING WORK.
- 2. IF THE TEST PIT DATA SHOWS THAT THE BEDROCK ELEVATION IS LOWER THAN APPROXIMATE ELEVATION 65.0, THE CONTRACTOR SHALL LOWER THE PIPE ELEVATION SUCH THAT THE CROWN OF THE PIPE WILL BE A MINIMUM OF 4 FEET INTO BEDROCK. THE VERTICAL ALIGNMENT WILL ADJUST FOR ANY CHANGES IN THE ELEVATION OF THE PIPE INVERTS AT THE LOWEST POINT.
- THE DUCTILE IRON SIPHON SHALL BE BURIED WITH DIMENSIONS AS SHOWN ABOVE. BACKFILL SHALL CONSIST OF #57 STONE, WRAPPED IN GEOTEXTILE, FROM 6" BELOW THE PIPE TO 12" ABOVE THE PIPE. #57 STONE SHALL BE THE FULL WIDTH OF THE TRENCH.
- ABOVE THE #57 STONE, FLOWABLE FILL SHALL BE PROVIDED. SEE THE HOWARD COUNTY SPECIAL PROVISIONS, PARAGRAPH 11 FOR REQUIREMENTS. THE TOP OF THE FLOWABLE FILL SHALL BE SET AT THE SAME ELEVATION AS THE TOP OF ROCK.


#### "TYPE A FLOWABLE FILL PROTECTION" DETAIL FOR BONNIE BRANCH SEWER CONNECTION NOT TO SCALE

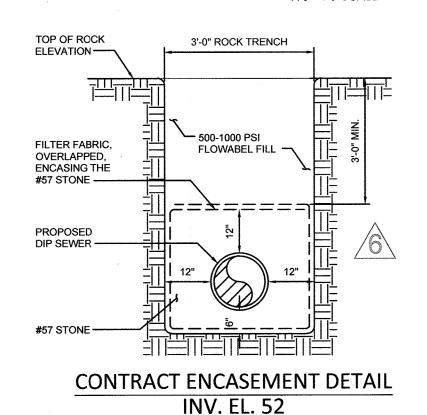

NOT TO SCALE

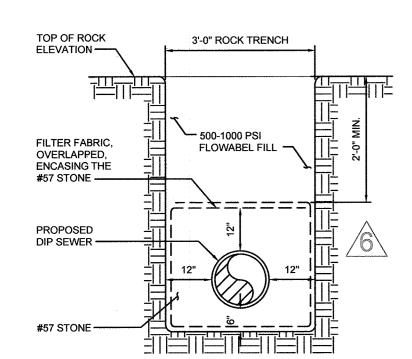

**HOWARD COUNTY PROPOSAL OF** 2' MIN. ENCASEMENT IN ROCK WITH CONCRETE FILL **REVISED INV. EL. 53** NOT TO SCALE

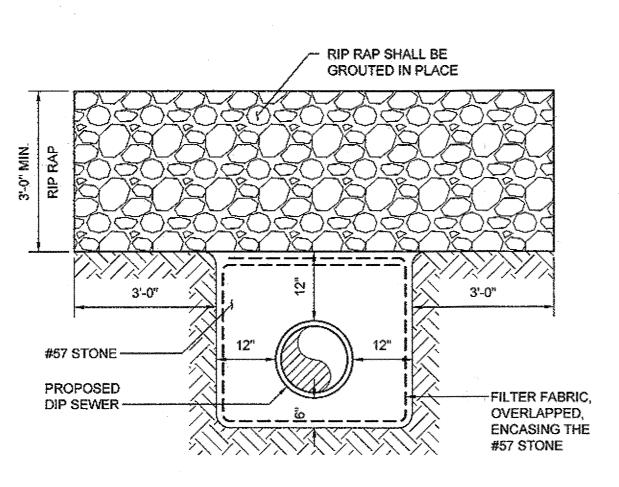


#### NOTES FOR "TYPE B RIP RAP PROTECTION":

- 1. THIS TYPE OF RIP RAP PROTECTION SHALL BE UTILIZED TO PROTECT THE PIPE IN THE STEEP PORTIONS OF THE TRENCH WITHIN THE BANKS OF THE RIVER AT NORMAL FLOW.
- THE DUCTILE IRON SIPHON SHALL BE BURIED IN THE WITH DIMENSIONS SHOWN ABOVE BACKFILL SHALL CONSIST OF #57 STONE, WRAPPED IN GEOTEXTILE, FROM 6" BELOW THE PIPE TO 12" ABOVE THE PIPE. #57 STONE SHALL BE THE FULL WIDTH OF THE TRENCH.
- ABOVE THE #57 STONE, CLASS III RIP RAP GROUTED IN PLACE SHALL BE PROVIDED AT A MINIMUM DEPTH OF 3 FEET AND EXTENDING HORIZONTALLY 3 FEET BEYOND THE LIMITS OF THE #57 STONE, FOR A TOTAL WIDTH OF APPROXIMATELY 9 FEET.
- 4. THE TOP OF THE RIP RAP ELEVATION SHALL BE SET AT THE GRADE ELEVATION POST DAM REMOVAL. ONCE THE GROUTED RIP RAP IS INSTALLED, CONTRACTOR SHALL INSTALL RIVER BANK PROTECTION IN ACCORDANCE WITH THE RIVER BANK PROTECTION DETAIL ON THIS

#### NOTES FOR "TYPE C RIP RAP PROTECTION"


- 1. THIS TYPE OF RIP RAP PROTECTION SHALL BE UTILIZED TO PROTECT THE PIPE WHERE IT ENTERS THE ACCESS VAULT AS WELL AS PROTECTING THE ACCESS VAULT FROM THE FORCES OF THE
- 2. A SMALL PORTION OF THE SIPHON NEAR THE VAULT WILL BE ABOVE EXISTING GRADE. IN THIS LOCATION, CONTRACTOR SHALL CONCRETE ENCASE THE PIPE A MINIMUM OF 12 INCHES ALL AROUND AND PROVIDE GROUTED RIP RAP ABOVE AND ON ALL EXPOSED SIDES OF THE CONCRETE, AS WELL AS SURROUNDING THE PROPOSED ACCESS VAULT FOR A DISTANCE OF APPROXIMATELY 10 FEET. AROUND THE ACCESS VAULT, THE RIP RAP SHALL BE TAPERED FROM THE TOP OF THE VAULT TO EXISTING GRADE AS APPROPRIATE. RIP RAP SIZE SHALL BE A MIXTURE OF CLASS II AND CLASS III RIP RAP ARRANGED IN A PATTERN TO BEST PROTECT THE EXPOSED SIPHON AND ACCESS VAULT.

**NOT TO SCALE** 

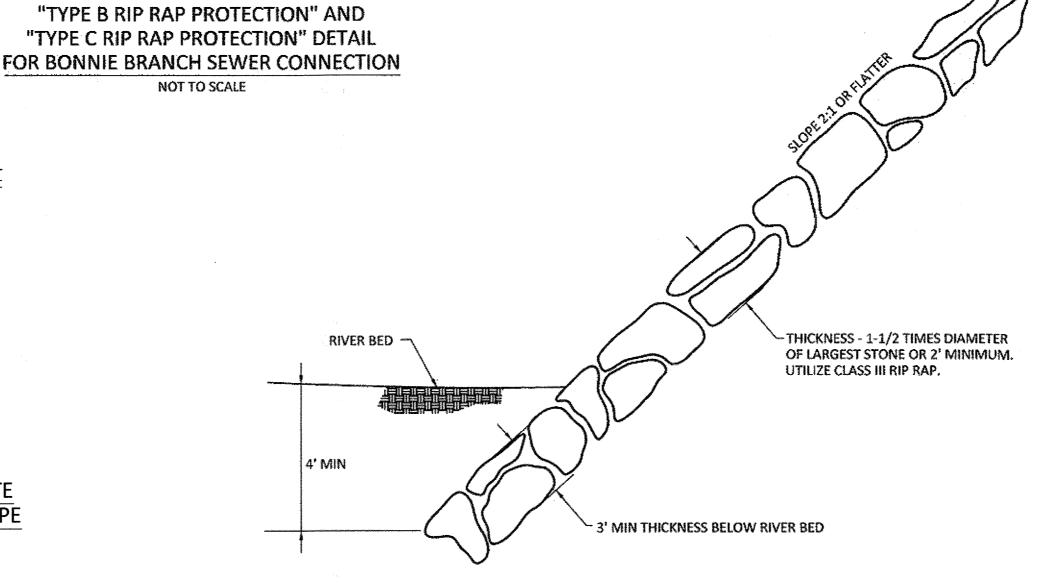


NOTE: RIVER BANK PROTECTION SHALL EXTEND A MINIMUM OF 6 FEET BOTH UPSTREAM AND DOWNSTREAM OF THE PROPOSED SIPHON ALIGNMENT, FOR A TOTAL LENGTH OF 12 FEET MEASURED ALONG THE DIRECTION OF RIVER FLOW.

> RIVER BANK PROTECTION DETAIL **NOT TO SCALE**

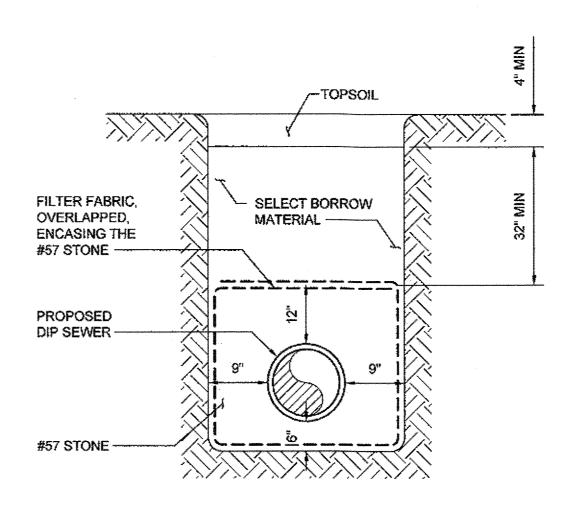


"TYPE D TRENCH" DETAIL FOR BONNIE BRANCH SEWER CONNECTION NOT TO SCALE

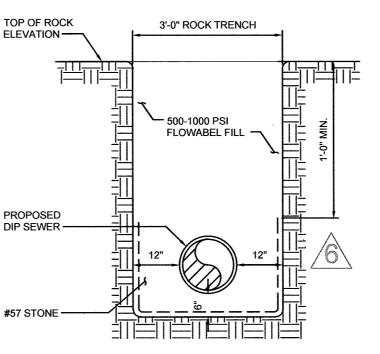

# 1' MIN. ENCASEMENT IN CONCRETE **WITHOUT #57 STONE**

**REVISED INV. EL. 55** NOT TO SCALE

RIVER BANK-

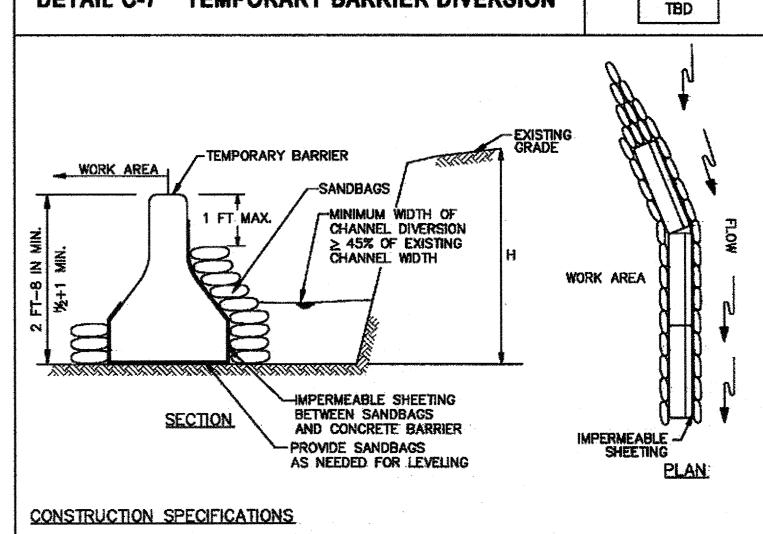

STANDARD SYMBOL

- FOR SANDBAGS USE MATERIALS THAT ARE RESISTANT TO ULTRA-VIOLET RADIATION, TEARING, AND PUNCTURE AND WOVEN TIGHTLY ENOUGH TO PREVENT LEAKAGE OF FILL MATERIAL.
- 2. USE BARRIER MADE OF CONCRETE OR OTHER APPROVED MATERIAL

**DETAIL C-7 TEMPORARY BARRIER DIVERSION** 

- 3. USE 10 MIL OR THICKER, UV RESISTANT, IMPERMEABLE SHEETING OR OTHER APPROVED MATERIAL THAT IS IMPERMEABLE AND RESISTANT TO PUNCTURING AND TEARING.
- . ESTABLISH TOP ELEVATION AT H/2 + 1 FOOT FOR PROJECTS OF DURATION LESS THAN 2 WEEKS OR AS SPECIFIED ON APPROVED PLAN.
- 5. INSTALL DIVERSION STRUCTURE FROM UPGRADE TO DOWNGRADE.
- 6. PLACE IMPERMEABLE SHEETING SUCH THAT UPGRADE PORTION OVERLAPS DOWNGRADE PORTION BY A MINIMUM OF 18 INCHES.
- 7. USE SANDBAG BASE FOR LEVELING AND TO ESTABLISH MINIMUM TOP ELEVATION OF THE BARRIER AS
- 8. DISPOSE OF ALL EXCAVATED MATERIALS IN AN APPROVED DISPOSAL AREA OUTSIDE OF THE 100-YEAR FLCODPLAIN.
- 9. DEWATER WORK AREA USING AN APPROVED EROSION AND SEDIMENT CONTROL PRACTICE AS SPECIFIED ON APPROVED PLAN.
- 10. KEEP ABUTMENTS BETWEEN CONCRETE BARRIERS WATER TIGHT. REPLACE SANDBAGS AND IMPERMEABLE SHEETING IF TORN.

MARYLAND STANDARDS AND SPECIFICATIONS FOR SOIL EROSION AND SEDIMENT CONTROL U.S. DEPARTMENT OF AGRICULTURE NATURAL RESOURCES CONSERVATION SERVICE

MARYLAND DEPARTMENT OF ENVIRONMENT WATER MANAGEMENT ADMINISTRATION C.22

TEMPORARY RIVER CONSTRUCTION DETAIL FOR BONNIE BRANCH SEWER CONNECTION - MDE DETAIL C-7

**DEPARTMENT OF PUBLIC WORKS** HOWARD COUNTY, MARYLAND

CHIEF UTILITY DESIGN DIVISON

PROFESSIONAL CERTIFICATION I HEREBY CERTIFY THAT THESE DOCUMENTS WERE PREPARED OR APPROVED BY ME, AND THAT I AM A DULY LICENSED

NH/MJB DESIGNED\_ CHECKED\_\_ REVISION PER HOWARD COUNTY 8/2017 ISSUED FOR DATE

NO CHANGES IN REVISIONS 1, 2, 3, 4

AS-BUILT REPLACEMENT SHEET A

PATAPSCO INTERCEPTOR RELOCATION AND BLOEDE DAM REMOVAL CAPITAL PROJECT NUMBER S-6282 **CONTRACT NUMBER 10-4948** 

HSC-3

2ND ELECTION DISTRICT. HOWARD COUNTY, MARYLAND SHEET 75 OF 106

20170815 10:17A 0:\32322-000-BAL\Drawings\CAD Backup\MJBCAD\SC\HSC-3.dwg LastSaveBy:MBLICKENSTAFF

HAZEN AND SAWYER
1 SOUTH STREET, SUITE 1150; BALTIMORE, MD 21202
410-539-7681

TOP OF ROCK

PROPOSED

3'-0" ROCK TRENCH

500-1000 PSI FLOWABEL FILL 🥆

2' MIN. ENCASEMENT IN CONCRETE WITHOUT #57 STONE ON TOP OF PIPE

**REVISED INV. EL. 54** 

NOT TO SCALE

PROFESSIONAL ENGINEER UNDER THE LAWS OF THE STATE OF MARYLAND, UCENSE NO. 35295. EXPIRATION DATE 01/06/2018


SIGNED: PUST

PROJ. ENGR. JTH

**DETAILS** 

CIVIL

( AUGUST 201

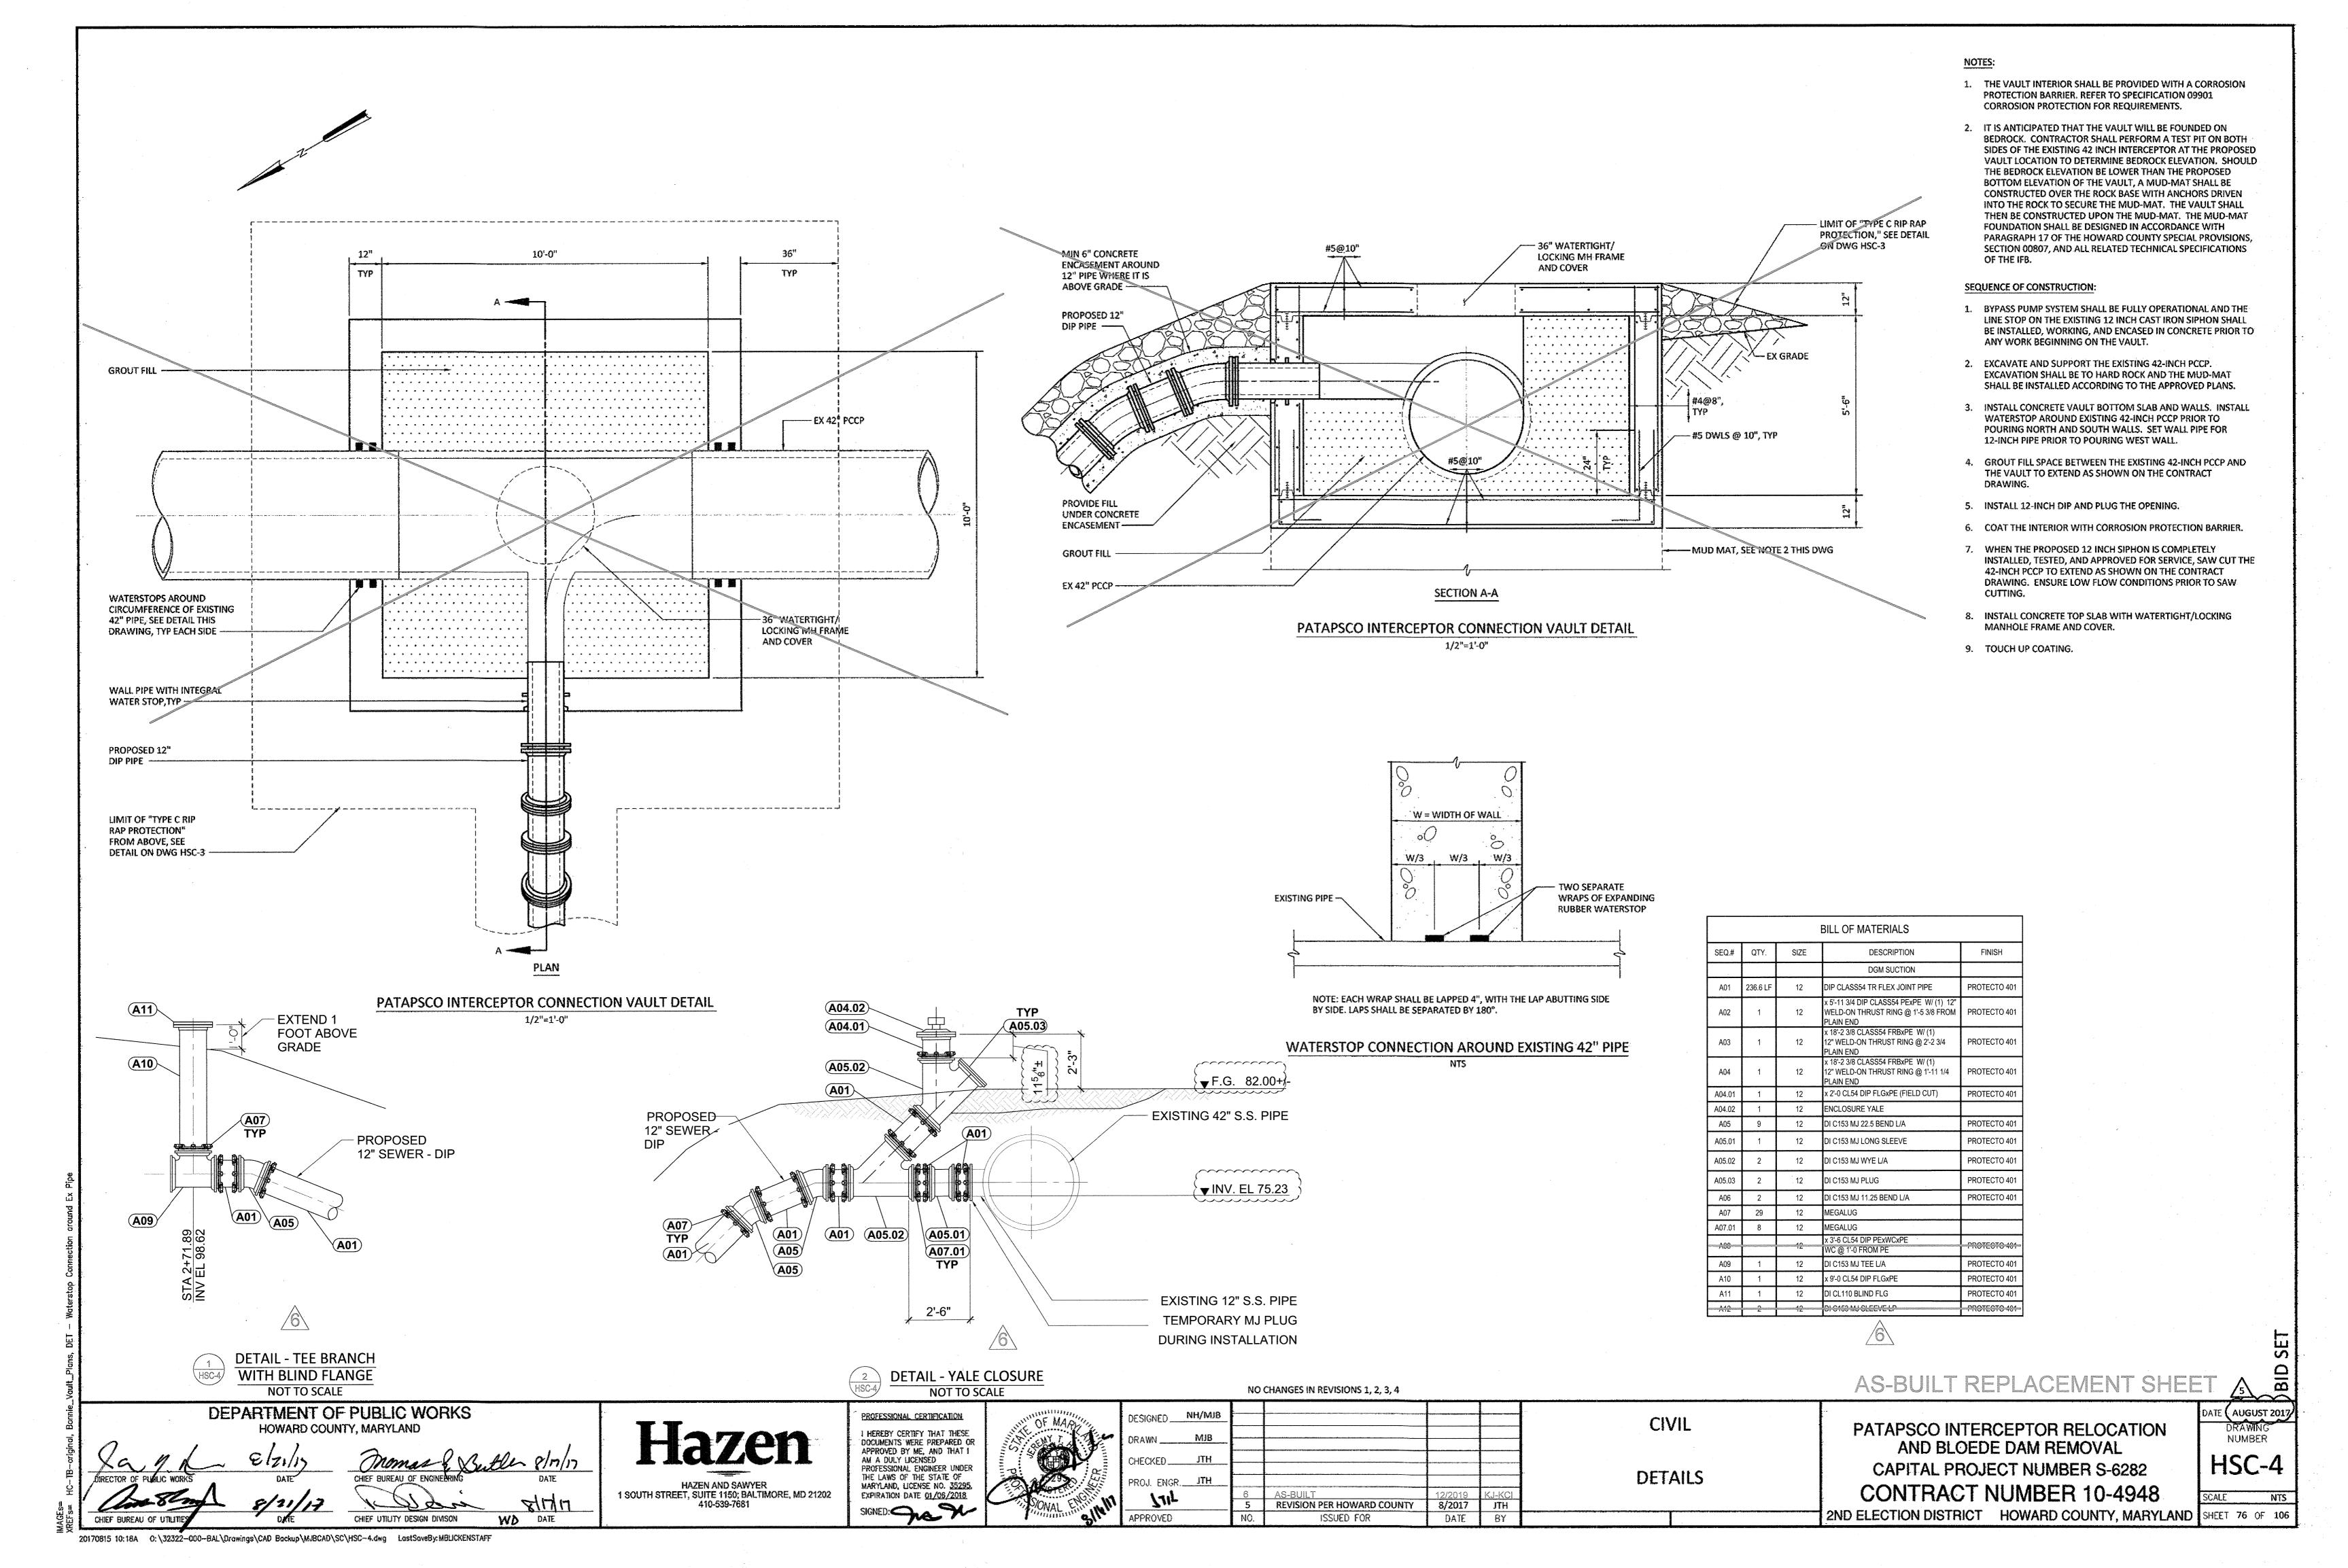



# HOWARD COUNTY, MARYLAND

PATAPSCO INTERCEPTOR RELOCATION AND BLOEDE DAM REMOVAL

# BONNIE BRANCH INTERCEPTOR SIPHON REPLACEMENT

**CAPITAL PROJECT S-6282 CONTRACT NO. 10-4948** 

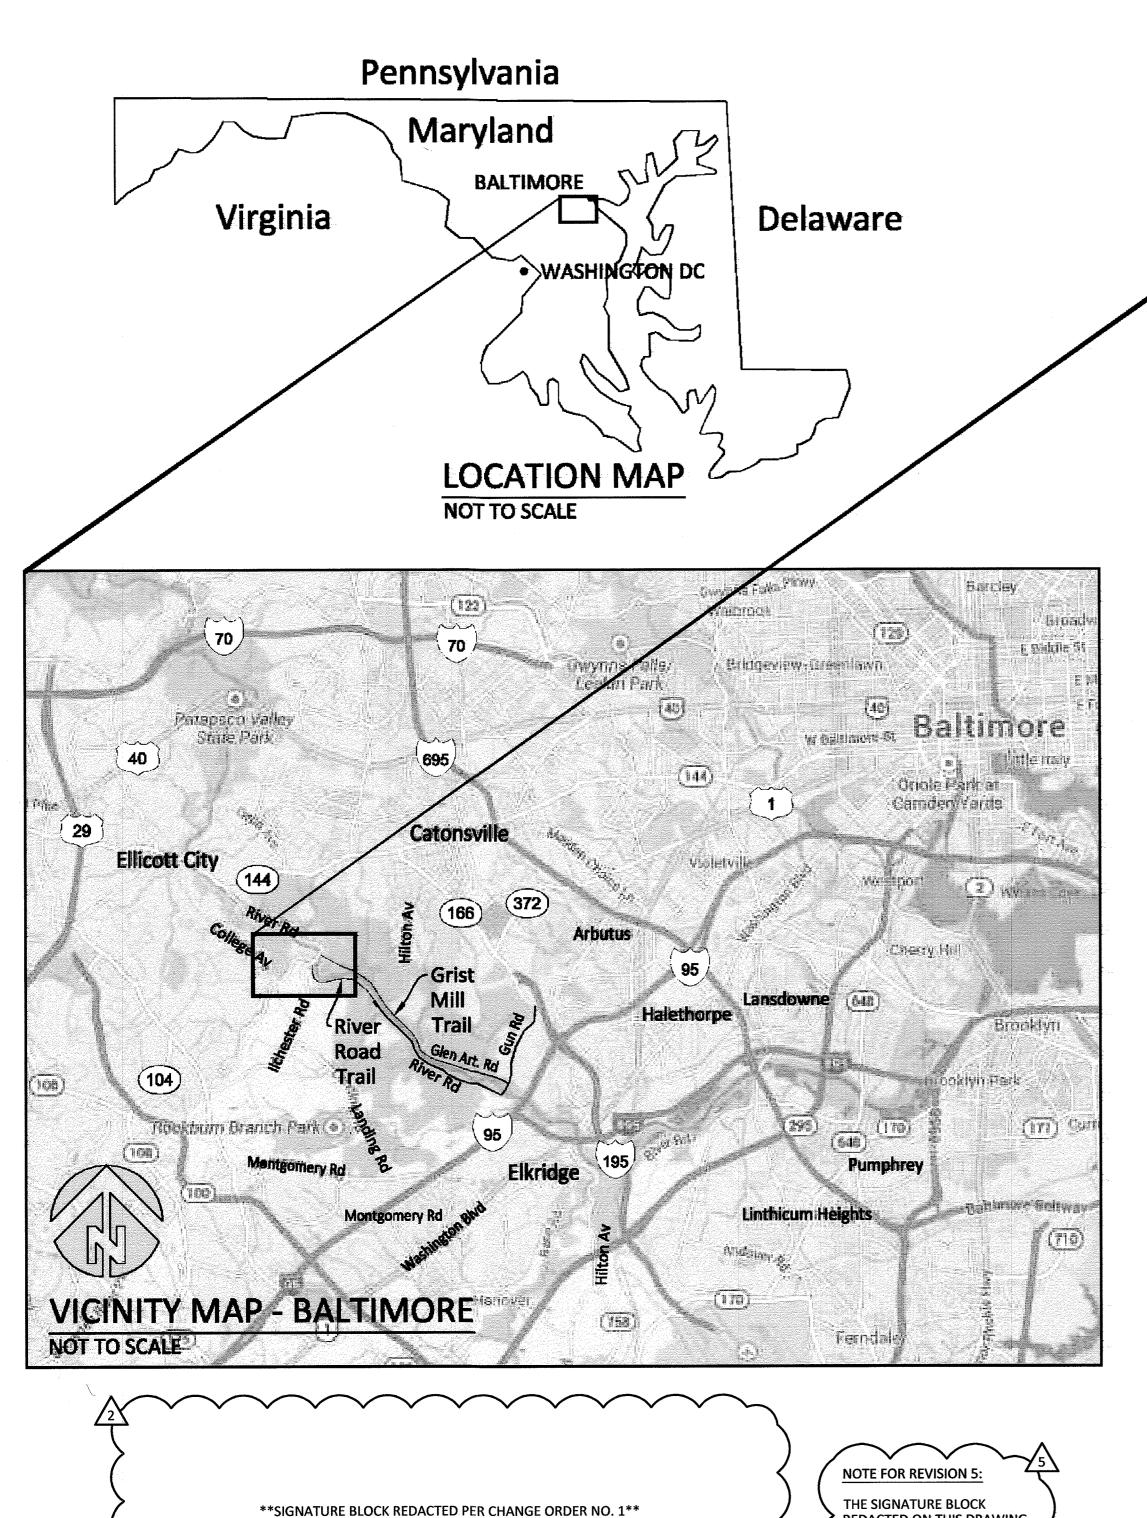

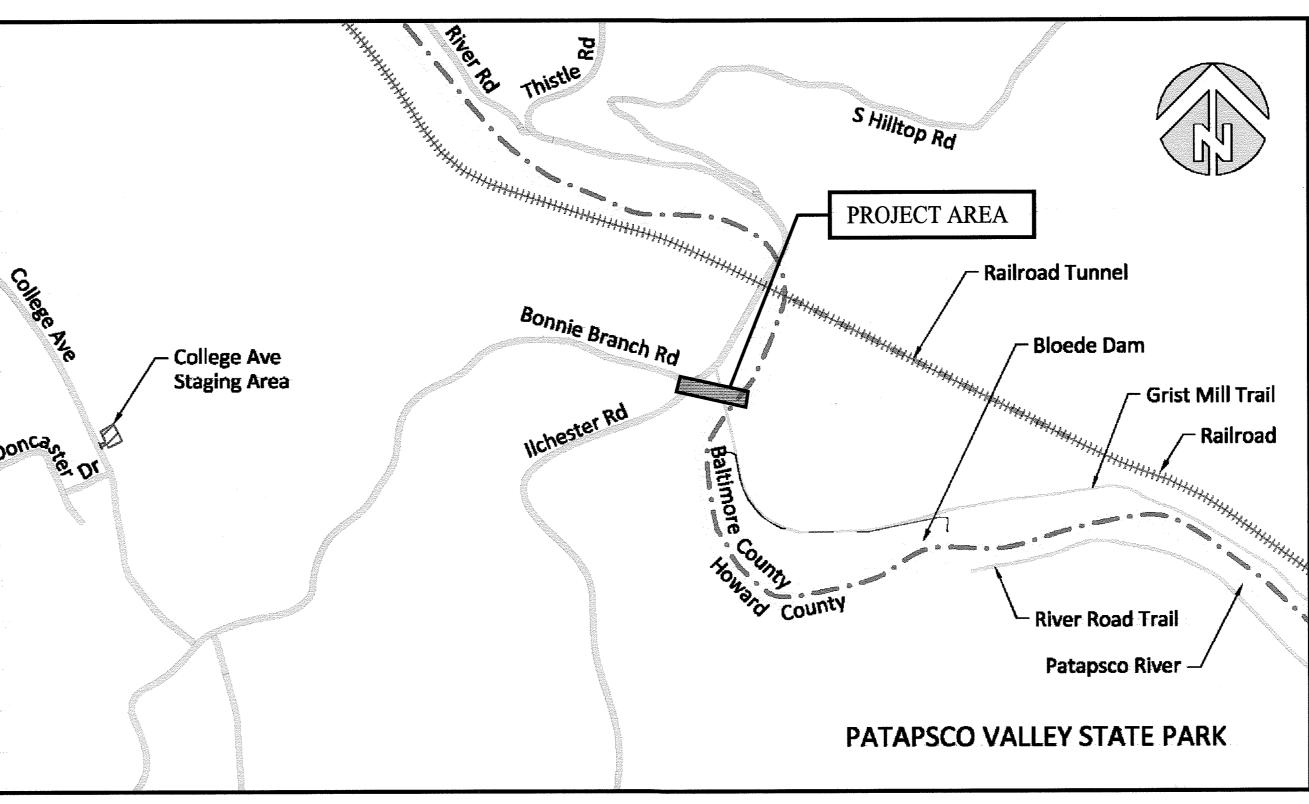

HORIZONTAL DATUM: NAD83 SITE MAP - BONNIE BRANCH INTERCEPTOR **VERTICAL DATUM: NAVD88** 1" = 1000'

## STATEMENT OF PROJECT PURPOSE:

THIS PROJECT IS TO REPLACE THE ENTIRE 12-INCH SEWER INTERCEPTOR SIPHON REASON FOR THE NEW SIPHON REPLACEMENT IS TO LOWER THE SIPHON UNDER THE RIVER TO PERMIT CHANNEL EROSION TO OCCUR WHICH WILL RESULT FROM THE REMOVAL OF BLOEDE DAM.

"SEDIMENT CONTROL MEASURES FOR THIS CONTRACT WILL BE IMPLEMENTED IN ACCORDANCE WITH SECTION 308 OF THE HOWARD COUNTY DESIGN MANUAL **VOLUME IV: STANDARD SPECIFICATIONS AND DETAILS FOR CONSTRUCTION AS SHOWN** ON THESE PLANS AND ON DRAWINGS ESC-1 THROUGH ESC-24 OF THE PATAPSCO INTERCEPTOR RELOCATION AND BLOEDE DAM REMOVAL DRAWINGS.

#### **GENERAL NOTES:**

- COORDINATES SHOWN ON THE DRAWINGS ARE BASED ON MARYLAND STATE REFERENCE SYSTEM NAD '83/'91.

- ..410-685-0123 BUREAU OF .410-313-4900 COLONIAL PIPELINE

- LINE OF EXCAVATION. PAYMENT FOR SUCH REMOVAL SHALL BE INCLUDED IN

# SEWER NOTES:

- 1. ALL SEWER MAINS SHALL BE D.I.P. OR P.V.C. UNLESS OTHERWISE NOTED.
- 2. ALL MANHOLES SHALL BE 4'-0" INSIDE DIAMETER UNLESS OTHERWISE
- 3. FORCE MAINS SHALL BE D.I.P. ONLY.
- 4. MANHOLES SHOWN WITH 12" AND 16" WALLS ARE FOR BRICK MANHOLES
- 5. MANHOLES DESIGNATED W.T. IN PLAN AND PROFILE SHALL HAVE WATERTIGHT FRAME AND COVER, STANDARD DETAIL G5.52. WHERE WATERTIGHT MANHOLE FRAMES AND COVERS ARE USED, SET TOP OF FRAME 1'-6" ABOVE FINISHED GRADE UNLESS OTHERWISE NOTED ON THE
- 6. HOUSE(S) WITH THE SYMBOL "C.N.S." INDICATES THAT THE CELLAR

# **BILL OF MATERIALS**

ITEM	UNIT	ESTIMATE	AS-BUILT	MANUFACTURE
12" DIP, CLASS 54 RJ	LF	278	279	USPIPE
12" RJ DIP 22.5° BEND	EA	9	7	US PIPE
12" RJ DIP 11.25° BEND	EA	2	3	US PIPE
12" RJ DIP TEE	EA	1	ı	US PIPE
VAULT FRAME AND COVER	EA	1		
LINE STOP	EA	1	ı	
YALE CLOSURE	EA		l	
NAME OF UTILITY CONTRACT	TOR: KIEW	w/FERGU	SON W	ATERWORKS
		C	CHECKBOX	
		ΔS-	-BUILT DATE	12/2019

AS-BUILT DATE 12/37/2014


NO CHANGES IN REVISIONS 1, 3

DEPARTMENT OF PUBLIC WORKS HOWARD COUNTY, MARYLAND

1 SOUTH STREET, SUITE 1150; BALTIMORE, MD 21202

**REDACTED ON THIS DRAWING** WAS THE "DEVELOPER'S CERTIFICATION" FOR THE **HOWARD SOIL CONSERVATION** 

DISTRICT THAT WAS REMOVED VIA CHANGE ORDER NO. 1.

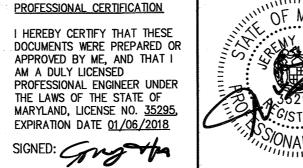



DESIGNED NH/	/MJB				
DRAWN	IJB				
CHECKED	тн				
PROJ. ENGR.	TH 5	REVISION PER HOWARD COUNTY	8/2017	JTH	
1 -1	. 4	REVISION PER MDE COMMENTS	1/2017	JTH	
-M	2	CHANGE ORDER NO. 1	5/2016	JTH	L
APPROVED	NO.	ISSUED FOR	DATE	BY	

**GENERAL COVER SHEET** 

PATAPSCO INTERCEPTOR RELOCATION AND BLOEDE DAM REMOVAL **CAPITAL PROJECT NUMBER S-6282 CONTRACT NUMBER 10-4948** 2ND ELECTION DISTRICT HOWARD COUNTY, MARYLAND SHEET 64 OF 106

DRAWING NUMBER HSG-1 CALE AS SHOWN

20170816 10:00A 0:\32322-000-BAL\Drawings\CAD Backup\MJBCAD\SG\HSG-1.dwg LastSaveBy:MBLICKENSTAFF

#### SITE LEGEND

SURVEY CONTROL DATA

EASTING

1379843.04

1379948.79

1378813.99

1379009.21

1379031.99

1379054.66

1379247.99

1379438.38

1379687.26

1379979.79

1378798.59

1379686.15

1379400.10

1379205.84

NORTHING

575435.07

575472.53

576083.95

576112.95

575939.45

575694.67

575468.30

575481.61

575573.48

575556.07

576084.57

575729.33

575719.56

575766.43

ELEV.

77.90

88.88

75.23

100.94

99.85

79.44

80.16

79.73

80.68

76.55

82.52

98.42

99.78

100.54

DESCRIPTION

ROD/STAKE

TRAVERSE STATION

170

171

421

422

423

424

425

426

427

428

937

42435

42436

42437

**EXISTING** LIMITS OF DISTURBANCE ——LOD—— STABILIZED CONSTRUCTION **ENTRANCE** SOIL BORING LOCATION CONTOUR -- PROPERTY LINE **PAVEMENT** GUARDRAIL **FENCE ROAD SIGN** OVERHEAD ELECTRIC LINE **ELECTRIC POLE** STORM DRAIN PIPING SANITARY SEWER PIPING **SANITARY SEWER MANHOLE** —— 2YR —— 2-YEAR STORM WATER LEVEL -----10YR----- 10-YEAR STORM WATER LEVEL ——100YR—— 100-YEAR STORM WATER LEVEL ∧<sup>42436</sup> **SURVEY TRAVERSE POINT** 

#### GENERAL NOTES FOR THE BONNIE BRANCH SEWER RELOCATION DRAWINGS ONLY (HSG, HSR, HSC, & HST SERIES DRAWINGS):

- 1. ALL CONSTRUCTION SHALL BE IN ACCORDANCE WITH THE LATEST STANDARDS AND SPECIFICATIONS OF HOWARD COUNTY PLUS MSHA STANDARDS AND SPECIFICATIONS IF APPLICABLE.
- 2. THE CONTRACTOR SHALL NOTIFY THE HOWARD COUNTY DEPARTMENT OF PUBLIC WORKS/BUREAU OF ENGINEERING/CONSTRUCTION INSPECTION DIVISION AT (410) 313-1880 AT LEAST FIVE (5) WORKING DAYS PRIOR TO START OF WORK.
- 3. THE CONTRACTOR SHALL NOTIFY "MISS UTILITY" AT 1-800-257-7777 AT LEAST 48 HOURS PRIOR TO ANY EXCAVATION WORKING BEING DONE. IF MISS UTILITY DOES NOT RESPOND, THE CONTRACTOR SHALL BE REQUIRED TO CONTACT AND CONTRACT A PRIVATE UTILITY LOCATOR COMPANY 48 HOURS PRIOR TO BEGINNING GRADING OR DEMOLITION ACTIVITIES.
- 4. THE SURVEY INFORMATION DATED SEPTEMBER 2013 WAS PROVIDED BY INTERFLUVE, INC. THE HORIZONTAL DATUM IS REFERENCED TO MARYLAND STATE PLANE (NAD 83/91) AND THE VERTICAL DATUM IS REFERENCED TO NAVD 88.
- 5. EXISTING UTILITIES SHOWN MUST BE FIELD VERIFIED BY THE CONTRACTOR PRIOR TO START OF ANY DEMOLITION AND CONSTRUCTION.
- 6. THE ENTIRE PROJECT AREA IS LOCATED IN THE 100 YEAR FLOODPLAIN. FLOOD ELEVATIONS HAVE BEEN PROVIDED ON THE SITE PLANS FOR THE VARIOUS LOCATIONS.
- 7. OFF SITE DISPOSAL OF EXCESS MATERIAL SHALL BE TO AN APPROVED AND PROPERLY PERMITTED SITE.
- 8. THE CONTRACTOR SHALL LOCATE AND PROTECT ALL EXISTING FACILITIES, STRUCTURES AND UTILITIES FROM DAMAGE UNLESS OTHERWISE NOTED TO BE REMOVED/DEMOLISHED.
- 9. IT SHALL BE THE RESPONSIBILITY OF THE CONTRACTOR TO REMOVE AND LEGALLY DISPOSE OF ANY AND ALL DEMOLISHED/DELETERIOUS MATERIALS AT A PROPERLY PERMITTED DISPOSAL SITE.
- 10. POSITIVE DRAINAGE SHALL BE MAINTAINED AT ALL TIMES. PONDING OF WATER SHALL NOT BE PERMITTED. ALL PONDING WATER SHALL BE FILTERED THROUGH A PORTABLE SEDIMENT TANK PRIOR TO DISCHARGE INTO THE PUBLIC STORM SEWER SYSTEM.
- 11. SURFACED STREET AND PARKING AREAS SHALL BE MAINTAINED IN A CLEAN CONDITION FREE OF MUD AND DUST AT ALL TIMES. ADEQUATE MEANS SHALL BE PROVIDED TO CLEAN TRUCKS AND EQUIPMENT.
- 12. IN-RIVER WORK ASSOCIATED WITH BONNIE BRANCH SEWER CONSTRUCTION SHALL OCCUR DURING PATAPSCO RIVER LOW FLOW PERIODS TO THE MAXIMUM EXTENT FEASIBLE TO MINIMIZE RIVER DIVERSION AND DEWATERING.

# INDEX OF BONNIE BRANCH SEWER RELOCATION DRAWINGS:

SHEET NO.	DWG NO.	DESCRIPTION
HSG SERIES		
64	HSG-1	COVER SHEET
65	HSG-2	SYMBOLS, NOTES, AND ABBREVIATIONS
66	HSG-3	ACCESS PLAN
67	HSG-4	ACCESS ROAD SECTIONS
68	HSG-5	BONNIE BRANCH SEWER RECORD DRAWINGS (FOR INFORMATION ONLY
69	HSG-6	BONNIE BRANCH SEWER RECORD DRAWINGS (FOR INFORMATION ONLY
70	HSG-7	PEDESTRIAN BRIDGE RECORD DRAWINGS (FOR INFORMATION ONLY)
71	HSG-8	PEDESTRIAN BRIDGE RECORD DRAWINGS (FOR INFORMATION ONLY)
HSR SERIES		
72	HSR-1	CLEARING AND GRUBBING PLAN
HSC SERIES		
73	HSC-1	BONNIE BRANCH SIPHON PLAN
74	HSC-2	BONNIE BRANCH BYPASS PLAN
75	HSC-3	DETAILS
76	HSC-4	DETAILS
HST SERIES		

### ACCORDANCE WITH SECTION 308 OF THE HOWARD COUNTY DESIGN MANUAL -**VOLUME IV: STANDARD SPECIFICATIONS AND DETAILS FOR CONSTRUCTION AS SHOWN** ON THESE PLANS AND ON DRAWINGS ESC-1 THROUGH ESC-24 OF THE PATAPSCO INTERCEPTOR RELOCATION AND BLOEDE DAM REMOVAL DRAWINGS."

#### GENERAL SEDIMENT CONTROL NOTES:

THE FOLLOWING NOTES SHALL APPLY TO WORK ON THE BONNIE BRANCH SIPHON. WHERE REQUIREMENTS ARE CONTRADICTORY WITH WHAT IS SHOWN ON DRAWINGS ESC-1 THROUGH ESC-11 OF THE PATAPSCO INTERCEPTOR AND BLOEDE DAM REMOVAL DRAWINGS, THE MORE STRINGENT REQUIREMENT SHALL APPLY. CONTRACT SHALL NOTE THAT THE MARYLAND DEPARTMENT OF THE ENVIRONMENT IS IN CHARGE OF REVIEWING AND APPROVING SEDIMENT CONTROL MEASURES.

- 1. FOR UTILITY INSTALLATIONS, ALL DISTURBED AREAS SHALL BE STABILIZED THE SAME DAY. IF UNFORESEEN CONDITIONS REQUIRE THAT AN EXCAVATION MUST REMAIN OPEN BEYOND THE WORK DAY, THE FOLLOWING PROVISIONS MUST BE FOLLOWED:
- 1.1. TEMPORARY SILT FENCE SHALL BE PLACED IMMEDIATELY DOWNSTREAM OF ANY AREA INTENDED TO REMAIN DISTURBED FOR MORE THAN ONE DAY, AND
- 1.2. ANY PILES OF EXCAVATION SPOILS MATERIALS MUST BE SECURELY COVERED TO ENSURE THAT SEDIMENTS ARE NOT TRANSPORTED FROM THE PILE.
- 2. PAVEMENTS ADJACENT TO THE EXCAVATION MUST REMAIN SEDIMENT FREE. CONTRACTOR SHALL PLACE PLASTIC SHEETING BENEATH THE EXCAVATED MATERIAL PILES, AND SWEEP PAVEMENTS CLEAN OF SEDIMENTS AS REQUIRED.
- 3. A STABILIZED CONSTRUCTION ENTRANCE SHALL BE PROVIDED AT THE DIRECTION OF THE SEDIMENT AND EROSION CONTROL INSPECTOR.
- 4. ALL SPOILS FROM THE EXCAVATION ARE TO BE PLACED ON THE UPHILL SIDE OF THE TRENCH.

#### STANDARD SEDIMENT CONTROL NOTES:

THE FOLLOWING NOTES SHALL APPLY TO WORK ON THE BONNIE BRANCH SIPHON. WHERE REQUIREMENTS ARE CONTRADICTORY WITH WHAT IS SHOWN ON DRAWINGS ESC-1 THROUGH ESC-24 OF THE PATAPSCO INTERCEPTOR AND BLOEDE DAM REMOVAL DRAWINGS, THE MORE STRINGENT REQUIREMENT SHALL APPLY. CONTRACT SHALL NOTE THAT THE MARYLAND DEPARTMENT OF THE ENVIRONMENT IS IN CHARGE OF REVIEWING AND APPROVING SEDIMENT CONTROL MEASURES. 

- 1. A MINIMUM OF 48 HOURS NOTICE MUST BE GIVEN TO THE HOWARD COUNTY DEPARTMENT OF INSPECTIONS, LICENSES, AND PERMITS, SEDIMENT CONTROL DIVISION PRIOR TO THE START OF ANY CONSTRUCTION (410-313-1855).
- 2. ALL VEGETATIVE AND STRUCTURAL PRACTICES ARE TO BE INSTALLED ACCORDING TO THE PROVISION OF THIS PLAN AND ARE TO BE IN CONFORMANCE WITH THE 2011 MARYLAND STANDARDS AND SPECIFICATIONS FOR SOIL EROSION AND SEDIMENT CONTROL AND ALL REVISIONS THERETO.
- 3. FOLLOWING INITIAL SOIL DISTURBANCE OR RE-DISTURBANCE, PERMANENT OR TEMPORARY STABILIZATION SHALL BE COMPLETED WITHIN A) THREE (3) CALENDAR DAYS FOR ALL PERIMETER DIKES, SWALES, DITCHES, PERIMETER SLOPES AND ALL SLOPES GREATER THAN 3 HORIZONTAL TO 1 VERTICAL (3:1); AND B) SEVEN (7) CALENDAR DAYS AS TO ALL OTHER DISTURBED OR GRADED AREAS ON THE PROJECT SITE NOT UNDER ACTIVE GRADING.
- 4. ALL DISTURBED AREAS MUST BE STABILIZED WITHIN THE TIME PERIOD SPECIFIED ABOVE IN ACCORDANCE WITH THE 2011 MARYLAND STANDARDS AND SPECIFICATIONS FOR SOIL EROSION AND SEDIMENT CONTROL FOR PERMANENT SEEDING (SEC. B-4-5), TEMPORARY SEEDING (SEC. B-4-4) AND MULCHING (SEC. B-4-3). TEMPORARY STABILIZATION WITH MULCH ALONE CAN ONLY BE DONE WHEN RECOMMENDED SEEDING DATES DO NOT ALLOW FOR PROPER GERMINATION AND ESTABLISHMENT OF GRASSES.
- 5. ALL SEDIMENT CONTROL STRUCTURES ARE TO REMAIN IN PLACE AND ARE TO BE MAINTAINED IN OPERATIVE CONDITION UNTIL PERMISSION FOR REMOVAL HAS BEEN OBTAINED FROM THE HOWARD COUNTY SEDIMENT CONTROL INSPECTOR.
- 6. ANY SEDIMENT CONTROL PRACTICE THAT IS DISTURBED BY GRADING ACTIVITY FOR PLACEMENT OF UTILITIES MUST BE REPAIRED ON THE SAME DAY OF DISTURBANCE.
- 7. ADDITIONAL SEDIMENT CONTROL MUST BE PROVIDED, IF DEEMED NECESSARY BY THE SEDIMENT AND EROSION CONTROL INSPECTOR.
- 8. ON ALL SITES WITH DISTURBED AREAS IN EXCESS OF 2 ACRES, APPROVAL OF THE INSPECTION AGENCY SHALL BE REQUESTED UPON COMPLETION OF INSTALLATION OF PERIMETER EROSION AND SEDIMENT CONTROLS, BUT BEFORE PROCEEDING WITH ANY OTHER EARTH DISTURBANCE OR GRADING. OTHER BUILDING OR GRADING INSPECTION APPROVALS MAY NOT BE AUTHORIZED UNTIL THIS INITIAL APPROVAL BY THE INSPECTION AGENCY IS MADE.
- TRENCHES FOR THE CONSTRUCTION OF UTILITIES SHALL BE LIMITED TO THREE PIPE LENGTHS OR THAT WHICH SHALL BE BACK-FILLED AND STABILIZED AT THE END OF EACH WORKING DAY. WHICHEVER IS SHORTER.
- 10. ANY CHANGES OR REVISIONS TO THE SEQUENCE OF CONSTRUCTION MUST BE REVIEWED AND APPROVED BY THE PLAN APPROVAL AUTHORITY PRIOR TO PROCEEDING WITH CONSTRUCTION.
- 11. A PROJECT IS TO BE SEQUENCED SO THAT GRADING ACTIVITIES BEGIN ON ONE GRADING UNIT (MAXIMUM ACREAGE OF 20 AC. PER GRADING UNIT) AT A TIME. WORK MAY PROCEED TO A SUBSEQUENT GRADING UNIT WHEN AT LEAST 50 PERCENT OF THE DISTURBED AREA IN THE PRECEDING UNIT HAS BEEN STABILIZED AND APPROVED BY THE ENFORCEMENT AUTHORITY. UNLESS OTHERWISE SPECIFIED AND APPROVED BY THE APPROVAL AUTHORITY, NO MORE THAN 30 ACRES CUMULATIVELY MAY BE DISTURBED AT A GIVEN TIME.

#### **ABBREVIATIONS**

ALT	ALTERNATE	LF	LINEAR FEET
APPROX	APPROXIMATE	LOD	LIMITS OF DISTURBANCE
BLDG	BUILDING	MDE	MARYLAND DEPARTMENT
BLK	BLOCK		OF THE ENVIRONMENT
BM	BENCH MARK	MDOT	MARYLAND DEPARTMENT
		MDOI	
BOC	BACK OF CURB		OF TRANSPORTATION
BOT	BOTTOM	MDSHA	MARYLAND STATE
			HIGHWAY ADMINISTRATION
CF	CUBIC FEET	MFR	MANUFACTURER
CI	CAST IRON	MH	MANHOLE
CIP	CAST IRON PIPE	MIN	MINIMUM
CL	CENTER LINE	MISC	MISCELLANEOUS
CMP	CORRUGATED METAL PIPE		
CO		NITC	NOT TO SCALE
	CLEANOUT	NTS	NOT TO SCALE
CONC	CONCRETE		
CY	CUBIC YARD	OD	OUTSIDE DIAMETER
DET	DETAIL		
	DETAIL	PCCP	PRESTRESSED CONCRETE
DIA	DIAMETER		CYLINDER PIPE
Ø	DIAMETER	PVC	POLYVINYL CHLORIDE
DIM	DIMENSION	PG	PAGE
DIP	DUCTILE IRON PIPE	10	IAGE
	DISCHARGE		
DISCH		QTY	QUANTITY
DWG	DRAWING		
		RCP	REINFORCED CONCRETE PIPE
EA	EACH		
ELEV		REQD	REQUIRED
	ELEVATION	RSF	REINFORCED SILT FENCE
ELEC	ELECTRIC/ELECTRICAL	R/W	RIGHT OF WAY
EOP	EDGE OF PAVEMENT	•	
EQ	EQUAL	CCT	CTARULTER CONCERNICATION
EQPT	EQUIPMENT	SCE	STABILIZED CONSTRUCTION
EX			ENTRANCE
EX	EXISTING	SHC	SEWER HOUSE CONNECTION
		SF	SQUARE FEET
FEMA	FEDERAL EMERGENCY	SPEC	SPECIFICATION
	MANAGEMENT AGENCY		
FH	FIRE HYDRANT	SS	SANITARY SEWER
		SSMH	SANITARY SEWER MANHOLE
FM	FORCE MAIN	STA	STATION
FP	FLOOD PLAIN	STD	STANDARD
FT	FEET	315	317114271112
LIDDE	LUCU DENCITY	TYP	TYPICAL
HDPE	HIGH DENSITY		
	POLYETHYLENE	UG	UNDERGROUND
HOR	HORIZONTAL	00	ONDENOROUND
INI	INCH	VERT	VERTICAL
IN INIV	INCH		
INV	INVERT	W/	WITH
		w/o	WITHOUT
		•	
		WUS	WATERS OF THE US
		YD	YARD

YR YEAR

DETAILED SEQUENCE OF CONSTRUCTION:

REFER TO DRAWING DG-3 FOR DETAILED SEQUENCE OF CONSTRUCTION.

AS-BUILT DATE 12/31/2019


DEPARTMENT OF PUBLIC WORKS **HOWARD COUNTY, MARYLAND** 

CHIEF UTILITY DESIGN DIVISON

HAZEN AND SAWYER

1 SOUTH STREET, SUITE 1150; BALTIMORE, MD 21202

PROFESSIONAL CERTIFICATION I HEREBY CERTIFY THAT THESE DOCUMENTS WERE PREPARED OR APPROVED BY ME, AND THAT I AM A DULY LICENSED PROFESSIONAL ENGINEER UNDER THE LAWS OF THE STATE OF MARYLAND, LICENSE NO. 35295, EXPIRATION DATE 01/06/2018

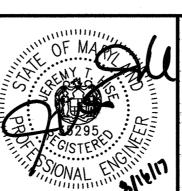

DESIGNED	NH/MJB				
DRAWN	МЈВ		-		
CHECKED	JTH	-			
PROJ. ENGR.	JTH	5	REVISION PER HOWARD COUNTY	8/2017	JTH
•		4	REVISION PER MDE COMMENTS	1/2017	JTH
<u> </u>		2	CHANGE ORDER NO. 1	5/2016	JTH
APPROVED		NO.	ISSUED FOR	DATE	BY
					*

NO CHANGES IN REVISIONS 1, 3

**GENERAL** 


SYMBOLS, NOTES, AND **ABBREVIATIONS** 


PATAPSCO INTERCEPTOR RELOCATION AND BLOEDE DAM REMOVAL CAPITAL PROJECT NUMBER S-6282 **CONTRACT NUMBER 10-4948** 2ND ELECTION DISTRICT HOWARD COUNTY, MARYLAND SHEET 65 OF 106


HSG-2 SCALE NTS


20170815 10:11A 0:\32322-000-BAL\Drawings\CAD Backup\MJBCAD\SG\HSG-2.dwg LastSaveBy:MBLICKENSTAFF


( AUGUST 201

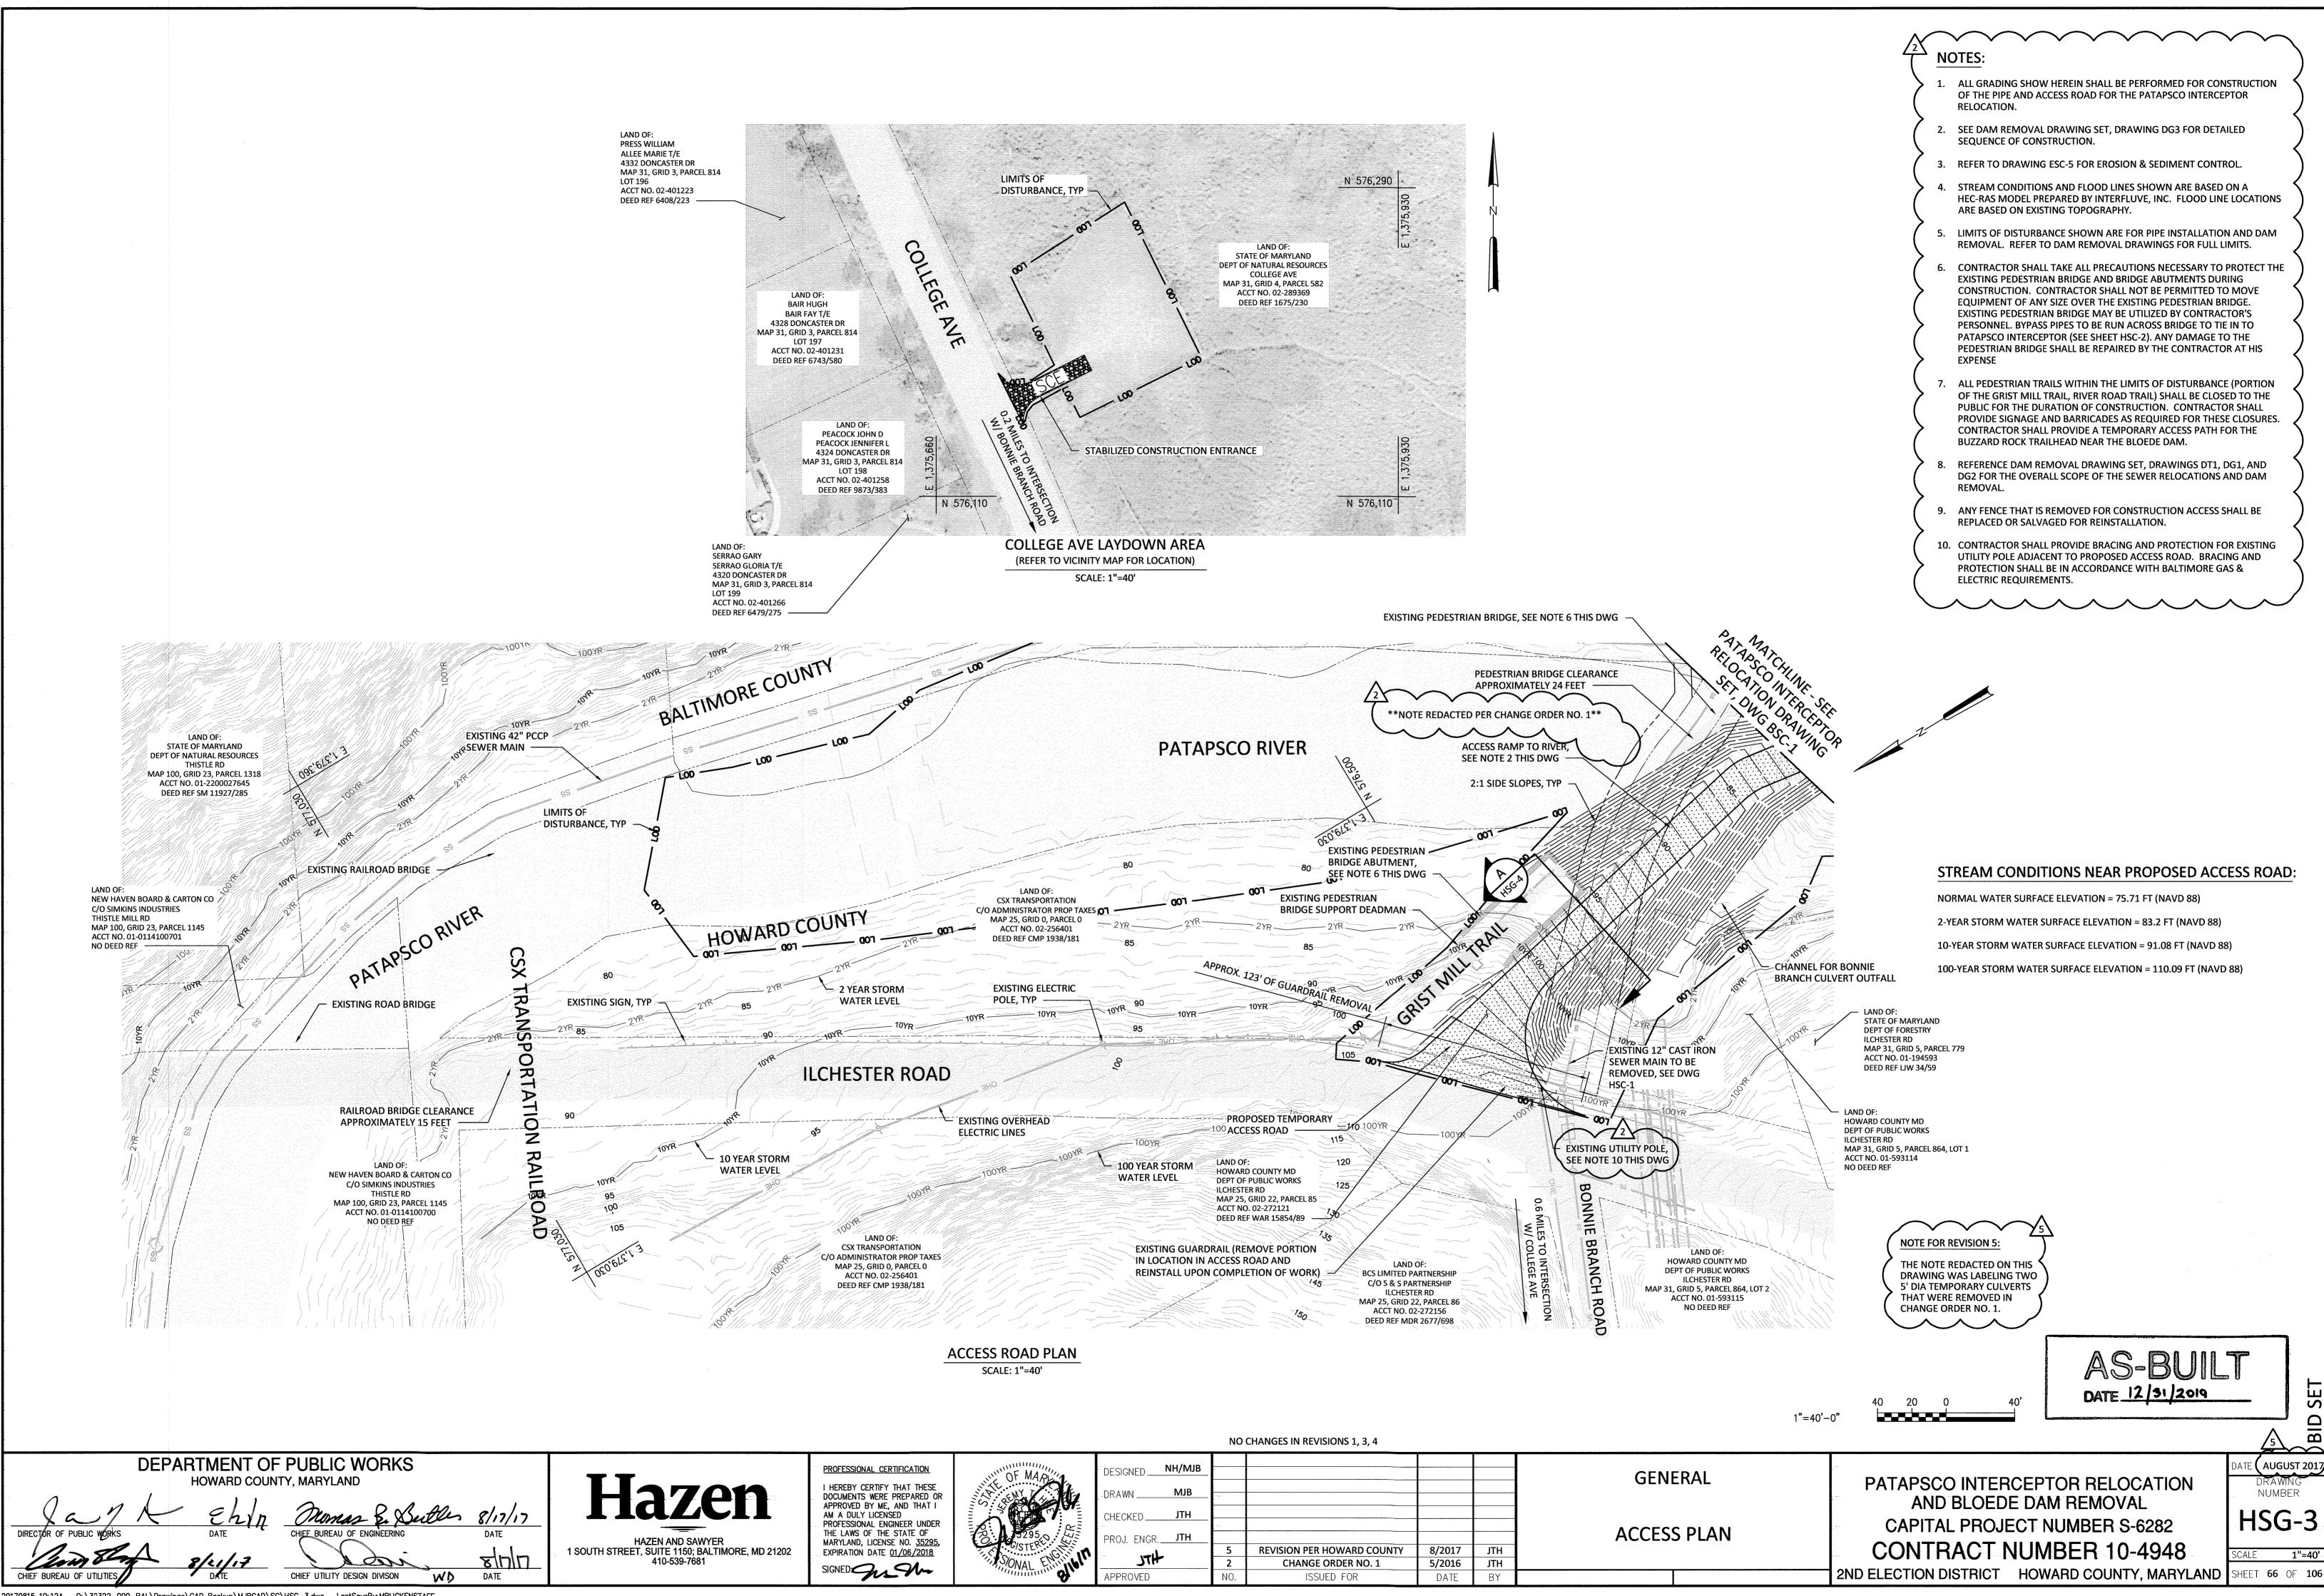

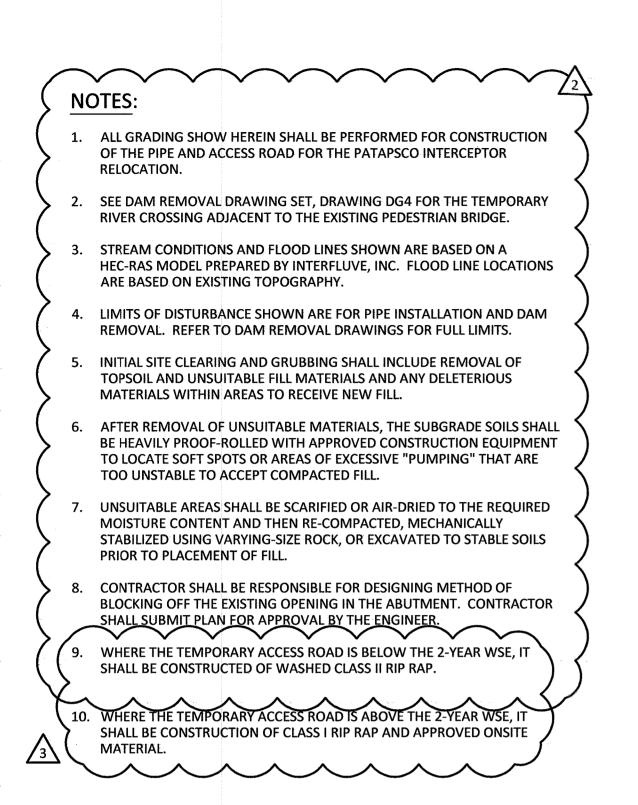

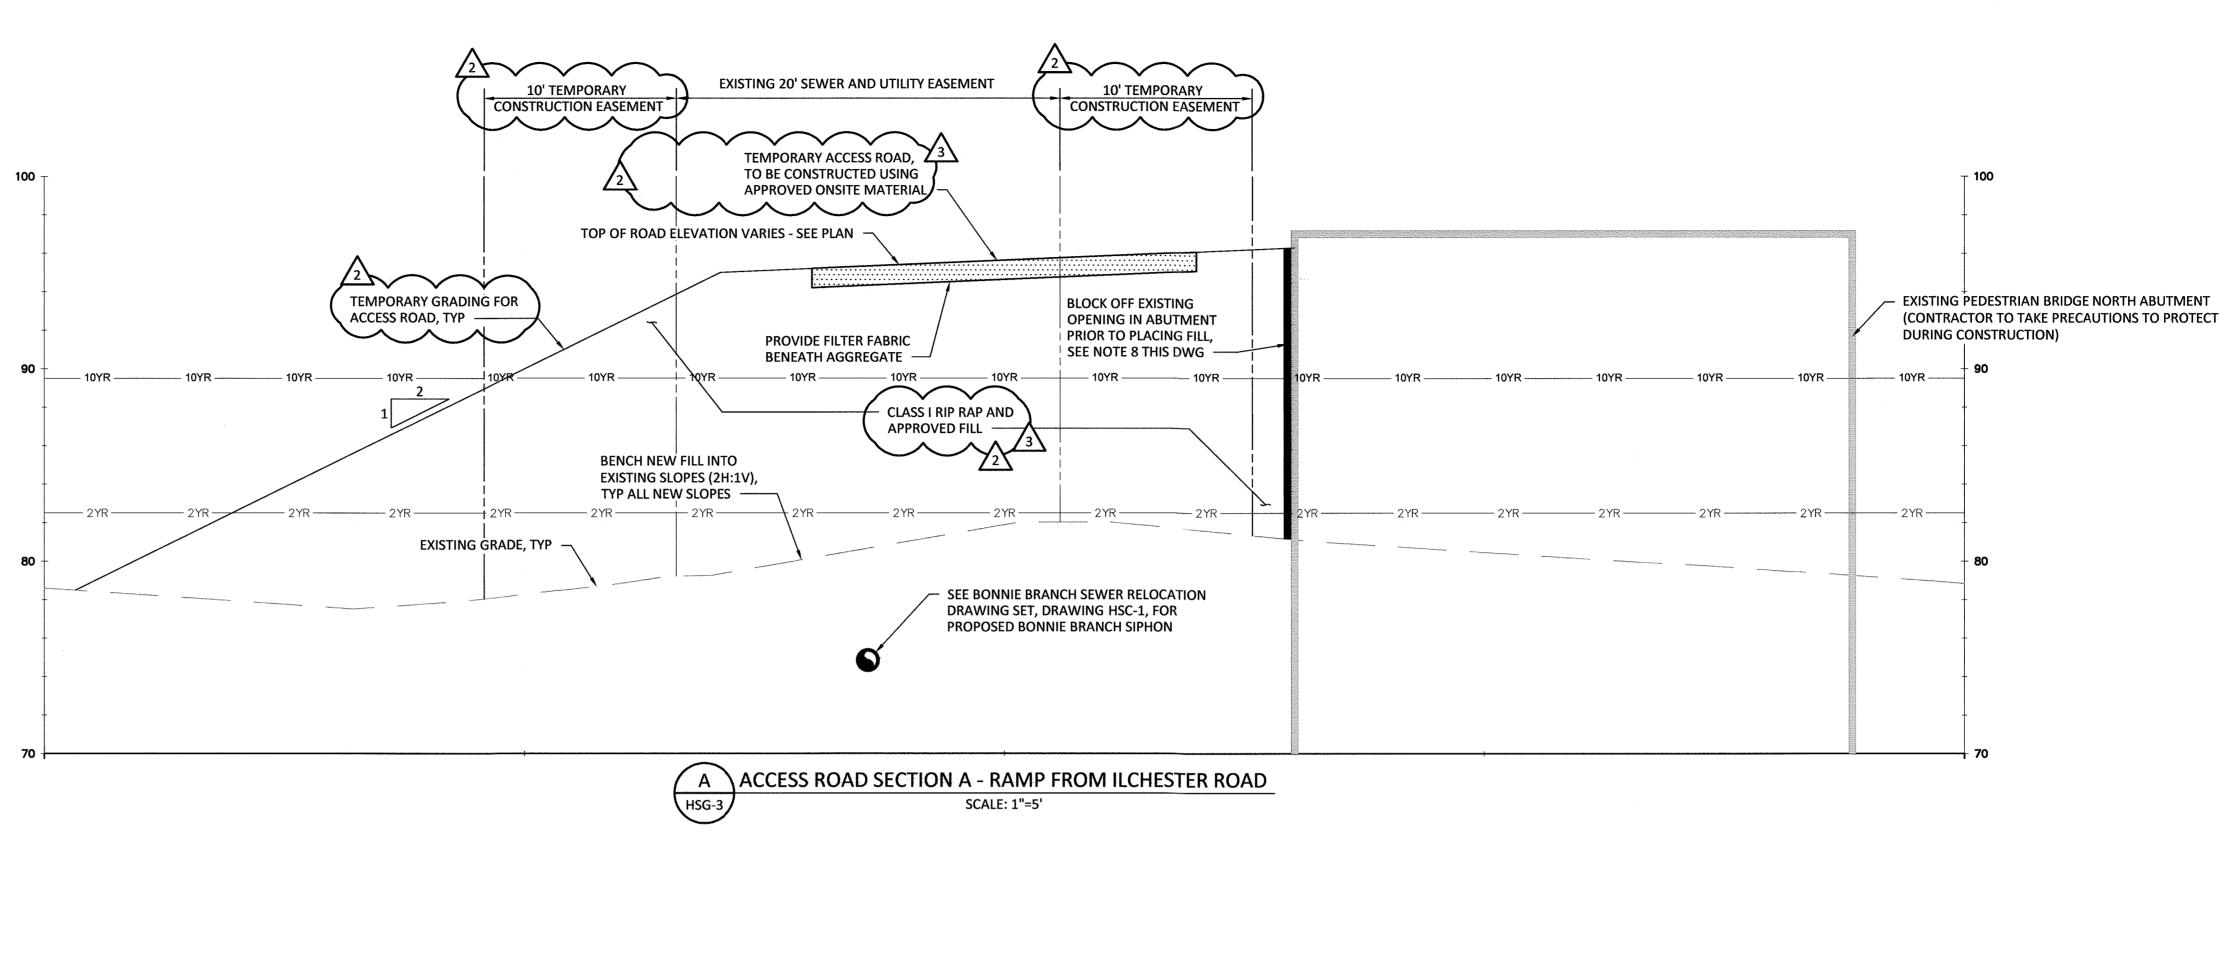

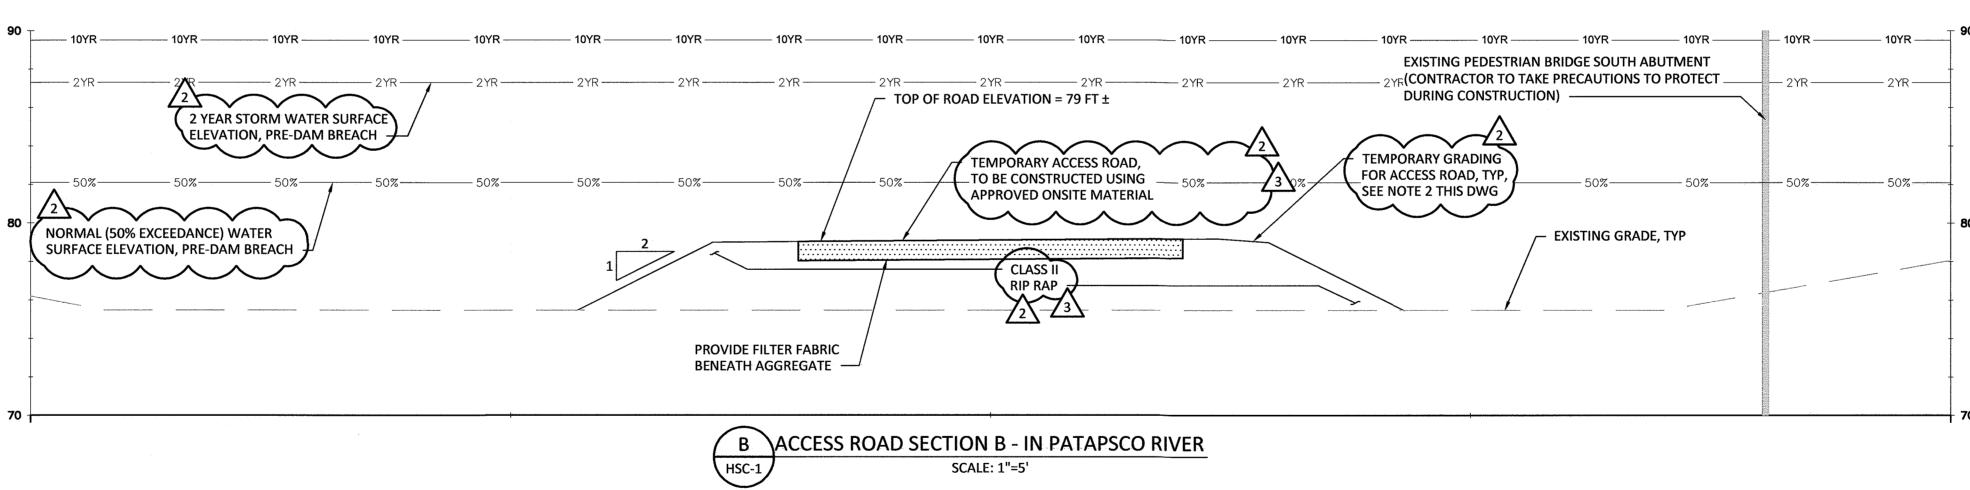

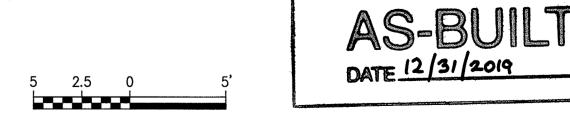

NO CHANGES IN REVISIONS 1, 4

DEPARTMENT OF PUBLIC WORKS HOWARD COUNTY, MARYLAND

HAZEN AND SAWYER 1 SOUTH STREET, SUITE 1150; BALTIMORE, MD 21202

410-539-7681

PROFESSIONAL CERTIFICATION I HEREBY CERTIFY THAT THESE DOCUMENTS WERE PREPARED OR APPROVED BY ME, AND THAT I AM A DULY LICENSED PROFESSIONAL ENGINEER UNDER
THE LAWS OF THE STATE OF
MARYLAND, LICENSE NO. 35295. EXPIRATION DATE 01/06/2018



	DESIGNED	NH/MJB					
	DRAWN	МЈВ		-			
	CHECKED	JTH					
	PROJ. ENGR	JTH	5	REVISION PER HOWARD COUNTY	8/2017	JTH	
1	477		3	REVISION PER MDE COMMENTS	8/2016	JTH	
`			2	CHANGE ORDER NO. 1	5/2016	JTH	L
	APPROVED		NO.	ISSUED FOR	DATE	BY	


**GENERAL ACCESS ROAD SECTIONS** 

PATAPSCO INTERCEPTOR RELOCATION AND BLOEDE DAM REMOVAL CAPITAL PROJECT NUMBER S-6282 **CONTRACT NUMBER 10-4948** 2ND ELECTION DISTRICT HOWARD COUNTY, MARYLAND SHEET 67 OF 106

ATE (AUGUST 2017 DRAWING NUMBER HSG-4 CALE **1"=5**"

# NOTES:

- 1. RECORD DRAWINGS ARE SHOWN FOR INFORMATION ONLY.
- 2. ELEVATIONS SHOWN ON THIS DRAWING ARE BASED ON NGVD29 VERTICAL DATUM.

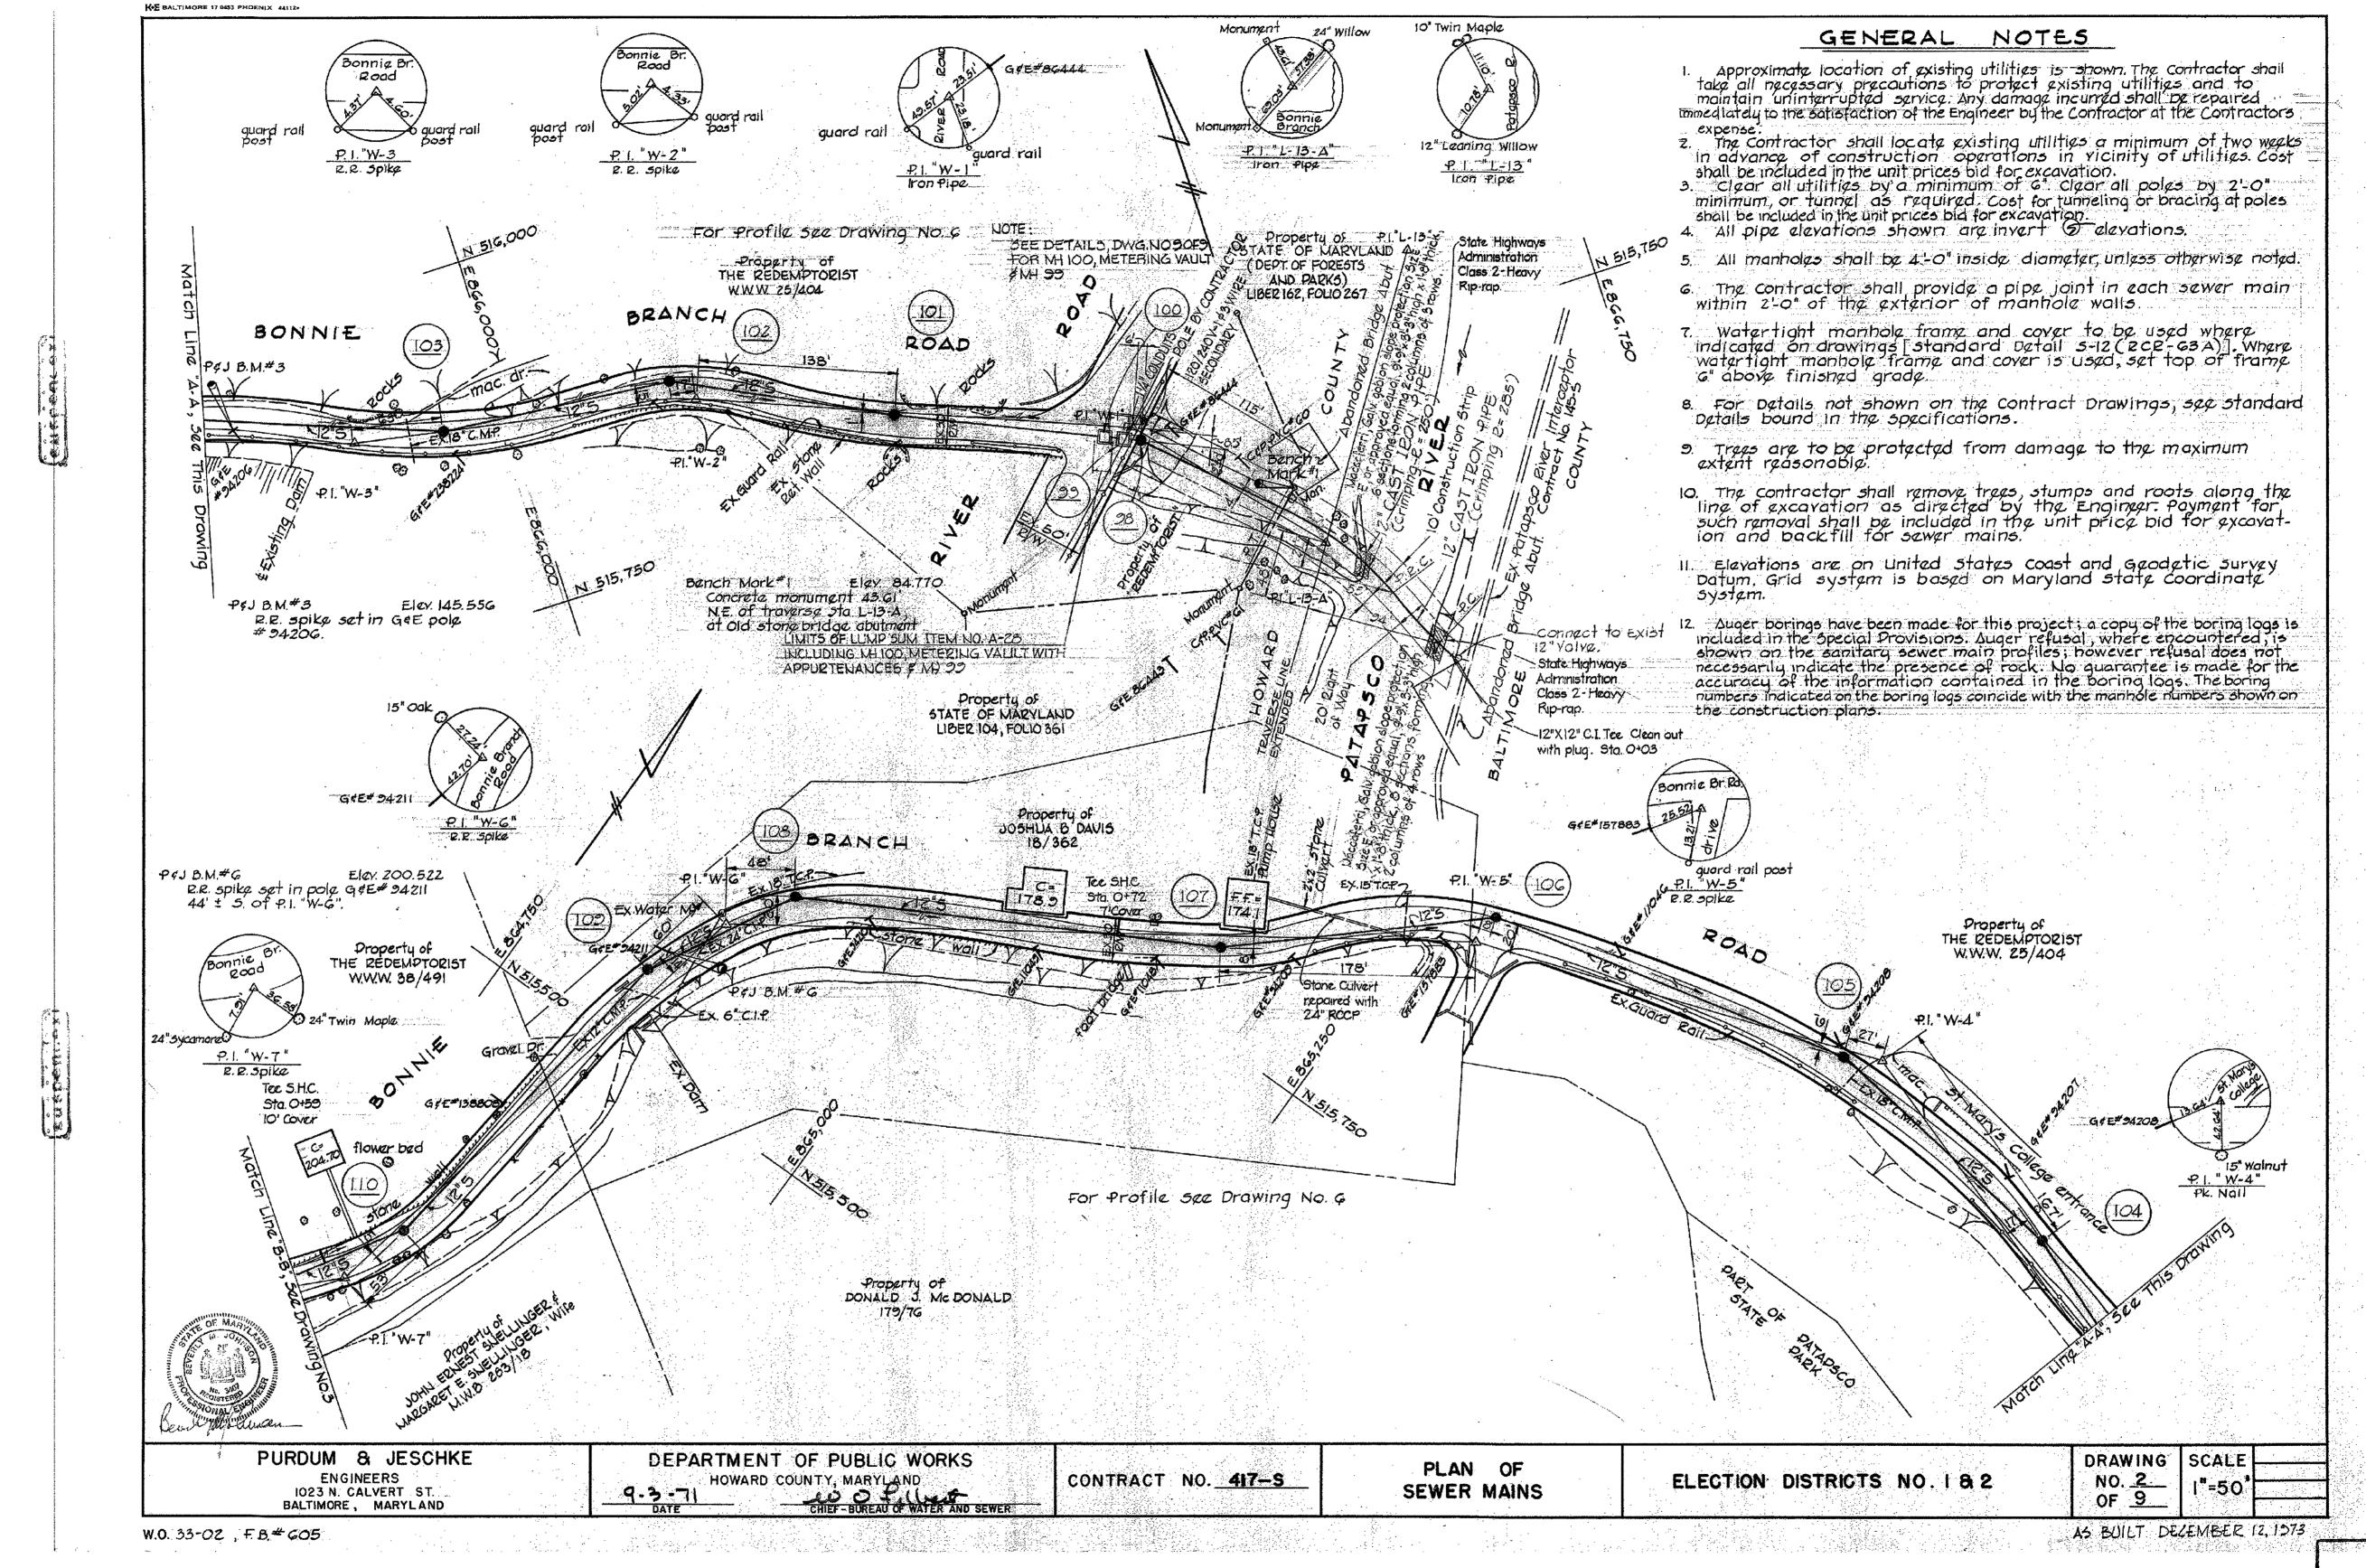

AS-BUILT DATE 12/31/2019

**DEPARTMENT OF PUBLIC WORKS** 

**HOWARD COUNTY, MARYLAND** 

HAZEN AND SAWYER 1 SOUTH STREET, SUITE 1150; BALTIMORE, MD 21202 410-539-7681

PROFESSIONAL CERTIFICATION I HEREBY CERTIFY THAT THESE DOCUMENTS WERE PREPARED OR APPROVED BY ME, AND THAT I AM A DULY LICENSED PROFESSIONAL ENGINEER UNDER THE LAWS OF THE STATE OF MARYLAND, LICENSE NO. 35295, EXPIRATION DATE 01/06/2018



	DESIGNED NH/MJB					
4	DRAWN EP	- 				
	CHECKED JTH		700-			ŀ
	PROJ. ENGR. <b>JTH</b>					
11	177	5	REVISION PER HOWARD COUNTY	8/2017	JTH	
	APPROVED	NO.	ISSUED FOR	DATE	BY	

NO CHANGES IN REVISIONS 1, 2, 3, 4

**GENERAL BONNIE BRANCH SEWER RECORD DRAWINGS (FOR INFORMATION ONLY)** 

PATAPSCO INTERCEPTOR RELOCATION AND BLOEDE DAM REMOVAL CAPITAL PROJECT NUMBER S-6282 **CONTRACT NUMBER 10-4948** 2ND ELECTION DISTRICT HOWARD COUNTY, MARYLAND SHEET 68 OF 106


DRAWING NUMBER HSG-5

20170815 10:13A 0:\32322-000-BAL\Drawings\CAD Backup\MJBCAD\SG\HSG-5.dwg LastSaveBy: MBLICKENSTAFF

S

# NOTES:

- 1. RECORD DRAWINGS ARE SHOWN FOR INFORMATION ONLY.
- 2. ELEVATIONS SHOWN ON THIS DRAWING ARE BASED ON NGVD29 VERTICAL DATUM.

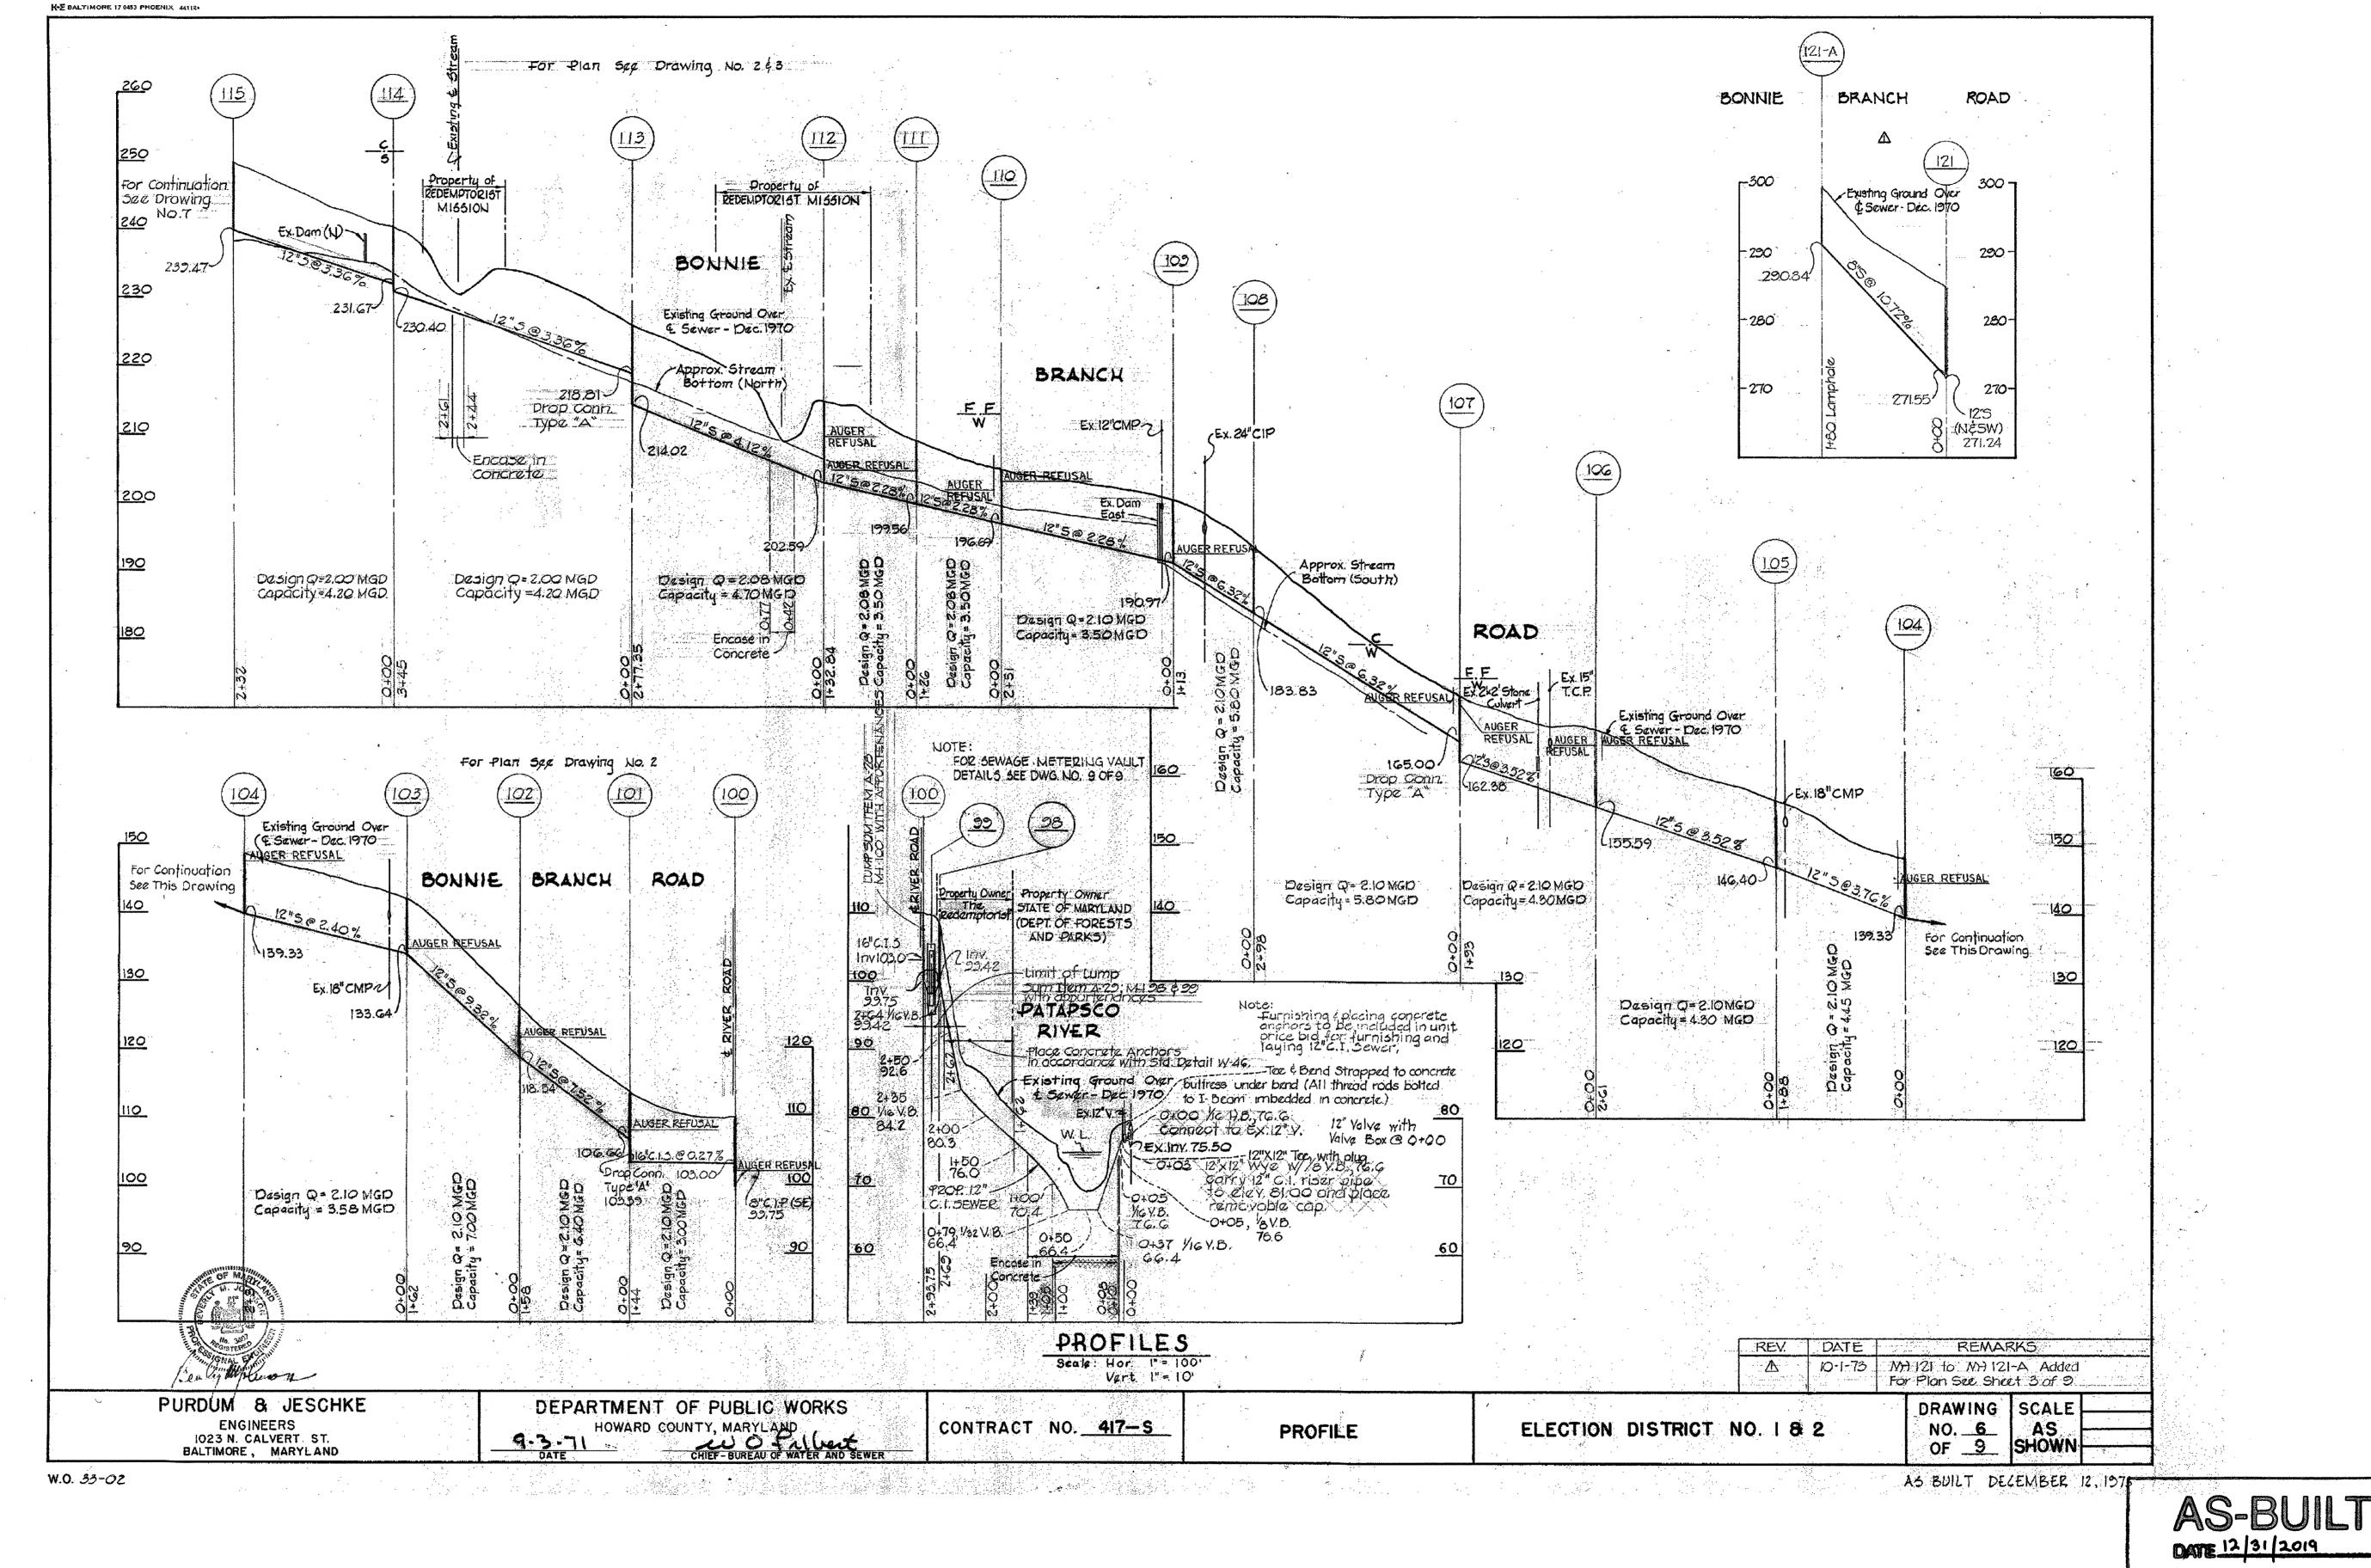

DEPARTMENT OF PUBLIC WORKS HOWARD COUNTY, MARYLAND

CHIEF UTILITY DESIGN DIVISON

HAZEN AND SAWYER 1 SOUTH STREET, SUITE 1150; BALTIMORE, MD 21202

410-539-7681

PROFESSIONAL CERTIFICATION I HEREBY CERTIFY THAT THESE DOCUMENTS WERE PREPARED OR APPROVED BY ME, AND THAT ! AM A DULY LICENSED PROFESSIONAL ENGINEER UNDER THE LAWS OF THE STATE OF MARYLAND, LICENSE NO. 35295, EXPIRATION DATE 01/06/2018 SIGNED:



NH/MJB DESIGNED\_ CHECKED\_ PROJ. ENGR. JTH 8/2017 **REVISION PER HOWARD COUNTY** 

NO CHANGES IN REVISIONS 1, 2, 3, 4

**GENERAL BONNIE BRANCH SEWER RECORD DRAWINGS (FOR INFORMATION ONLY)** 

PATAPSCO INTERCEPTOR RELOCATION AND BLOEDE DAM REMOVAL CAPITAL PROJECT NUMBER S-6282 **CONTRACT NUMBER 10-4948** 2ND ELECTION DISTRICT HOWARD COUNTY, MARYLAND SHEET 69 OF 106


NUMBER HSG-6 CALE NTS

ATE ( AUGUST 201

SEI


20170815 10:13A 0:\32322-000-BAL\Drawings\CAD Backup\MJBCAD\SG\HSG-6.dwg LastSaveBy:MBLICKENSTAFF

1

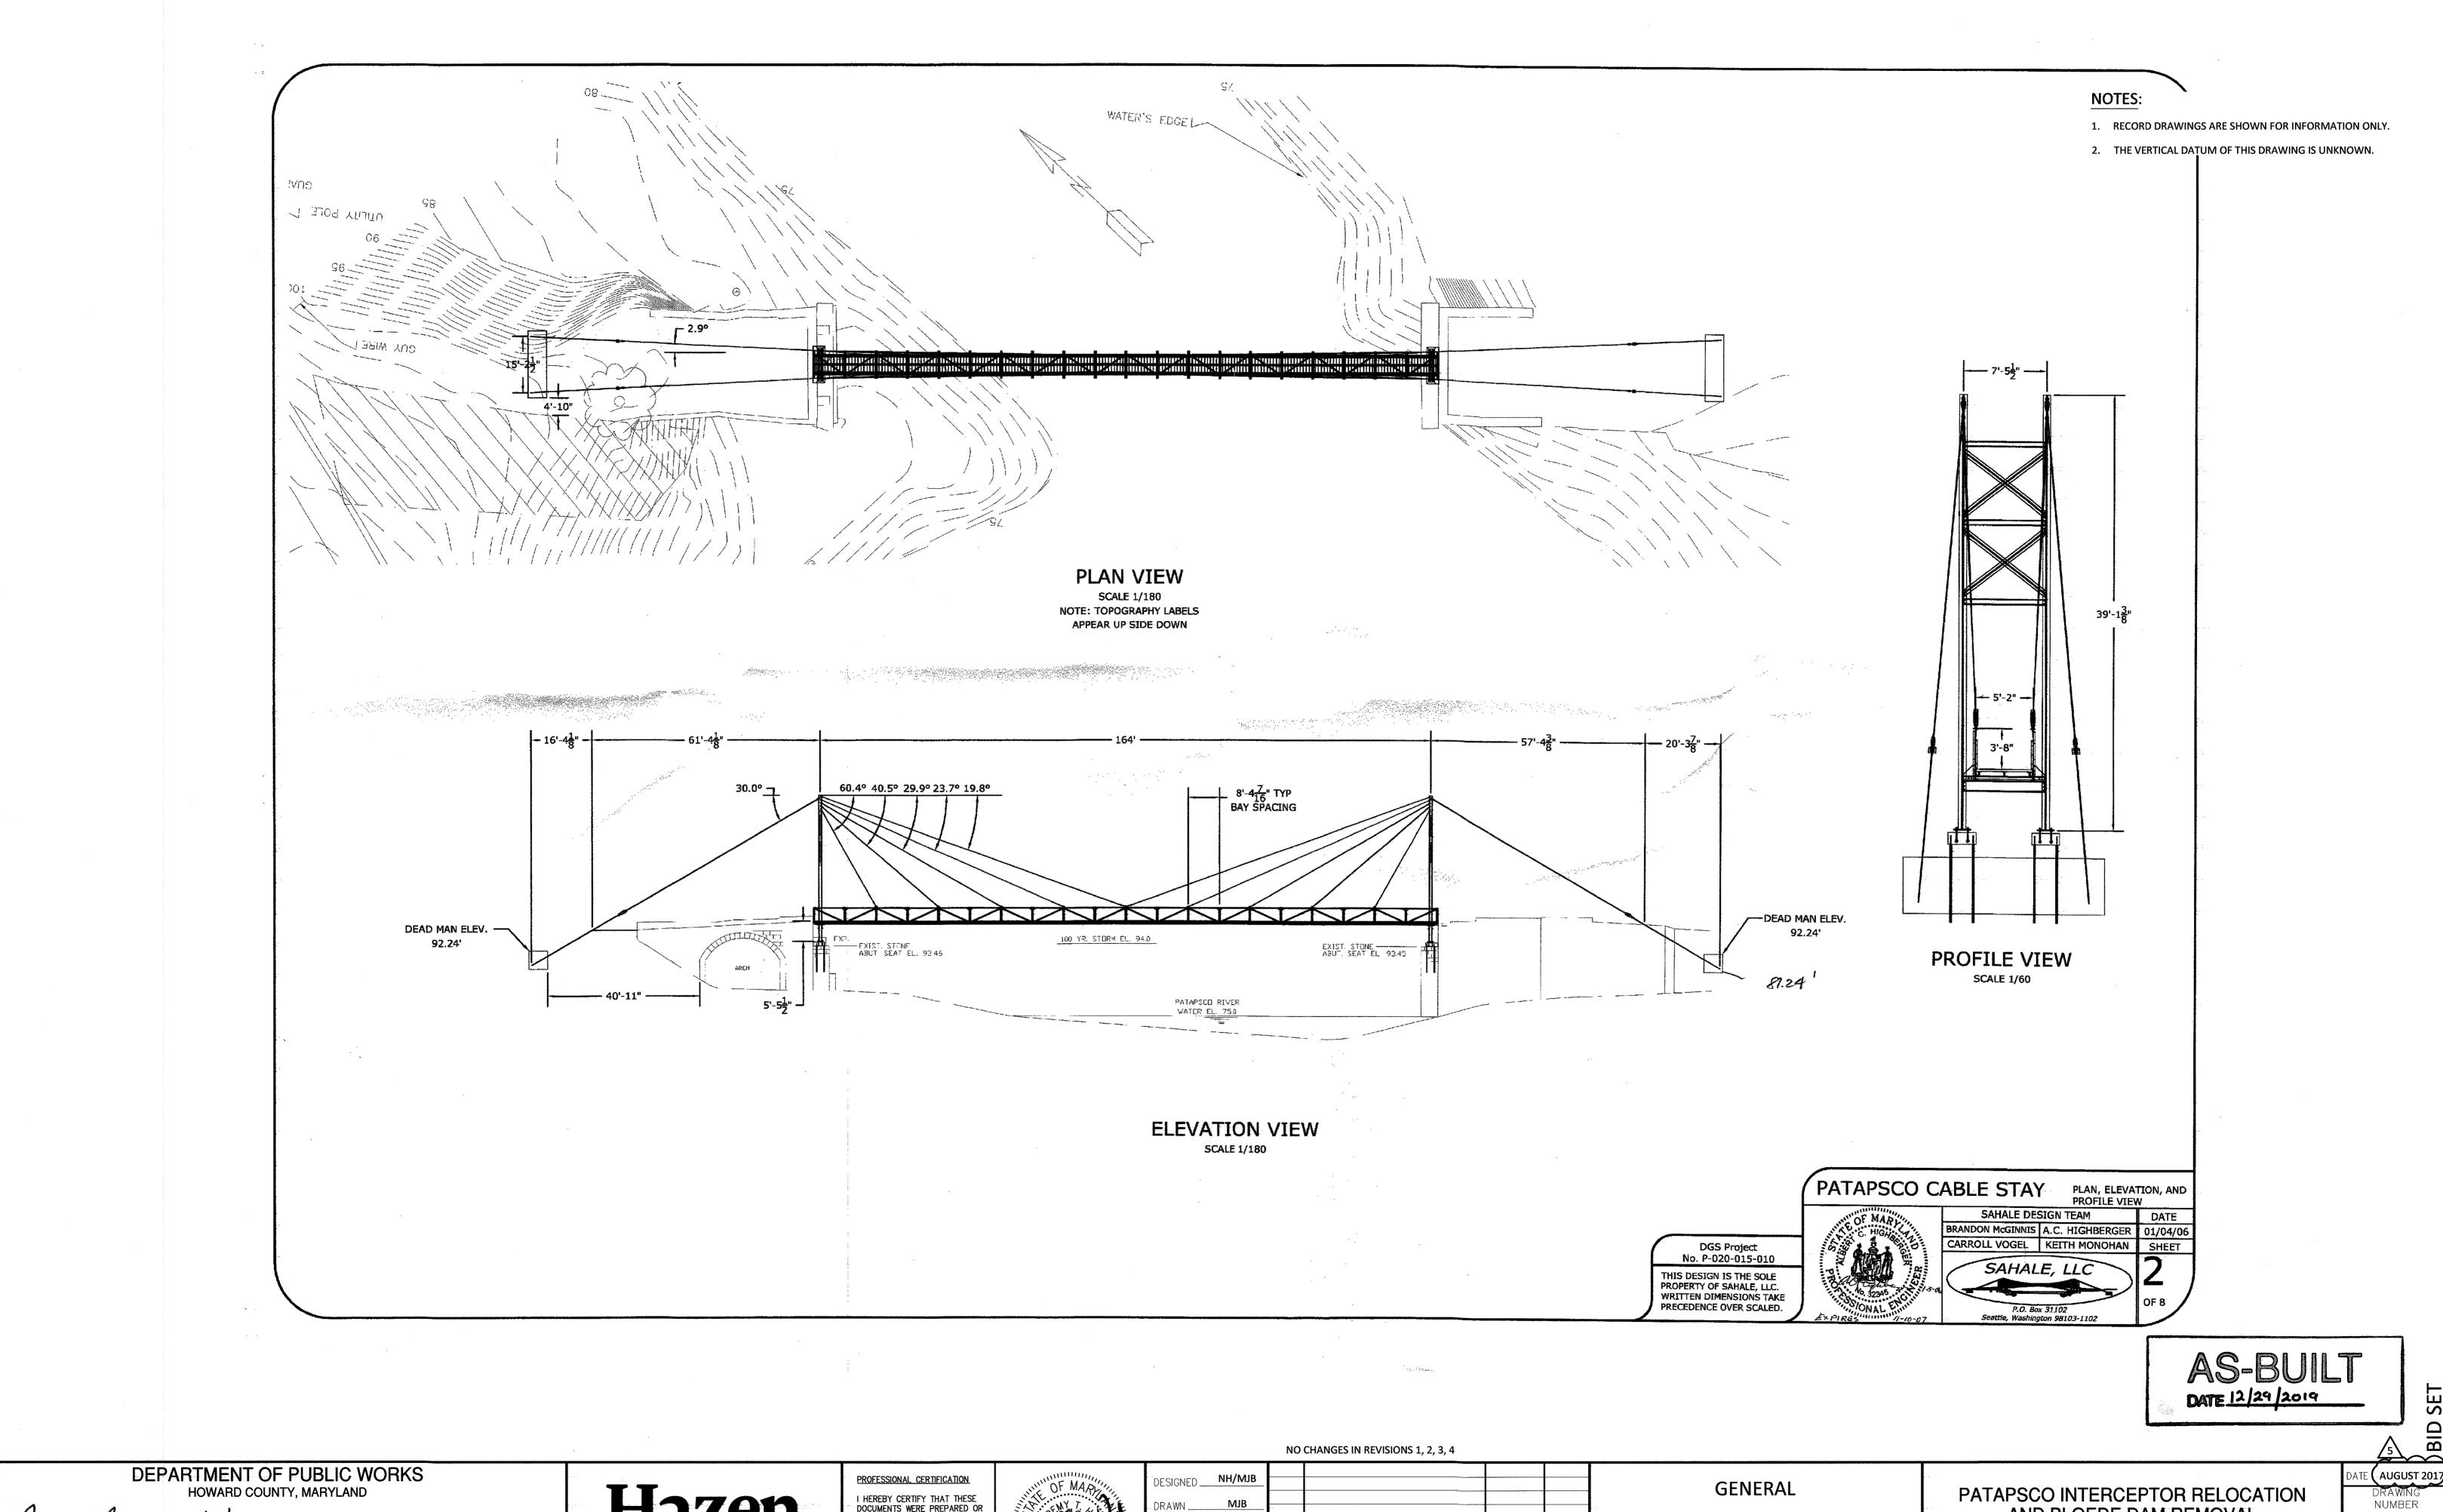

HAZEN AND SAWYER 1 SOUTH STREET, SUITE 1150; BALTIMORE, MD 21202 410-539-7681

I HEREBY CERTIFY THAT THESE DOCUMENTS WERE PREPARED OR APPROVED BY ME, AND THAT I AM A DULY LICENSED PROFESSIONAL ENGINEER UNDER THE LAWS OF THE STATE OF MARYLAND, LICENSE NO. 35295, EXPIRATION DATE 01/06/2018

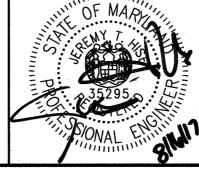


DESIGNED NH/MJ	В	200			İ
DRAWNMJB					
CHECKED JTH					
PROJ. ENGR. JTH					
724	5	REVISION PER HOWARD COUNTY	8/2017	JTH	
APPROVED	NO.	ISSUED FOR	DATE	BY	,
	DRAWN MJB  CHECKED JTH  PROJ. ENGR. JTH	DRAWN MJB  CHECKED JTH  PROJ. ENGR. JTH	DRAWNMJB  CHECKEDJTH  PROJ. ENGRJTH  5 REVISION PER HOWARD COUNTY	DRAWN MJB  CHECKED JTH  PROJ. ENGR. JTH  5 REVISION PER HOWARD COUNTY 8/2017	DRAWNMJB  CHECKEDJTH  PROJ. ENGRJTH  5 REVISION PER HOWARD COUNTY 8/2017 JTH

PEDESTRIAN BRIDGE RECORD DRAWINGS (FOR **INFORMATION ONLY)** 

PATAPSCO INTERCEPTOR RELOCATION AND BLOEDE DAM REMOVAL CAPITAL PROJECT NUMBER S-6282 CONTRACT NUMBER 10-4948 2ND ELECTION DISTRICT HOWARD COUNTY, MARYLAND SHEET 70 OF 106

HSG-7

20170815 10:14A 0:\32322-000-BAL\Drawings\CAD Backup\MJBCAD\SG\HSG-7.dwg LastSaveBy:MBLICKENSTAFF

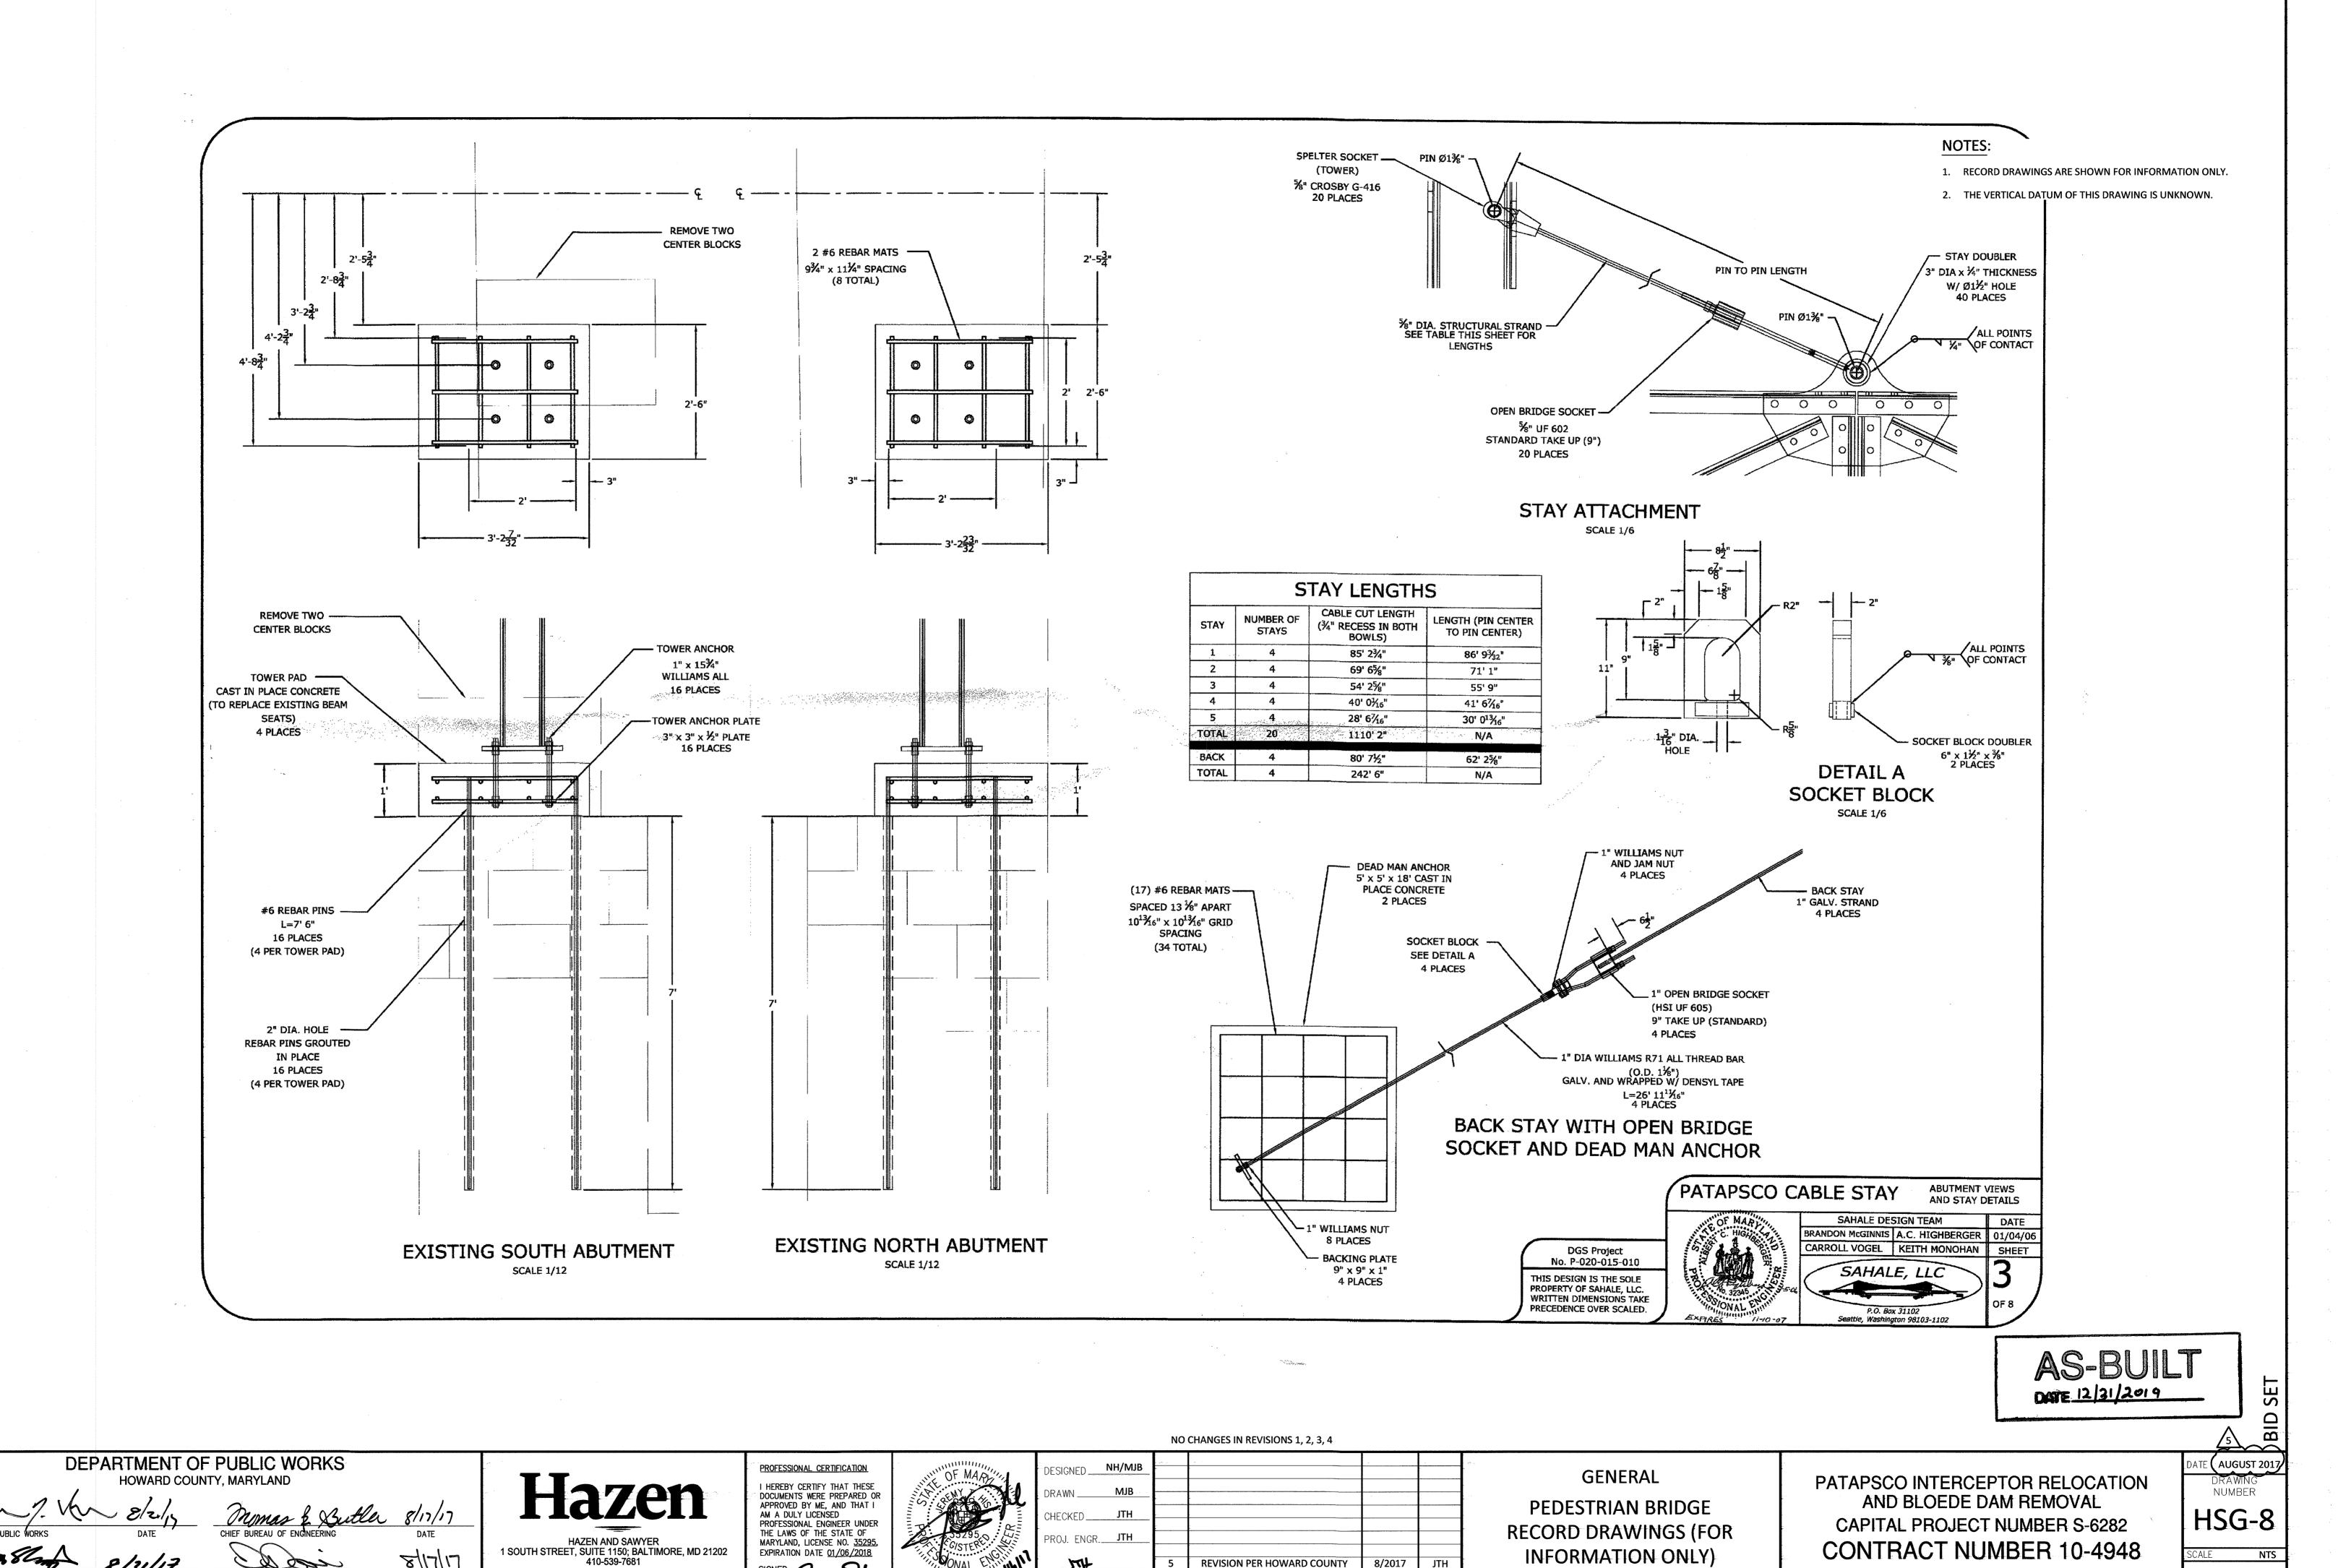

8/2017

**REVISION PER HOWARD COUNTY** 

ISSUED FOR

JTH


2ND ELECTION DISTRICT HOWARD COUNTY, MARYLAND SHEET 71 OF 106

20170815 10:31A 0:\32322-000-BAL\Drawings\CAD Backup\MJBCAD\SG\HSG-8.dwg LastSaveBy:MBLICKENSTAFF


8/17/17

# NOTES:

1. LIMITS OF DISTURBANCE SHOWN ARE FOR PIPE INSTALLATION AND DAM REMOVAL. REFER TO DAM REMOVAL DRAWINGS FOR FULL LIMITS.

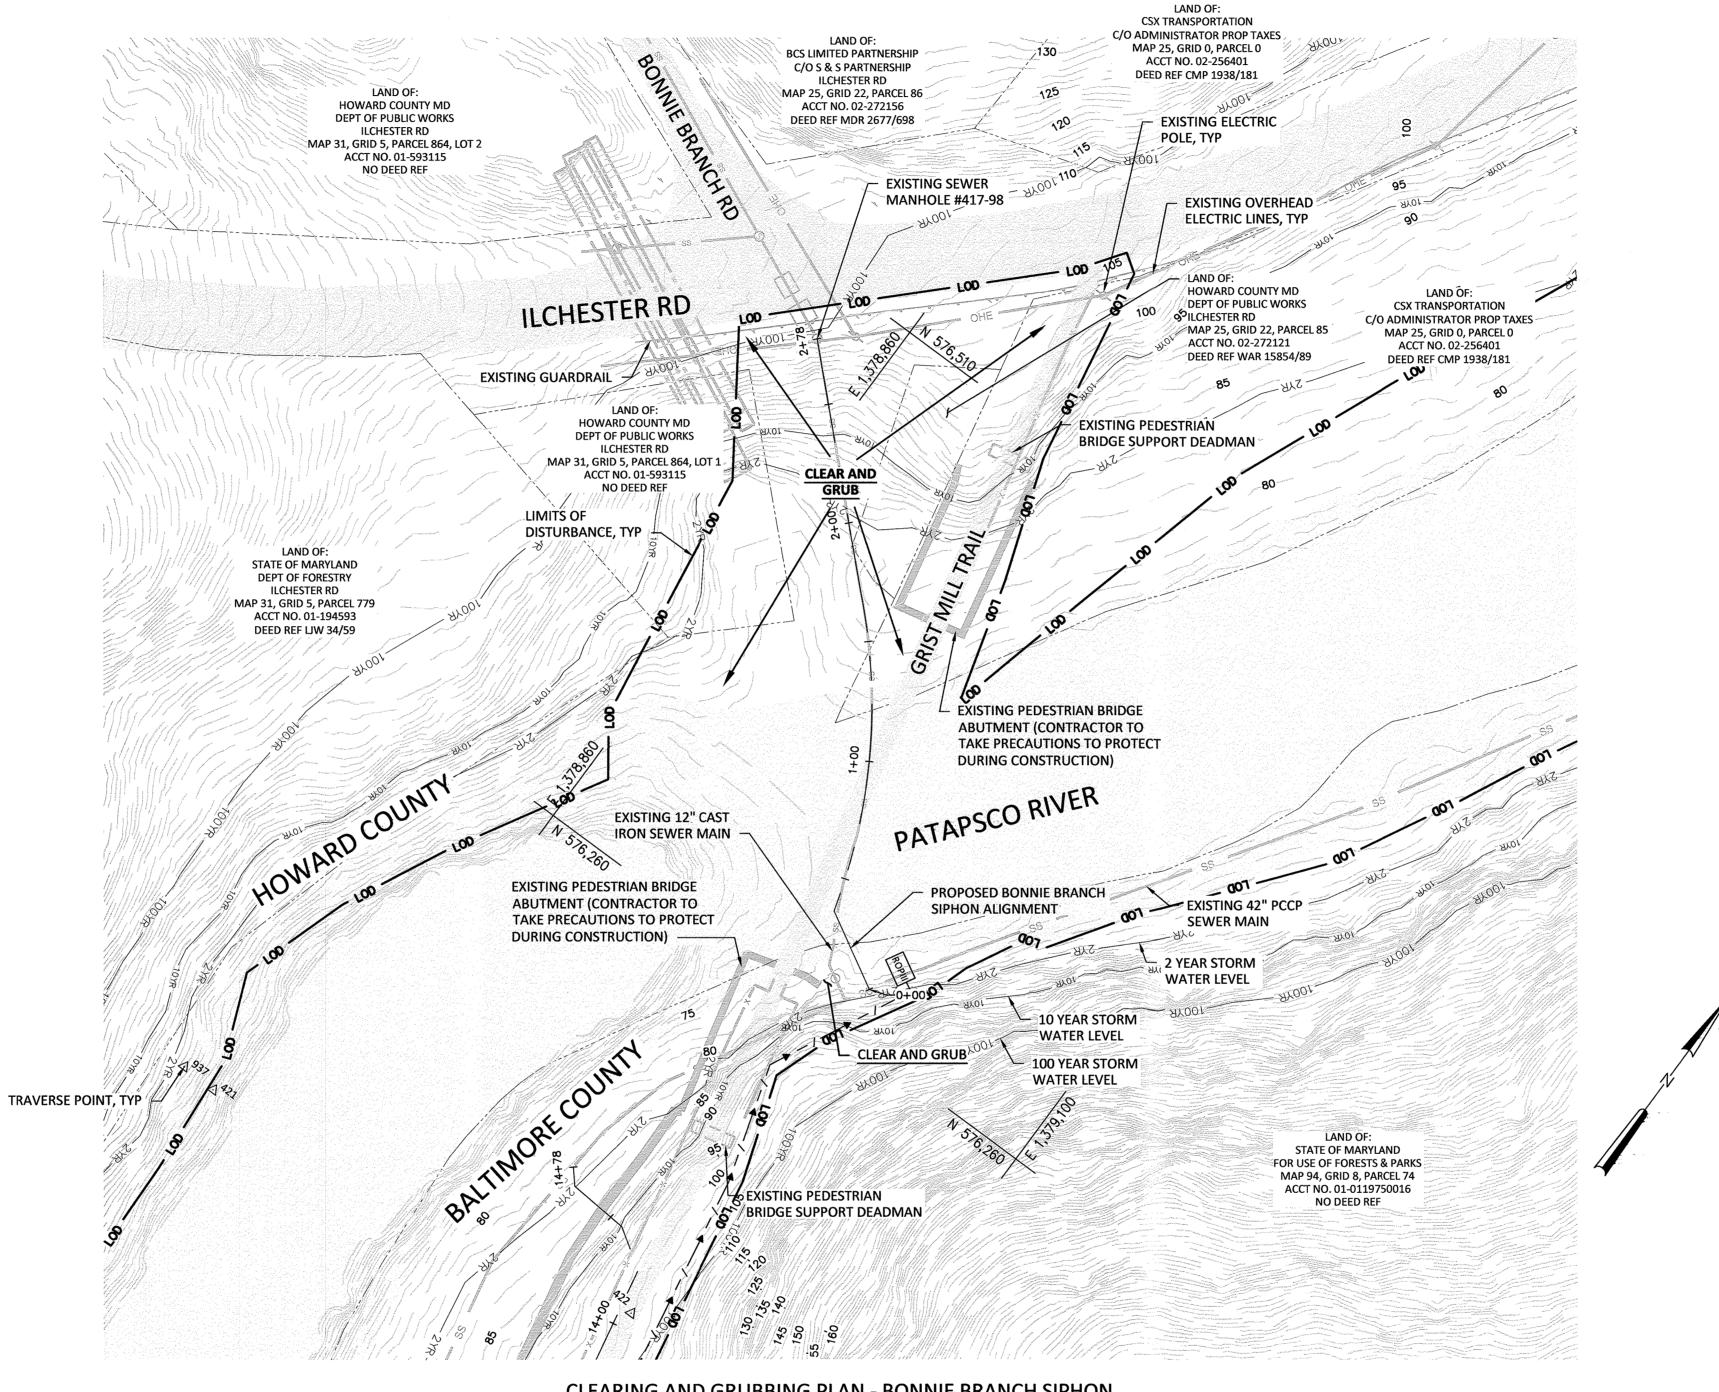

CLEARING AND GRUBBING PLAN - BONNIE BRANCH SIPHON SCALE: 1"=40'

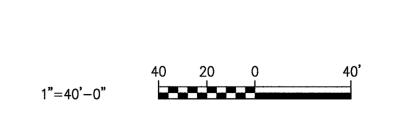

DEPARTMENT OF PUBLIC WORKS HOWARD COUNTY, MARYLAND

CHIEF UTILITY DESIGN DIVISON

HAZEN AND SAWYER 1 SOUTH STREET, SUITE 1150; BALTIMORE, MD 21202 410-539-7681

WD DATE

PROFESSIONAL CERTIFICATION I HEREBY CERTIFY THAT THESE DOCUMENTS WERE PREPARED OR APPROVED BY ME, AND THAT I AM A DULY LICENSED PROFESSIONAL ENGINEER UNDER THE LAWS OF THE STATE OF MARYLAND, LICENSE NO. 35295, EXPIRATION DATE 01/06/2018




	DESIGNED NH/MJB					
	DRAWNMJB	÷				
	CHECKED JTH			-		,
	PROJ. ENGR. JTH	** *				ľ
\	747	5	REVISION PER HOWARD COUNTY	8/2017	JTH	
-	APPROVED	NO.	ISSUED FOR	DATE	BY	Γ

NO CHANGES IN REVISIONS 1, 2, 3, 4

CIVIL **CLEARING AND GRUBBING PLAN** 

PATAPSCO INTERCEPTOR RELOCATION AND BLOEDE DAM REMOVAL CAPITAL PROJECT NUMBER S-6282 CONTRACT NUMBER 10-4948 2ND ELECTION DISTRICT HOWARD COUNTY, MARYLAND SHEET 72 OF 106

DRAWING NUMBER HSR-1 SCALE **1"=40'** 

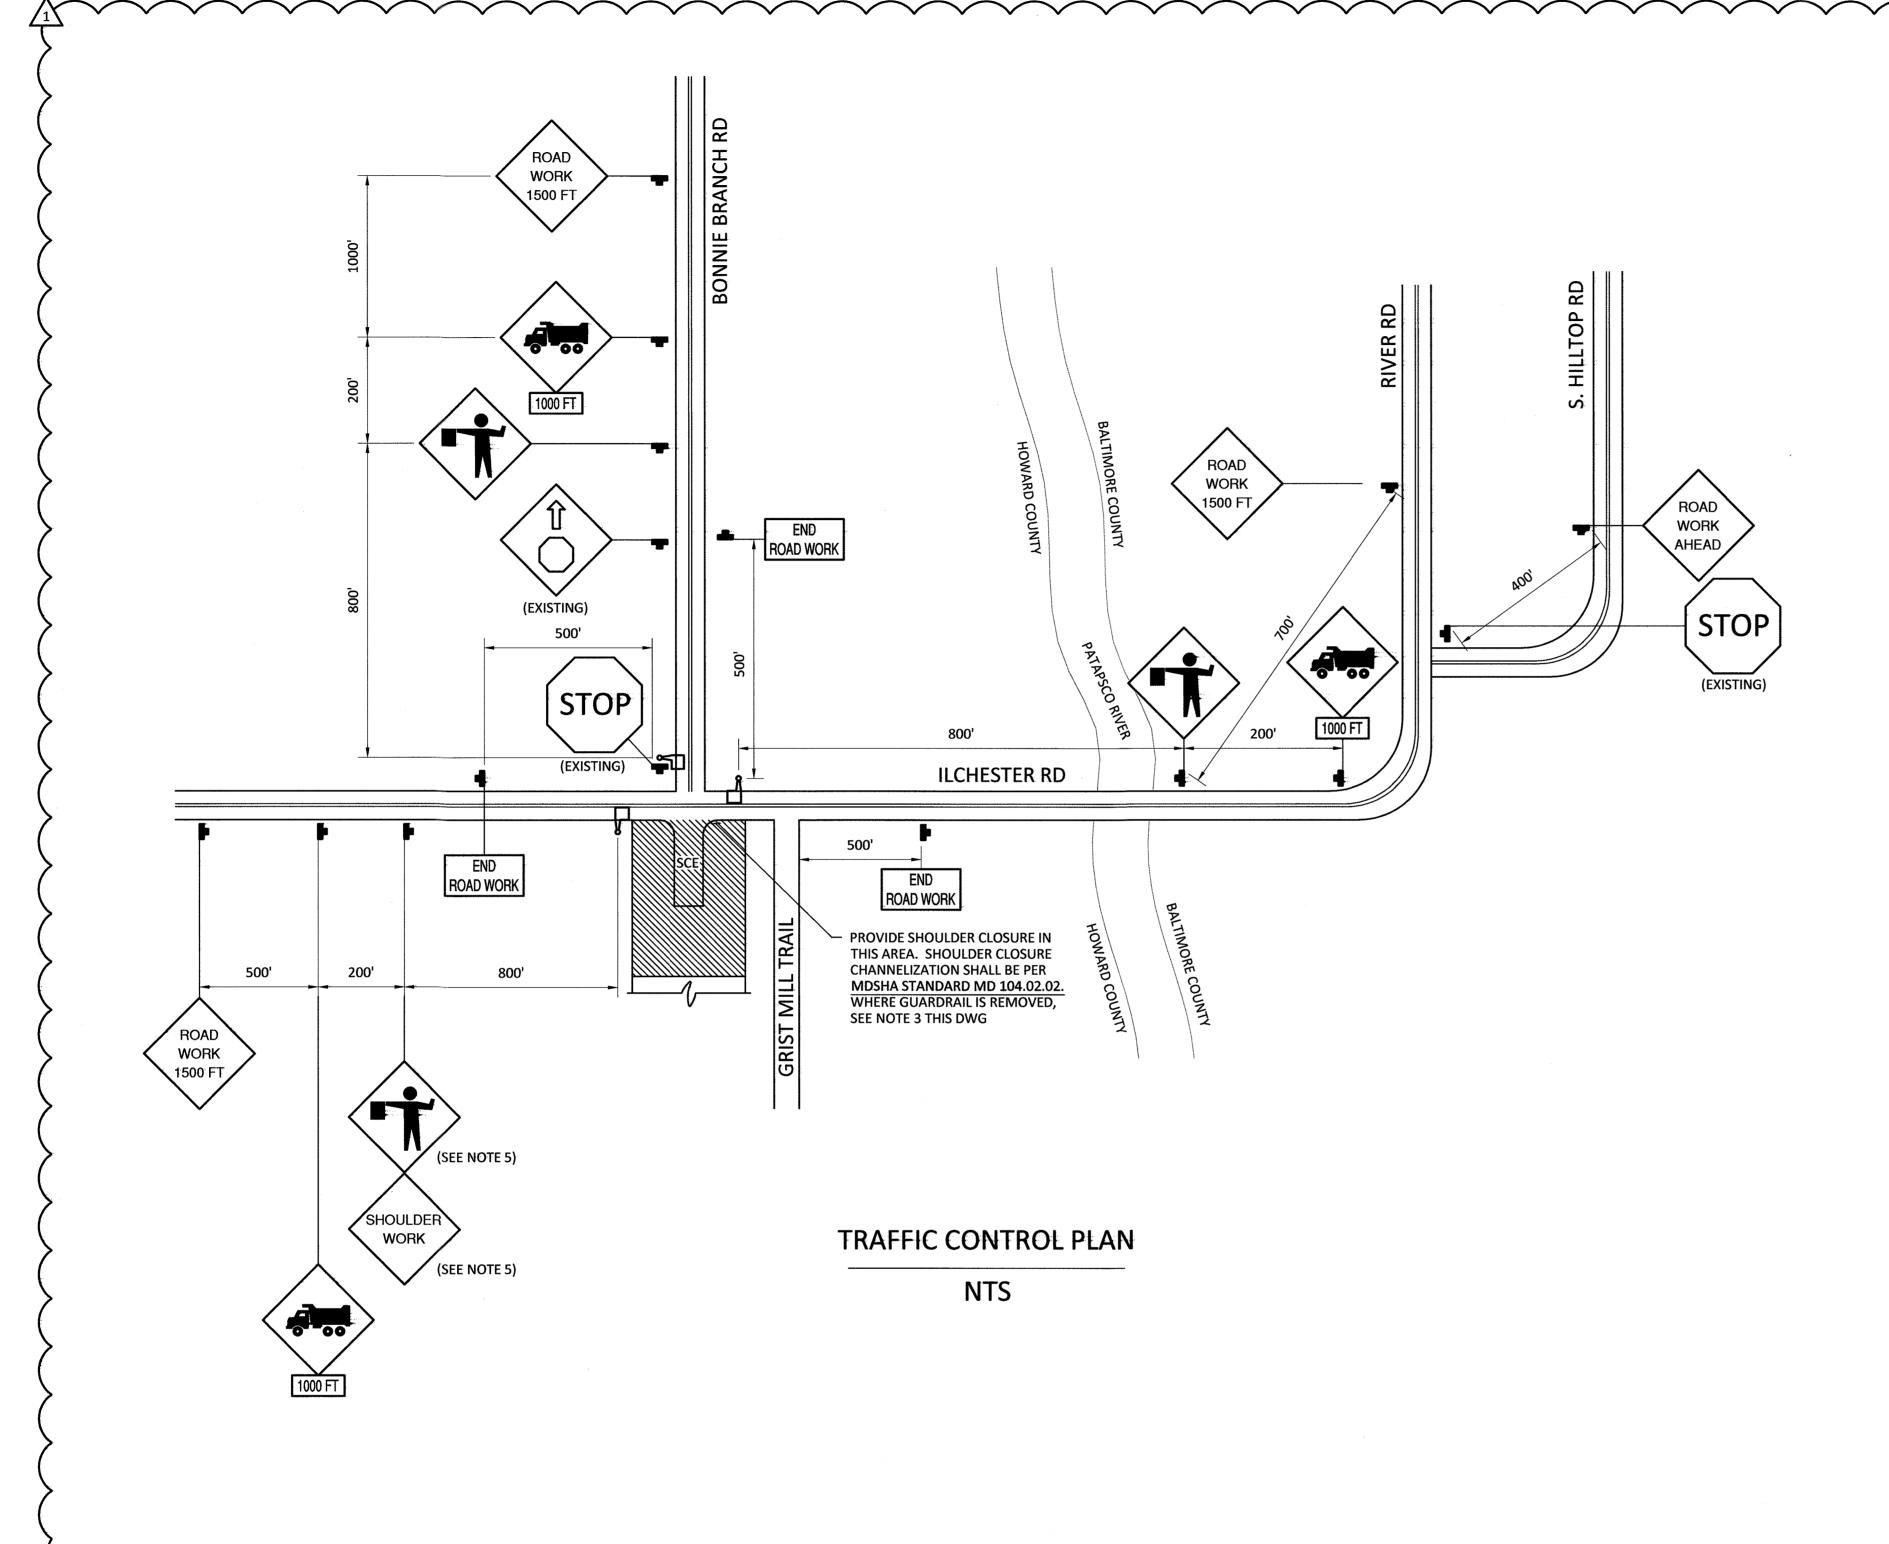

#### TRAFFIC CONTROL PLAN NOTES:

- 1. EXACT LOCATION OF ALL SIGNS SHALL BE COORDINATED WITH THE ENGINEER.
- 2. ALL WORK ZONE VEHICLES WHEN ENTERING/EXITING THE WORK AREA OR OPERATING WITHIN THE WORK ZONE SHALL DISPLAY FLASHING WARNING LIGHTS AS SPECIFIED IN MARYLAND SHA STANDARDS 104.01-18A AND B.
- 3. A PORTION OF THE EXISTING GUARDRAIL WILL NEED TO BE REMOVED FOR CONSTRUCTION ACCESS. CONTRACTOR SHALL PROVIDE THE PROPER NUMBER AND ARRANGEMENT OF SAND FILLED CRASH CUSHIONS AS PER MARYLAND SHA STANDARD 104.01-71 FOR 40MPH TO PROTECT THE ENDS OF THE GUARDRAIL FROM TRAFFIC.
- 4. ALL TEMPORARY SIGNS SHALL BE COVERED OR TURNED AWAY FROM TRAFFIC DURING NON-WORKING HOURS UNLESS OTHERWISE NOTED.
- 5. DURING WORK HOURS WHEN FLAGGER IS PRESENT, FLAGGER SIGN SHALL BE DISPLAYED IN THIS LOCATION. DURING ALL OTHER HOURS, SHOULDER WORK SIGN SHALL BE DISPLAYED IN THIS LOCATION.

# SYMBOL LEGEND

SIGN

BARRICADE

**WORK AREA** 

**FLAGGER** 

# SIGN LEGEND

SIGN	MDSHA SIGN NO.
	W11-10(1)
	W20-7a
ROAD WORK 1500 FT	W20-1(1)
END ROAD WORK	G20-2(1)
SHOULDER WORK	W21-5(1)


DEPARTMENT OF PUBLIC WORKS

HOWARD COUNTY, MARYLAND

**WD** DATE

HAZEN AND SAWYER 1 SOUTH STREET, SUITE 1150; BALTIMORE, MD 21202 410-539-7681

PROFESSIONAL CERTIFICATION I HEREBY CERTIFY THAT THESE DOCUMENTS WERE PREPARED OR APPROVED BY ME, AND THAT I AM A DULY LICENSED PROFESSIONAL ENGINEER UNDER THE LAWS OF THE STATE OF MARYLAND, LICENSE NO. 35295,

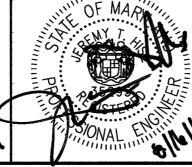

	DESIGNED	ин/мив	-			:
1	DRAWN	MJB	· · ·			
''iiii	CHECKED	JTH	-			
11111	PROJ. ENGR	JTH	j.,			
111	744		5	REVISION PER HOWARD COUNTY	8/2017	JTH
11,			1	ADDENDUM NO. 3	5/2016	JTH
	APPROVED		NO.	ISSUED FOR	DATE	BY

NO CHANGES IN REVISIONS 2, 3, 4

TRAFFIC CONTROL

TRAFFIC CONTROL PLAN

PATAPSCO INTERCEPTOR RELOCATION AND BLOEDE DAM REMOVAL CAPITAL PROJECT NUMBER S-6282 **CONTRACT NUMBER 10-4948** 2ND ELECTION DISTRICT HOWARD COUNTY, MARYLAND SHEET 77 OF 106

ATE **(AUGUST 2017** DRAWING NUMBER HST-1

20170815 10:18A 0:\32322-000-BAL\Drawings\CAD Backup\MJBCAD\ST\HST-1.dwg LastSaveBy: MBLICKENSTAFF