

BENCHMARK INFORMATION

- B.M.#1 HOWARD COUNTY CONTROL STATION #0023 HORIZONTAL NA'83) (LOCATED ALONG THE WEST SIDE OF CENTENNIAL LANE, APPROX. 92' SOUTHEAST FROM THE CORNER OF CENTENNIAL HIGH SCHOOL & APPROX. 89' WEST OF CENTENNIAL LANE PAVING)
- N 577,373.143 E 1,349,751.273
- ELEVATION = 479.248 VERTICAL (NAVD '88)
- B.M.#2 HOWARD COUNTY CONTROL STATION #30AB HORIZONTAL (NAD '03) (LOCATED ALONG THE WEST SIDE OF CENTENNIAL LANE, APPROX. 5.4' BEHIND THE GUARD RAIL AND APPROX. 47.5' NORTH WEST FROM THE END OF THE GUARD RAIL) N 573,239,385
- E 1,349,547.546 ELEVATION = 361.900 - VERTICAL - (NAVD '88)

PF	RIVATE WELL &	PRIVATE SEPTIC	SYSTEM (CHART
PARCEL NO.	ADDRE55	OWNER	ABANDON WELL	ABANDON SEPTIC
05	4509 CENTENNIAL LANE	ROBERT & HELEN SPEDDEN	ON PUBLIC	YE5

NOTE: WATER METERS WILL NOT BE RELEASED BY HOWARD COUNTY TO ANY NEW BUILDING UNTIL THE EXISTING WELLS AND SEPTIC SYSTEMS HAVE BEEN ABANDONED IN ACCORDANCE WITH HOWARD COUNTY HEALTH DEPARTMENT REGULATIONS AND THE EXISTING BUILDINGS ARE CONNECTED TO THE PUBLIC

Contact Howard County Littles prior to shotting of ADY Valves.

DEVELOPER'S CERTIFICATION

" I/WE HEREBY CERTIFY THAT ALL DEVELOPMENT AND CONSTRUCTION WILL BE DONE ACCORDING TO THIS PLAN OF DEVELOPMENT AND PLAN FOR EROSION AND SEDIMENT CONTROL AND THAT ALL RESPONSIBLE PERSONNEL INVOLVED IN THE CONSTRUCTION PROJECT WILL HAVE A CERTIFICATE OF ATTENDANCE AT THE DEPARTMENT OF THE ENVIRONMENT APPROVED TRAINING PROGRAM FOR THE CONTROL OF SEDIMENT AND EROSION BEFORE BEGINNING THE PROJECT. I ALSO AUTHORIZE PERIODIC ON-SITE INSPECTION BY THE HOWARD SOIL CONSERVATION DISTRICT OR THEIR AUTHORIZED AGENTS, AS ARE DEEMED NECESSARY."

Contonnial Rosepus, LLC

SIGNATURE OF DEVELOPER

ENGINEER'S CERTIFICATION " I HEREBY CERTIFY THAT THIS PLAN FOR EROSION AND SEDIMENT CONTROL REPRESENTS A PRACTICAL AND WORKABLE PLAN BASED ON MY

PERSONAL KNOWLEDGE OF THE SITE CONDITIONS AND THAT IT WAS

PREPARED IN ACCORDANCE WITH THE REQUIREMENTS OF THE HOWARD SOIL CONSERVATION DISTRICT." SIGNATURE OF ENGINEER

SEDIMENT CONTROL MEASURES FOR THIS CONTRACT WILL BE IMPLEMENTED IN ACCORDANCE WITH SECTION 308 OF THE HOWARD COUNTY DESIGN MANUAL - VOLUME IV: STANDARD SPECIFICATIONS AND DETAILS FOR CONSTRUCTION AND AS SHOWN ON THE ROAD CONSTRUCTION PLANS, F-20-010

Paul W. Kniebel; FOR: Centennial Rasparva LLC SIGNATURE OF DEVELOPER

F-20-010

THIS DEVELOPMENT IS APPROVED FOR EROSION AND SEDIMENT

CONTROL BY HOWARD SOIL CONSERVATION DISTRICT.

N 573,700 WATER ZONE: ____ WATER TEST GRADIENT: _____ WATER TEST PRESSURE,: TYPE OF BUILDING: NUMBER OF LOTS: . NO. OF WATER HOUSE CONNECTIONS: NO. OF SEWER HOUSE CONNECTIONS: SEWER SHED: _ TREATMENT PLANT: DESIGN MANUAL WAIVER NOTE
BY LETTER DATED JULY 17, 2020, MR. THOMAS
BUTLER, DEPUTY DIRECTOR, DPW, CONDITIONALLY APPROVED DMV2-20-019; ALLOWING THE ESTABLISHMENT OF A 20'
PRIVATE SEWER & WATER HOUSE CONNECTION EASEMENT FOR
THE BENEFIT OF PARCEL 6; SUBJECT TO THE FOLLOWING: A MINIMUM CLEARANCE OF TEN FEET IS MAINTAINED BETWEEN WHC AND SHC TO LOT 2 WITHIN THE EASEMENT.
A TEN-FOOT PRIVATE STORM DRAIN EASEMENT IS
DESIGNATED ON LOT 13 OF CENTENNIAL RESERVE AND SHOWN ON W&S PLANS.

630

907'

216 psi

RESIDENTIAL: SINGLE FAMILY DETACHED

LITTLE PATUXENT

LITTLE PATUXENT WATER RECLAMATION PLANT

SAVAGE, MARYLAND

18 (1 OPEN SPACE)

N 577,700

CONTRACT NO. 24-5088-D

ADC MAP: 26 BLOCKS: E3, E4, F3 &

LOCATION MAP

COLONIAL.

CENTURY

- EX. 6"5 & 6"W; CONT. NO. 24-3017-D

HOWARD COUNTY

CONTROL STATION

#0023

HOWARD COUNTY

CONTROL STATION

#30AB

CENTENNIAL RESERVE

LOTS 1 THRU 17 & OPEN SPACE LOT 18

CONTRACT NO. 24-5086-D


SEWER & WATER MAIN EXTENSIONS

HOWARD COUNTY, MARYLAND

EX. 12"W; CONT. -NO. 163-W

SEWER & WATER MAIN EX' HOWARD COUNTY, MARY

		PROP.	WHC
		PROP.	5HC
		PROP.	FIRE HYDRANT
	•	PROP.	VALVE
	OWNERS		
TENSIONS YLAND	PARCEL 04 LENNIS HAMRICK 4409 CENTENNIAL LA ELLICOTT CITY, MD 21 PARCEL 05 ROBERT & HELEN SPE 5710 SAN GABRIEL D PENSACOLA, FL 325 PARCEL 174 CHARLES & SHIRLEY H 10202 MAXINE STRE ELLICOTT CITY, MD 21	EDDEN ORIVE 604 HARDY EET	DEVELOPER CENTENNIAL RESERVE, LLC 7017 MEANDERING STREAM WAY FULTON, MD 20759
and the second			

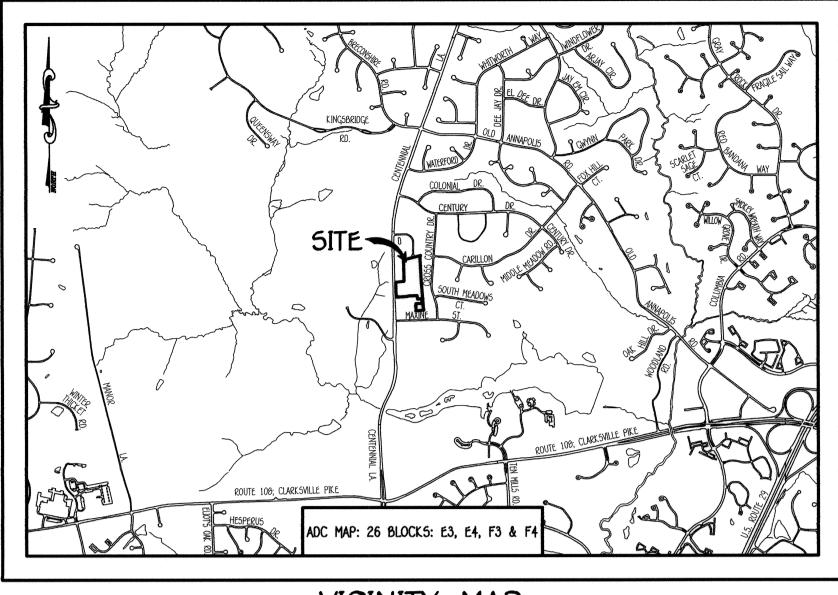

1. APPROXIMATE LOCATIONS OF EXISTING MAINS ARE SHOWN. THE CONTRACTOR SHALL TAKE ALL NECESSARY PRECAUTIONS TO PROTECT EXISTING MAINS AND SERVICES AND MAINTAIN UNINTERRUPTED SERVICE. ANY DAMAGE INCURRED SHALL BE REPAIRED IMMEDIATELY TO THE SATISFACTION OF THE ENGINEER AT THE CONTRACTOR'S EXPENSE. 2. TOPOGRAPHIC FIELD SURVEYS WERE PERFORMED ON OR ABOUT SEPTEMBER, 2018 BY FISHER, COLLINS & CARTER, INC.

. HORIZONTAL AND VERTICAL SURVEY CONTROLS: THE COORDINATES SHOWN ON THE DRAWINGS ARE BASED ON MARYLAND STATE REFERENCE SYSTEM NAD '83/91' AS PROJECTED BY HOWARD COUNTY GEODETIC CONTROL STATIONS NO. 0023 & NO. 30AB. ILL VERTICAL CONTROLS ARE BASED ON NAVD '80. VERTICAL CONTROLS PROVIDED ON THE DRAWINGS.

ALL PIPE ELEVATIONS SHOWN ARE INVERT ELEVATIONS UNLESS OTHERWISE NOTED ON THE PLANS. 5. CLEAR ALL UTILITIES BY A MINIMUM OF 12 INCHES. CLEAR ALL POLES BY 5'-0" MINIMUM OR TUNNEL AS REQUIRED UNLESS OTHERWISE NOTED. THE OWNER HAS CONTACTED THE UTILITY COMPANIES AND HAS MADE ARRANGEMENTS FOR BRACING OF POLES AS SHOWN ON THE DRAWINGS. IN THE EVENT THE CONTRACTOR'S WORK REQUIRES BRACING OF ADDITIONAL POLES, ANY COST INCURRED BY THE OWNER FOR THE BRACING OF THE ADDITIONAL POLES OR DAMAGES SHALL BE DEDUCTED FROM MONIES OWED THE CONTRACTOR. THE CONTRACTOR SHALL COORDINATE WITH THE UTILITY COMPANIES TO SCHEDULE THE BRACING OF

6. FOR DETAILS NOT SHOWN ON THE DRAWINGS, AND FOR MATERIALS AND CONSTRUCTION METHODS, USE HOWARD COUNTY DESIGN MANUAL, VOLUME IV, STANDARD SPECIFICATIONS AND DETAILS FOR CONSTRUCTION (LATEST EDITION). THE CONTRACTOR SHALL

HAVE A COPY OF VOLUME IV ON THE JOB SITE. 7. WHERE TEST PITS HAVE BEEN MADE ON EXISTING UTILITIES, THEY ARE NOTED BY THE SYMBOL. • AT THE LOCATIONS OF THE TEST PITS. A NOTE OR NOTES CONTAINING THE RESULTS OF THE TEST PIT OR PITS IS INCLUDED ON THE DRAWINGS. EXISTING UTILITIES IN THE VICINITY OF THE PROPOSED WORK FOR WHICH TEST PITS HAVE NOT BEEN DUG SHALL BE LOCATED BY THE CONTRACTOR TWO WEEKS IN ADVANCE OF CONSTRUCTION OPERATIONS AT HIS OWN EXPENSE.

8. THE CONTRACTOR SHALL NOTIFY THE FOLLOWING UTILITY COMPANIES OR AGENCIES AT LEAST FIVE WORKING DAYS BEFORE STARTING WORK SHOWN ON THESE PLANS:

. 410-637-8713 . 410-605-0123 . 410-313-4900

9 TREES AND SHRUBS ARE TO BE PROTECTED FROM DAMAGE TO THE MAXIMUM EXTENT. TREES AND SHRUBS LOCATED WITHIN THE CONSTRUCTION STRIP ARE NOT TO BE REMOVED OR DAMAGED BY THE CONTRACTOR.

10. CONTRACTOR SHALL REMOVE TREES, STUMPS AND ROOTS ALONG THE LINE OF EXCAVATION. PAYMENT FOR SUCH REMOVAL SHALL BE INCLUDED IN THE UNIT PRICE BID FOR THE CONSTRUCTION OF THE MAIN.

11. THE CONTRACTOR SHALL NOTIFY THE BUREAU OF HIGHWAYS, HOWARD COUNTY, AT (410)-313-7450 AT LEAST FIVE WORKING DAYS BEFORE OPEN CUTTING OR BORING/JACKING OF ANY COUNTY ROAD FOR LAYING WATER/SEWER MAINS OR HOUSE CONNECTIONS. THE APPROVAL OF THESE DRAWINGS WILL CONSTITUTE COMPLIANCE WITH DPW REQUIREMENTS PER SECTION 18.114(a) OF THE HOWARD

PART 8: WATER MAIN GENERAL NOTES

1. ALL WATER MAINS SHALL BE AWWA C900 PVC; DR-18.

2. TOPS OF ALL WATER MAINS SHALL HAVE A MINIMUM OF 3'-6" OF COVER UNLESS OTHERWISE NOTED.

3. VALVES ADJACENT TO TEES SHALL BE STRAPPED TO TEES.

4. ALL FITTINGS SHALL BE BUTTESSED OR ANCHORED WITH CONCRETE IN ACCORDANCE WITH STANDARD DETAILS UNLESS OTHERWISE

PROVIDED FOR ON THE DRAWINGS.

5. FIRE HYDRANTS SHALL BE SET TO THE BURY LINE ELEVATIONS SHOWN ON THE DRAWINGS. ALL FIRE HYDRANTS SHALL BE INSTALLED IN ACCORDANCE WITH STANDARD DETAILS. THE SOIL AROUND THE FIRE HYDRANT SHALL BE COMPACTED IN ACCORDANCE WITH SECTION 1000 AND SECTION 1005 OF THE STANDARD SPECIFICATIONS.

THE CONTRACTOR SHALL NOT OPERATE ANY WATER MAIN VALVES ON THE EXISTING WATER SYSTEM. TRACER WIRE AND CONTINUITY TEST STATIONS SHALL BE INSTALLED ON ALL D.I.P. AND PVC WATER MAINS IN ACCORDANCE

WITH HOWARD COUNTY DESIGN MANUAL.

8. FOR PVC WATER MAINS, ALL RECORDS FOR THE QUALITY CONTROL AND QUALIFICATION TEST REQUIREMENTS NOTED IN

6. FOR PVC WATER MAINS, ALL RECORDS FOR THE QUALITY CONTROL AND QUALIFICATION TEST REQUIREMENTS NOTED IN SECTION 5.1 OF THE AWWA STANDARD C900 FOR PVC PRESSURE PIPE SHALL BE SUBMITTED WITH THE PIPE MATERIAL CERTIFICATIONS OR SHOP DRAWINGS PRIOR TO APPROVAL OF THE MATERIAL FOR USE. THE TEST RECORDS SHALL BE FOR THE PIPE TO BE INSTALLED UNDER THIS CONTRACT. ALL PVC PIPE SHALL CONTAIN MARKINGS TO ALLOW CROSS REFERENCING OF THE PIPE SUPPLIED TO THE TEST RECORDS RECEIVED.
9. UNLESS OTHERWISE NOTED ON THE PLANS OR IN THE SPECIFICATIONS, SEVENTEEN (17) POUND SACRIFICIAL ANODES SHALL BE INSTALLED ON ALL VALVES AND METALLIC FITTINGS USED WITH PVC WATER MAINS IN ACCORDANCE WITH VOLUME IV, STANDARD SPECIFICATIONS AND DETAILS FOR CONSTRUCTION. MAGNESIUM ANODES SHALL BE INSTALLED ON ALL VALVES AND DUCTILE IRON FITTINGS INCLUDING RESTRAINTS AND HARNESSES. ZINC ANODES SHALL BE INSTALLED ON ALL STAINLESS STEEL FITTINGS AND SADDLES USED WITH PVC MAINS. ALL "TEES" USED WITH PVC MAINS SHALL BE DUCTILE IRON.
10. PROPER ASSEMBLY OF GASKETED PVC PIPE JOINTS: THE MANUFACTURER'S INSERTION LINE OF GASKETED PVC PIPE JOINTS INDICATES THE MAXIMUM DEPTH OF INSERTION OF THE SPIGOT INTO THE BELL. AFTER ASSEMBLY OF THE JOINT, THE INSERTION LINE SHALL

THE MAXIMUM DEPTH OF INSERTION OF THE SPIGOT INTO THE BELL. AFTER ASSEMBLY OF THE JOINT, THE INSERTION LINE SHALL REMAIN VISIBLE. DUAL INSERTION LINES ON GASKETED PVC PIPE INDICATE THE MAXIMUM AND MINIMUM DEPTH OF INSERTION OF THE SPIGOT INTO THE BELL. THE CONTRACTOR SHALL NOT OVER INSERT OR OVER HOME THE SPIGOT INTO THE BELL OF PVC PIPE. 1. ALL CHANGES IN HORIZONTAL OR VERTICAL DIRECTION OF PVC WATER PIPE SHALL BE MADE WITH STANDARD BENDS, 5-DEGREE SWEEPS OR HIGH DEFLECTION (HD) COUPLINGS. NO BENDING OF THE PIPE OR DEFLECTING OF PVC PIPE JOINTS IS PERMITTED. WHERE HIGH DEFLECTION COUPLINGS OR 5-DEGREE SWEEPS ARE PERMITTED, THE CONTRACTOR SHALL PROVIDE ONE FULL PIPE LENGTH (20 FOOT LONG) ON EITHER SIDE OF THE HIGH DEFLECTION COUPLING OR 5-DEGREE SWEEP, TAKING CARE NOT TO USE COMPACTION

PVC HIGH DEFLECTION COUPLINGS SHALL BE LIMITED TO A TOTAL OF 3-DEGREES (1 1-DEGREE ON EITHER END OF THE COUPLING), SHALL BE RATED FOR A MINIMUM 200 PSI MEETING THE REQUIREMENTS OF AWWA C900, SHALL HAVE A MINIMUM LAY LENGTH OF 9-INCHES AND SHALL HAVE CENTER STOPS. PVC HIGH DEFLECTION COUPLINGS SHALL BE CERTAINTEED PVC HIGH DEFLECTION (HD)

FIVE DEGREE SWEEPS SHALL BE BELL BY SPIGOT, RATED FOR A MINIMUM 225 PSI, DR-10 MEETING THE REQUIREMENTS OF AWWA C900

AND SHALL BE MULTI FITTINGS (IPEX) BLUE BRUTE DR-10 OR EQUAL. 2. WHEN PVC HIGH DEFLECTION COUPLINGS OR PVC 5-DEGREE SWEEPS ARE USED TO FACILITATE CHANGES IN HORIZONTAL OR VERTICAL ALIGNMENTS OF AWWA C900 PVC PIPELINES, THE CONTRACTOR SHALL INSERT DEVICES FOR THE PREVENTION OF OVER-INSERTION OF THE PVC PIPE SPIGOTS OR PLAIN ENDS INTO THE PUSH ON BELL JOINT ON BOTH SIDES OF THE HIGH DEFLECTION COUPLINGS

AND 5-DEGREE SWEEPS. BELL STOPS SHALL BE PLACED AT THE PROPER INSERTION LINE FOR THE FITTING. THE BELL STOP SHALL BE MANUFACTURED OF DUCTILE IRON AND INCORPORATE AN EXPANSION RETENTION SPRING TO ALLOW FOR PIPE EXPANSION AND CONTRACTION. THE BELL STOPS SHALL BE SERIES 5000 MEGA-STOP, AS MANUFACTURED BY EBAA IRON, INC. OR APPROVED EQUAL.

13. TO ACCOMMODATE A SPRINKLER SYSTEM, ALL RESIDENTIAL DWELLING UNITS SHALL HAVE A 1-1/2" WATER HOUSE CONNECTION WITH A 1" OUTSIDE METER SETTING; STD. DET. W-3.20.

PART C: <u>SEWER MAIN GENERAL NOTES</u> 1. ALL SEWER MAINS SHALL BE D.I.P. OR P.V.C. UNLESS OTHERWISE NOTED.

STOP COUPLINGS OR EQUAL.

2. ALL MANHOLES SHALL BE 4'-0" INSIDE DIAMETER UNLESS OTHERWISE NOTED. 3. FORCE MAINS SHALL BE D.I.P. ONLY.

4. MANHOLES SHOWN WITH 12" AND 16" WALLS ARE FOR BRICK MANHOLES ONLY.
5. MANHOLES DESIGNATED W.T. IN PLAN AND PROFILE SHALL HAVE WATERTIGHT FRAME AND COVER, STANDARD DETAIL G5.52.
WHERE WATERTIGHT MANHOLE FRAMES AND COVERS ARE USED, SET TOP OF FRAME 1'-6" ABOVE FINISHED GRADE UNLESS

OTHERWISE NOTED ON THE DRAWINGS.

6. HOUSE(5) WITH THE SYMBOL "C.N.S." INDICATES THAT CELLAR CANNOT BE SERVED.

SCALE: 1" = 50'

CONTRACT NO. 24-5000-D 200' CENTENNIAL RESERVE LOTS 1 THRU 17 & OPEN SPACE LOT 18 SEWER & WATER MAIN EXTENSIONS HOWARD COUNTY, MARYLAND

DEPARTMENT OF PUBLIC WORKS


DEPARTMENT OF PLANNING AND ZONING HOWARD COUNTY, MARYLAND

8-6-2020 CHIEF. BUREAU OF UTILITIES

CHIEF, DEVELOPMENT ENGINEERING DIVISION

DULY LICENSED PROFESSIONAL ENGINEER UNDER THE LAWS OF THE STATE OF MARYLAND. LICENSE NO. 12043 EXPIRATION DATE IS 7/16/22. FISHER, COLLINS & CARTER, INC. VIL ENGINEERING CONSULTANTS & LAND SURVEYOR SQUARE OFFICE PARK - 10272 BALTIMORE NATIONAL I ELLICOTT CITY, MARYLAND 21042

prepared or approved by Me, and that I am a

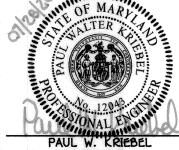

BEL	DATE : JULY, 2020	ВУ	NO.	REVISION	DATE
	CHECKED BY : P.W.K.				
E BELL	DRAWN BY : T.C.R.				
A VI	P.W.K.				
#12043	DESIGNED BY :				

SEWER & WATER MAIN EXTENSIONS TITLE SHEET 600' SCALE MAP NO. ____30____ BLOCK NO. ___1__

F.C.C. WORK ORDER NO. ____30501

FILE NAME : SEWER & WATER MAIN EXTENSION PLAN

N 577,700

RUGBY

N 573,700

PLAN REFERENCE NUMBERS:

F-20-010(PUBLIC ROAD & RECORD PLAT)

LEGEND

EX. WATER MAIN

EX. SEWER MAIN

EX. SEWER MANHOLE

EX. FIRE HYDRANT

PROP. WATER MAIN

PROP. SEWER MAIN

PROP. SEWER MANHOLE

EX. VALVE

DESCRIPTION

EX. SEWER, WATER & UTILITY EASEMENT

PROP. SEWER, WATER & UTILITY EASEMENT

ECP-19-022

5P-19-001

CLAIBORNE

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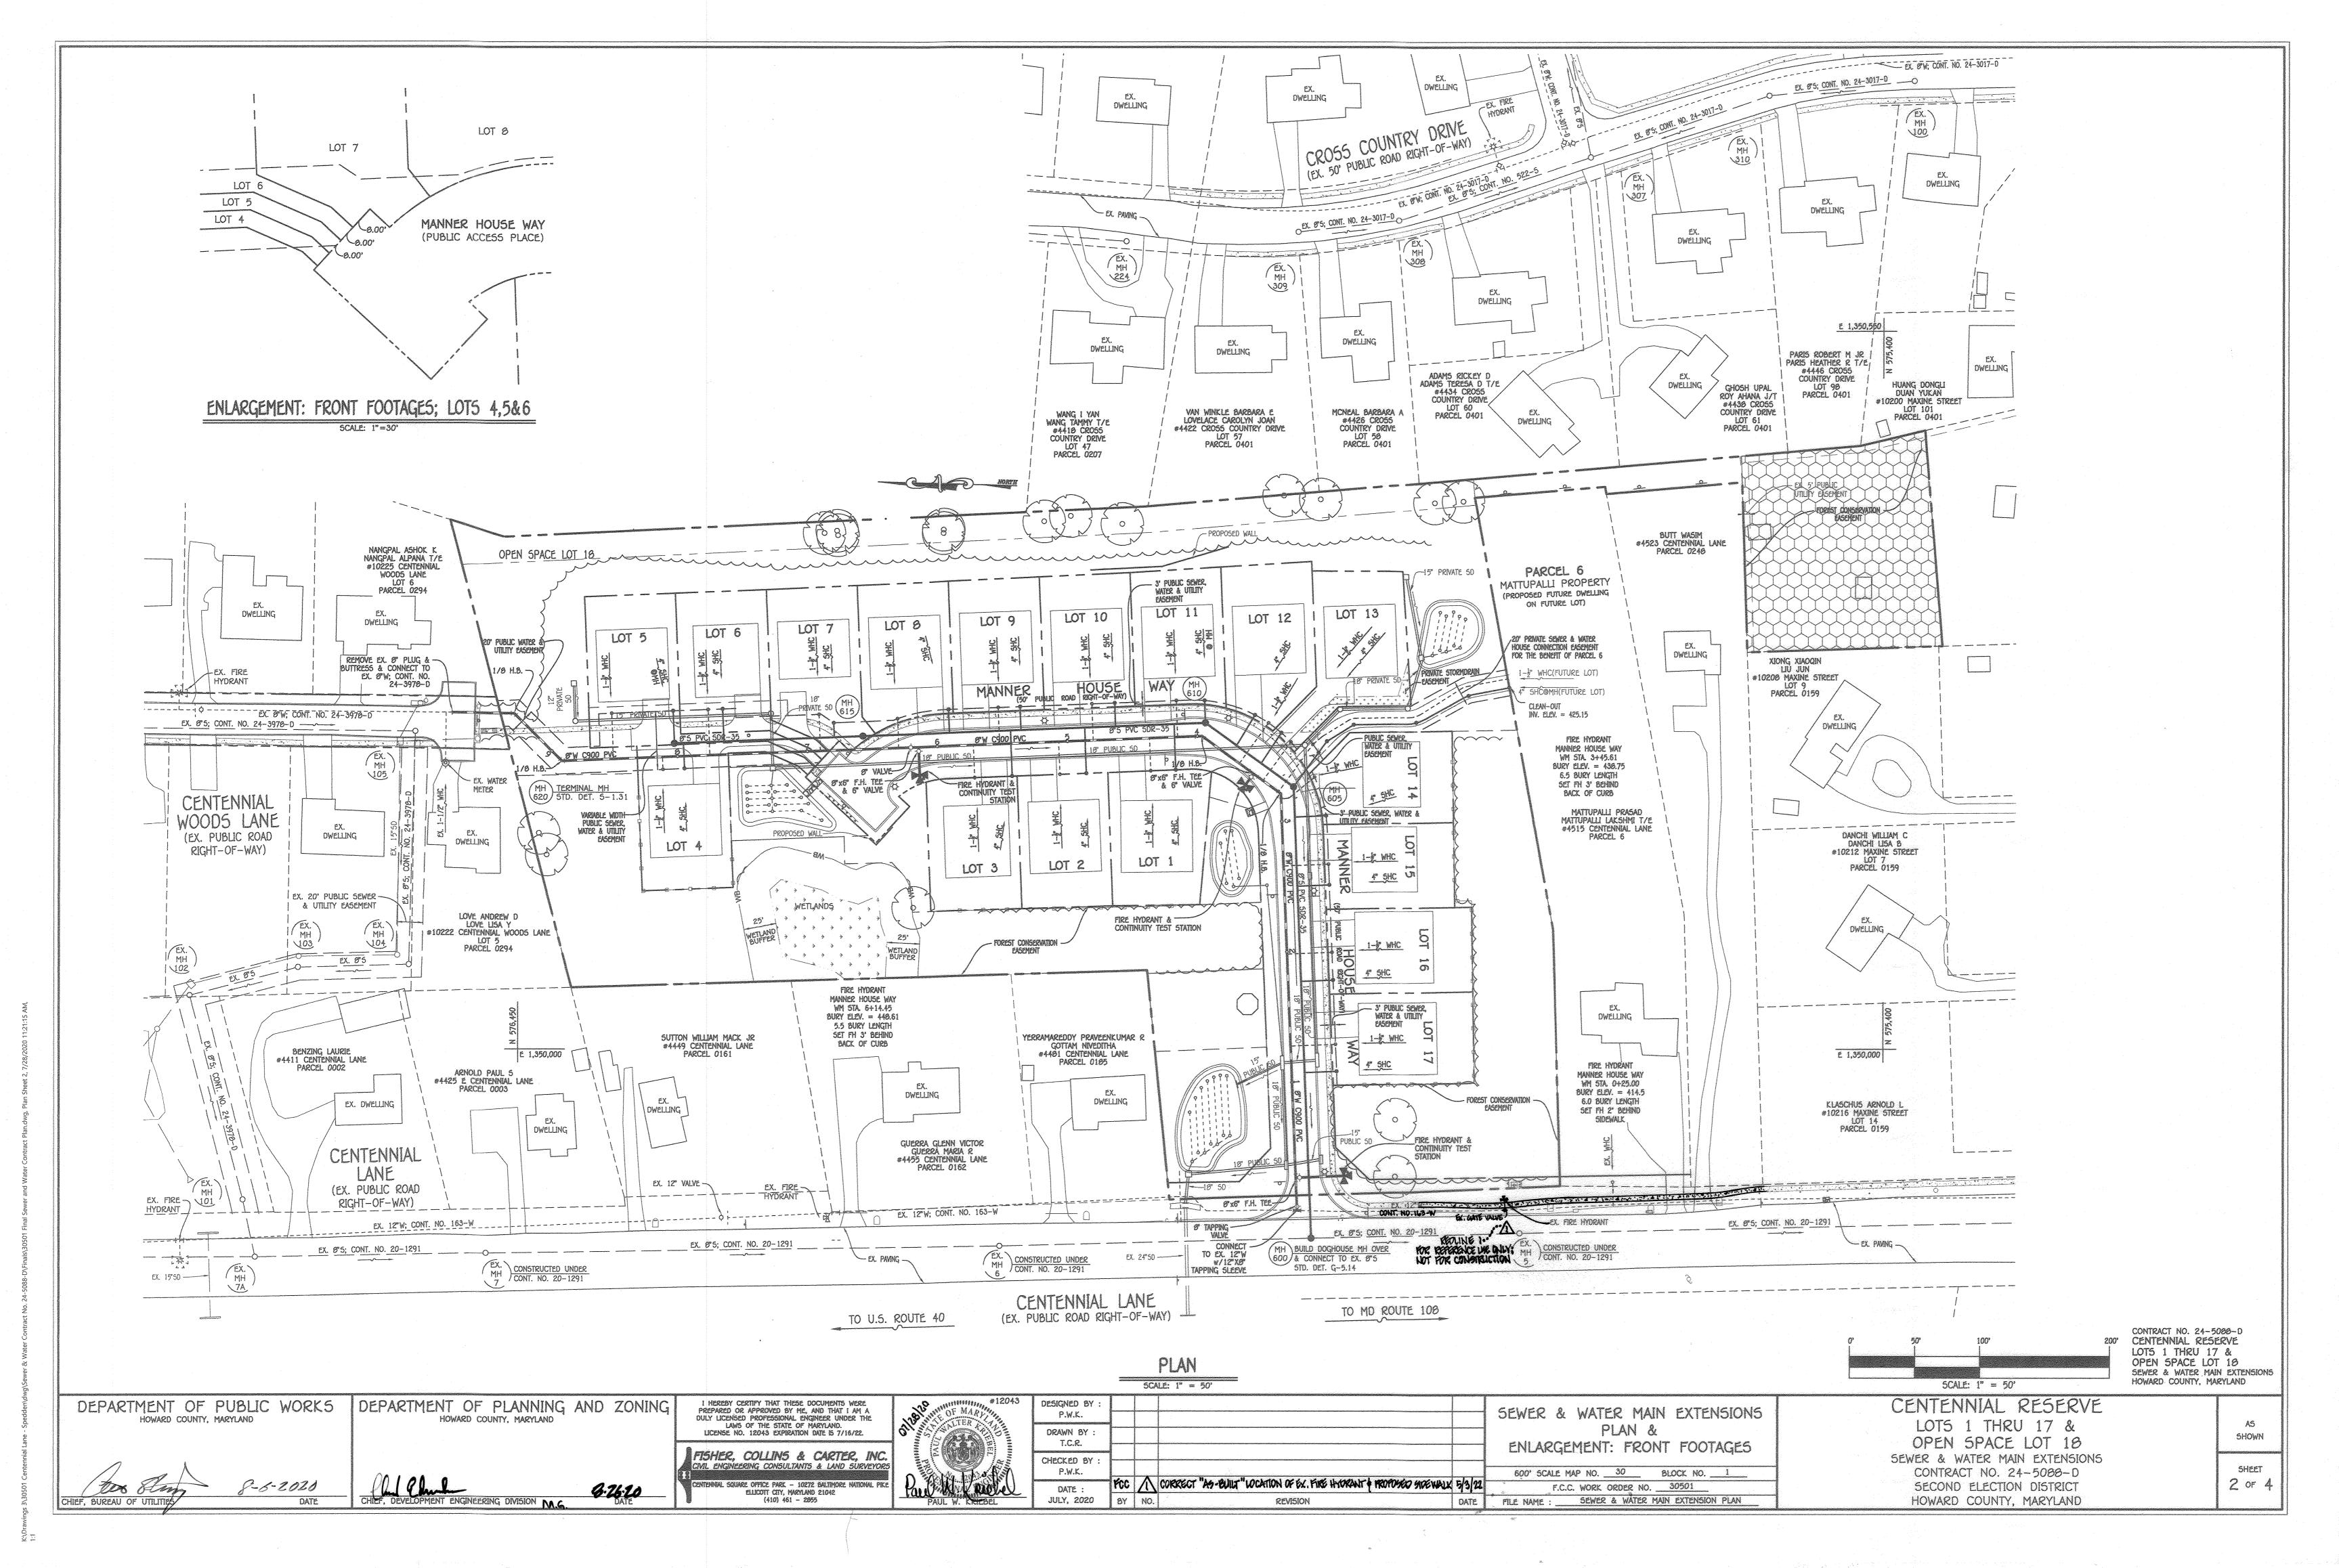
CENTENNIAL RESERVE LOTS 1 THRU 17 & OPEN SPACE LOT 18 SEWER & WATER MAIN EXTENSIONS CONTRACT NO. 24-5088-D


SECOND ELECTION DISTRICT


HOWARD COUNTY, MARYLAND

A5 **SHOWN**

SHEET OF 4



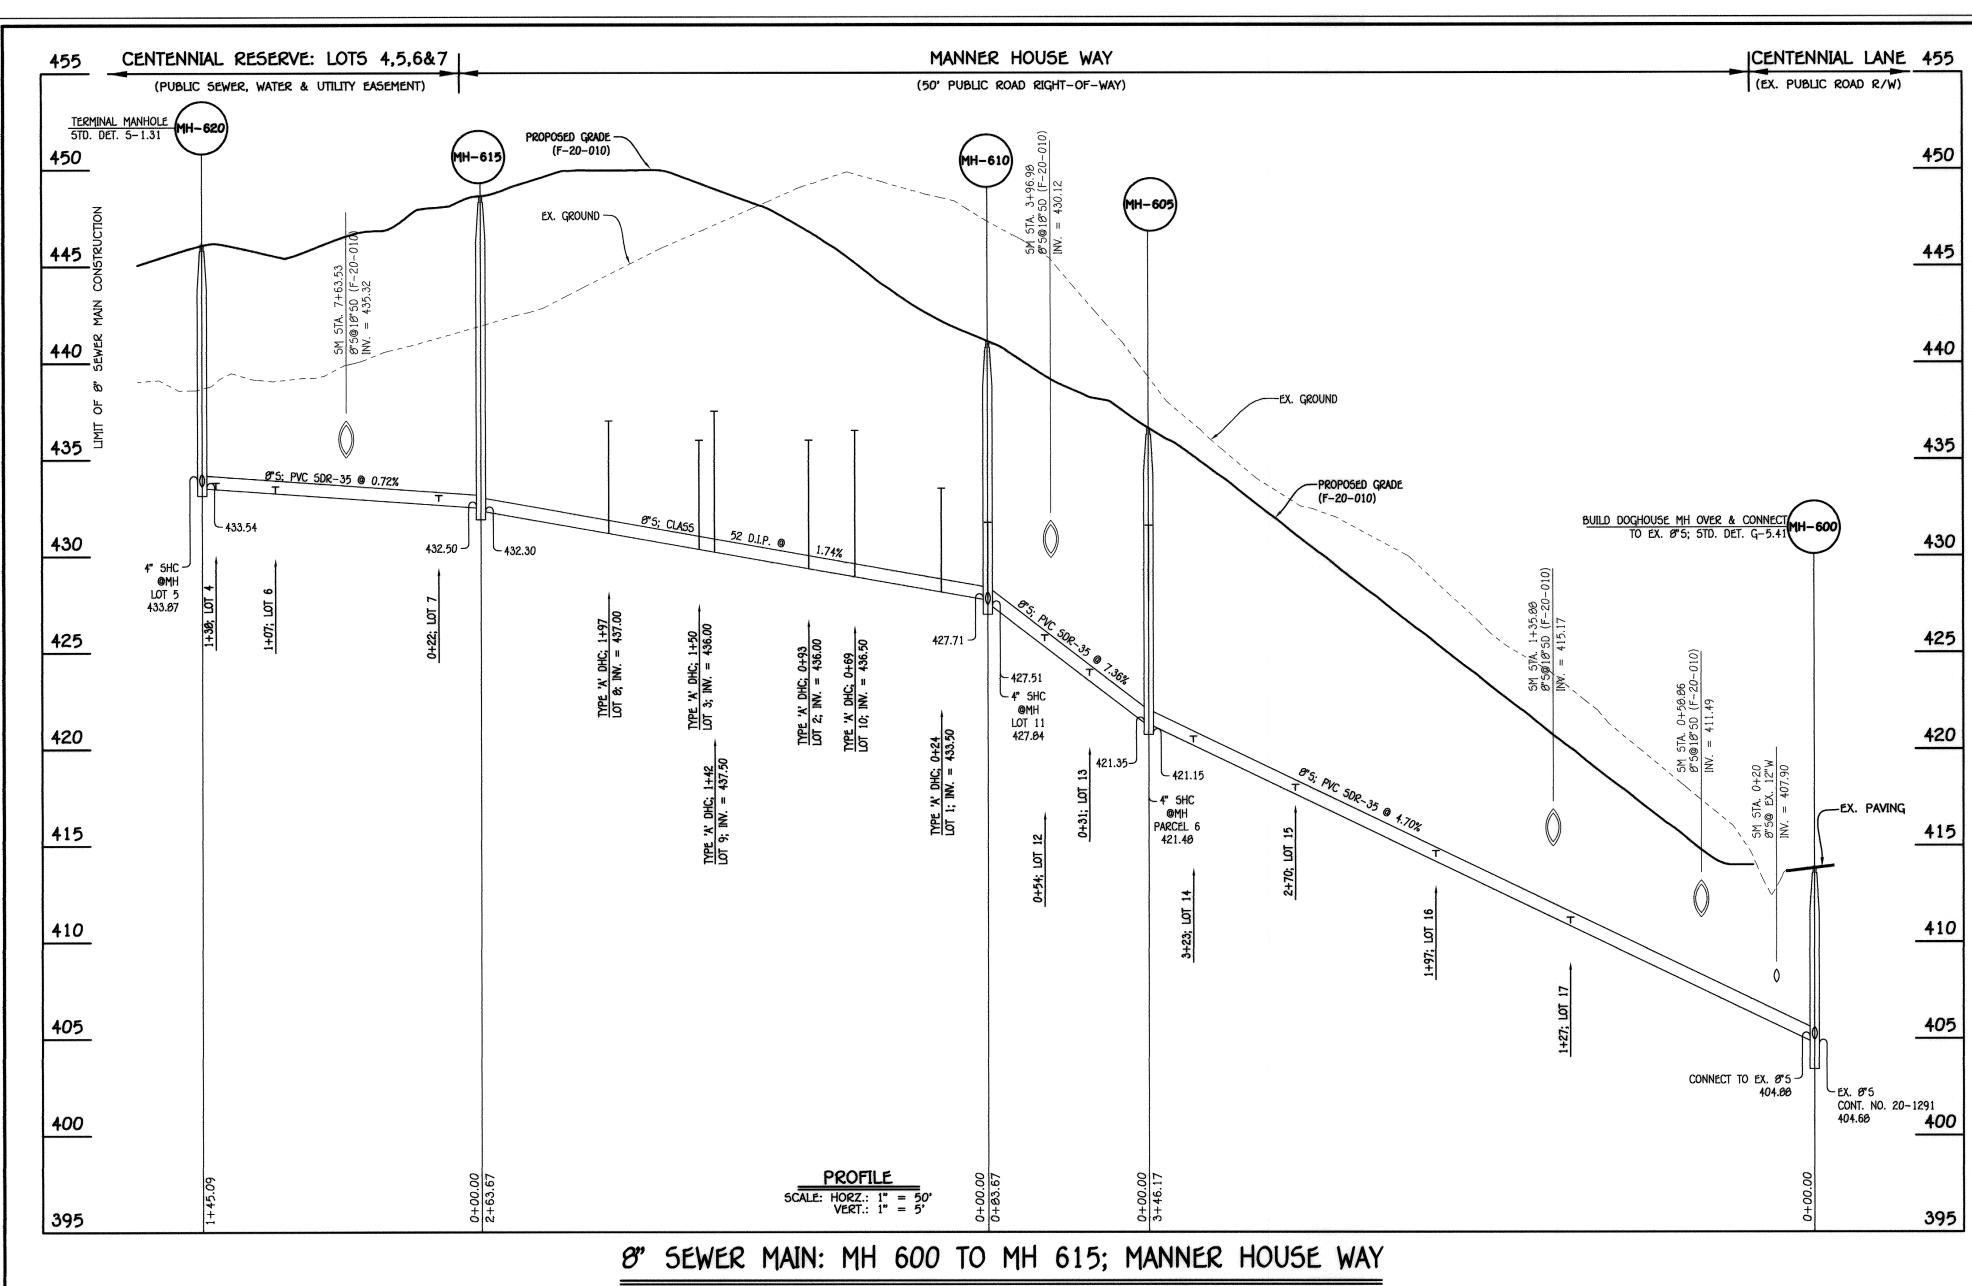

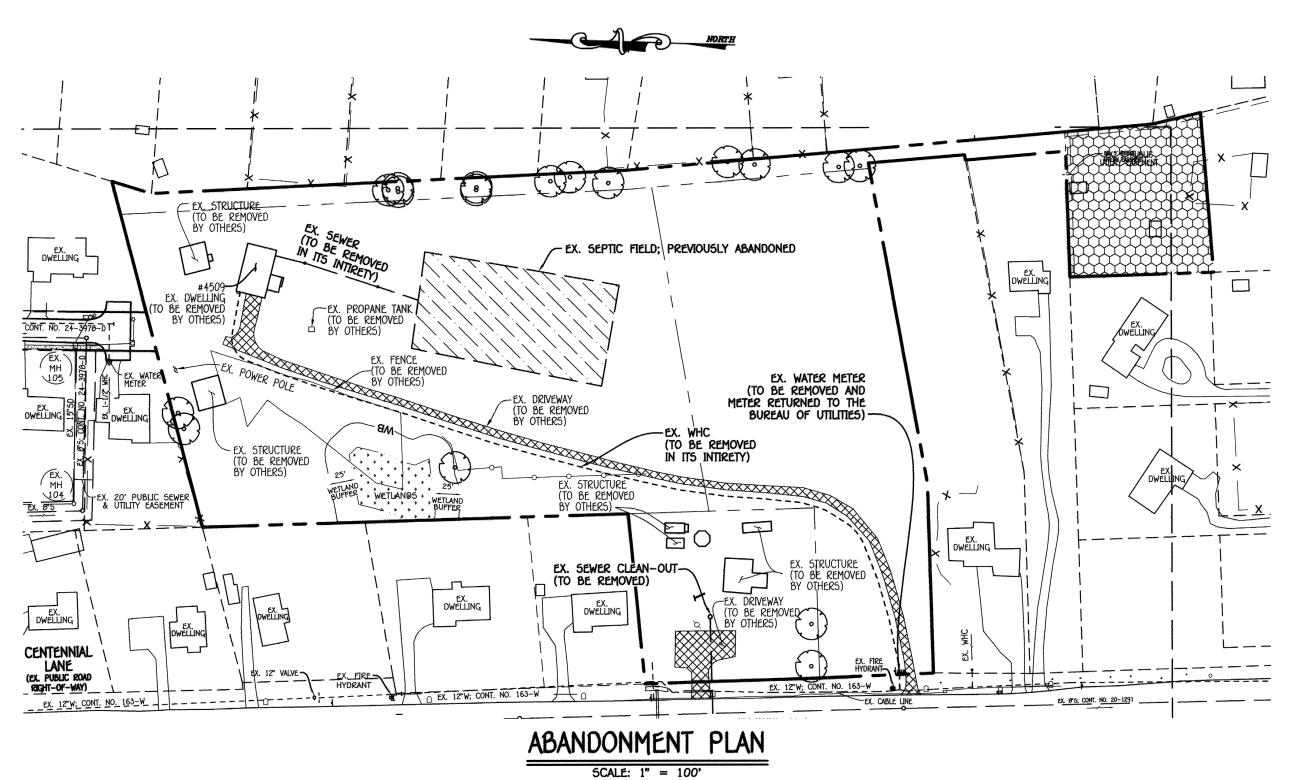


MANHOLE TABULATION CHART							
NO.	NORTHING	EASTING	RIM ELEVATION				
600	575039.37	1349055.11	413.89				
605	575053.33	1350201.00	436.59				
610	575921.21	1350249.93	442.39				
615	576184.68	1350239.72	447.95				
620	576329.66	1350234.09	445.15				

											-
OTE:	SET	MH	rim5	FLU5H	W/PROPOSED	OR	EXISTING	GRADE,	A5	APPLICABLE	

STATION	LOT	ELEVATION AT MAIN	ELEVATION AT R/W	M.C.E.	B.E.	F.F.
		MH 600	TO MH 605			
1+27 RT.	17 @1.00%	411.02	411.25	415.05	415.10	424.90
1+97 RT.	16	414.31	414.77	419.67	420.45	430.25
2+70 RT.	15	417.74	418.20	423.20	426.00	435.80
3+23 RT.	14	420.23	420.71	425.91	428.72	438.52
@MH 605	PARCEL 6 (1.00%)	423.23	423.55	429.35	429.40	439.20
		MH 605	5 TO MH 610			
0+31 RT.	13	423.80	424.36	429.36	433.67	443.47
0+54 RT.	12	425.49	426.05	431.05	433.69	443.69
@M H 610	11	427.84	428.18	433.10	437.41	447.21
		MH 610	TO MH 615			
0+24 LT.	1(DHC)	433.50	434.20	439.20	439.38	449.18
0+69 RT.	10(DHC)	436.50	436.06	441.76	442.36	452.16
0+93 LT.	2(DHC)	436.00	436.70	441.60	442.97	452.77
1+42 LT.	9(DHC)	437.50	437.06	442.76	444.47	454.27
1+50 LT.	3(DHC)	436.00	436.70	442.00	443.79	453.59
1+97 RT.	Ø(DHC)	437.00	437.36	442.46	444.26	454.06
	Alexander	MH 615	TO MH 620			
0+22 RT.	7	432.64	433.03	430.23	441.27	451.07
1+07 RT.	6	433.26	433.64	430.44	440.07	449.87
1+36 LT.	4	433.66	434.06	430.06	439.22	449.02
@MH 615 RT.	5(@1.00%)	433.87	433.97	436.82	438.62	448.42

	SEWER HOUSE CONNE	ECTION AS-BUILT LOCAT	ION TABLE
LOT NUMBER	ADDRESS	LOCATION DIMENSION 1	LOCATION DIMENSION 2
1			
2			
3			
4			
5			
6			
7			
8			
9			
10			
11			
12			
13			
14			
15			
16			
17			
PARCEL 6			

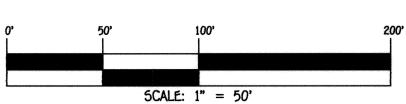

CONTRACT NO. 24-5000-D 200' CENTENNIAL RESERVE LOTS 1 THRU 17 & OPEN SPACE LOT 18 SEWER & WATER MAIN EXTENSIONS HOWARD COUNTY, MARYLAND

DEPARTMENT OF PUBLIC WORKS

CHIEF, BUREAU OF UTILITIES

8-6-2020

DEPARTMENT OF PLANNING AND ZONING HOWARD COUNTY, MARYLAND HOWARD COUNTY, MARYLAND

8-26-20 DATE CHIEF, DEVELOPMENT ENGINEERING DIVISION

I HEREBY CERTIFY THAT THESE DOCUMENTS WERE PREPARED OR APPROVED BY ME, AND THAT I AM A DULY LICENSED PROFESSIONAL ENGINEER UNDER THE LAWS OF THE STATE OF MARYLAND.


LICENSE NO. 12043 EXPIRATION DATE IS 7/16/22. FISHER, COLLINS & CARTER, INC. nial square office park — 10272 baltimore national pii ellicott city, maryland 21042 (410) 461 — 2055

OF MAR OF MAR ALTER AVA AVA AVA AVA AVA AVA AVA AV
OF MARY
ALTER
PRO 1204 BEL 2000 ONAL EL SONAL EL SONA
1204 C. T.
THE WALL BUTTER
PAUL W. KRIEBEL

The second secon					
DESIGNED BY : P.W.K.					SEWER MAIN EXTENSION
DRAWN BY : T.C.R.					PROFILE, CHARTS, "AS-BUILT" TABLE & ABANDONMENT PLAN
CHECKED BY: P.W.K.					600' SCALE MAP NO. 30 BLOCK NO. 1
DATE :					F.C.C. WORK ORDER NO. 30501
JULY, 2020	BY	NO.	REVISION	DATE	FILE NAME :SEWER & WATER MAIN EXTENSION PLAN

CENTENNIAL RESERVE LOTS 1 THRU 17 & OPEN SPACE LOT 18 SEWER & WATER MAIN EXTENSIONS CONTRACT NO. 24-5088-D SECOND ELECTION DISTRICT HOWARD COUNTY, MARYLAND

SHOWN SHEET 3 of 4

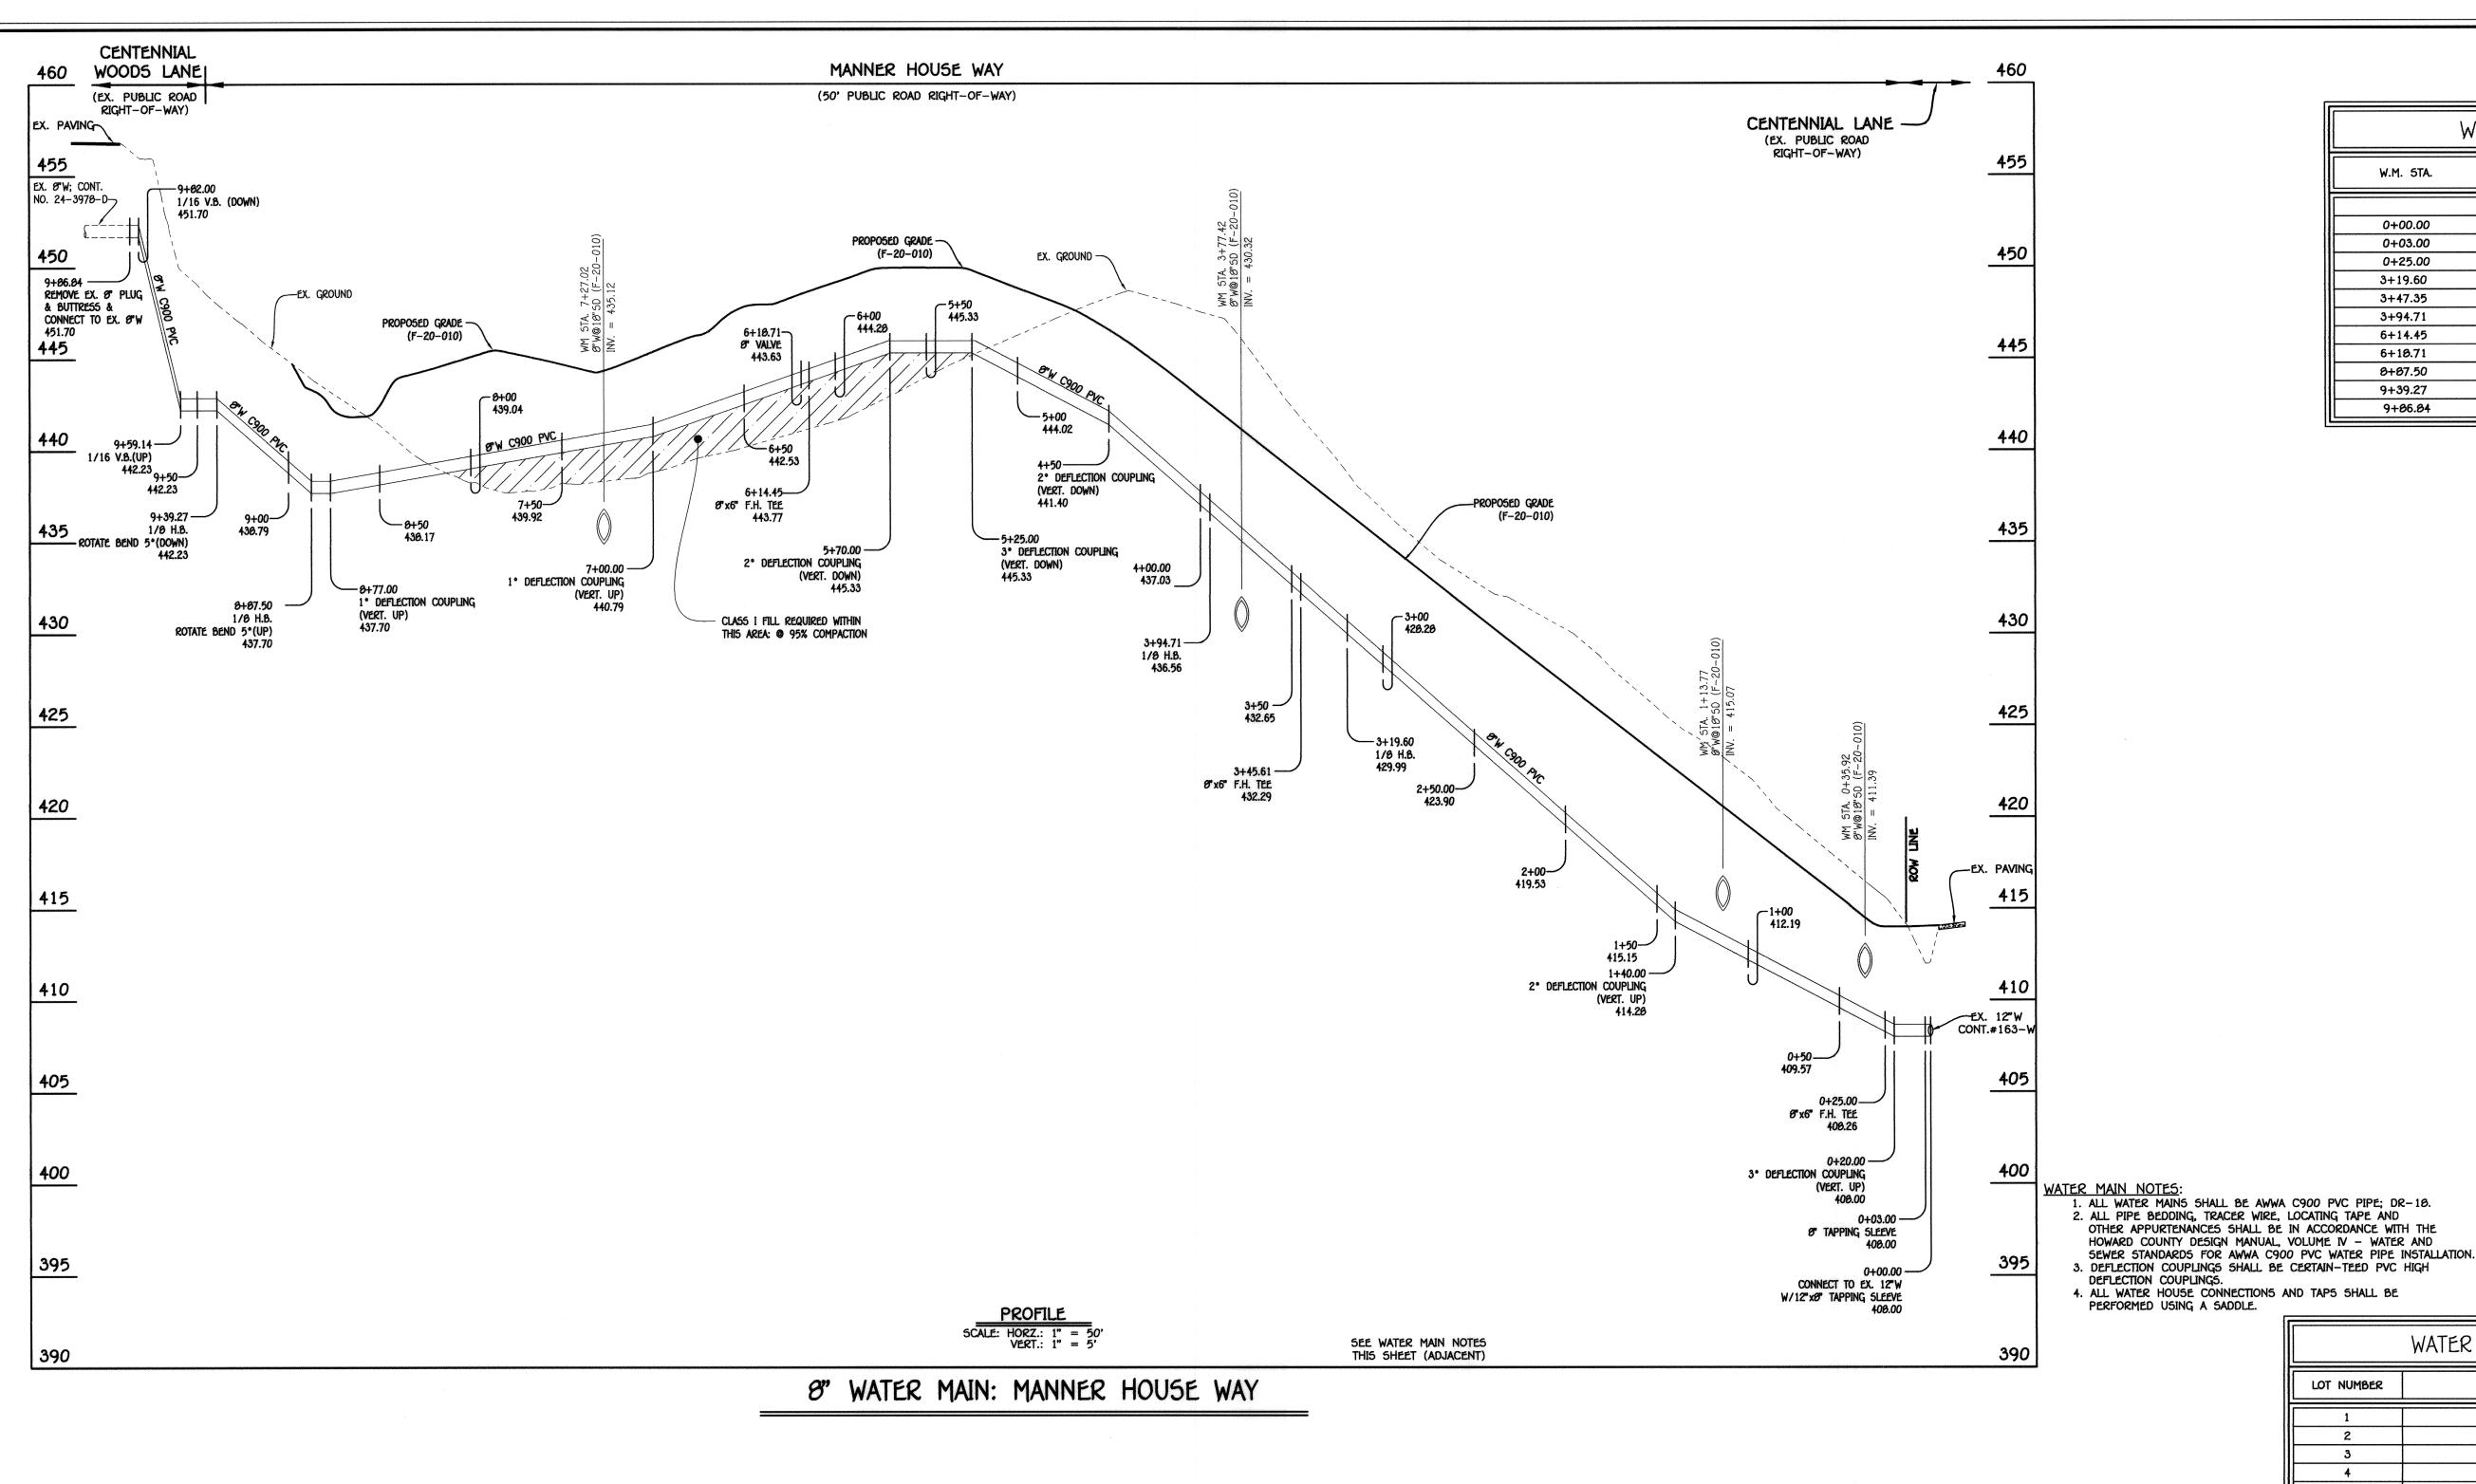

WATER MAIN TABULATION CHART EASTING NORTHING W.M. STA. APPURTENANCE 8" WATER MAIN: MANNER HOUSE WAY 12"X8" TAPPING SLEEVE 575850.24 1349876.41 0+00.00 1349879.40 575050.36 0+03.00 8" TAPPING SLEEVE 0+25.00 8" x6" F.H. TEE 575851.24 1349901.44 575063.13 1350195.75 3+19.60 1/8 H.B. 3+47.35 8" x6" F.H. TEE 575884.19 1350211.01 3+94.71 1/8 H.B. 575923.95 1350239.82 576141.78 1350231.37 6+14.45 8" x6" F.H. TEE 576147.78 1350231.14 8" VALVE 6+18.71 576416.36 1350220.73 1/8 H.B. 8+87.50 1/8 H.B. 576453.15 1350257.16 9+39.27 CONNECT TO EX. 8"W 9+86.84 576500.71 1350257.68

WATER MAIN NOTES:

1. ALL WATER MAINS SHALL BE AWWA C900 PVC PIPE; DR-10. 2. ALL PIPE BEDDING, TRACER WIRE, LOCATING TAPE AND OTHER APPURTENANCES SHALL BE IN ACCORDANCE WITH THE HOWARD COUNTY DESIGN MANUAL, VOLUME IV - WATER AND

3. DEFLECTION COUPLINGS SHALL BE CERTAIN-TEED PVC HIGH DEFLECTION COUPLINGS. 4. ALL WATER HOUSE CONNECTIONS AND TAPS SHALL BE PERFORMED USING A SADDLE.

> WATER HOUSE CONNECTION AS-BUILT LOCATION TABLE LOT NUMBER ADDRESS LOCATION DIMENSION 1 LOCATION DIMENSION 2 5 8 10 12 13 14 15 16 17 PARCEL 6

> > 5CALE: 1" = 50'

CENTENNIAL RESERVE

CONTRACT NO. 24-5000-D
200' CENTENNIAL RESERVE
LOTS 1 THRU 17 &
OPEN SPACE LOT 10
SEWER & WATER MAIN EXTENSIONS HOWARD COUNTY, MARYLAND

DEPARTMENT OF PUBLIC WORKS HOWARD COUNTY, MARYLAND

ton 82mm 8-6-2020

CHIEF, BUREAU OF UTILITIES

DEPARTMENT OF PLANNING AND ZONING HOWARD COUNTY, MARYLAND

5-26-20 DATE CHIEF, DEVELOPMENT ENGINEERING DIVISION

I HEREBY CERTIFY THAT THESE DOCUMENTS WERE PREPARED OR APPROVED BY ME, AND THAT I AM A DULY LICENSED PROFESSIONAL ENGINEER UNDER THE LAWS OF THE STATE OF MARYLAND.

LICENSE NO. 12043 EXPIRATION DATE IS 7/16/22. F15HER, COLLINS & CARTER, INC. ennial square office park — 10272 baltimore national p ELLICOTT CITY, MARYLAND 21042 (410) 461 - 2055

	THE OF MARY	DESIGNED BY : P.W.K.
	S TALLER BB	DRAWN BY : T.C.R.
25	PRO 12043	CHECKED BY : P.W.K.
(É	PAUL W. KRIEBEL	DATE : JULY, 2020

		BY NO	. REVISION	DATE
DA	TE:			
	ED BY : — W.K.			
	N BY : C.R.			
P.1	W.K.			1

WATER MAIN EXTENSION PROFILE, TABULATION CHART, NOTES & "AS-BUILT" TABLE

600' SCALE MAP NO. ___30____ BLOCK NO. ___1

F.C.C. WORK ORDER NO. ____30501

FILE NAME : SEWER & WATER MAIN EXTENSION PLAN

LOTS 1 THRU 17 & OPEN SPACE LOT 18 SEWER & WATER MAIN EXTENSIONS CONTRACT NO. 24-5088-D SECOND ELECTION DISTRICT HOWARD COUNTY, MARYLAND

SHOWN SHEET 4 of 4