



BENCH MARK ELEV. 378.38
 Roadside Flange bolt of Fire Hydrant
 200' West of Bellview Drive

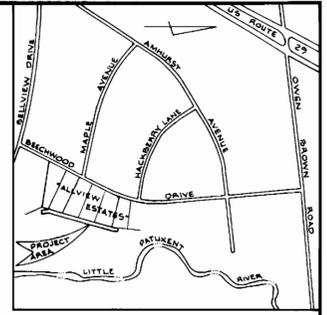


VICINITY MAP
 SCALE: 1" = 600'

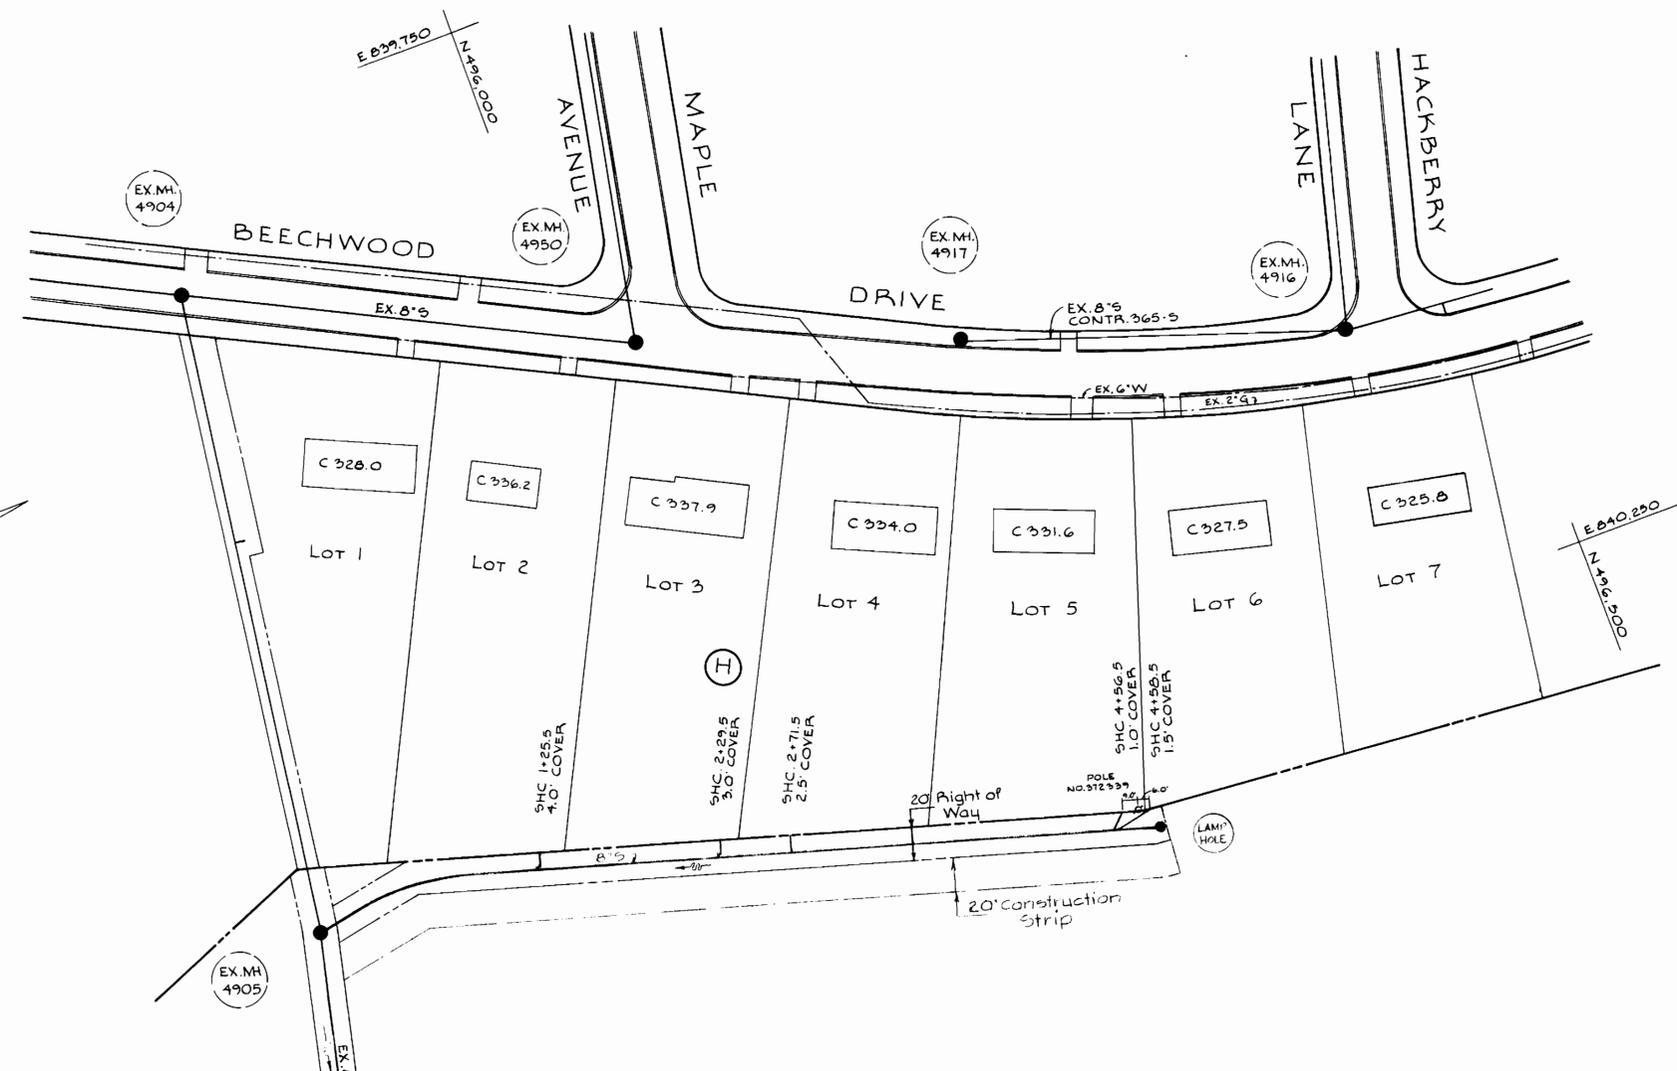

GENERAL NOTES

1. Approximate location of existing mains are shown. The Contractor shall take all necessary precautions to protect existing mains and services and maintain uninterrupted supply. Any damage incurred shall be repaired immediately.
2. All pipe elevations are invert elevations.
3. The Contractor shall locate existing utilities a minimum of two weeks in advance of construction operations in vicinity of utilities.
4. For all standard details see standards bound in specifications.
5. All horizontal and vertical controls are based on Maryland State Datum.
6. Clear all utilities by a minimum of 6', clear all poles by a minimum of 2'-0" or tunnel as required.
7. All sewer mains shall be A.C.P. Class 2400, unless otherwise noted.

VILLAGE OF OWEN BROWN
 SECTION 5 AREA 2
 SHEET 6 OF 6
 30/73

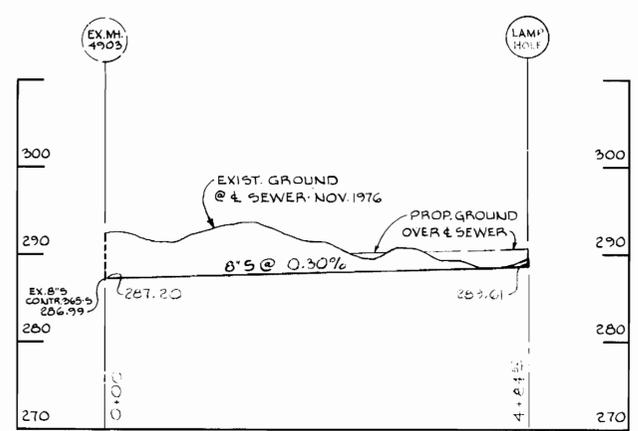

PROFILE
 HOR: 1" = 100'
 VERT: 1" = 10'

BUREAU OF ENGINEERING
 INSPECTION AND SURVEY DIVISION

DEPARTMENT OF PUBLIC WORKS
 HOWARD COUNTY, MARYLAND
 10-24-77 W. O. Gilbert 10-25-77
 DIRECTOR OF PUBLIC WORKS DATE CHIEF-BUREAU OF ENGINEERING DATE

CONTRACT NO. 782 M0-S

PLAN AND PROFILES
 OF SEWER MAIN EXTENSION

ELECTION DISTRICT
 GUILFORD NO. 6

DRAWING NO. 1 OF 1 SCALE AS SHOWN