GENERAL NOTES

- SUBJECT PROPERTY ZONED R-20 PER THE 10/06/2013 COMPREHENSIVE ZONING PLAN. PROPERTY ADDRESS: 8030 OLD MONTGOMERY ROAD, ELLICOTT CITY, MARYLAND 21043
- TOTAL AREA OF PROPERTY: 3.13 AC.±
- 4. PUBLIC WATER AND PUBLIC SEWER WILL BE USED WITHIN THIS SITE. REFERENCE: LIBER 17538, FOLIO 429


IMMEDIATELY AT THE CONTRACTOR'S EXPENSE.


10. NO FLOODPLAINS, WETLANDS, STREAMS OR BUFFERS ARE PRESENT ON SITE.

- PREVIOUS HOWARD COUNTY FILE NUMBERS: WP-21-008, CONTR. 189-W, CONTR. 547-S THE BOUNDARY SHOWN HEREON IS BASED ON A BOUNDARY SURVEY PREPARED BY SEG LAND
- SURVEYING, LLC IN MARCH OF 2022. 8. THE EXISTING TOPOGRAPHY SHOWN WITHIN THE DEVELOPED AREA IS BASED ON A FIELD RUN
- TOPOGRAPHIC SURVEY PREPARED BY SEG LAND SURVEYING, LLC IN MARCH OF 2022. THE SOILS SHOWN HAVE BEEN TAKEN FROM THE US DEPARTMENT OF AGRICULTURE, NATURAL RESOURCE CONSERVATION SERVICE, WEB SOIL SURVEY WEBSITE. HOWARD COUNTY SOILS GRID
- 11. EXISTING UTILITIES ARE LOCATED BY THE USE OF ANY OR ALL OF THE FOLLOWING: ROAD CONSTRUCTION PLANS, FIELD SURVEYS, PUBLIC WATER AND SEWER PLANS AND OTHER AVAILABLE RECORD DRAWINGS. APPROXIMATE LOCATION OF THE EXISTING UTILITIES ARE SHOWN FOR THE CONTRACTORS INFORMATION. CONTRACTOR SHALL LOCATE EXISTING UTILITIES WELL IN ADVANCE OF CONSTRUCTION ACTIVITIES AND TAKE ALL NECESSARY PRECAUTIONS TO PROTECT THE EXISTING UTILITIES AND TO MAINTAIN UNINTERRUPTED
- PRELIMINARY GEOTECHNICAL INFORMATION HAS BEEN TAKEN FROM THE US DEPARTMENT OF AGRICULTURE, NATURAL RESOURCE CONSERVATION SERVICE, WEB SOIL SURVEY WEBSITE AND FIELD INVESTIGATIONS. IF FUTURE INVESTIGATIONS SHOW UNSATISFACTORY SOIL CONDITIONS FOR ANY OF THE STORMWATER MANAGEMENT TREATMENTS SHOWN, EITHER UNDERDRAINS WILL BE PROVIDED OR A DIFFERENT PRACTICE WILL BE SUBSTITUTED.
- 13. THE COORDINATES SHOWN HEREON ARE BASED UPON THE HOWARD COUNTY GEODETIC CONTROL, WHICH IS BASED ON THE MARYLAND STATE PLANE COORDINATE SYSTEM. HOWARD COUNTY MONUMENTS NUMBERS 37R2 AND 37B4 WERE USED FOR THIS PROJECT.
- 14. NO GRADING, REMOVAL OF VEGETATIVE COVER OR TREES, PAVING AND NEW STRUCTURES SHALL BE PERMITTED WITHIN THE LIMITS OF WETLANDS, STREAMS, OR THEIR REQUIRED BUFFERS, FLOODPLAIN AND FOREST CONSERVATION EASEMENT AREAS, UNLESS WAIVERS HAVE BEEN APPROVED OR ACTIVITIES HAVE BEEN DETERMINED ESSENTIAL BY THE DEPARTMENT OF
- 15. A FOREST CONSERVATION PLAN WILL BE PROVIDED IN ACCORDANCE WITH SECTION 16.1200 OF THE HOWARD COUNTY SUBDIVISION AND LAND DEVELOPMENT REGULATIONS. 16. A SIMPLIFIED FOREST STAND DELINEATION HAS BEEN APPROVED UNDER ECP-19-071. FOREST
- CONSERVATION WILL BE ADDRESSED AT THE NEXT PLANNING STAGE. LANDSCAPING WILL BE PROVIDED AT THE FINAL PLAN AND SITE DEVELOPMENT PLAN STAGE OF THIS PROJECT. ALL LANDSCAPING WITHIN 40 FEET OF ANY POWER LINES SHALL BE DECIDUOUS, SMALL TO MEDIUM
- 17. APPROVAL OF THIS SKETCH PLAN DOES NOT CONSTITUTE APPROVAL OF SUBSEQUENT AND ASSOCIATED SUBDIVISION PLANS, SITE DEVELOPMENT PLANS OR RED-LINE REVISIONS. REVIEW DEVELOPMENT REGULATIONS AND THE HOWARD COUNTY ZONING REGULATIONS SHALL OCCUR AT THE SUBDIVISION OR SITE DEVELOPMENT PLAN STAGES OR RED-LINE REVISION PROCESS. THE APPLICANT AND CONSULTANT SHOULD EXPECT ADDITIONAL AND MORE DETAILED REVIEW COMMENTS (INCLUDING COMMENTS THAT MAY ALTER THE OVERALL SITE DESIGN) AS THIS PROJECT PROGRESSES THROUGH THE PLAN REVIEW PROCESS.
- 18. OPEN SPACE OBLIGATIONS WILL BE ADDRESSED BY A FEE-IN-LIEU. 19. THE STORMWATER MANAGEMENT SYSTEM SHOWN ON THESE PLANS IS AN APPROXIMATION OF THE SIZE, SHAPE AND LOCATION. IT IS UNDERSTOOD THAT THIS SYSTEM HAS NOT BEEN DESIGNED AND THE ACTUAL DESIGN MAY CHANGE, ALTERING THE NUMBER OF UNITS
- 20. ON JUNE 30, 2022 A REQUEST TO WAIVE SECTION 16.1215(A)(3) OF THE HOWARD COUNTY SUBDIVISION AND LAND DEVELOPMENT REGULATIONS, TO ALLOW FOR THE REMOVAL OF ONE (1) SPECIMEN TREE, PRELIMINARY PLAN, WAS APPROVED BY THE DIRECTOR OF PLANNING AND ZONING SUBJECT TO THE FOLLOWING CONDITIONS (REFER TO ALTERNATIVE COMPLIANCE PETITION WP-21-008): • SUBMISSION OF A FINAL PLAN AND SITE DEVELOPMENT PLAN SHALL BE SUBMITTED TO THE DEPARTMENT OF PLANNING AND ZONING TO BE REVIEWED AND APPROVED BY THE SRC IN COMPLIANCE WITH THE MILESTONES ESTABLISHED BY THE ADEQUATE PUBLIC FACILITIES
- THE REMOVAL OF SPECIMEN TREE #1 IS PERMITTED AND REQUIRES THE ONSITE PLANTING OF 2 NATIVE TREES WITH A DBH OF 3". THE TREES SHALL BE SHOWN ON THE FINAL SUBDIVISION LANDSCAPE PLAN SHEET AND MUST BE BONDED AS PART OF THE LANDSCAPE
- 23. ALL LANDSCAPE REQUIREMENTS TO BE IN ACCORDANCE WITH THE HOWARD COUNTY LANDSCAPE MANUAL AND WILL BE ADDRESSED AT THE NEXT PLAN STAGE.
- 24. ALL REQUIREMENTS PER THE HOWARD COUNTY COMPLETE STREETS AND BRIDGE DESIGN MANUAL, VOLUME III, WILL BE ADDRESSED AT THE NEXT PLAN STAGE.
- 25. THE PROJECT IS IN CONFORMANCE WITH THE LATEST HOWARD COUNTY STANDARDS UNLESS WAIVERS HAVE BEEN APPROVED.

SKETCH PLAN CALLA PROPERTY

LOTS 1-6 HOWARD COUNTY, MARYLAND

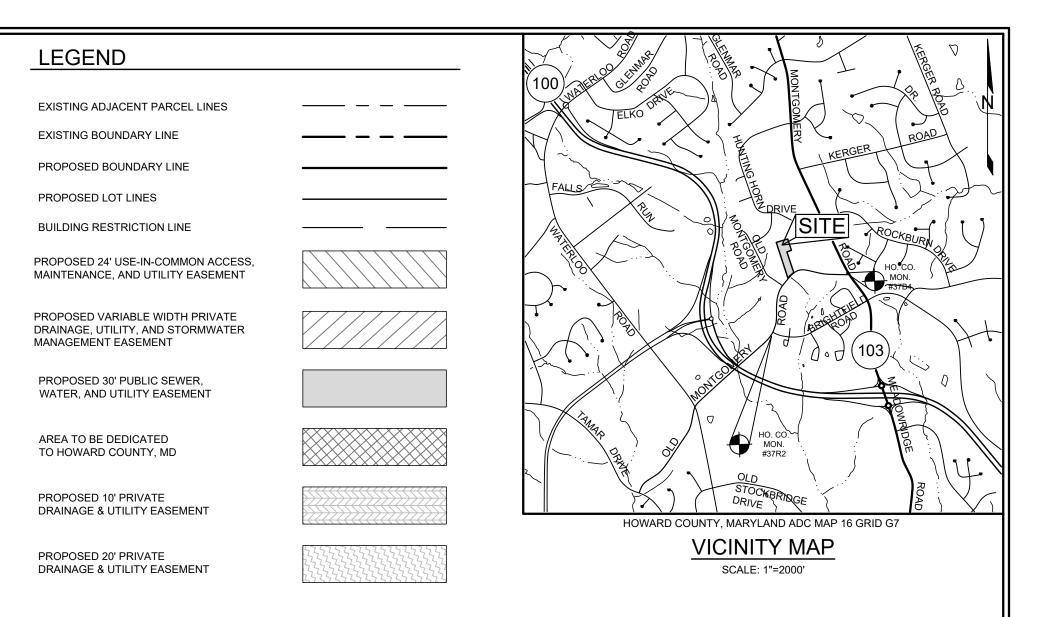

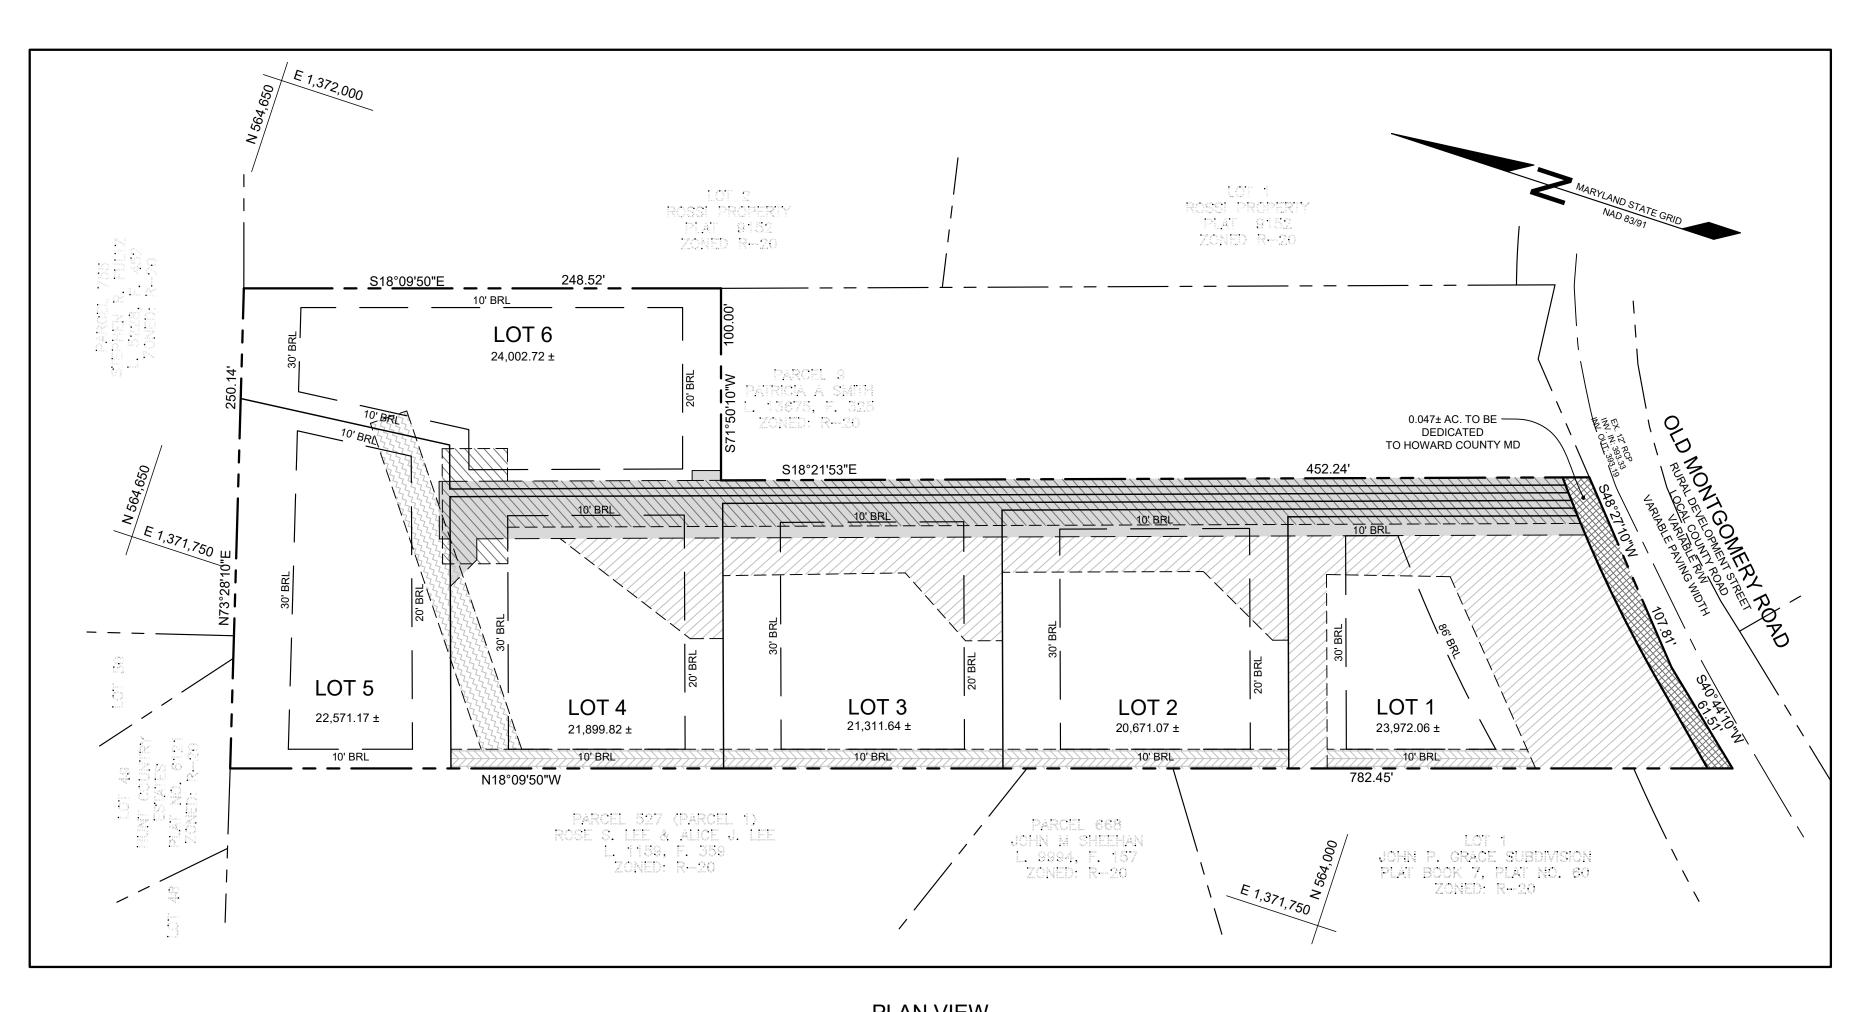

SITE ANALYSIS DATA SHEET				
ENVIRONMENTAL AREA	SIZE OR USE			
TOTAL PROJECT AREA	3.13 AC ±			
ROW TO BE DEDICATED	0.044 AC ±			
PROPOSED PROJECT AREA	3.13 AC ±			
ZONING DESIGNATION	R-20			
NUMBER OF UNITS ALLOWED	6			
NUMBER OF UNITS PROPOSED	6			
LIMIT OF DISTURBANCE	2.7478 AC ±			
GREEN OPEN AREA (LAWN)	1.8723 AC ±			
PROPOSED IMPERVIOUS AREA	0.7422 AC ±			
PROPOSED SITE USES	RESIDENTIAL			
REQUIRED PARKING SPACES	2.5 SPACES/LOT			
PROVIDED PARKING SPACES	2.5 SPACES/LOT			
WETLANDS	0 AC ±			
WETLAND BUFFERS	0 AC ±			
FLOODPLAINS	0 AC ±			
FLOODPLAIN BUFFERS	0 AC ±			
EXISTING FOREST	0.0 AC ±			
FOREST TO BE CLEARED	0.0 AC ±			
FOREST TO REMAIN	0.0 AC ±			
SLOPES GREATER THAN 15%*	0.0 AC ±			
SLOPES GREATER THAN 25%*	0.0 AC ±			
HIGHLY ERODIBLE SOILS	0.0 AC ± (1)			

1) SOIL INFORMATION HAS BEEN TAKEN FROM THE UNITED STATES DEPARTMENT OF AGRICULTURE; NATURAL RESOURCES CONSERVATION SERVICE; WEB SOIL SURVEY.

2) HIGHLY ERODIBLE SOILS ARE THOSE SOILS WITH A SLOPE GREATER THAN 15 PERCENT OR THOSE SOILS WITH A SOIL ERODIBILITY FACTOR 'K' GREATER THAN 0.35 AND WITH A SLOPE GREATER THAN 5 PERCENT.

BENCHMARKS						
NUMBER	NORTHING	EASTING	ELEVATION	DESCRIPTION		
37R2	562,611.42	1,371,554.55	399.70	CORNER OF OLD MONTGOMERY ROAD & BRIGHTFIELD ROAD		
37B4	563,928.56	1,373,109.17	477.73	CORNER OF OLD MONTGOMERY ROAD & MONTGOMERY ROAD (RT 103)		

SHEET INDEX				
SHEET NO.	DESCRIPTION			
1	COVER SHEET			
2	EXISTING CONDITIONS AND DEMOLITION PLAN			
3	STOPPING SIGHT DISTANCE ANALYSIS			
4	GRADING, SEDIMENT & EROSION CONTROL PLAN			
5	STORMWATER MANAGEMENT DRAINAGE AREA MAP			
6	STORMWATER MANAGEMENT 100 YEAR ROUTING DRAINAGE AREA MAP			
7	STORMWATER MANAGEMENT, PLAN, NOTES, AND DETAILS			

MINIMUM LOT SIZE CHART				
LOT NUMBER	MINIMUM LOT SIZE (SF)	PIPESTEM AREA (SF)	GROSS AREA (SF)	
1	23,972.06 ±	-	23,972.06 ±	
2	20,070.89 ±	600.18 ±	20,671.07 ±	
3	20,122.25 ±	1,189.39 ±	21,311.64 ±	
4	20,134.63 ±	1,765.19 ±	21,899.82 ±	
5	20,241.46 ±	2.327.30 ±	22,568.76 ±	
6	22,197.39 ±	1,756.42 ±	23,953.81 ±	

PREVIOUS PROJECT FILE NUMBERS					
FILE NUMBER	DESCRIPTION				
ECP-19-071	ENVIRONMENTAL CONCEPT PLAN				
14-5130-D	PRELIMINARY WATER & SEWER PLAN				

TENTATIVELY, APPROVED: DEPARTMENT OF PLANNING AND ZONING,

PLANNING DIRECTOR


STORMWATER MANAGEMENT NOTES & DESIGN NARRATIVE

- BELOW IS A LIST TO DESCRIBE THE STORMWATER MANAGEMENT REQUIREMENTS AND ACHIEVEMENTS FOR THE SITE PER THE 2000 MARYLAND STORMWATER DESIGN MANUAL, VOLUMES I AND II, AS AMENDED BY THE STORMWATER MANAGEMENT ACT OF 2007. ENVIRONMENTALLY SENSITIVE AREAS HAVE BEEN AVOIDED WHERE POSSIBLE. NO STEEP SLOPES, NO FLOODPLAIN, NO STREAMS NO WETLANDS OR THEIR BUFFERS EXIST ON-SITE. NATURAL RESOURCES ONSITE CONSIST OF 3 SPECIMEN TREES; ST 1, 2, AND 3. ST 1 WILL NEED TO BE REMOVED DUE TO ITS PROXIMITY TO THE PROPOSED HOUSE ON LOT 2: THIS COULD NOT BE AVOIDED. ST 2
- AND ST 3 WILL BE RETAINED AND PROTECTED DURING DEVELOPMENT BY THE INSTALLATION OF A TREE. PROTECTION FENCING. TO THE GREATEST EXTENT PRACTICABLE THE NATURAL FLOW PATTERNS OF THE SITE HAVE BEEN MAINTAINED BY EXISTING 12" CULVERT TO BE REPLACED. TO MAINTAIN THE SAME VERTICAL CLEARANCE, 2 - 12" CULVERTS WILL BE INSTALLED. COMPUTATIONS SHOWS THAT THE 10 YEAR STORM WILL PASS THROUGH THE CULVERTS WITHOUT OVERTOPPING PROPOSED DRIVE. RUNOFF DISCHARGES INTO THE ROADSIDE CHANNEL IN FRONT OF THE PROPERTY, THEN FLOWS EAST APPROXIMATELY
- 3. IMPERVIOUS AREAS HAVE BEEN REDUCED BY POSITIONING THE BUILDING AS CLOSE TO THE USE-IN-COMMON DRIVEWAY AS THE 4. A STABILIZED CONSTRUCTION ENTRANCE, SILT FENCES AND SUPER SILT FENCES ARE USED AS SEDIMENT AND EROSION

300 FEET TO A 24" RCP CULVERT THAT CROSSES OLD MONTGOMERY ROAD.

5. THE STORMWATER MANAGEMENT OBLIGATIONS FOR THESE PARCELS WILL BE MET BY THE USE OF STORMBRIXX, AND MICRO-BIORETENTION FACILITIES (M-6).

	STORMWATER MANAGEMENT PRACTICES						
LOT	ADDRESS	MICRO- BIORETENTION M-6 (NUMBER)	DRYWELL M-5 (NUMBER)	ROOFTOP DISCONNECT N-1 (Y/N)	NON-ROOFTOP DISCONNECT N-2 (Y/N)		
1	OLD MONTGOMERY ROAD	1	3	N	N		
2	OLD MONTGOMERY ROAD	1	3	N	N		
3	OLD MONTGOMERY ROAD	1	3	N	N		
4	OLD MONTGOMERY ROAD	1	3	N	N		
5	OLD MONTGOMERY ROAD	0	4	N	N		
6	OLD MONTGOMERY ROAD	0	4	N	N		
N/A	USE IN COMMON DRIVE	0	0	N	N		

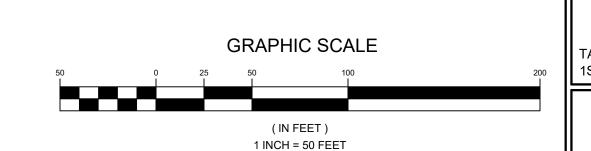

OWNER/DEVELOPER JIN PYO HONG & AUK JA HONG 8030 OLD MONTGOMERY ROAD ELLICOTT CITY, MARYLAND 21043

C/O JAMES JOO 443-900-4620

COVER SHEET CALLA PROPERTY 8030 OLD MONTGOMERY ROAD

ZONED R-20 TAX MAP 37 GRID 2 **1ST ELECTION DISTRICT**



¹ Engineering GROUP, LLC 16005 Frederick Road, 2nd Floor Woodbine, MD 21797 Phone: 443.325.5076 Fax: 410.696.2022


ROFESSIONAL CERTIFICATION: I HEREBY CERTIFY THAT THESE DOCUMENTS WERE PREPARED OR APPROVED BY ME . AND THAT I AM A DUI LICENSED PROFESSIONAL ENGINEER UNDER THE LAWS OF THE STATE OF MARYLAND, LICENSE NO. 32025, EXPIRATION DATE JUNE 20, 2023

DRAWN BY: ____ CHECKED BY: ____JB_ SCALE: AS SHOWN DATE: JUNE 30, 2022 PROJECT #: _____18-075_ SHEET#: __1__ of __7

HOWARD COUNTY, MARYLAND

PARCEL 8


7/5/2022

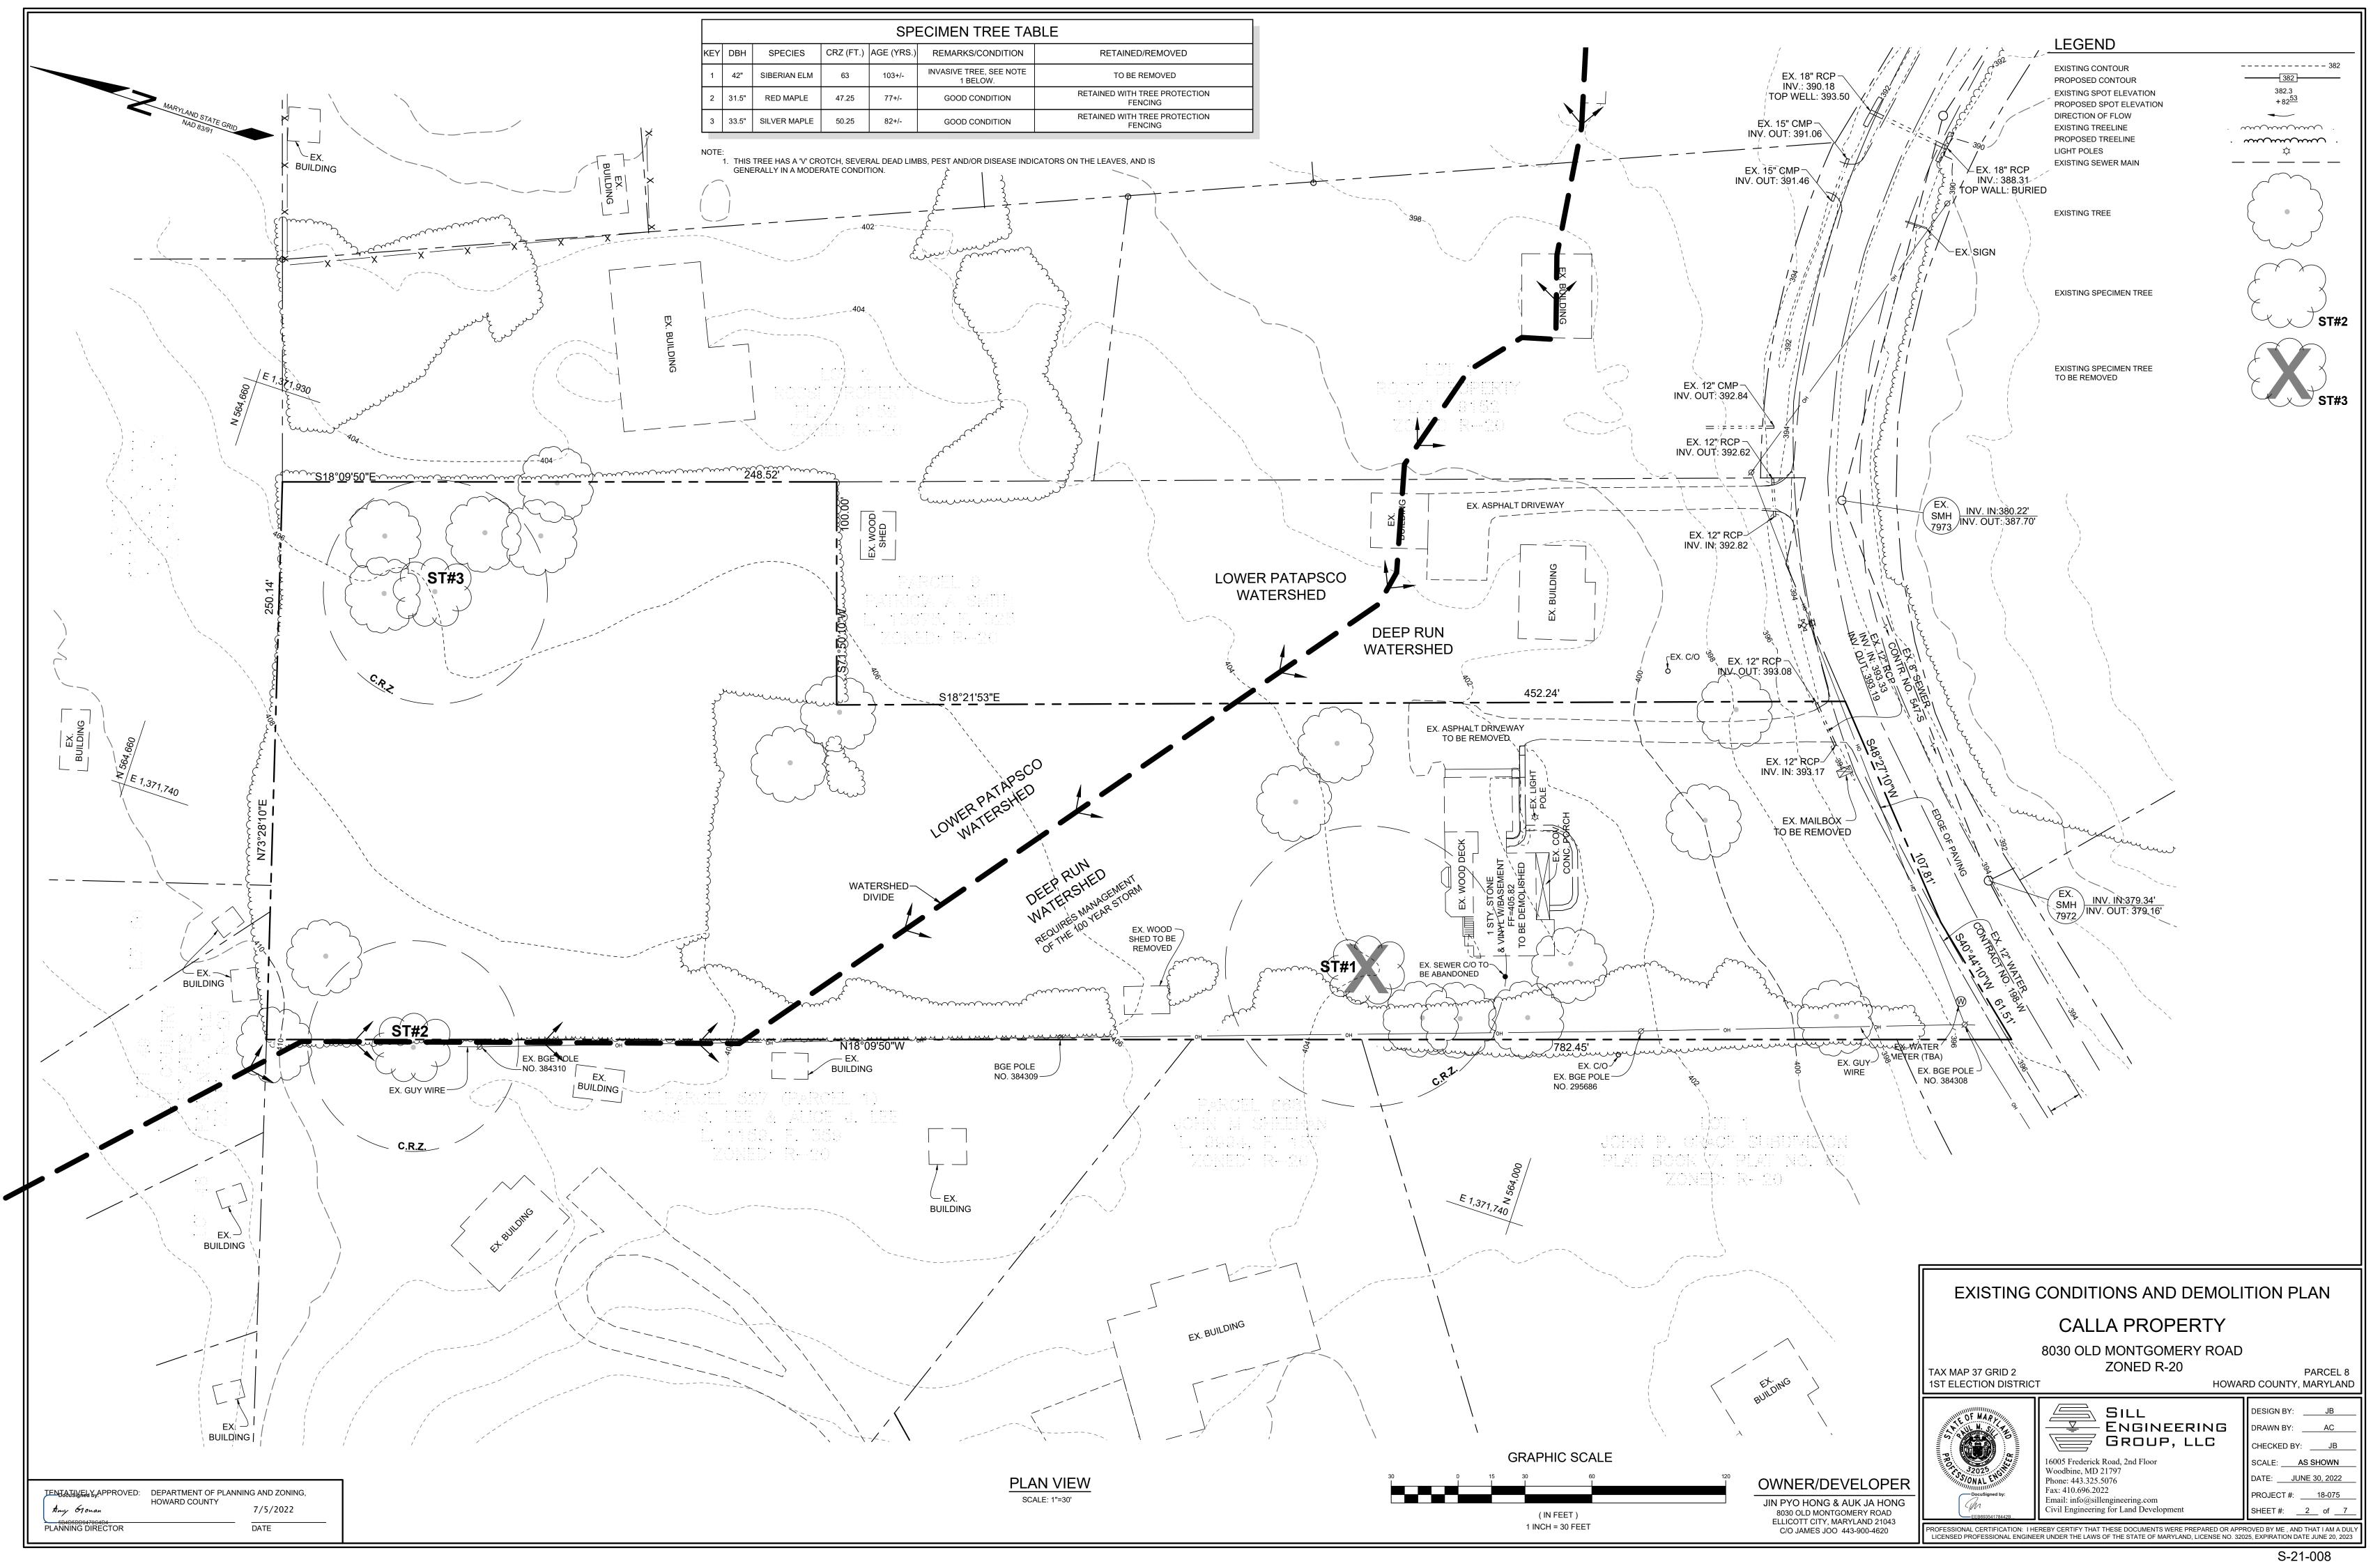


TENJAJJYELY, APPROVED: DEPARTMENT OF PLANNING AND ZONING,

PLANNING DIRECTOR

7/5/2022

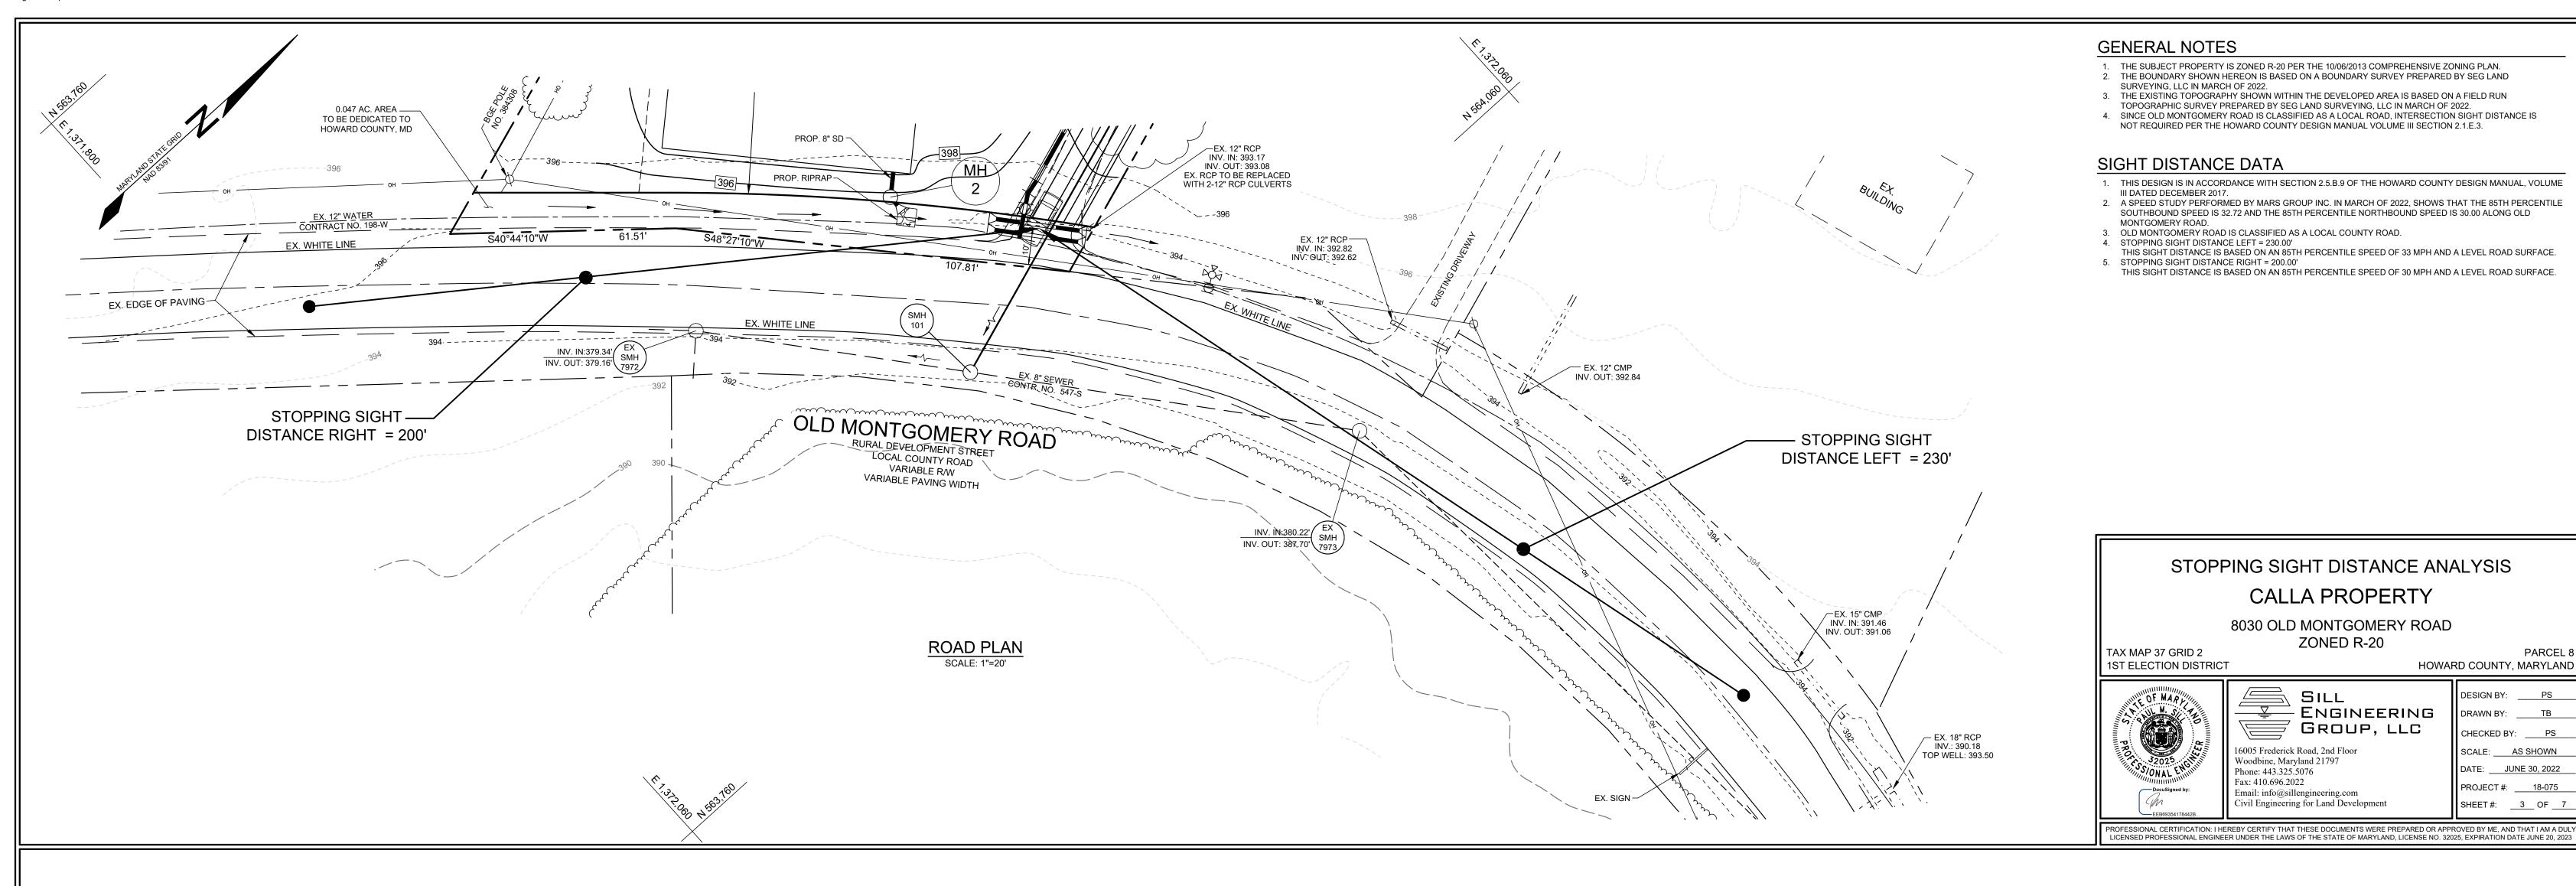

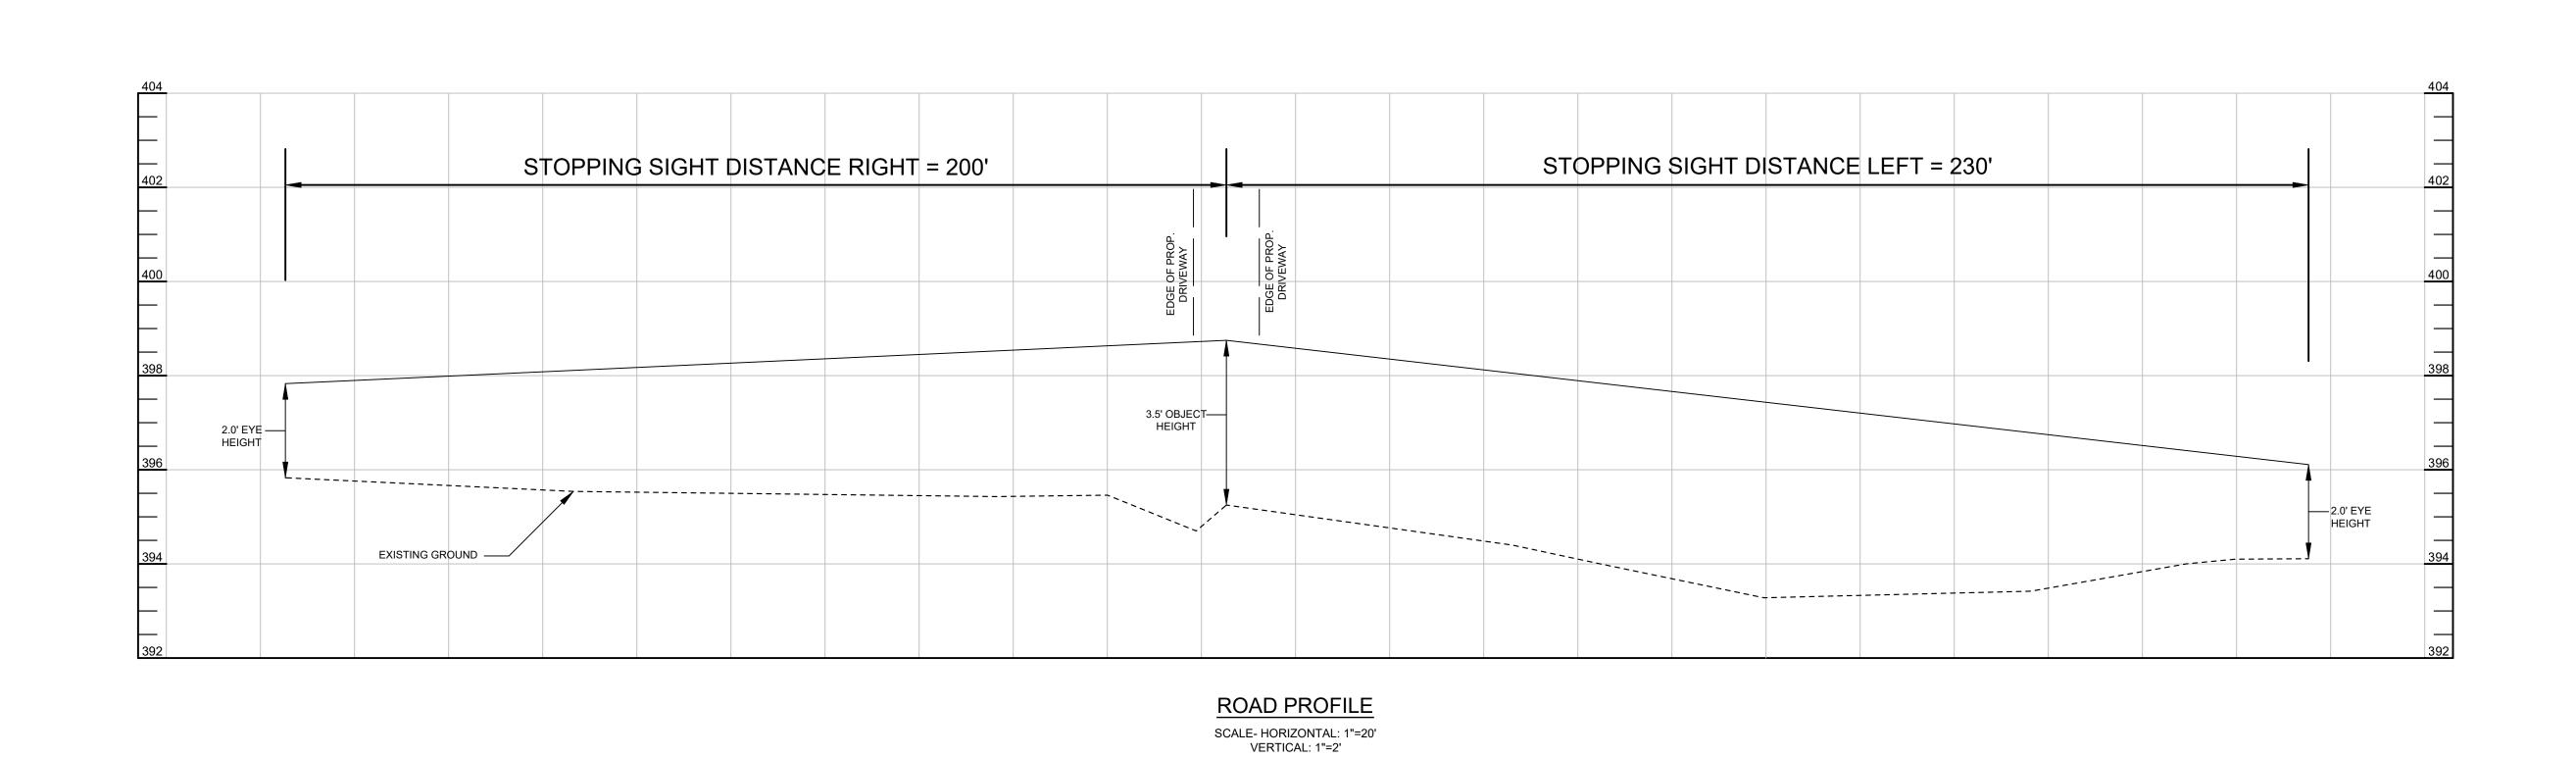

S-21-008

PARCEL 8

DESIGN BY: PS


DRAWN BY: _____TB


CHECKED BY: PS


SCALE: AS SHOWN DATE: <u>JUNE 30, 2022</u>


PROJECT #: ____18-075

SHEET #: <u>3</u> OF <u>7</u>

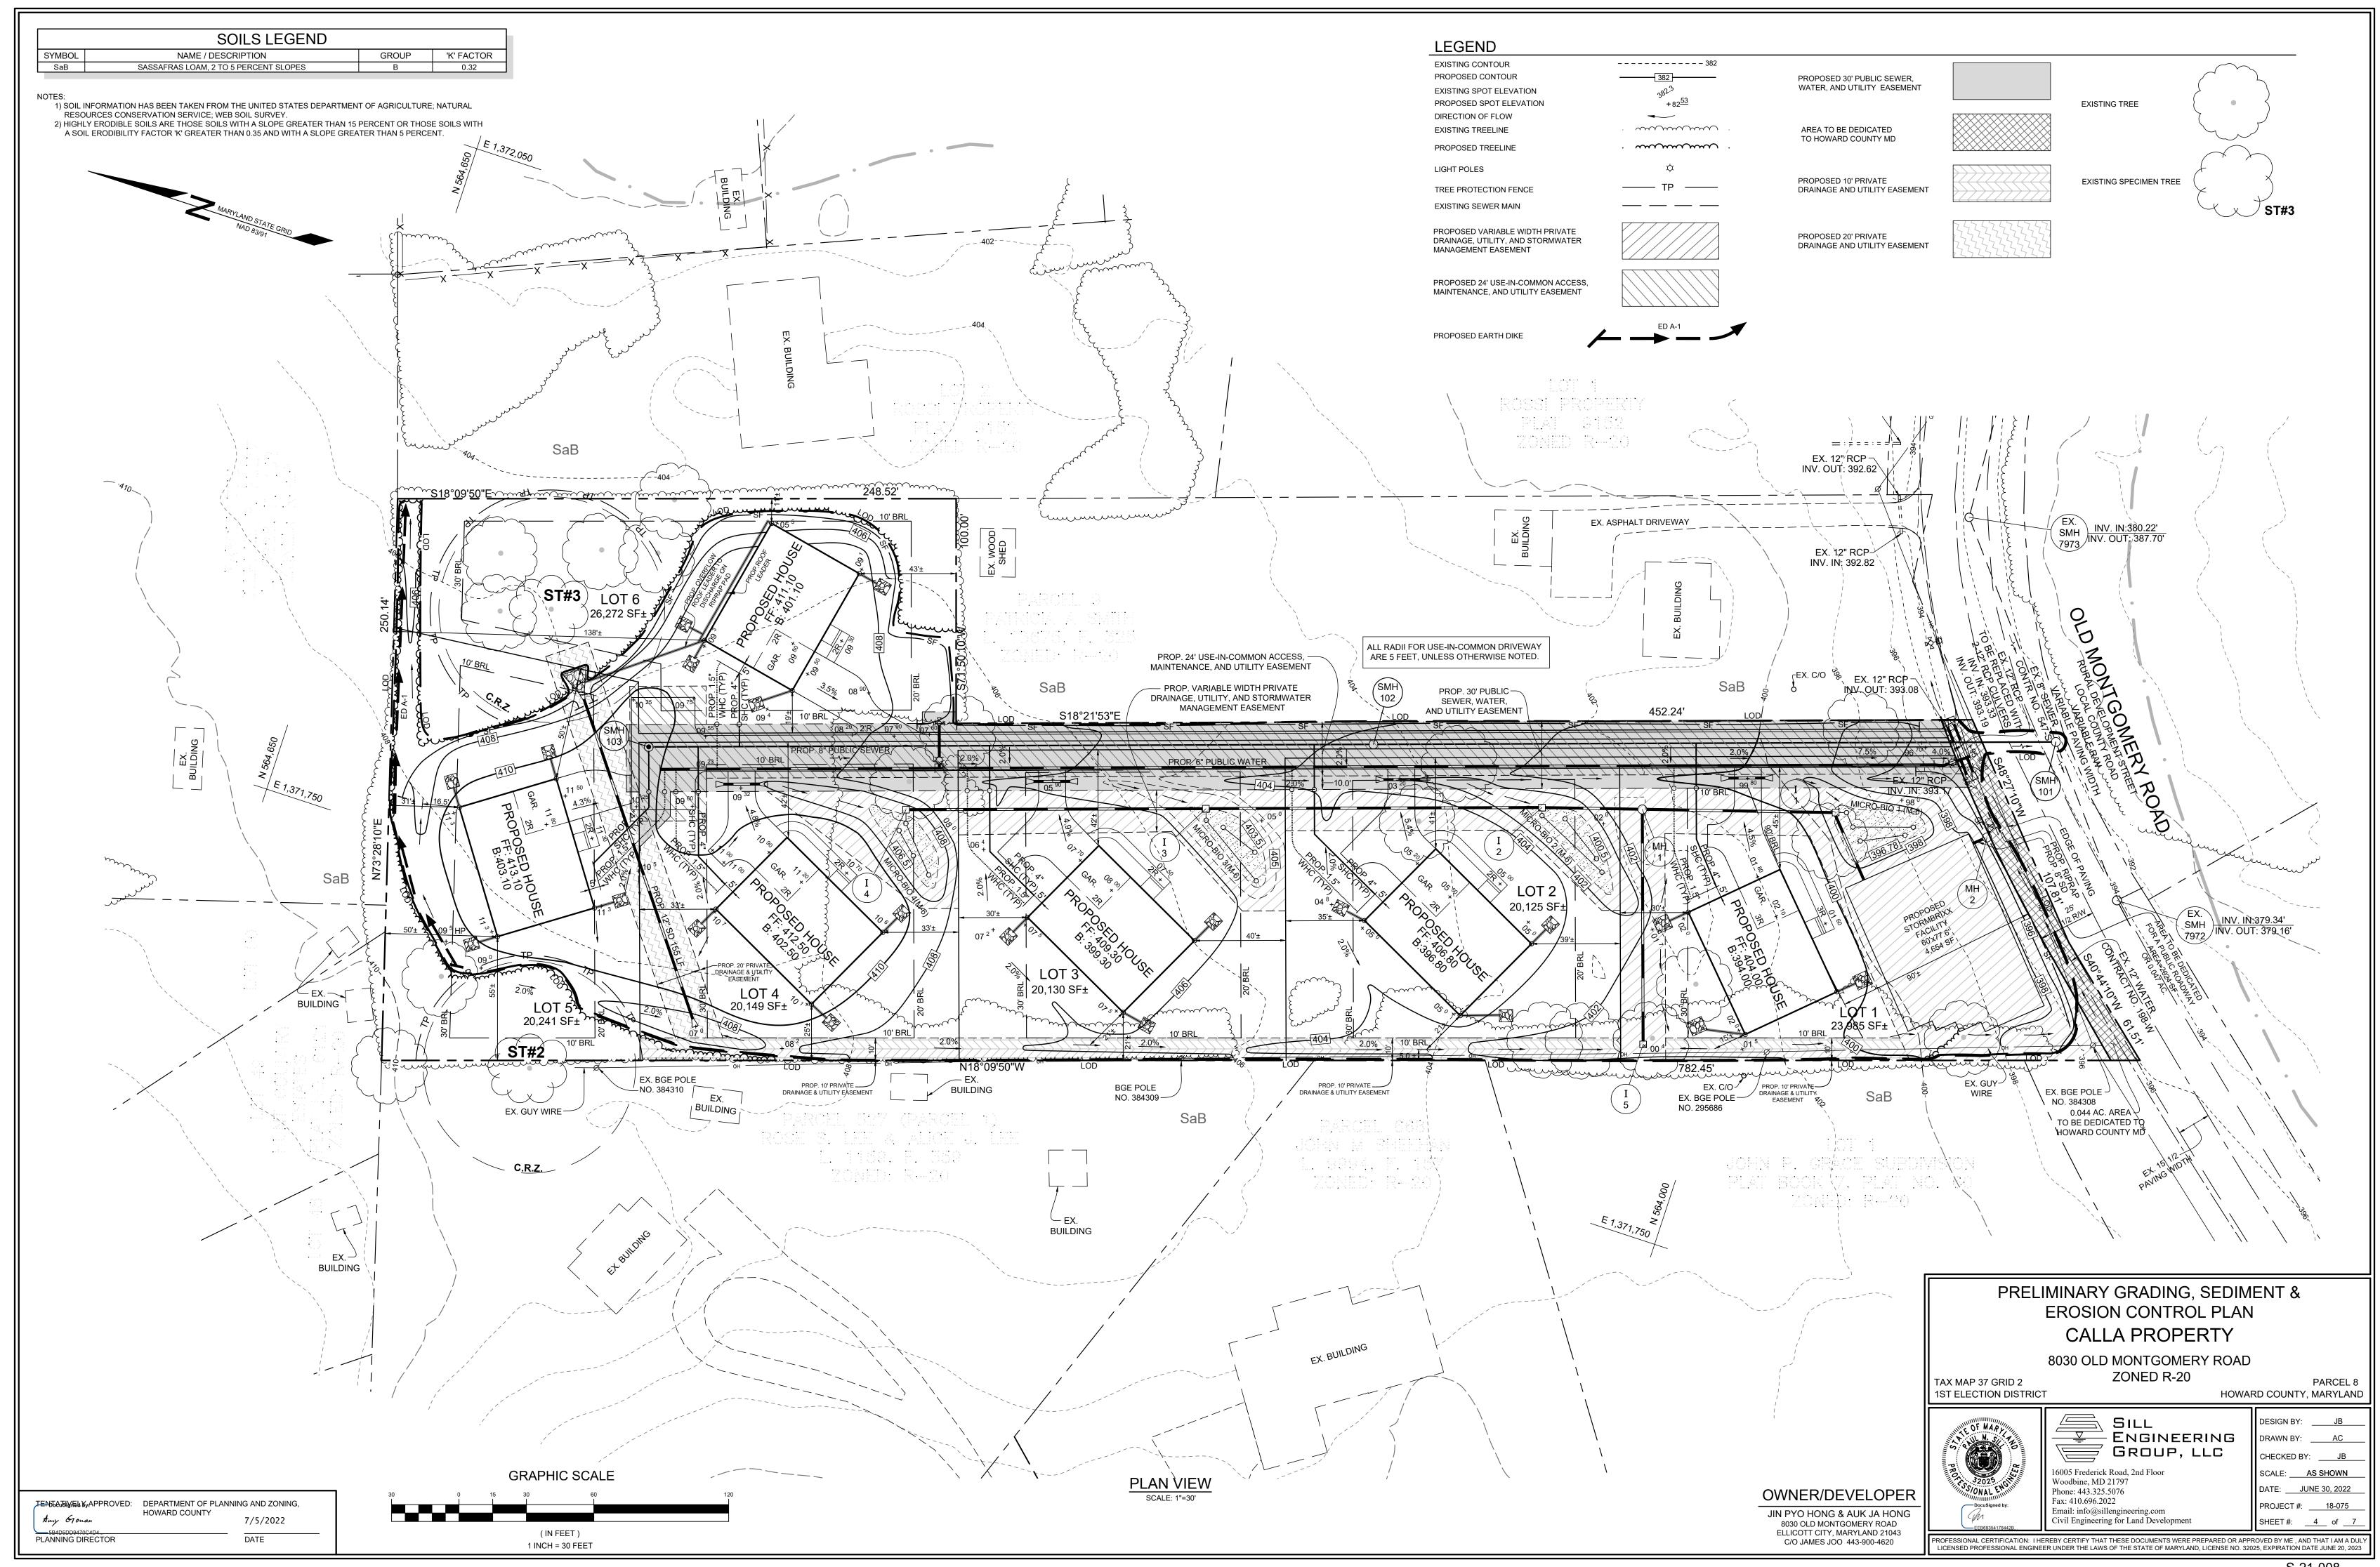


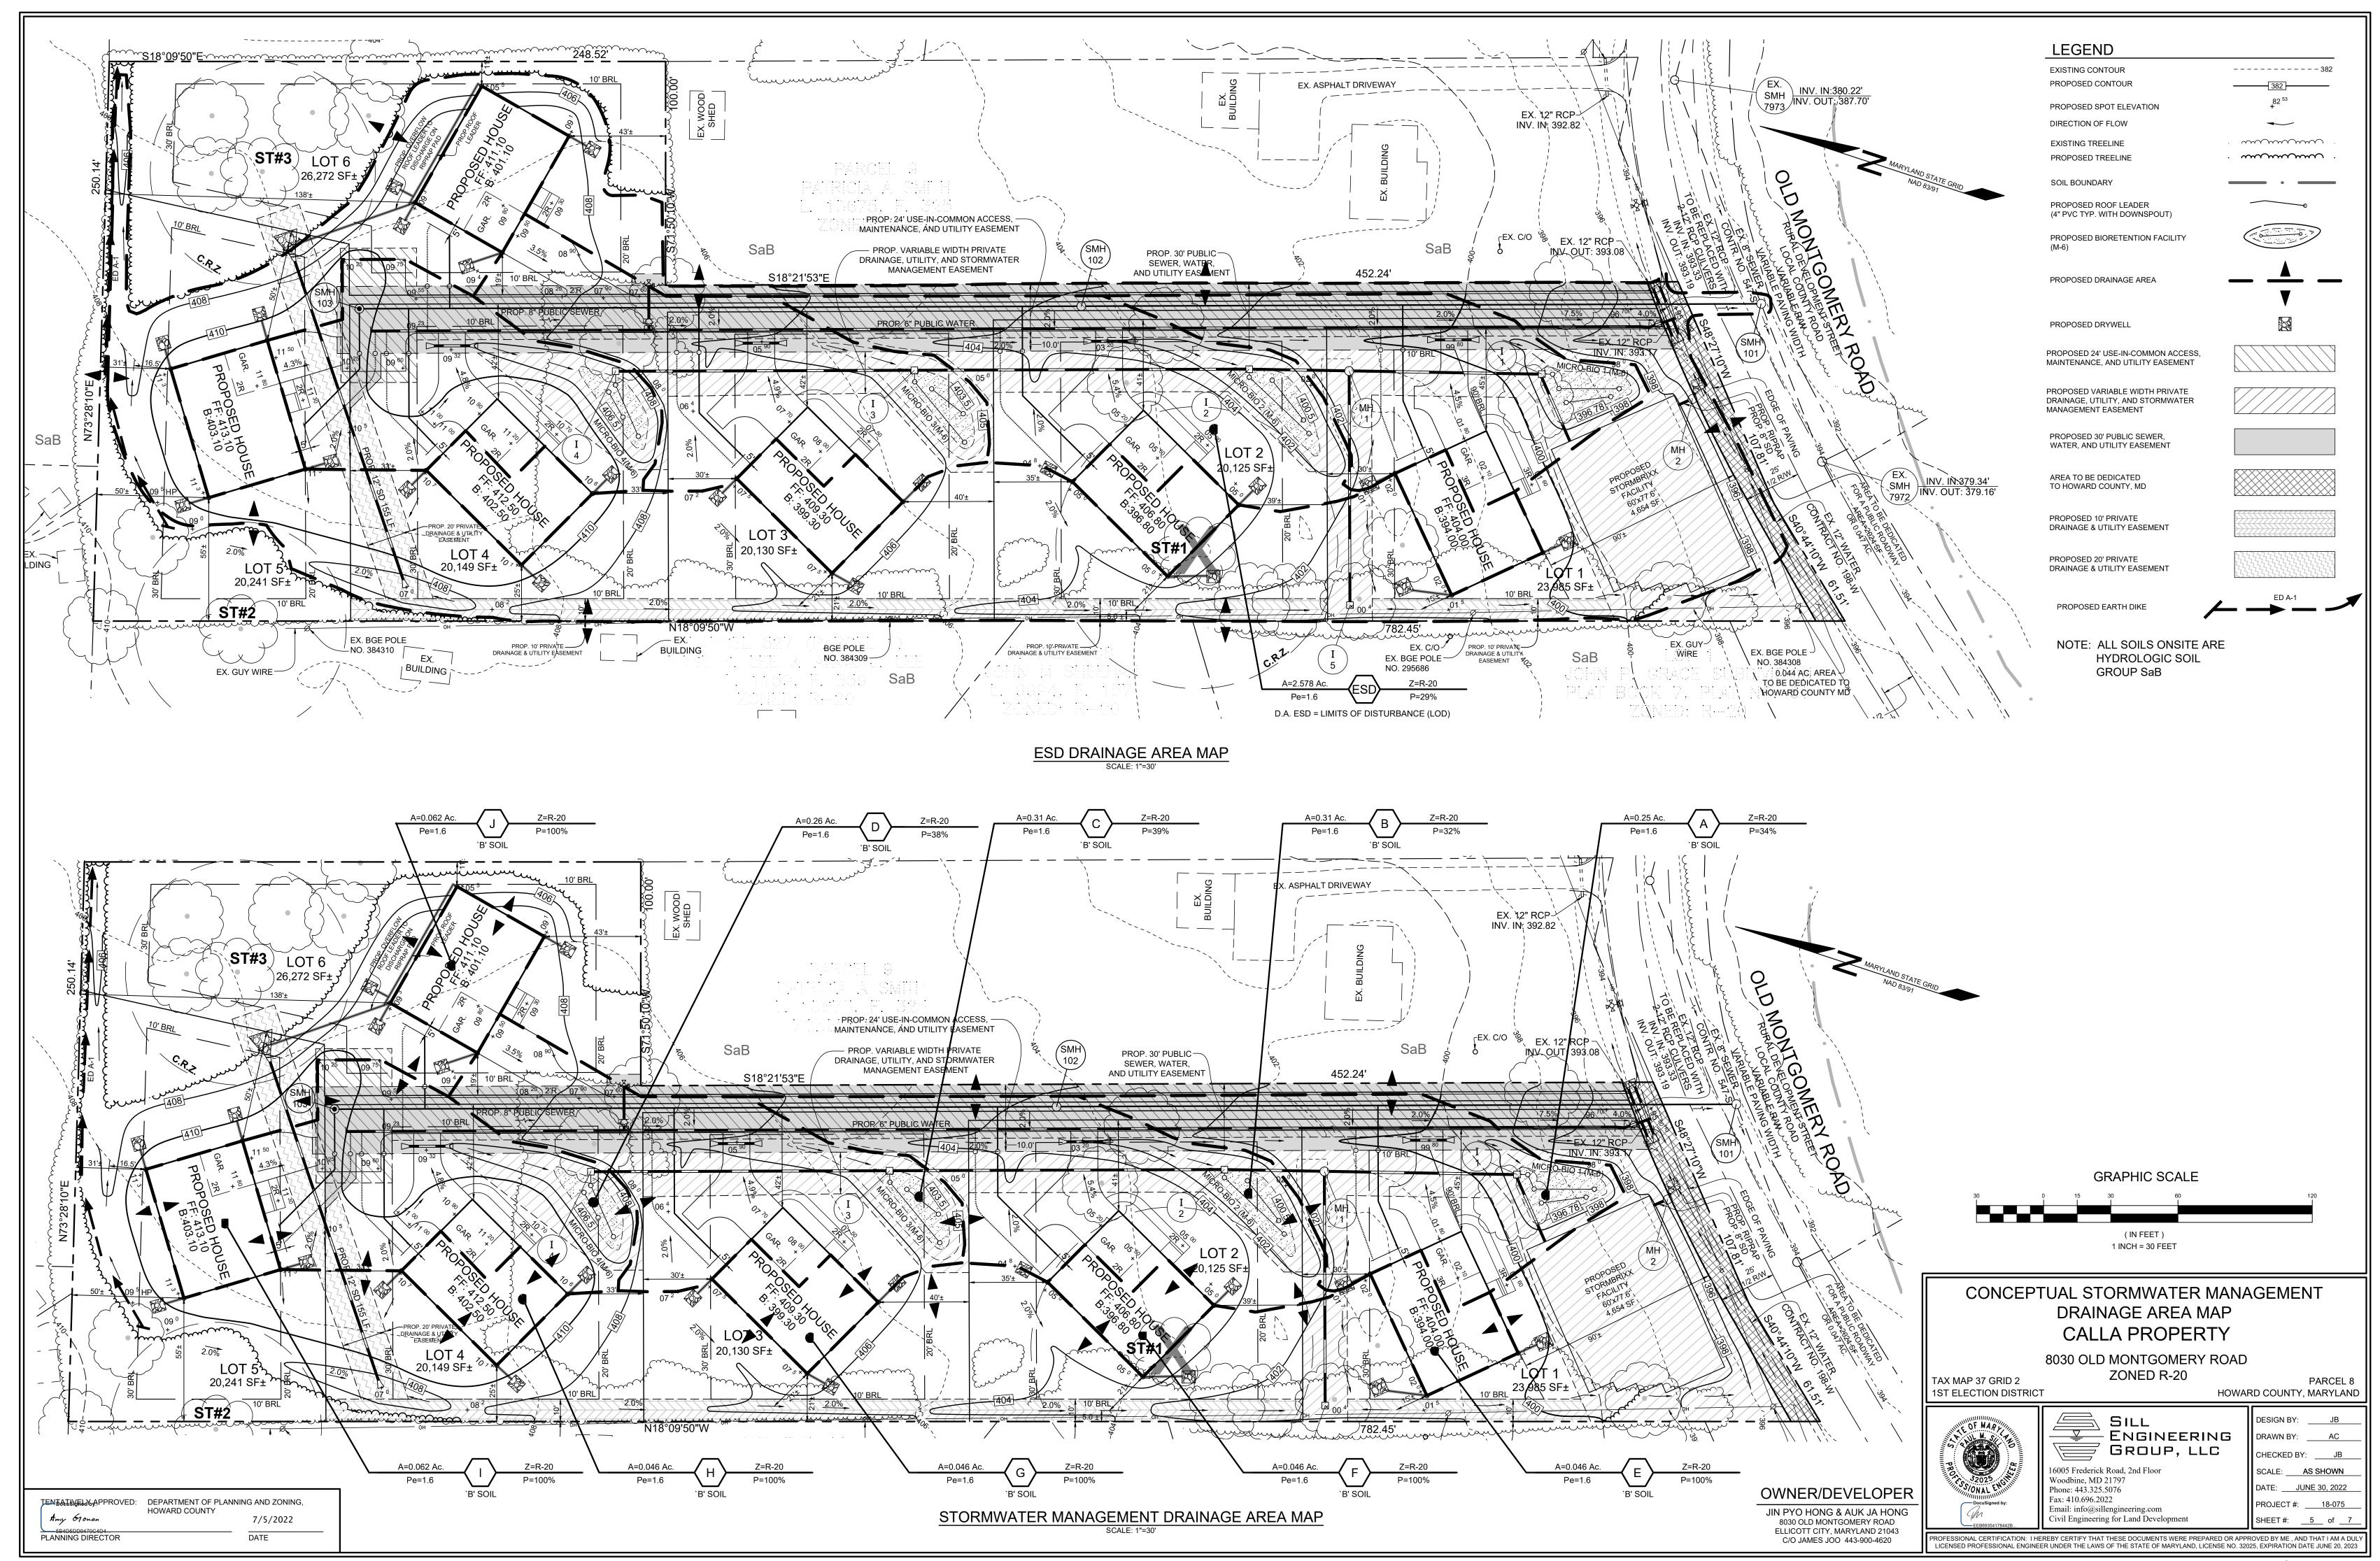

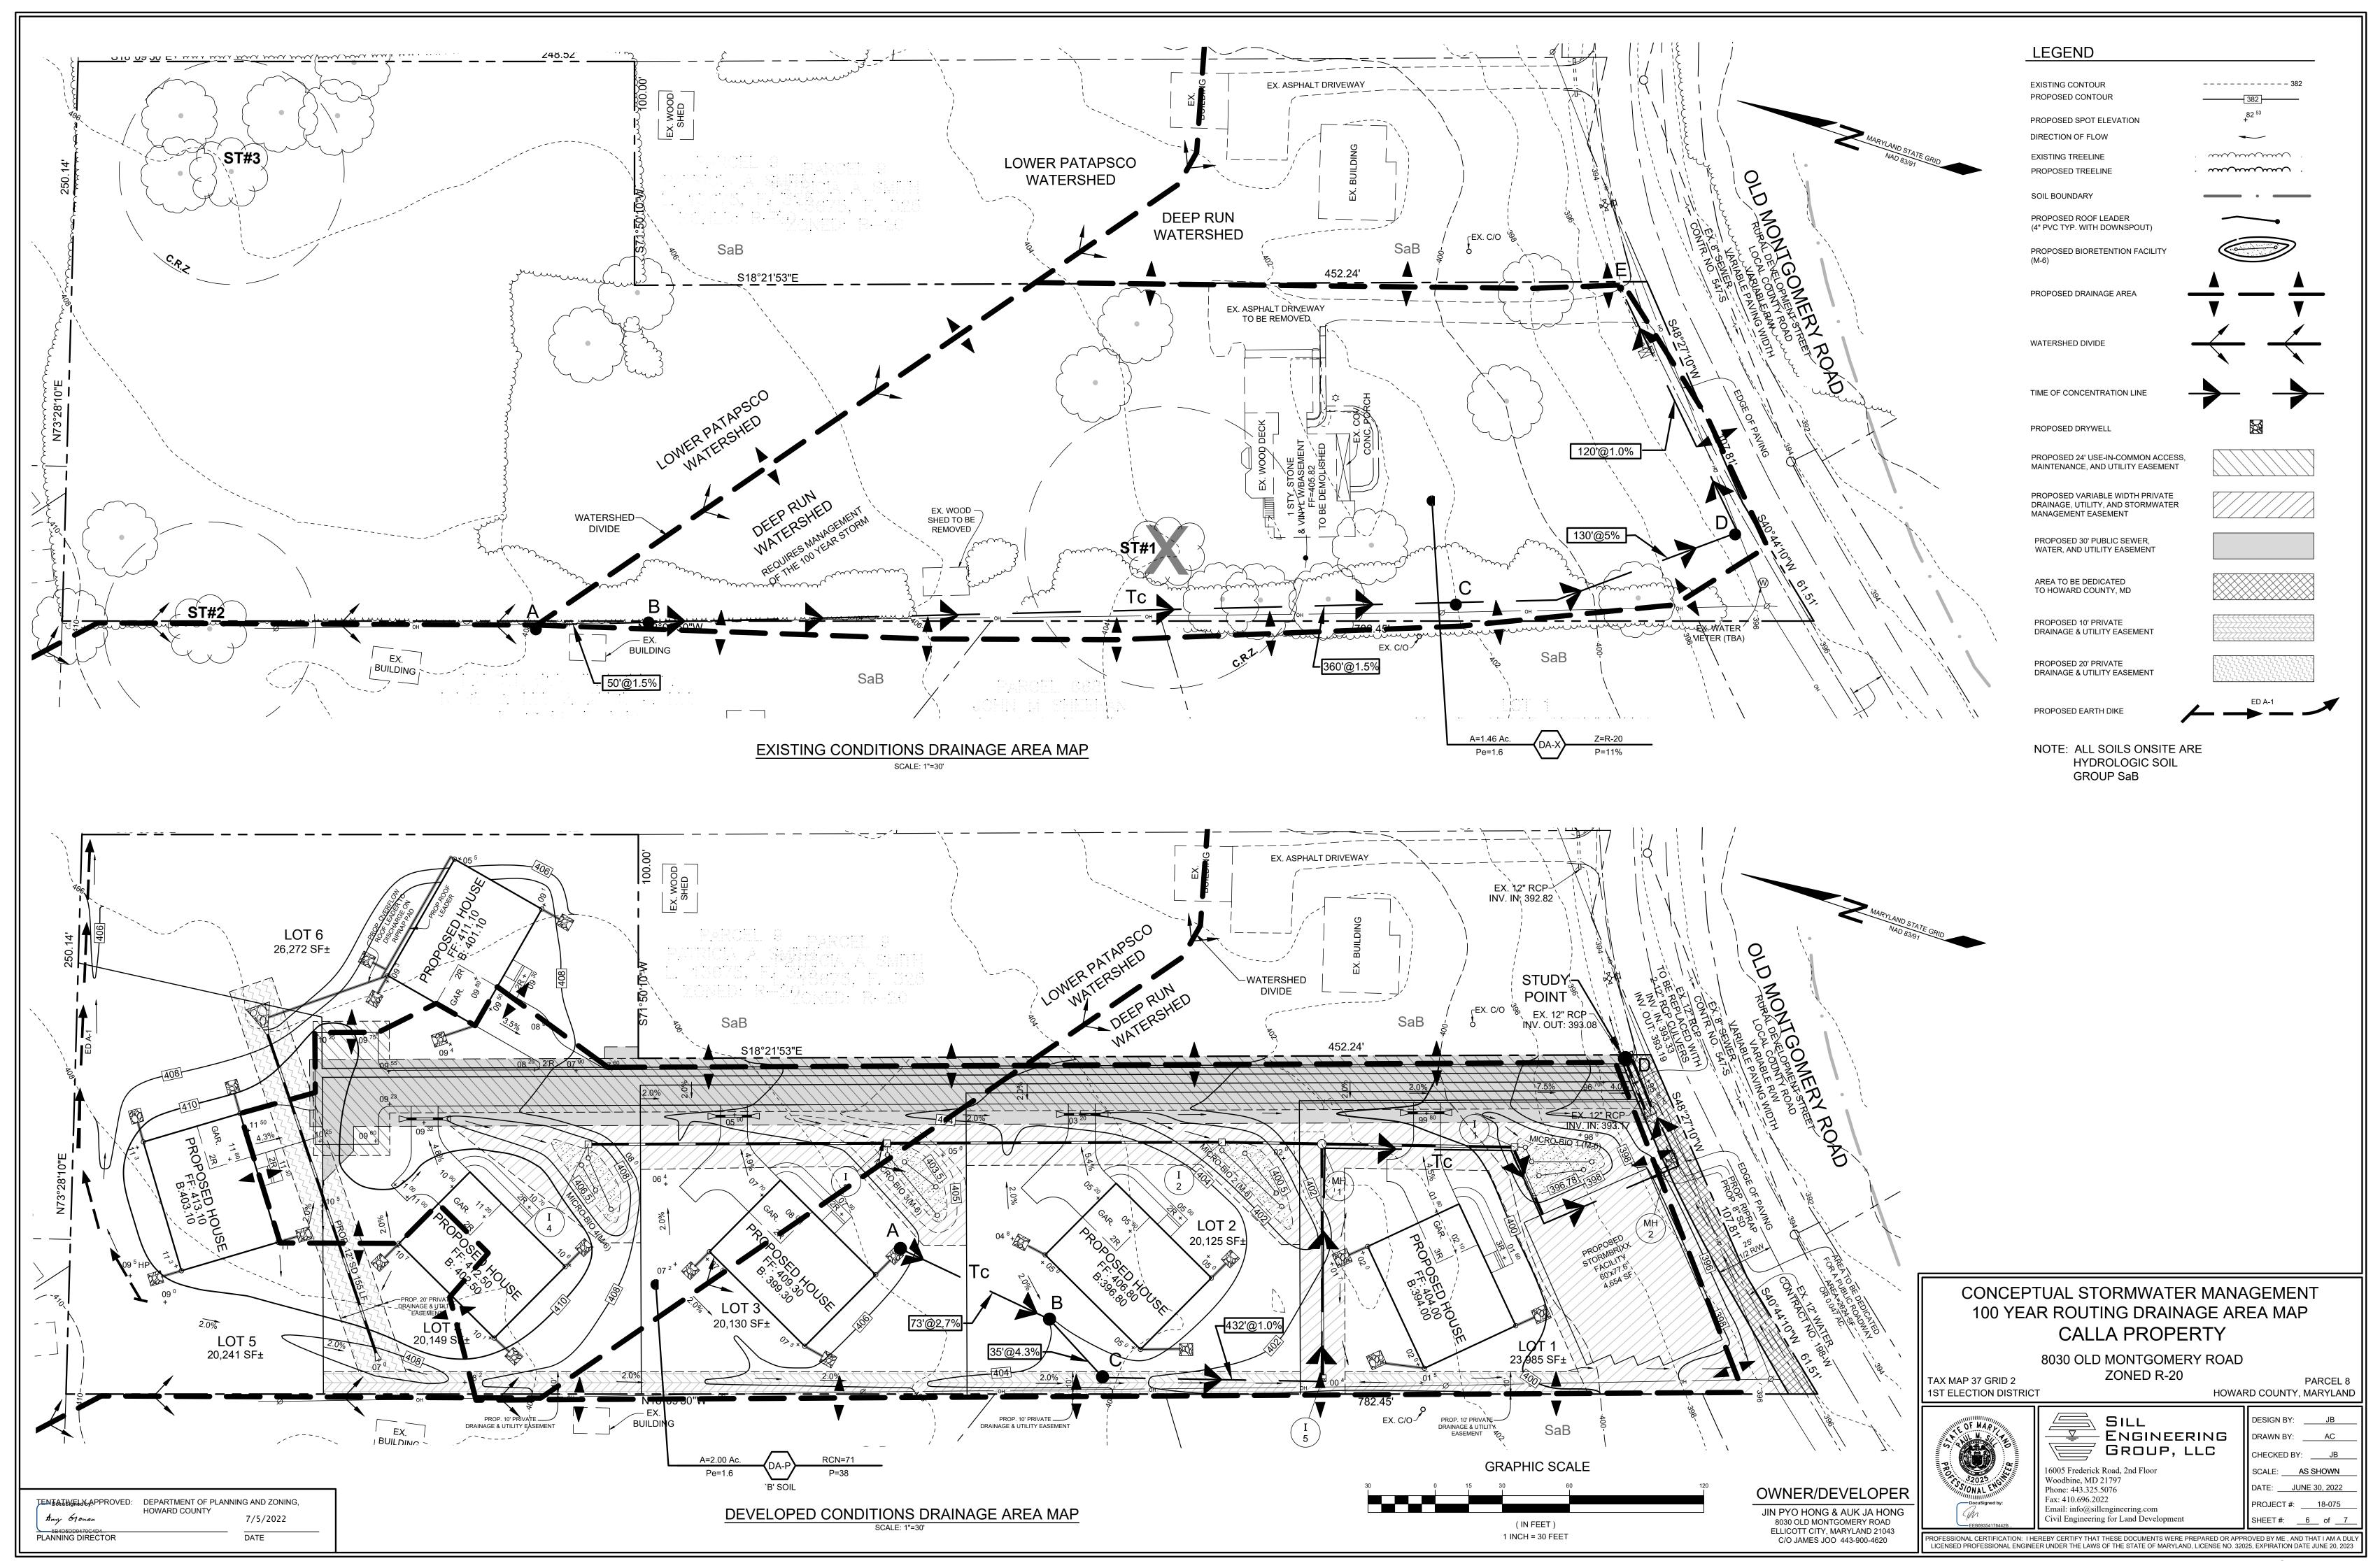

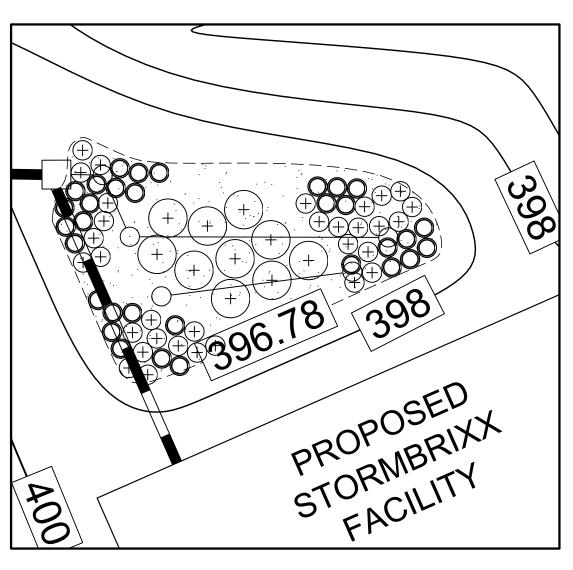

LANDSCAPING PLAN MICRO-BIORETENTION FACILITY SCALE: 1"=10'

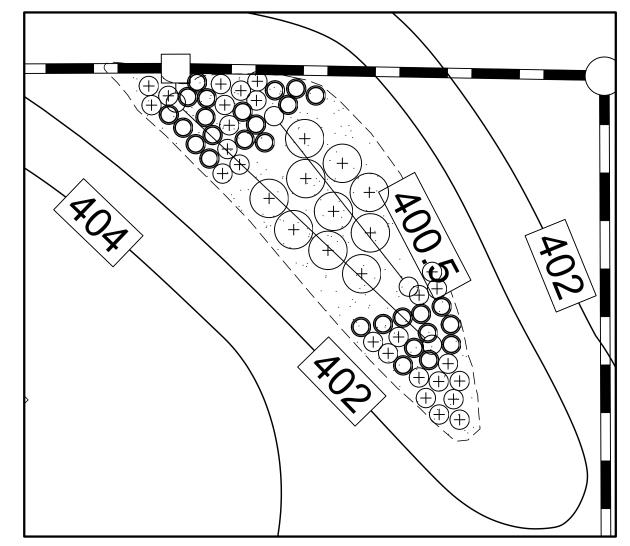

LANDSCAPING PLAN MICRO-BIORETENTION FACILITY 2

CLEANOUT WITH -

WATERPROOF CAP,

SET FLUSH WITH MULCH

FILTER FABRIC -

SIDES ONLY

4" SCH 40 PERFORATED-

SLOTTED PVC PIPE

UNDERDRAIN

IN 8" GRAVEL JACKET

WITHIN THE FACILITY

4" SCH 40 SOLID PVC PIPE

TO OUTFALL

4" SCH 40 SOLID PVC PIPE

MICRO-BIORETENTION #1 SHALL BE

ALL SIDES.

OPERATION AND MAINTENANCE SCHEDULE FOR

PRIVATELY OWNED AND MAINTAINED

MICRO-BIORETENTION FACILITIES (M-6)

MAINTENANCE OF MULCH AND SOIL IS LIMITED TO CORRECTING AREAS OF EROSION OR WASH OUT.

ACCEPTABLE REPLACEMENT PLANT MATERIAL IS LIMITED TO THE FOLLOWING: 2000 MARYLAND

THE OWNER SHALL PERFORM A PLANT INSPECTION IN THE SPRING AND IN THE FALL OF EACH YEAR.

BEYOND TREATMENT, REPLACE DEAD PLANT MATERIAL WITH ACCEPTABLE REPLACEMENT PLANT

DURING THE INSPECTION, THE OWNER SHALL REMOVE DEAD OR DISEASED VEGETATION CONSIDERED

MATERIAL, TREAT DISEASED TREES AND SHRUBS, AND REPLACE ALL DEFICIENT STAKES AND WIRES.

THE OWNER SHALL INSPECT THE MULCH EACH SPRING. THE MULCH SHALL BE REPLACED EVERY TWO

TO THREE YEARS. THE PREVIOUS MULCH LAYER SHALL BE REMOVED BEFORE THE NEW LAYER IS

4. THE OWNER SHALL CORRECT SOIL EROSION ON AN AS NEEDED BASIS, WITH A MINIMUM OF ONCE PER

ANY MULCH REPLACEMENT SHALL BE DONE IN THE SPRING. PLANT MATERIAL SHALL BE CHECKED FOR


DISEASE AND INSECT INFESTATION AND MAINTENANCE WILL ADDRESS DEAD MATERIAL AND PRUNING.

1. THE OWNER SHALL MAINTAIN THE PLANT MATERIAL, MULCH LAYER AND SOIL LAYER ANNUALLY.

STORMWATER DESIGN MANUAL, VOLUME II, TABLE A.4.1 AND 2.

MONTH AND AFTER EACH HEAVY STORM.

WRAPPED IN IMPERVIOUS LINER ON

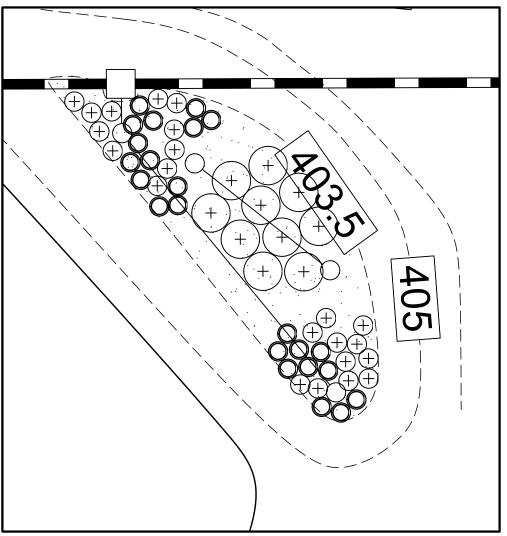

LANDSCAPING PLAN **MICRO-BIORETENTION FACILITY 3**

-'E' & 'F' EARTHEN

'A' PONDING DEPTH

6" MIN, 12" MAX

-3" MULCH LAYER, TYP. 'B' TOP OF MULCH ELEVATION

- 24" PLANTING MEDIA

– 4" PEA GRAVEL

UNDERDRAIN

-'O' GRAVEL

STORAGE

OVERFLOW DRAIN

W/ GRATE TOP

(DO NOT CONNECT

TO UNDERDRAIN)

- FOR ADDITIONAL INFORMATION, SEE THE 2000 MARYLAND

STORMWATER DESIGN MANUAL,

- SEE CHART, THIS SHEET, FOR

ELEVATIONS AND DISTANCES

BE WRAPPED IN

PARAMETER

No. of Layers*

Vertical Strength

Lateral Strength

Maximum Installation Depth

*Extra layers may be suitable in specific applications. Please consult ACO.

Design Life

Applic ations

IMPERVIOUS LINER ON

ALL SIDES AND BOTTOM.

NOTE: STORMBRIXX SYSTEM

VOLUMES I AND II.

SPILLWAY

-WSEL TO TOP OF BERM 6"


- FILTER FABRIC

BIORETENTION FACILITY

TYPICAL SECTION

NOT TO SCALE

SIDES ONLY

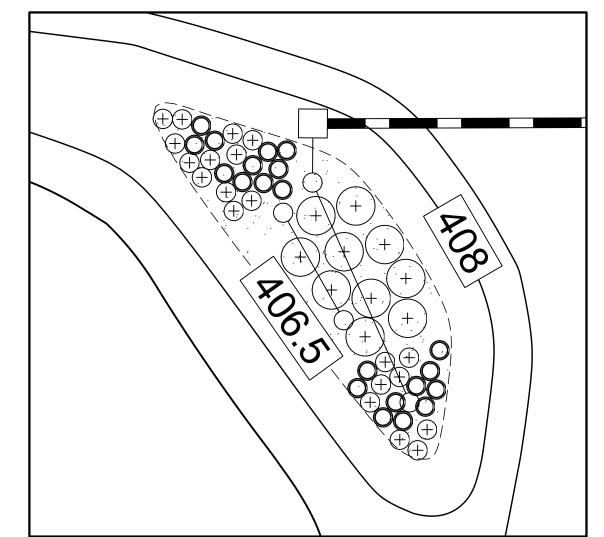

LANDSCAPING PLAN MICRO-BIORETENTION FACILITY 4

'A' PONDING DEPTH

6" MIN, 12" MAX

3" MULCH LAYER, TYP.

'B' TOP OF MULCH ELEVATION

24" PLANTING MEDIA -

4" PEA GRAVEL-

2" MIN. BELOW-

UNDERDRAIN

'O' GRAVEL STORAGE-

'P' BOTTOM FACILITY ELEVATION

BIORETENTION ELEVATIONS AND DIMENSIONS					
DESCRIPTION	BIO 1	BIO 2	BIO 3	BIO 4	
'A' PONDING DEPTH	1.0'	1.0'	1.0'	1.0'	
'B' TOP OF MULCH	396.76	400.50	403.5	406.5	
'C' WSEL	397.76	401.50	404.5	407.5	
'D' EMBANKMENT WIDTH	4.0'	4.0'	4.0'	4.0'	
'E' SPILLWAY WIDTH	N/A	N/A	N/A	N/A	
'F' SPILLWAY LENGTH	N/A	N/A	N/A	N/A	
'G' FACILITY LENGTH	36.1'	48.0'	45.0'	46.0'	
'H' FACILITY WIDTH (AVERAGE)	17.3'	15.5'	15.5'	14.0'	
'I' PERF. UNDERDRAIN PIPE DIMENSION	24'	35'	35'	24'	
'J' UNDERDRAIN PIPE INVERT	393.7	397.4	400.4	N/A	
'K' SOLID UNDERDRAIN DIMENSION	31'	N/A	N/A	N/A	
'L' OUTFALL INVERT	393.7	397.4	400.4	403.4	
'M' PERF. OVERFLOW PIPE DIMENSION	15'	23'	18'	23'	
'N' OVERFLOW PIPE INVERT	393.7	397.4	400.4	403.4	
'O' GRAVEL STORAGE	0.5'	0.5'	0.4'	0.4'	
'P' BOTTOM ELEVATION OF FACILITY	393.51	397.25	400.25	403.25	
'Q' GRADE % OF OUTFALL PIPE	0%	0%	0%	0%	

- 'D' EMBANKMENT WIDTH

MICRO-BIORETENTION #1 SHALL

BE WRAPPED IN IMPERVIOUS

LINER ON ALL SIDES.

ROOF LEADER

SURCHARGE

PIPE

-4" SOLID SCH 40 PVC OUTSIDE OF DRYWELL

4" PERFORATED > SCH 40 PVC

4" SCH 40 PERFORATED

SLOTTED PVC PIPE

OVERFLOW DRAIN

IN 8" GRAVEL JACKET.(DO

NOT CONNECT TO

-MITER PIPE END TO

CONFORM TO SLOPE

- 'L' OUTFALL INVERT

UNDERDRAIN)

-'Q' GRADE PERCENTAGE OF OUTFALL PIPE

PVC, SLOPE VARIES

(0.5% MIN)

BLOCK

	M-6 MICRO-BIORETENTION PLANT LIST									
			SHRUE	3S						
LEGEND	BOTANICAL NAME	COMMON NAME	SPACING	SIZE	REMARKS	QTY. BIO 1	QTY. BIO 2	QTY. BIO 3		TOTAL
+	ILEX VERTICILLATA	WINTERBERRY	AS SHOWN* (MIN. 4' O.C.)	24"- 36" HT.	1 MALE PLANT IN THE CENTER OF EVERY 10 PLANTS	10	10	10	10	40
		H	IERBACEOUS	SPECIES						
LEGEND	BOTANICAL NAME	COMMON NAME	SPACING	SIZE	REMARKS	QTY. BIO 1	QTY. BIO 2	QTY. BIO 3		TOTAL
0	RUDEBECKIA	BLACK EYED SUSAN	AS SHOWN* (MIN. 2' O.C.)	1 GAL		32	28	23	21	104
\oplus	ECHINCEA	CONEFLOWER	AS SHOWN* (MIN. 2' O.C.)	1 GAL		32	26	22	20	100

NOTE: PLANT MATERIAL MUST COVER 50% OF THE MULCH AREA AT MATURE GROWTH. *INTERSPERSE PLANTINGS THROUGHOUT BIORETENTION FILTER AREA

BIO 1 - BIORETENTION AREA = 650 S.f.

BIO 3 - BIORETENTION AREA = 533 S.F.

BIO 2 - BIORETENTION AREA = 585 S.F. BIO 4 - BIORETENTION AREA = 507 S.F.


MATERIALS S	PECIFICATIONS FOR MICRO-BIORETENTION,
RAIN	ARDEN & LANDSCAPE INFILTRATION

MATERIAL	SPECIFICATION	SIZE	NOTES
PLANTINGS	SEE PLANT LIST THIS SHEET	N/A	PLANTINGS ARE SITE-SPECIFIC, SEE PLANT LIST THIS SHEET
PLANTING SOIL [2'-4' TO 4' DEEP]	LOAMY SAND (60% - 65%) & COMPOST (35%-40%) OR SANDY LOAM (30%), COARSE SAND (30%) & COMPOST (40%)	N/A	USDA SOIL TYPES LOAMY SAND OR SANDY LOAM; CLAY CONTENT < 5%
ORGANIC CONTENT	MIN. 10% BY DRY WEIGHT (ASTM-D-2974)		
MULCH	SHREDDED HARDWOOD		AGED 6 MONTHS, MINIMUM; NO PINE OR WOOD CHIPS
PEA GRAVEL DIAPHRAGM	PEA GRAVEL: ASTM-D-448	NO. 8 OR NO. 9 (1/8" TO 3/8")	
CURTAIN DRAIN (IF REQUIRED)	ORNAMENTAL STONE: WASHED COBBLES	STONE: 2" TO 5"	
GEOTEXTILE		N/A	PE TYPE 1 NONWOVEN
UNDERDRAIN GRAVEL	AASHTO M-43	NO. 57 OR NO. 6 AGGREGATE (3/8" TO 3/4")	
UNDERDRAIN PIPING	F 758, TYPE PS 28 OR AASHTO M-278	4" TO 6" RIGID SCHEDULE 40 PVC OR SDR35	SLOTTED OR PERFORATED PIPE, 3/8" PERF. @ 6" ON CENTER, 4 HOLES PER ROW; MINIMUM OF 3" OF GRAVEL OVER PIPES; NOT NECESSARY UNDERNEATH PIPES. PERFORATED PIPE SHALL BE WRAPPED WITH 1/4" GALVANIZED HARDWARE CLOTH.
POURED IN PLACE CONCRETE (IF REQUIRED)	MSHA MX NO.3; F'c= 3500 PSI @ 28 DAYS, NORMAL WEIGHT, AIR-ENTRAINED; REINFORCING TO MEET ASTM-615-60	N/A	ON-SITE TESTING OF POURED-IN-PLACE CONCRETE REQUIRED: 28 DAY STRENGTH AND SLUMP TEST; ALL CONCRETE DESIGN (CAST-IN-PLACE OR PRE-CAST) NOT USING PREVOUSLY APPROVED STATE OR LOCAL STANDARDS REQUIRES DESIGN DRAWINGS SEALED AND APPROVED BY A PROFESSIONAL STRUCTURAL ENGINEER LICENSED IN THE STATE OF MARYLAND-DESIGN TO INCLUDE MEETING ACI CODE 350.R/89; VERTICAL LOADING [H-10 OR H-20]; ALLOWABLE HORIZONTAL LOADING (BASED ON SOIL PRESSURES); AND ANALYSIS OF POTENTIAL CRACKING.
SAND	AASHTO-M-6 OR ASTM-C-33	0.02" TO 0.04"	SAND SUBSTITUTIONS SUCH AS DIABASE AND GRAYSTONE (AASHTO) #10 ARE NOT ACCEPTABLE. NO CALCIUM CARBONATED OR DOLOMITIC SAND SUBSTITUTIONS ARE ACCEPTABLE. NO "ROCK DUST" CAN BE USED FOR SAND.

DRYWELL (M-5) DESIGN CHART					
LOT	VOLUME REQUIRED	VOLUME PROVIDED	NO. WELLS	SIZE WELLS	
1	261 CF	273 CF	DW 1-3	7.0' X 6.50' X 5' DEEP	
2	261 CF	273 CF	DW 1-3	7.0' X 6.50' X 5' DEEP	
3	261 CF	273 CF	DW 1-3	7.0' X 6.50' X 5' DEEP	
4	261 CF	273 CF	DW 1-3	7.0' X 6.50' X 5' DEEP	
5	348 CF	364 CF	DW 1-4	7.0' X 6.50' X 5' DEEP	
6	348 CF	364 CF	DW 1-4	7.0' X 6.50' X 5' DEEP	

NOTE: THE IMPERVIOUS SURFACE OF THE HOUSE WILL BE TREATED BY EACH DRY WELL.

rentatigeady. 7/5/2022 DATE PLANNING DIRECTOR

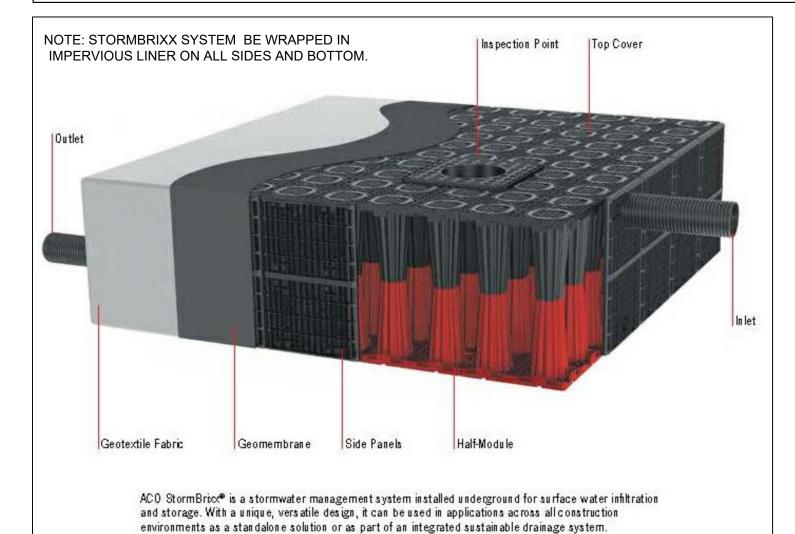

'H' FACILITY WIDTH

OVER FLOW


GRATE TOP

STORMBRIXX STORMWATER MANAGEMENT SYSTEM NOT TO SCALE

OPERATION AND MAINTENANCE SCHEDULE FOR PRIVATELY OWNED AND MAINTAINED DRY WELLS (M-5)

- 1. THE MONITORING WELLS AND STRUCTURES SHALL BE INSPECTED ON A QUARTERLY BASIS AND AFTER EVERY LARGE STORM WATER LEVELS AND SEDIMENT BUILD UP IN THE MONITORING WELLS SHALL BE RECORDED OVER A PERIOD OF SEVERAL DAYS TO INSURE TRENCH DRAINAGE.
 A LOG BOOK SHALL BE MAINTAINED TO DETERMINE THE RATE AT WHICH THE FACILITY DRAINS.
- WHEN THE FACILITY BECOMES CLOGGED SO THAT IT DOES NOT DRAIN DOWN WITHIN THE 72 HOURS TIME PERIOD, CORRECTIVE THE MAINTENANCE LOG BOOK SHALL BE AVAILABLE TO HOWARD COUNTY FOR INSPECTION TO INSURE COMPLIANCE WITH
- ONCE THE PERFORMANCE CHARACTERISTICS OF THE INFILTRATION FACILITY HAVE BEEN VERIFIED. THE MONITORING

OPERATION AND MAINTENANCE CRITERIA. SCHEDULE CAN BE REDUCED TO AN ANNUAL BASIS UNLESS THE PERFORMANCE DATA INDICATES THAT A MORE FREQUENT

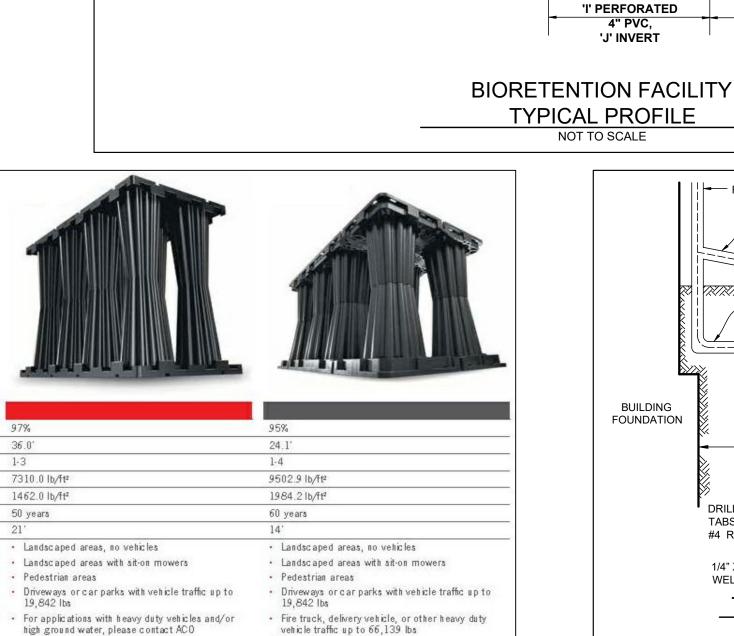

PIPE DIMENSION

'N' PERF. OVERFLOW

PIPE INVERT

"Ground improvements may be required. Ground water is not taken into account. STORMBRIXX STORMWATER MANAGEMENT SYSTEM NOT TO SCALE

For applications with heavy duty vehicles and/or high ground water, please contact ACO

GRAPHIC SCALE (IN FEET) 1 INCH = 10 FEET

For applications with unusually large loads and/or

high ground water, please contact ACO

OWNER/DEVELOPER JIN PYO HONG & AUK JA HONG 8030 OLD MONTGOMERY ROAD ELLICOTT CITY, MARYLAND 21043

'G' FACILITY LENGTH

OVERFLOW

GRATE TOP

CONNECT WITH - 4" PERFORATED SCH 40 PVC 4"x4" TEE ANCHORED WITH REBAR. **FOUNDATION** FOR DEPTH SEE SWM DESIGN CHART MINIMUM (THIS SHEET) -NO. 57 OR NO. 6 AGGREGATE (3/8" TO 3/4") DRILL HOLE THROUGH STEEL-TABS AND PVC PIPE INSERT SAND: AASHTO-M-6 OR #4 RE- BAR THROUGH HOLE ASTM -C-33 0.02" TO 0.04" 12" X12" STEEL FOOT PLATE 1/4" X 2" X 4" STEEL TABS WELDED TO FOOT PLATE -TYPICAL DRY WELL CROSS SECTION NOT TO SCALE CONCEPTUAL STORMWATER MANAGEMENT,


PLAN, NOTES, AND DETAILS CALLA PROPERTY

8030 OLD MONTGOMERY ROAD **ZONED R-20** TAX MAP 37 GRID 2 PARCEL 8 1ST ELECTION DISTRICT HOWARD COUNTY, MARYLAND

METAL CAP WITH LOCK

FILTER FABRIC LINES TOP AND

SIDES OF DRY WELL

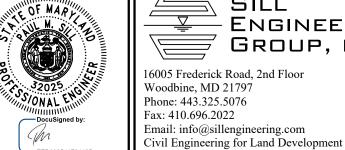

SILL ENGINEERING GROUP, LLC 16005 Frederick Road, 2nd Floor Woodbine, MD 21797 Phone: 443.325.5076 Fax: 410.696.2022

DRAWN BY: CHECKED BY: ____JB_ SCALE: AS SHOWN DATE: JUNE 30, 2022 PROJECT #: 18-075 SHEET #: __7__ of __7_

DESIGN BY:

PROFESSIONAL CERTIFICATION: I HEREBY CERTIFY THAT THESE DOCUMENTS WERE PREPARED OR APPROVED BY ME , AND THAT I AM A DUL LICENSED PROFESSIONAL ENGINEER UNDER THE LAWS OF THE STATE OF MARYLAND, LICENSE NO. 32025, EXPIRATION DATE JUNE 20, 2023 C/O JAMES JOO 443-900-4620