



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	SHEET INDEX	
	NO. DESCRIPTION	SITE
	2 SITE DEVELOPMENT PLAN 3 SITE DEVELOPMENT PLAN	
	4 SITE DEVELOPMENT PLAN 5 GRADING, SEDIMENT CONTROL AND DRAINAGE AREA MAP	
	6 GRADING, SEDIMENT CONTROL AND DRAINAGE AREA MAP 7 GRADING, SEDIMENT CONTROL AND DRAINAGE AREA MAP	
	8 STORM DRAIN PROFILES 9 SEWER PROFILES AND DETAILS	
	10 DETAIL SHEET 11 PLANTING PLAN 12 PLANTING PLAN	
	13 PLANTING PLAN	
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	CENERAL NOTES	
	1. ALL WATER LINES SHALL BE CONSTRUCTED A MINIMUM OF 42" COVER BELOW FINISHED GRADE.	
	2. ALL WORK SHALL BE PERFORMED IN ACCORDANCE WITH THE HOWARD COUNTY DESIGN MANUAL, VOLUME IV, i.e., STANDARD SPECIFICATIONS AND DETAILS	
	FOR CONSTRUCTION. 3. APPROXIMATE LOCATION OF EXISTING UTILITIES ARE SHOWN FROM BEST	
	AVAILABLE INFORMATION. THE CONTRACTOR SHALL TAKE ALL NECESSARY PRECAUTIONS TO PROTECT THE EXISTING UTILITIES AND MAINTAIN UNINTERRUPTED SERVICE. ANY DAMAGE INCURRED DUE TO CONTRACTOR'S	
	OPERATION SHALL BE REPAIRED IMMEDIATELY AT THE CONTRACTOR'S EXPENSE. 4. THE CONTRACTOR SHALL TEST PIT EXISTING UTILITIES AT LEAST FIVE (5)	
	DAYS BEFORE STARTING WORK SHOWN ON THESE DRAWINGS TO VERIFY THEIR LOCATION AND ELEVATION. THE CONTRACTOR SHALL NOTIFY THE ENGINEER	
	IRSEDIATELY IF LOCATION OF UTILITIES IS OTHER THAN SHOWN. 5. CONTRACTOR TO NOTIFY THE FOLLOWING UTILITIES OR AGENCIES AT LEAST	
	FIVE DAYS BEFORE STARTING WORK SHOWN ON THESE DRAWINGS: MISS UTILITY 1-800-257-7777	
	C & P TELEPHONE COMPANY 725-9976 HOWARD COUNTY BUREAU OF UTILITIES 992-2366 AT&T CABLE LOCATION DIVERSION 393-3553	
	BALTIMORE GAS & ELECTRIC COMPANY685-0123STATE HIGHWAY ADMINISTRATION531-5533HOWARD COUNTY CONSTRUCTION/INSPECTION SURVEY792-7272	
	DIVISION (24 HOURS NOTICE PRIOR TO COMMENCEMENT OF WORK)	ဌ
	6. ALL INLETS SHALL BE CONSTRUCTED IN ACCORDANCE WITH HOWARD COUNTY STANDARDS.	GRID .
	 ALL PIPE ELEVATIONS SHOWN ARE INVERT THE CONTRACTOR SHALL PROVIDE A JOINT IN ALL SEWER MAINS WITHIN 2'-0" 	
	OF EXTERIOR MANHOLE WALLS. 9. PROFILE STATIONS SHALL BE ADJUSTED AS NECESSARY TO CONFORM TO PLAN	NORTH
	DIMENSIONS. 10. NO PIPE SHALL BE LAID UNTIE LINES OF EXCAVATION HAVE BEEN BROUGHT TO	
	SUIGRADE. 11. TOPO TAKEN FROM FIELD RUN SURVEY DATED FED. 1088 BY THE RIEMER GROUP, INC.	
	12. ALL PLAN DIMENSIONS ARE TO FACE OF CURB UNLESS OTHERWISE NOTED.	
	13. ALL STORM DRAIN PIPE BEDDING SHALL BE AS SHOWN IN DETAIL G2.01 (TRENCH IN ROCK OR TRENCH IN EARTH AS DETERMINED BY FIELD	
	CONDITIONS) IN VOL. IV OF HOWARD COUNTY DESIGN MANUAL UNLESS OTHERWISE DIRECTED BY THE ENGINEER OR AS SHOWN ON THE DRAWINGS.	
	14. THE DEVELOPER IS RESPONSIBLE FOR THE AQUISITION OF ALL EASEMENTS, RICHTS AND / OR RICHTS-OF-WAY THAT HAY BE REQUIRED FOR THE SEDIMENT	
	AND EROSION CONTROL PRACTICES, STORM WATER MANAGEMENT PRACTICES AND THE DISCHARGE OF STORM WATER ONTO OR ACCROSS ADJACENT OR DOWNSTREAM PROPERTIES INCLUDED IN THIS PLAN. HE IS ALSO RESPONSIBLE FOR THE	
	AQUISITION OF ALL EASEMENTS, RIGHTS AND/OR WORK ON ADJACENT PROPERTIES INCLUDED IN THIS PLAN.	1066PH J. ROOK, NG.
	15. THE OWNER SHALL PROVIDE A SEPARATE AND, INDEPENDENT SEWER CONNECTION FOR EACH TENANT OR OCCUPANT OF ANY BUILDING, SHOWN ON THIS SITE DEVELOPMENT PLAN, WHO WILL DISCHARGE NON-DOMESTIC WASTE TO THE	ZONED R-MH
1	PUBLIC SEWERAGE SYSTEM IF THIS WASTE IS REGULATED UNDER SECTION 18.122A OF THE HOWARD COUNTY CODE. EACH SEPARATE AND INDEPENDENT SEWER CONNECTION SHALL INCLUDE A STANDARD MANHOLE AND OTHER WASTE	A A A A A A A A A A A A A A A A A A A
	PRETREATMENT DEVICES AS REQUIRED AND APPROVED BY HOWARD COUNTY. WASTE LINES ON THE INTERIOR OF THE BUILDING SHALL BE DESIGNED, CONSTRUCTED OR MODIFIED SUCH THAT NON-DOMESTIC WASTE WILL BE	
	DISCHARGED TO THE SEPARATE AND INDEPENDENT SEWER CONNECTION. NO TENENT OR OCCUPANT OF ANY BUILDING SHOWN ON THIS SITE DEVELOPMENT PLAN SHALL DISCHARGE REGULATED NON-DOMESTIC WASTE TO THE PUBLIC	
	SEWERAGE SYSTEM PRIOR TO INSTALLATION OF THE SEPARATE AND INDEPENDENT SEWER CONNECTION AND RELATED 'INTERIOR WASTE LINES. THE	
	ABOVE REQUIREMENTS SHALL APPLY TO ALL INITIAL AND FUTURE OCCUPANTS OR TENANTS.	
	K. PREVIOUS OFFICE OF PLANNING ZONING FILE NOS F-80-ZIO, GP-86-50, F-88-117.	
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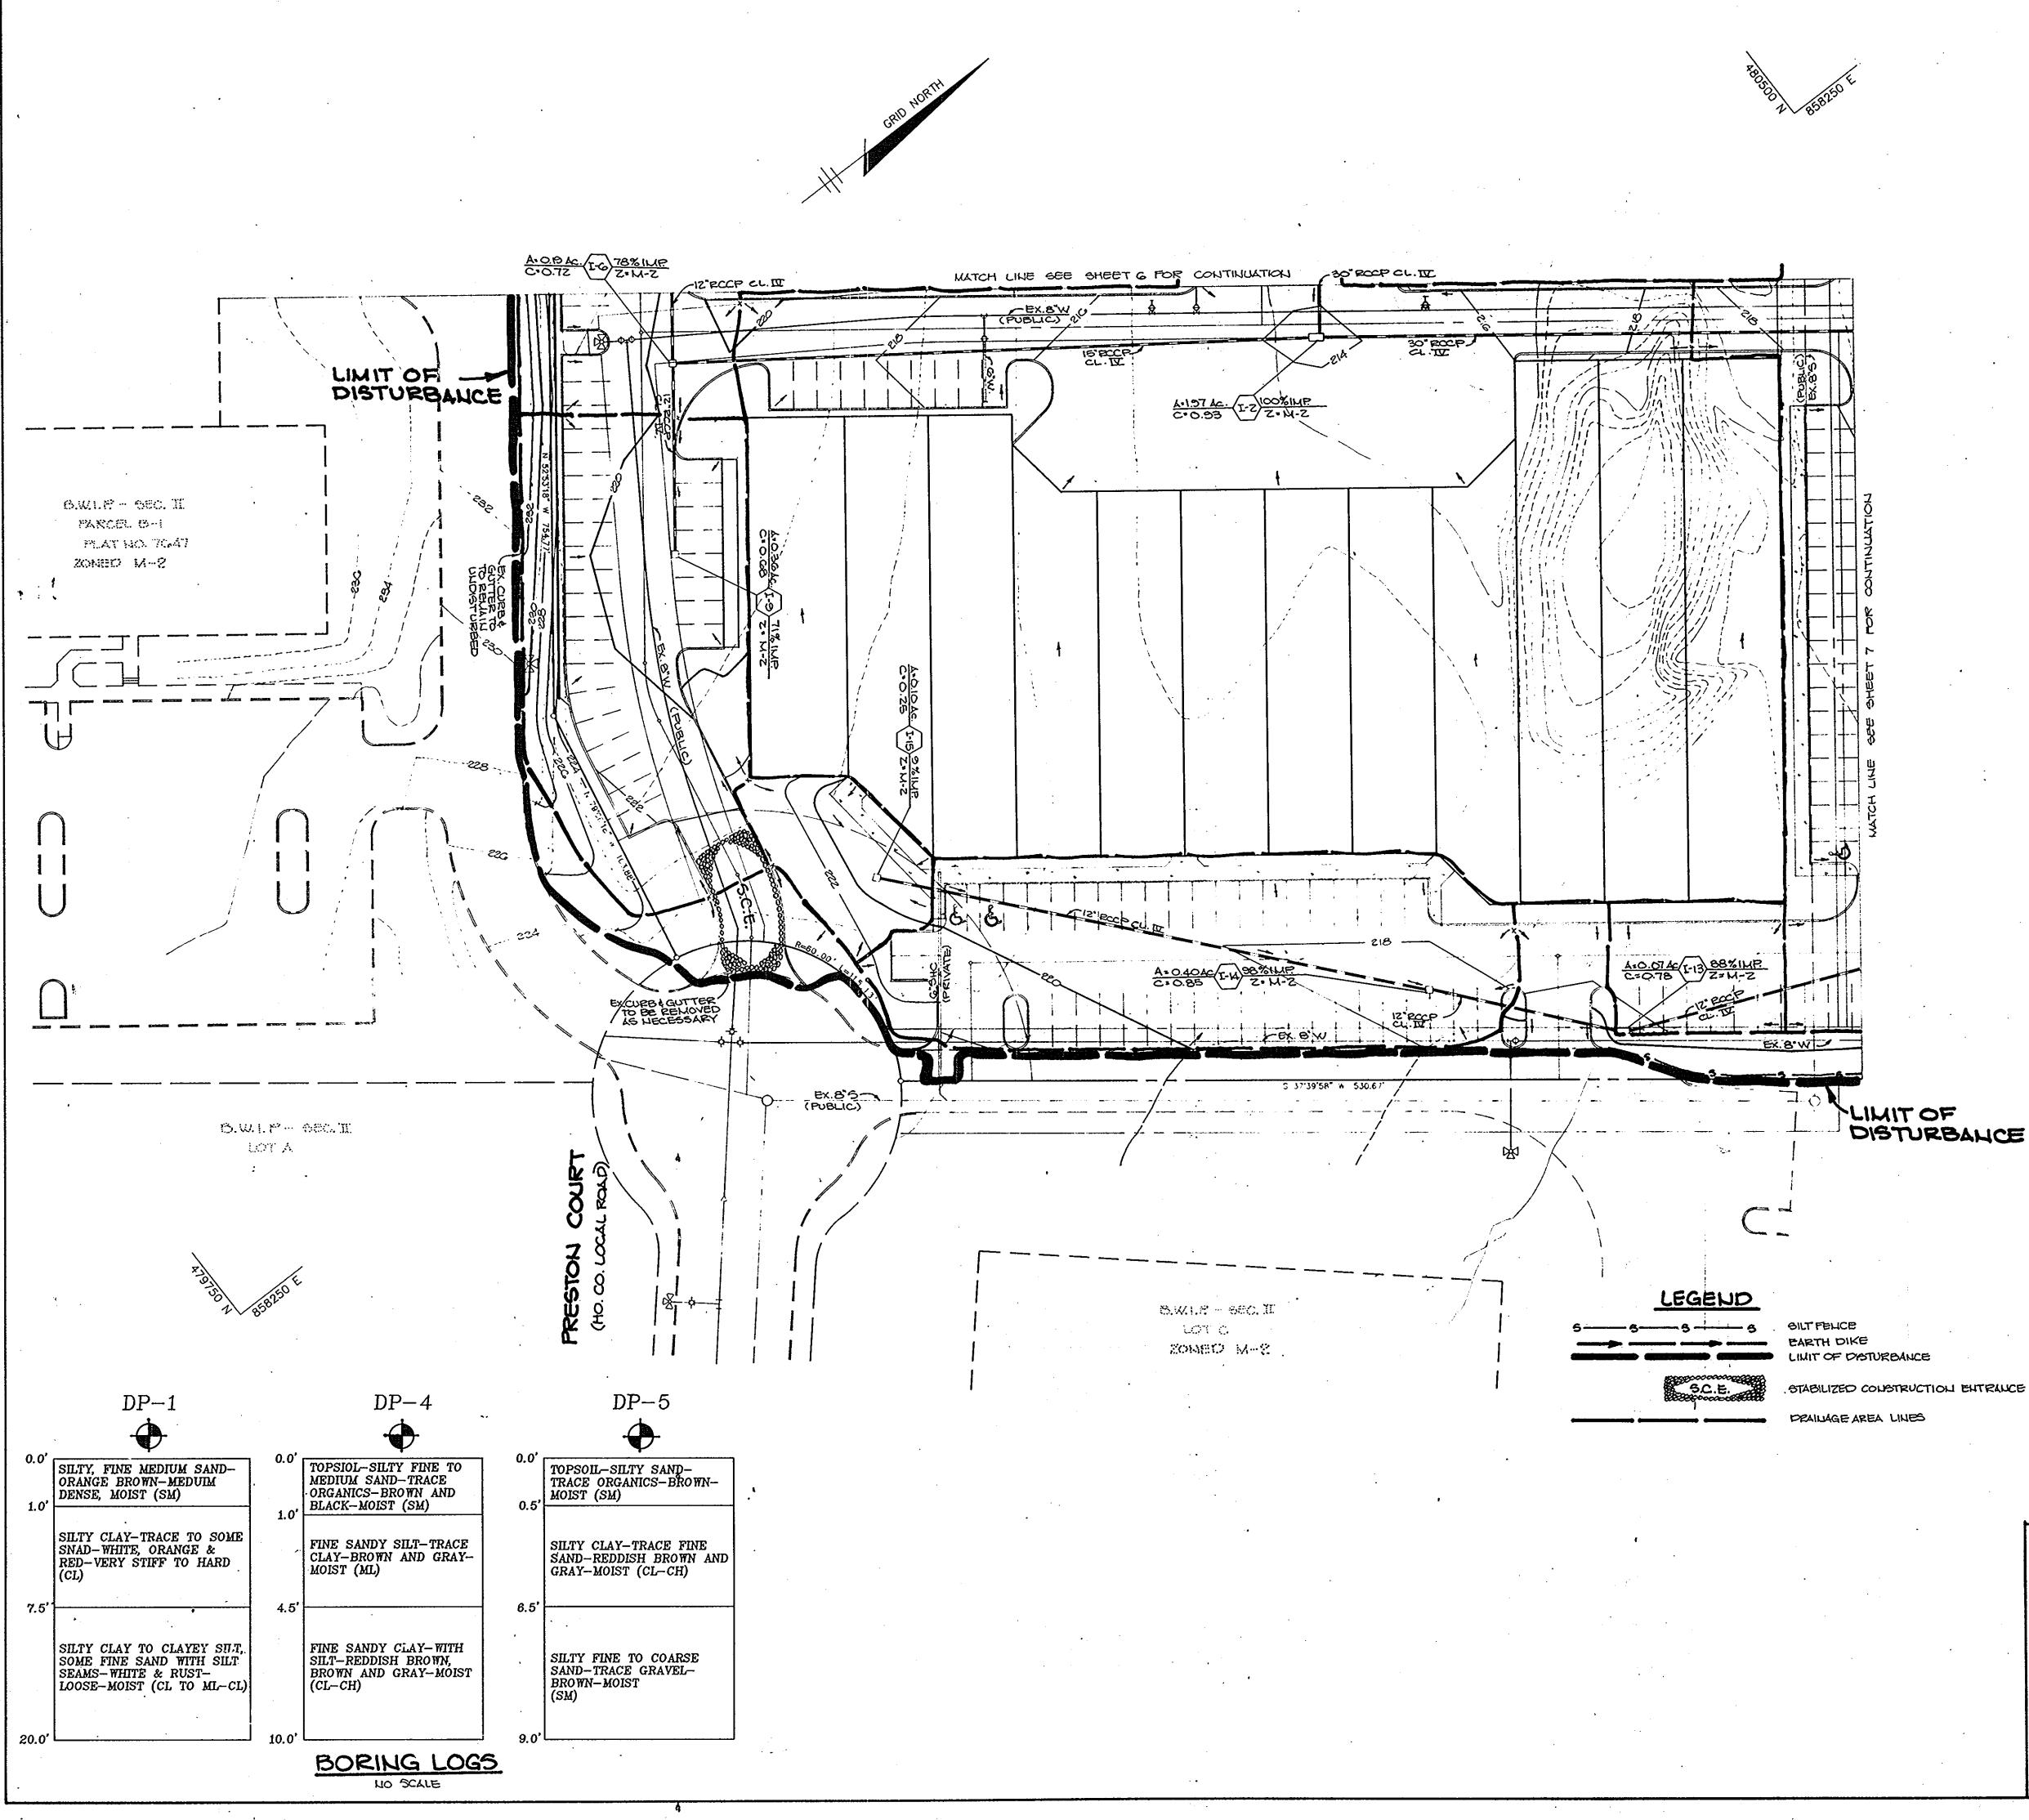


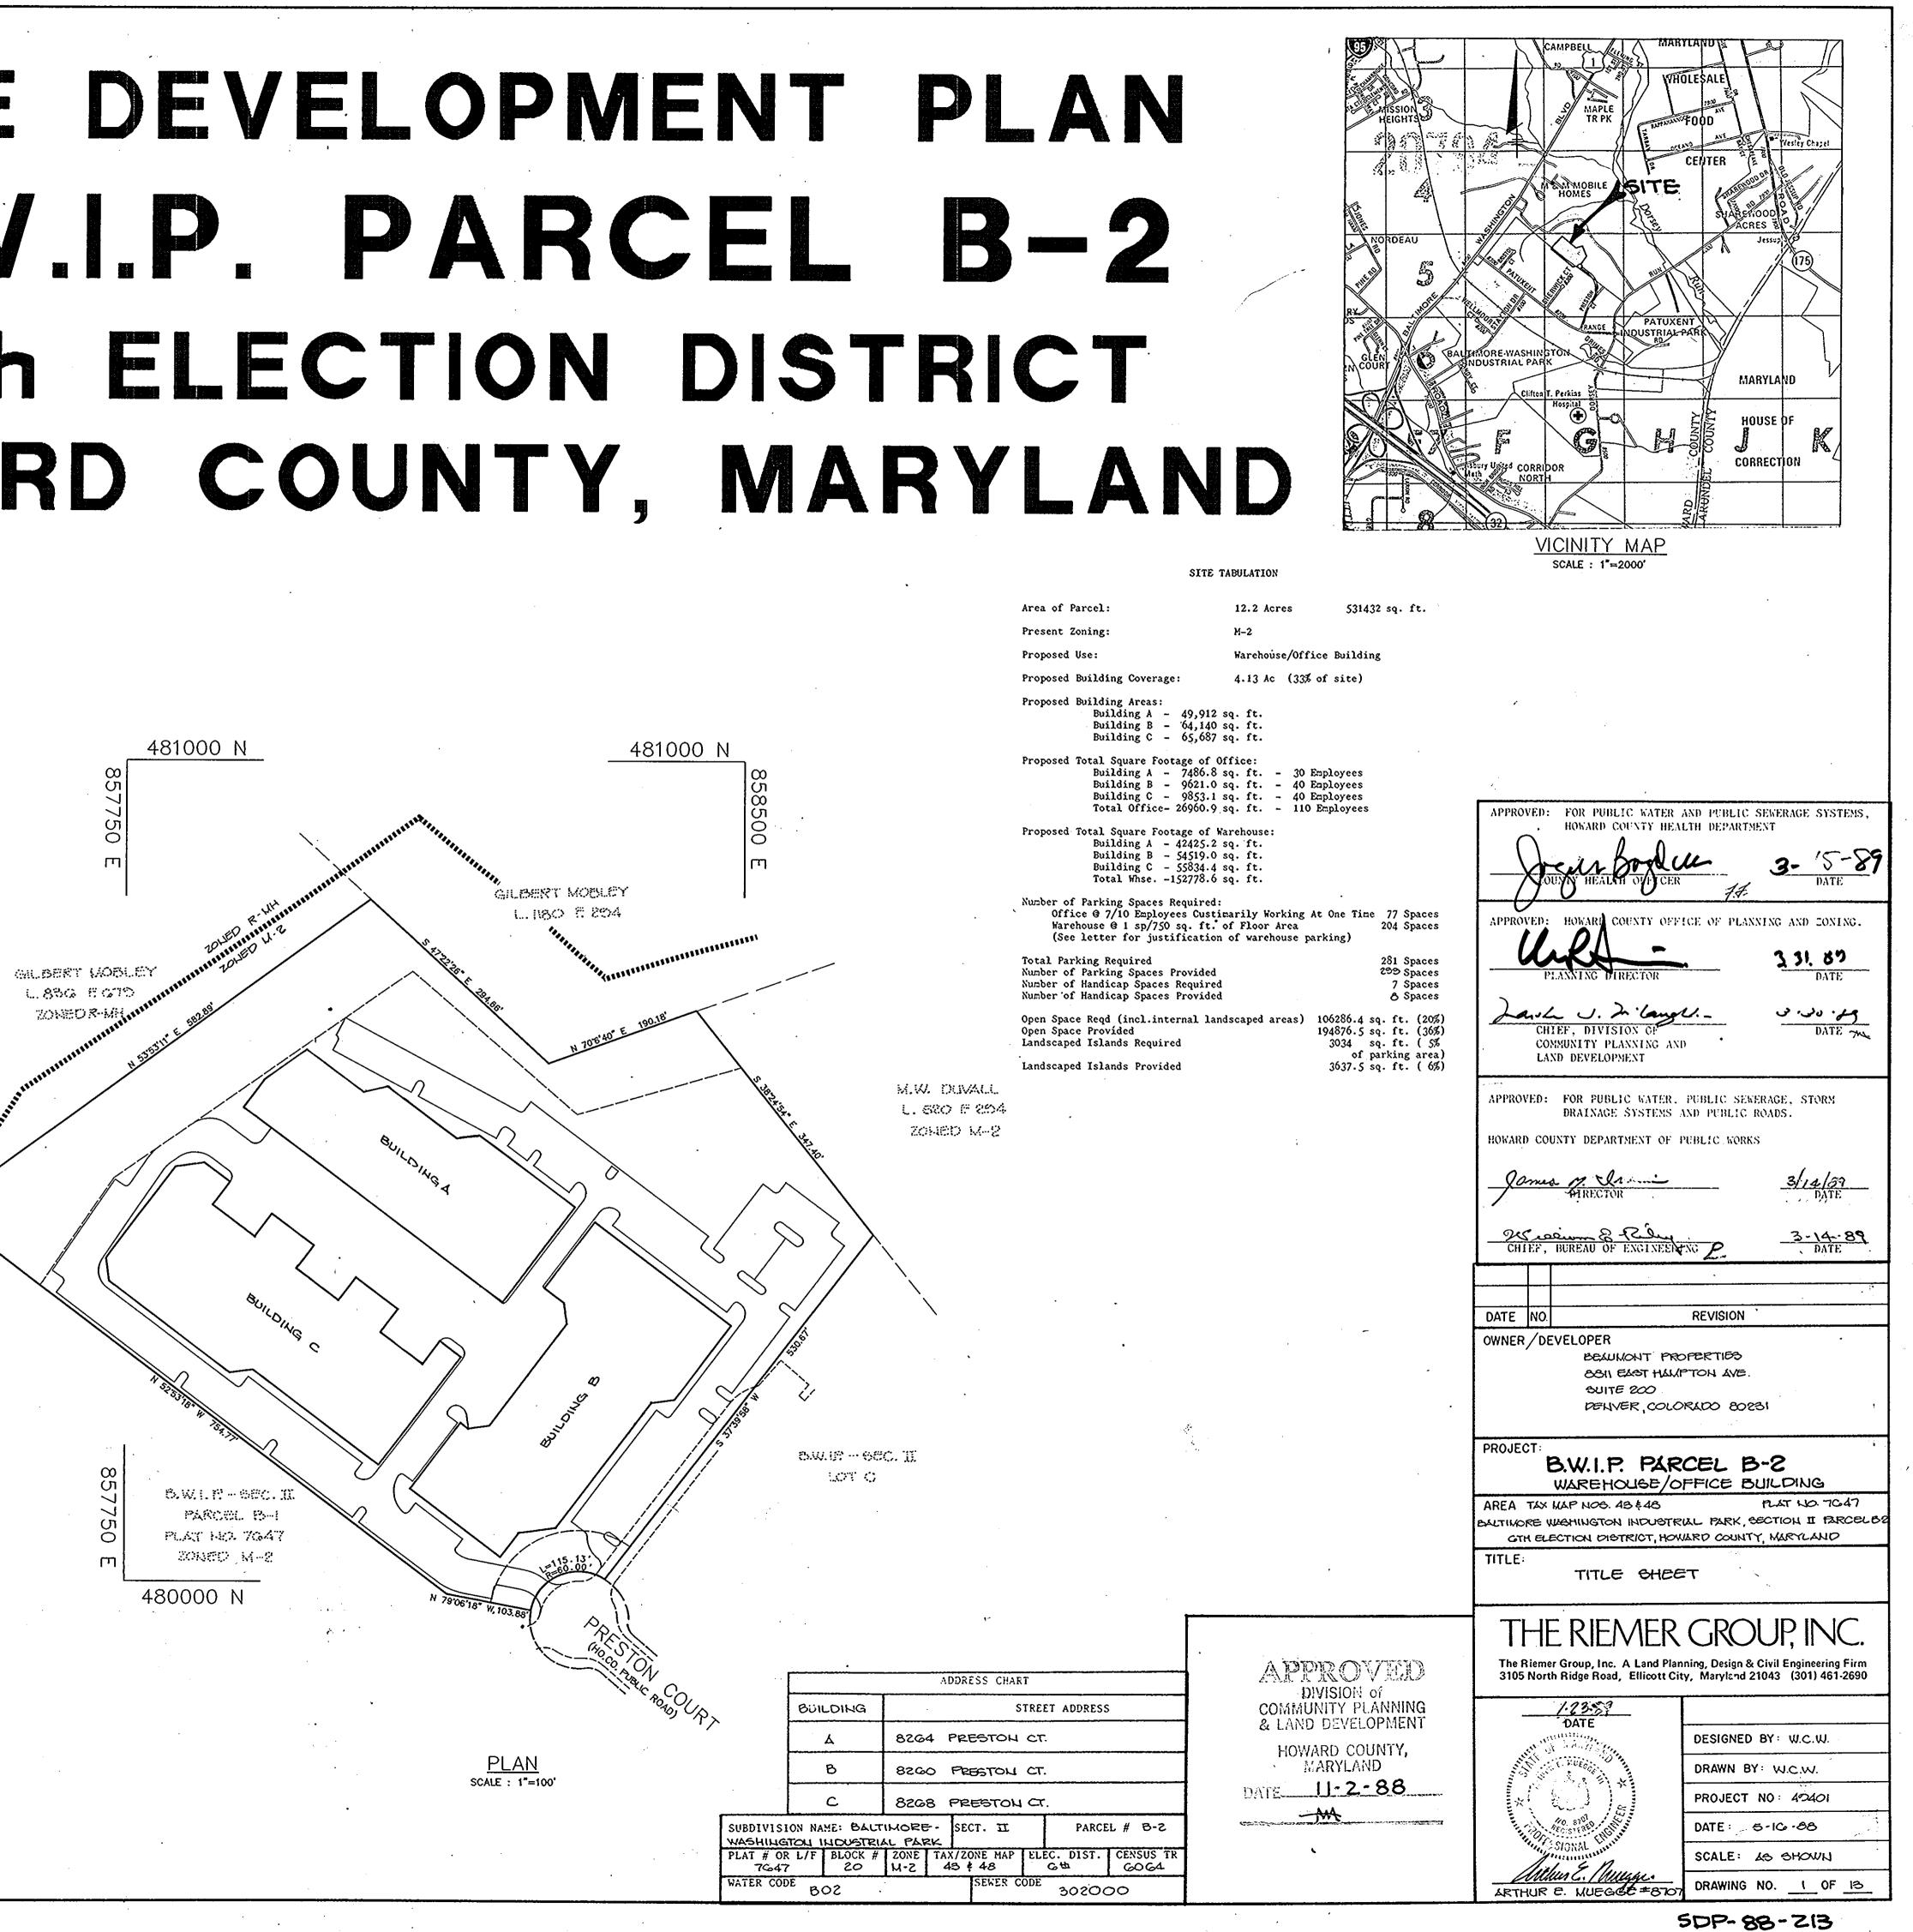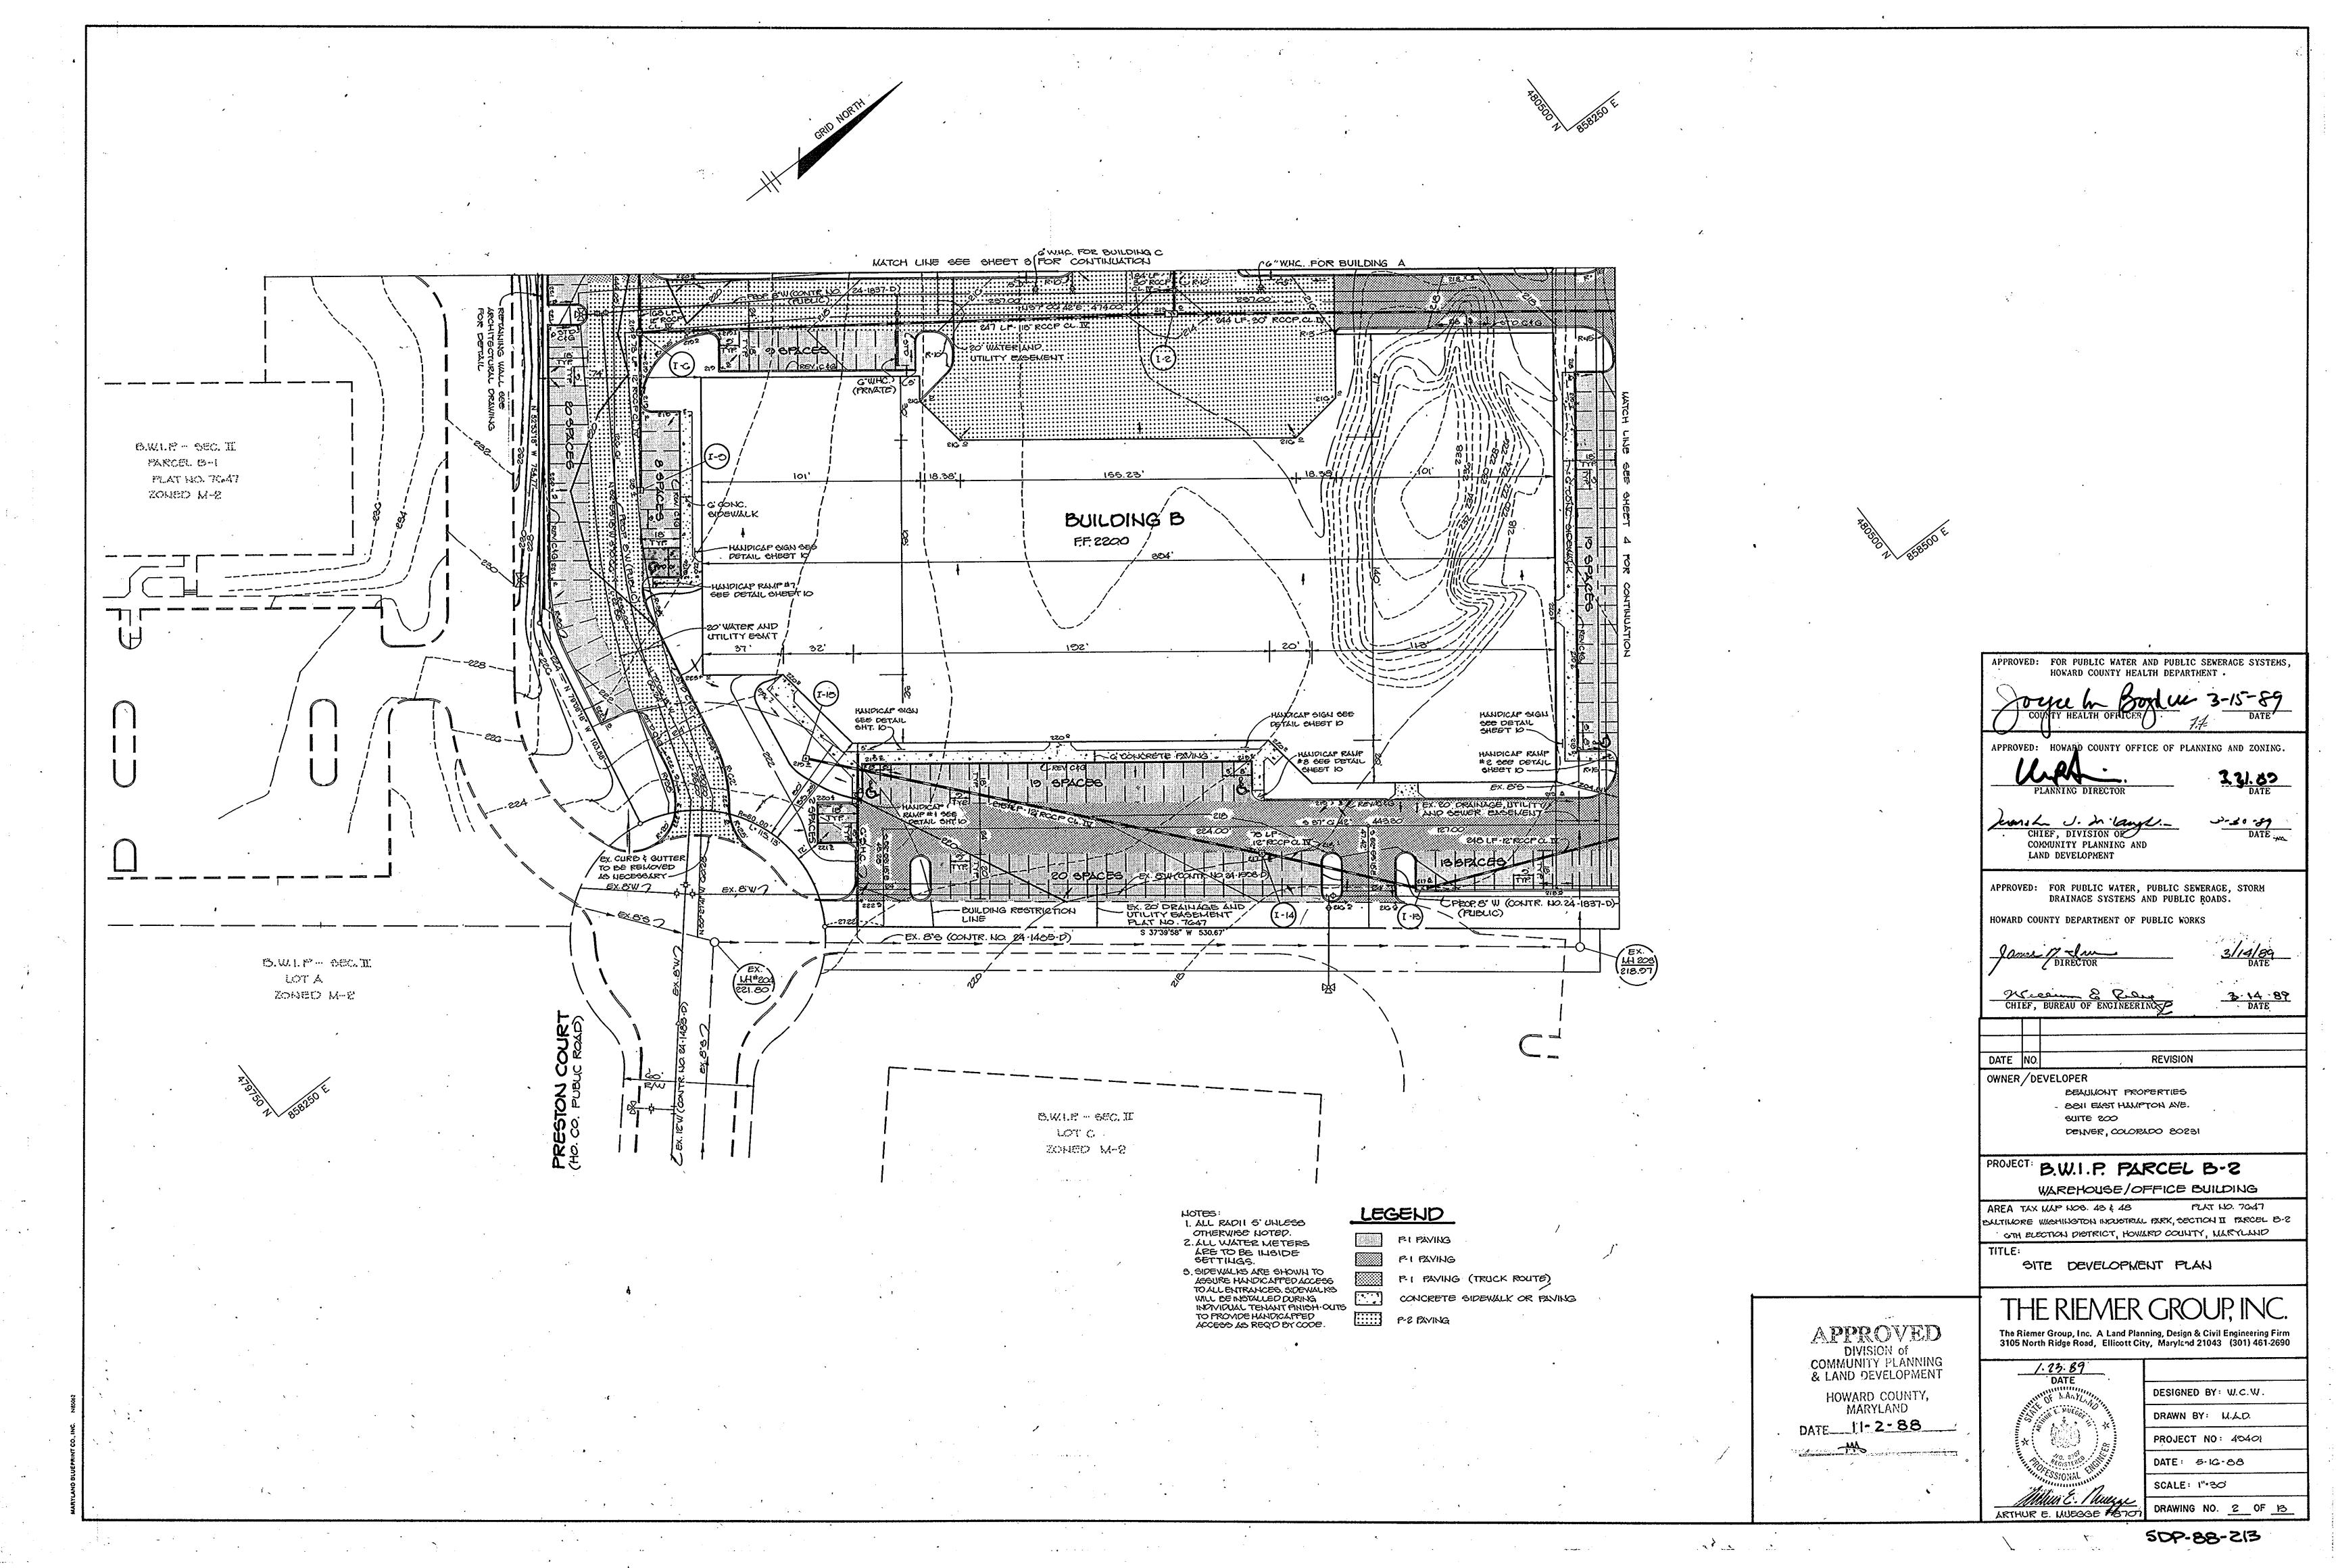

Ex. Sewer , APPROVED: FOR PUBLIC WATER AND PUBLIC SEWERAGE SYSTEMS, . HOWARD COUNTY HEALTH DEPARTMENT <u>4H#20</u> 02.8 - EX. 20' DRAINAGE, UTILITY APPROVED: HOWARD COUNTY OFFICE OF PLANNING AND ZONING. and gewer eagement FLAT NO 7047 3.31.89 GILBERT MOBLEY L.1180 F 100 SONED M-8 CHIEF, DIVISION OF COMMUNITY PLANNING AND DATE LAND DEVELOPMENT APPROVED: FOR PUBLIC WATER, PUBLIC SEWERAGE, STORM DRAINAGE SYSTEMS AND PUBLIC ROADS. - EX. 20' DRAINAGE AND UTILITY EASEMENT PLAT NO. 7647 HOWARD COUNTY DEPARTMENT OF PUBLIC WORKS <u>3/14/89</u> DATE 11 4 23 CHIEF, BUREAU OF ENGINEERING <u>3-14-89</u> DATE REVISION DATE NO. . 1 -PROPOSED TREE LINE OWNER / DEVELOPER BEAUMONT PROPERTIES 8811 EAST HAMPTON AVE. -EXISTING THEE LINE Suite 200 DENVER, COLORADO 80231 TIMAN PROJECT B.W.I.P. PARCEL B-2 WAREHOUSE / OFFICE BUILDING AREA TAX MAPNOS. 43148 PLAT NO. 7047 BALTIMORE WASHINGTON INDUSTRIAL PARK, SECTION II PARCELB GTH ELECTION DISTRICT, HOWARD COUNTY, MARYLAND TITLE BITE DEVELOPMENT PLAN THE RIEMER GROUP, INC. P.1 PAVING (TRUCK ROUTE) APPROVED The Riemer Group, Inc. A Land Planning, Design & Civil Engineering Firm 3105 North Ridge Road, Ellicott City, Maryland 21043 (301) 461-2690 CONCRETE SIDEWALK OR DIVISION OF COMMUNITY PLANNING 1.2.3.89 ZOHING ONISION LINE & LAND DEVELOPMENT DAT DESIGNED BY: W.C.W. HOWARD COUNTY, MARYLAND DRAWN' BY: M.A.D. DATE 11-2-88 PROJECT NO: 40401 DATE: 5-16-88 o'SIONM SCALE: 1":30 ARTHUR E. MORESE A BIOT DRAWING NO. 3 OF 13 5PP-88-213

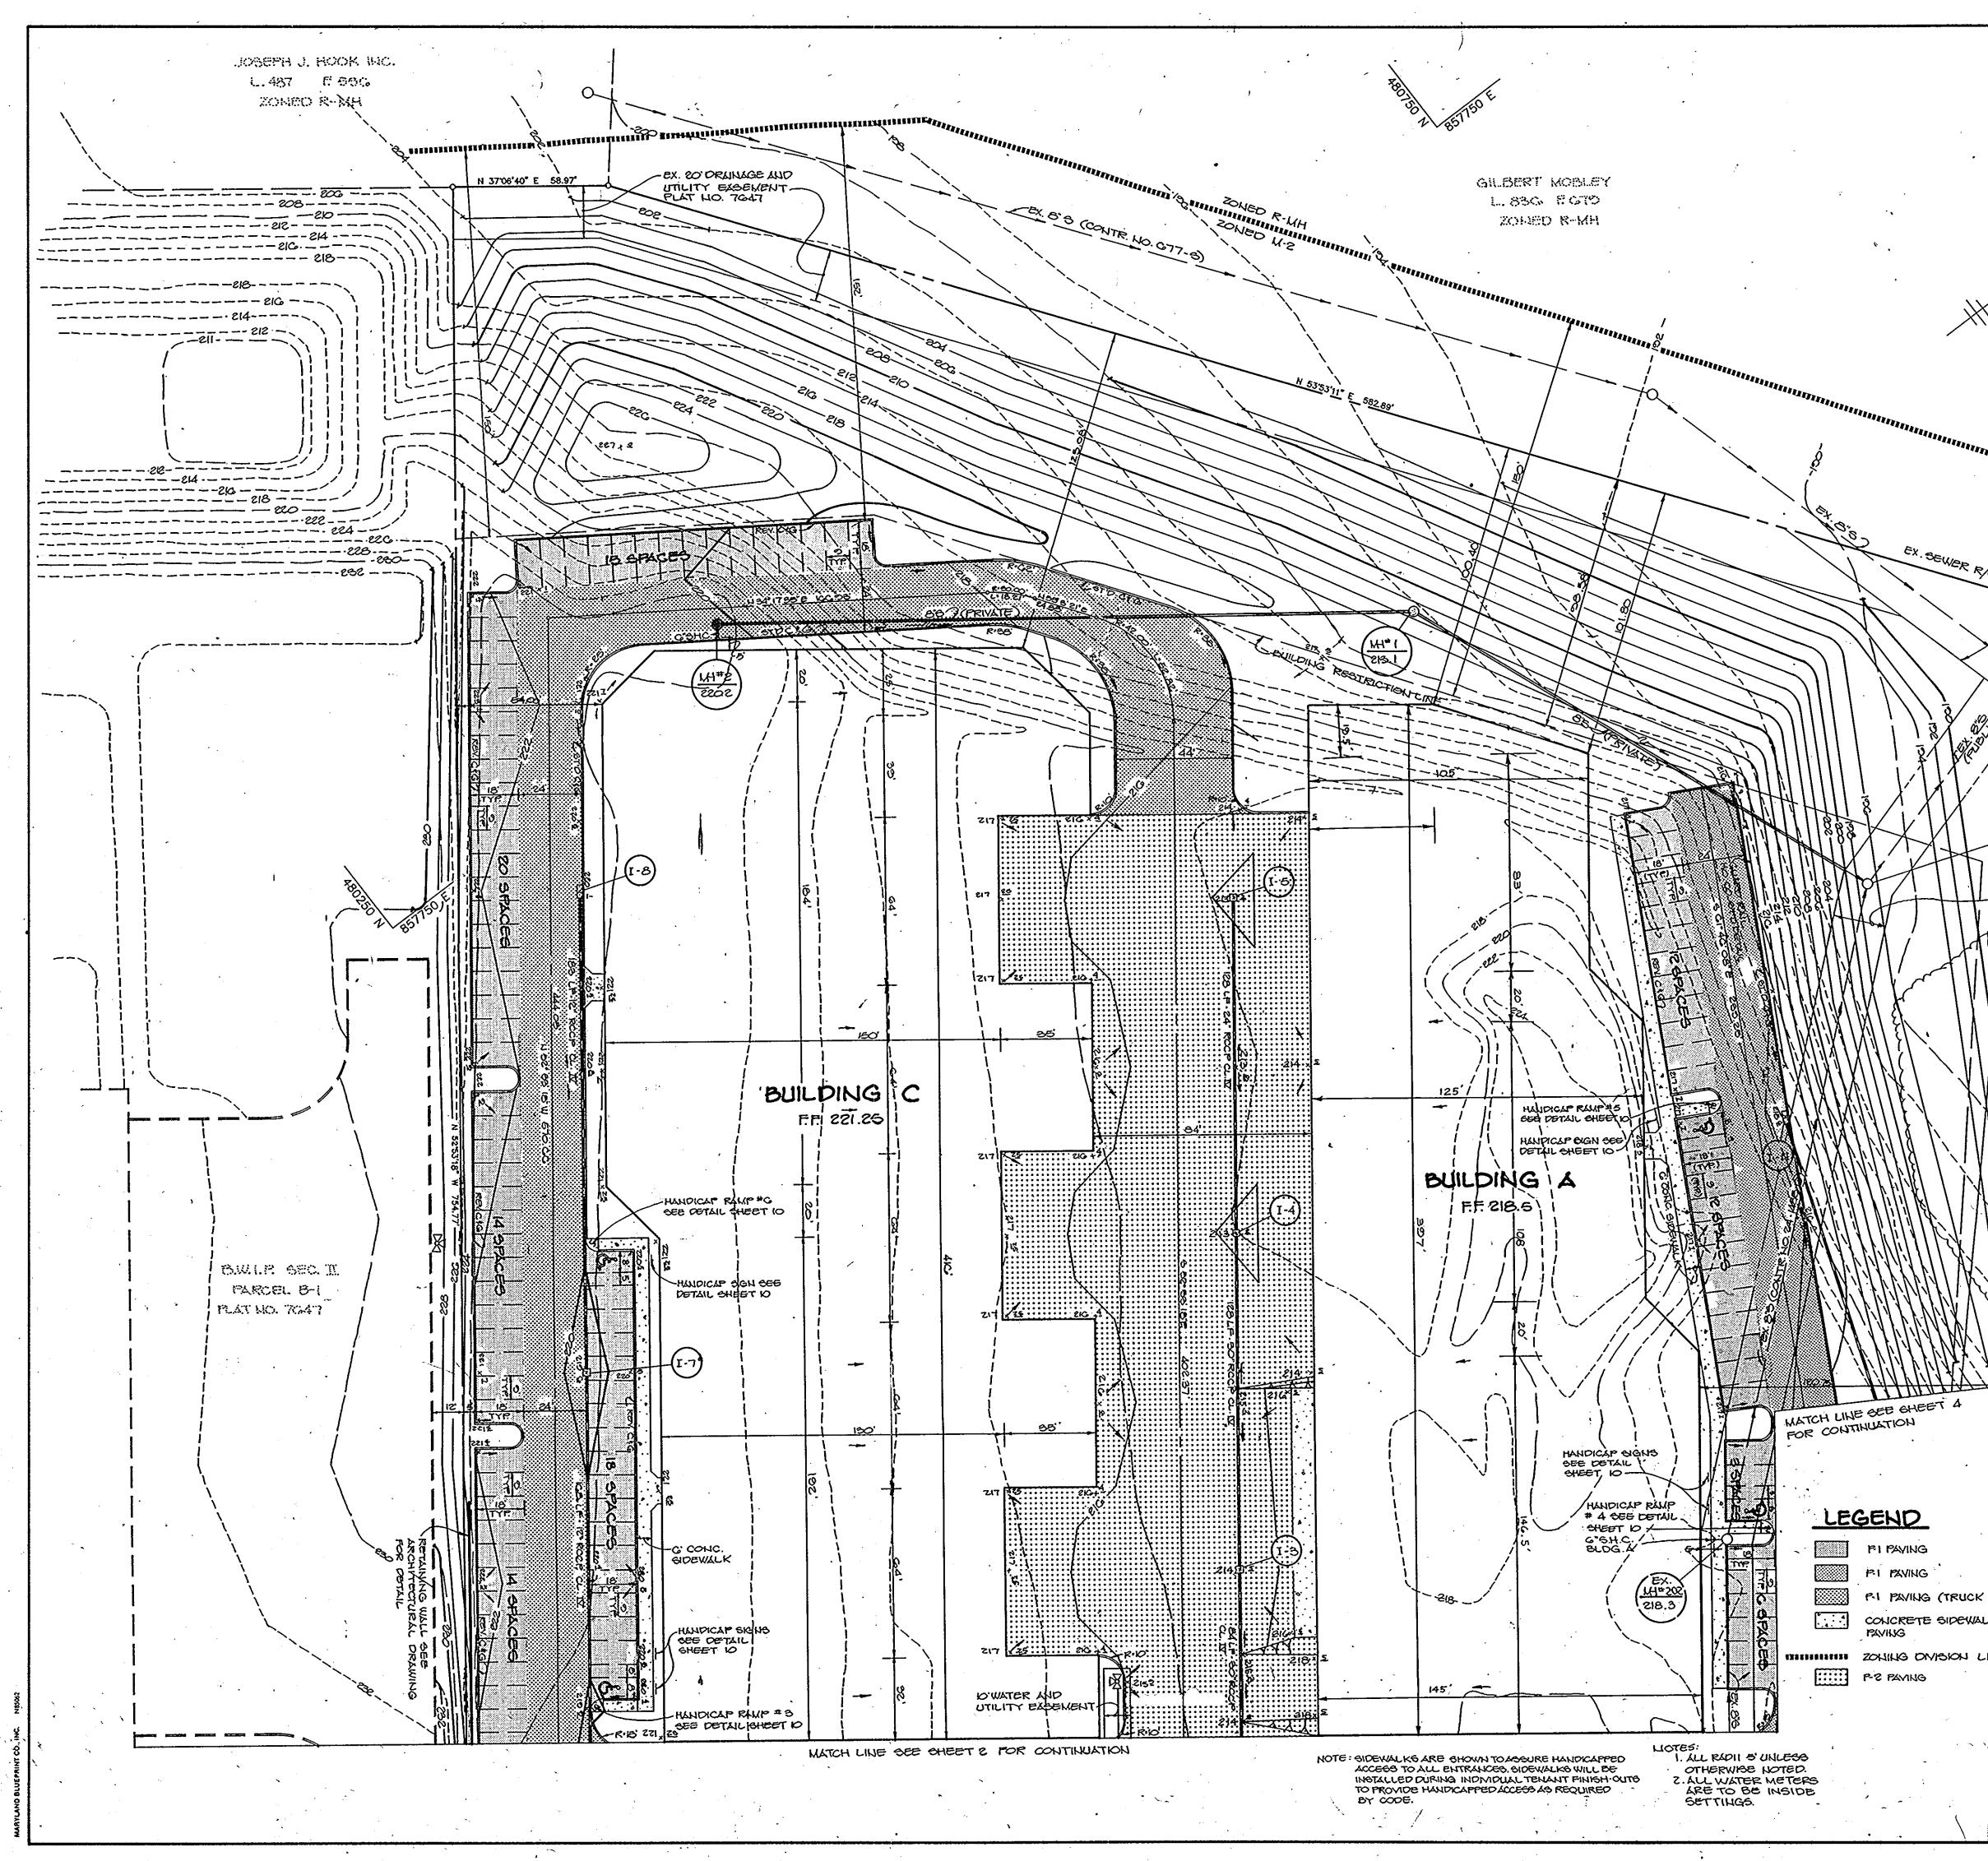


APPROVED: FOR PUBLIC WATER AND PUBLIC SEWERAGE SYSTEMS HOWARD COUNTY HEALTH DEPARTMENT HOWARD COUNTY OFFICE OF PLANNING AND ZONING. 31 より CHIEF, DIVISION OF COMMUNITY PLANNING AND LAND DEVELOPMENT مرد وی ف -----DATE -APPROVED: FOR PUBLIC WATER, PUBLIC SEWERAGE, STORM DRAINAGE SYSTEMS AND PUBLIC ROADS. HOWARD COUNTY DEPARTMENT OF PUBLIC WORKS 14/89 CHIEF, BUREAU OF ENGINEERONG <u>3-04-89</u> DATE DATE NO. REVISION OWNER/DEVELOPER BEAUMONT PROPERTIES BOILEAST HAMPTON AVE. SUITE 200 DENVER, COLORADO 80231 PROJECT: B.W.I.P. PARCEL B-2 WAREHOUSE / OFFICE BUILDING PLAT NO. 7047 AREA TAX MAP NOS. 43 \$ 48 BALTIMORE WASHINGTON INDUSTRIAL PARK, SECTION II PARCEL BE GTH ELECTION DISTRICT, HOWARD COUNTY, MARYLAND TITLE SITE DEVELOPMENT PLAN THE RIEMER GROUP, INC. The Riemer Group, Inc. A Land Planning, Design & Civil Engineering Firm 3105 North Ridge Road, Ellicott City, Maryland 21043 (301) 461-2690 APPROVED DIVISION OF MING COMMUNITY PLANNING & LAND DEVELOPMENT DESIGNED BY : W.C.W. HOWARD COUNTY, MARYLAND DRAWN BY: W.A.D. DATE 11-2-88 PROJECT NO: 49401, DATE: 5.16-88 ومحمومه مجهدت والمراجع المالية والمراجع SCALE: 1'-30' ARTHUR E. MUEGGE # 007 DRAWING NO. 4 OF 13 5DP-88-213 ••••

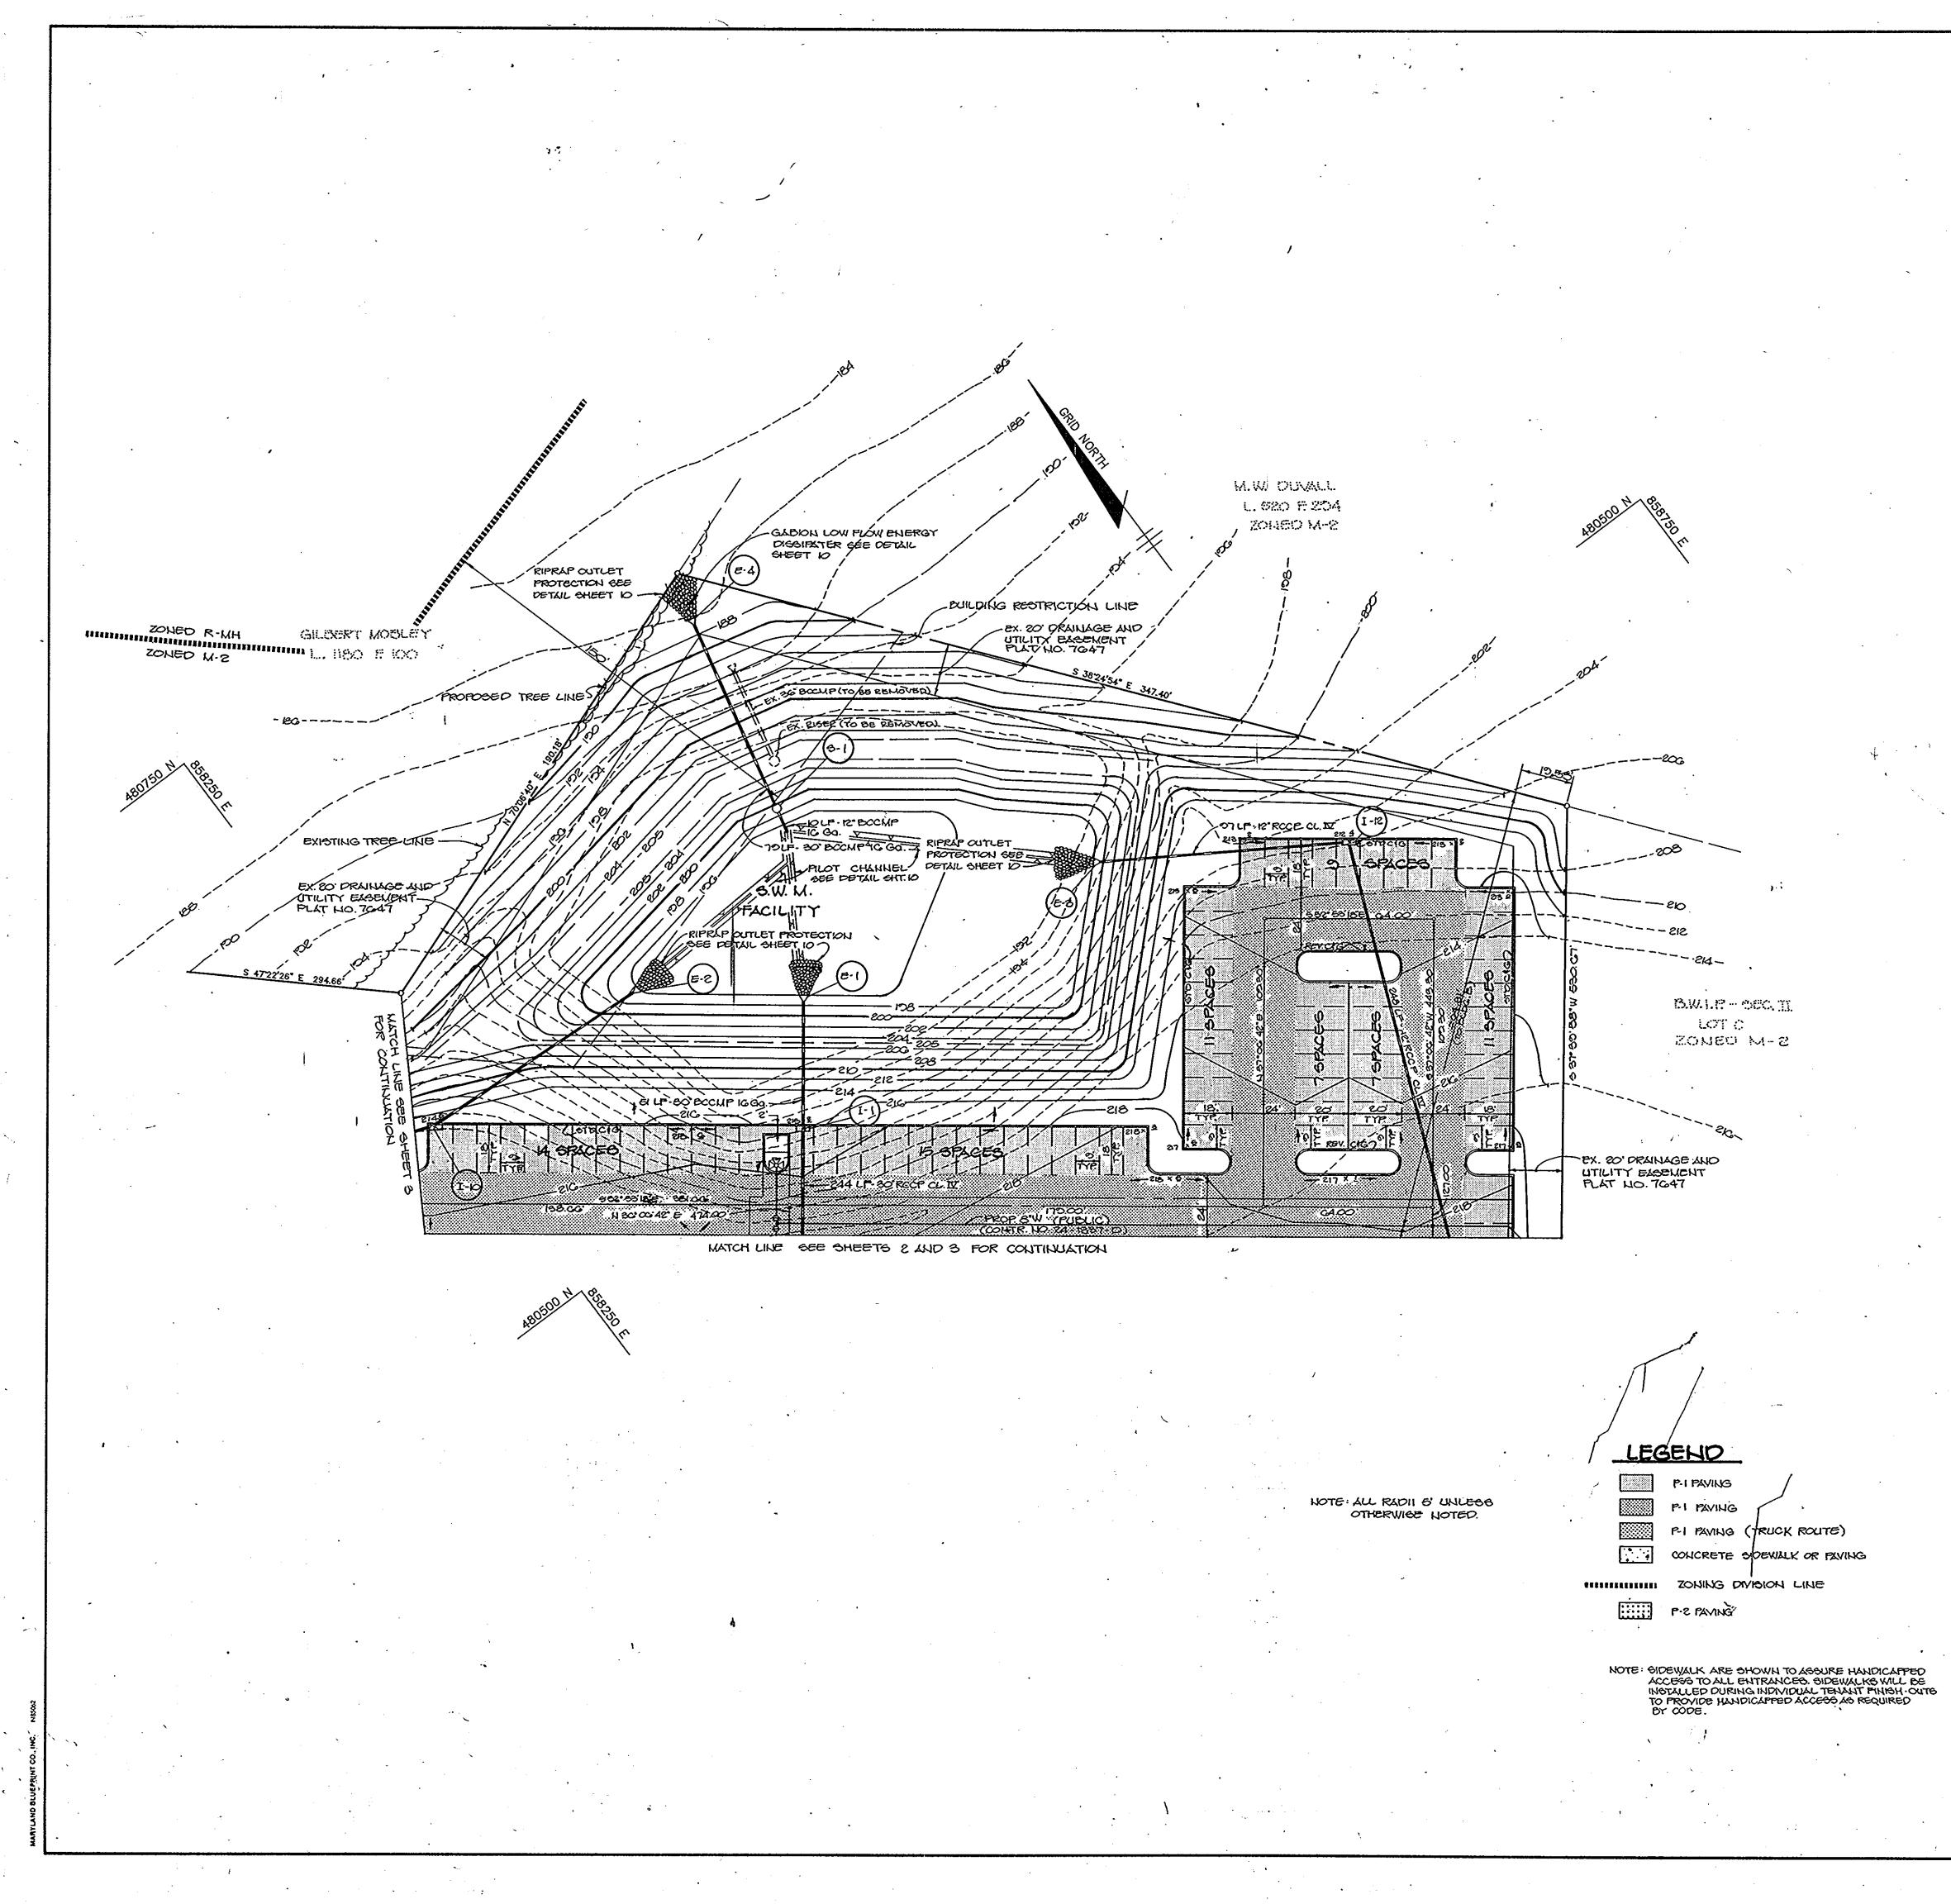

BY THE DEVELOPER: "I CERTIFY THAT ALL DEVELOPMENT AND/OR CONSTRUCTION WILL BE DONE ACCORDING TO THESE PLANS, AND THAT ANY RESPONSIBLE PERSONNEL INVOLVED IN THE CONSTRUCTION PROJECT WILL HAVE A CERTIFICATE OF ATTENDANCE AT A DEPARTMENT OF NATURAL RESOURCES APPROVED TRAINING PROGRAM FOR THE CONTROL OF SEDIMENT AND EROSION BEFORE BEGINNING THE PROJECT. I WILL PROVIDE THE HOWARD SOIL CONSERVATION DISTRICT WITH AN 'AS-BUILT' PLAN OF THE POND WITHIN 30 DAYS OF COMPLETION. I ALSO AUTHORIZE PERIODIC ON-SITE INSPECTION BY THE HOWARD SOIL CONSERVATION DISTRICT." BY THE ENGINEER: "I CERTIFY THAT THIS PLAN FOR POND CONSTRUCTION, EROSION AND SEDIMENT CONTROL REPRESENTS A PRACTICAL AND WORKABLE PLAN BASED ON MY PERSONAL KNOWLEDGE OF THE SITE CONDITIONS. THIS PLAN WAS PREPARED IN ACCORDANCE WITH THE REQUIREMENTS OF THE HOWARD SOIL CONSERVATION DISTRICT. 1 HAVE NOTIFIED THE DEVELOPER THAT HE MUST PROVIDE THE HOWARD SOIL CONSERVATION DISTRICT WITH AN 'AS-BUILT' PLAN OF THE POND WITHIN 30 DAYS OF COMPLETION." THESE PLANS RAVE BEEN REVIEWED FOR THE HOWARD SOIL CONSERVATION DISTRICT AND MEET THE TECHNICAL REQUIREMENTS SMALL POND CONSTRUCTION, SOIL EROSION AND SEDIMENT THESE PLANS FOR SMALL POND CONSTRUCTION, SOIL EROSION AND SEDIMENT CONTROL MEET THE REQUIREMENTS OF THE HOWARD, SOIL CONSERVATION DISTRICT APPROVED APPROVED: FOR PUBLIC WATER AND PUBLIC SEWERAGE SYSTEMS. HOWARD COUNTY HEALTH DEPARTMENT COUNTY OFFICE OF PLANNING AND ZONING. 3.31 87 CHIEF. DIVISION OF DATE AN COMMUNITY PLANNING AND LAND DEVELOPMENT APPROVED: FOR FUBLIC WATER, PUBLIC SEWERAGE, STORM DRAINAGE SYSTEMS AND PUBLIC ROADS. HOWARD COUNTY DEPARTMENT OF PUBLIC WORKS 3/13/89 · DATE Vanies. 3-14-89 DATE CHIEF, BUREAU OF ENCINEERIN REVISION DATE NO OWNER, DEVELOPER BEAUMONT PROPERTIES 8811 EAST HAMPTON AVE. GUITE 200 DENVER, COLORADO 80231 PROJECT B.W.I.P. PARCEL B-2 WAREHOUSE OFFICE BUILDING PLAT NO. 7047 AREA TAX WAP NOB 43 \$ 48 BALTINORE WASHINGTON INCUSTRIAL PARK, SECTION II PARCEL B-2 GTH ELECTION DISTRICT, HOWERD COUNTY, MERYLEND TITLE GRADING, SEDIMENT CONTROL AND DRAIHAGE AREA MAP. THE RIEMER GROUP, INC. **APPROVED** The Riemer Group, Inc. A Land Planning, Design & Civil Engineering Firm 3105 North Ridge Road, Ellicott City, Maryland 21043 (301) 461-2690 **DIVISION** of **COMMUNITY PLANNING** 1-23-89 DATE & LAND DEVELOPMENT DESIGNED BY W.C.W. HOWARD COUNTY, MARYLAND DRAWN BY W.C.W. DATE 11-2-88 PROJECT NO 40401 DATE 5.10-88 SCALE: 1"- 30' ARTHUR E. MUEGGE \$ 5107 DRAWING NO. 5 OF 13

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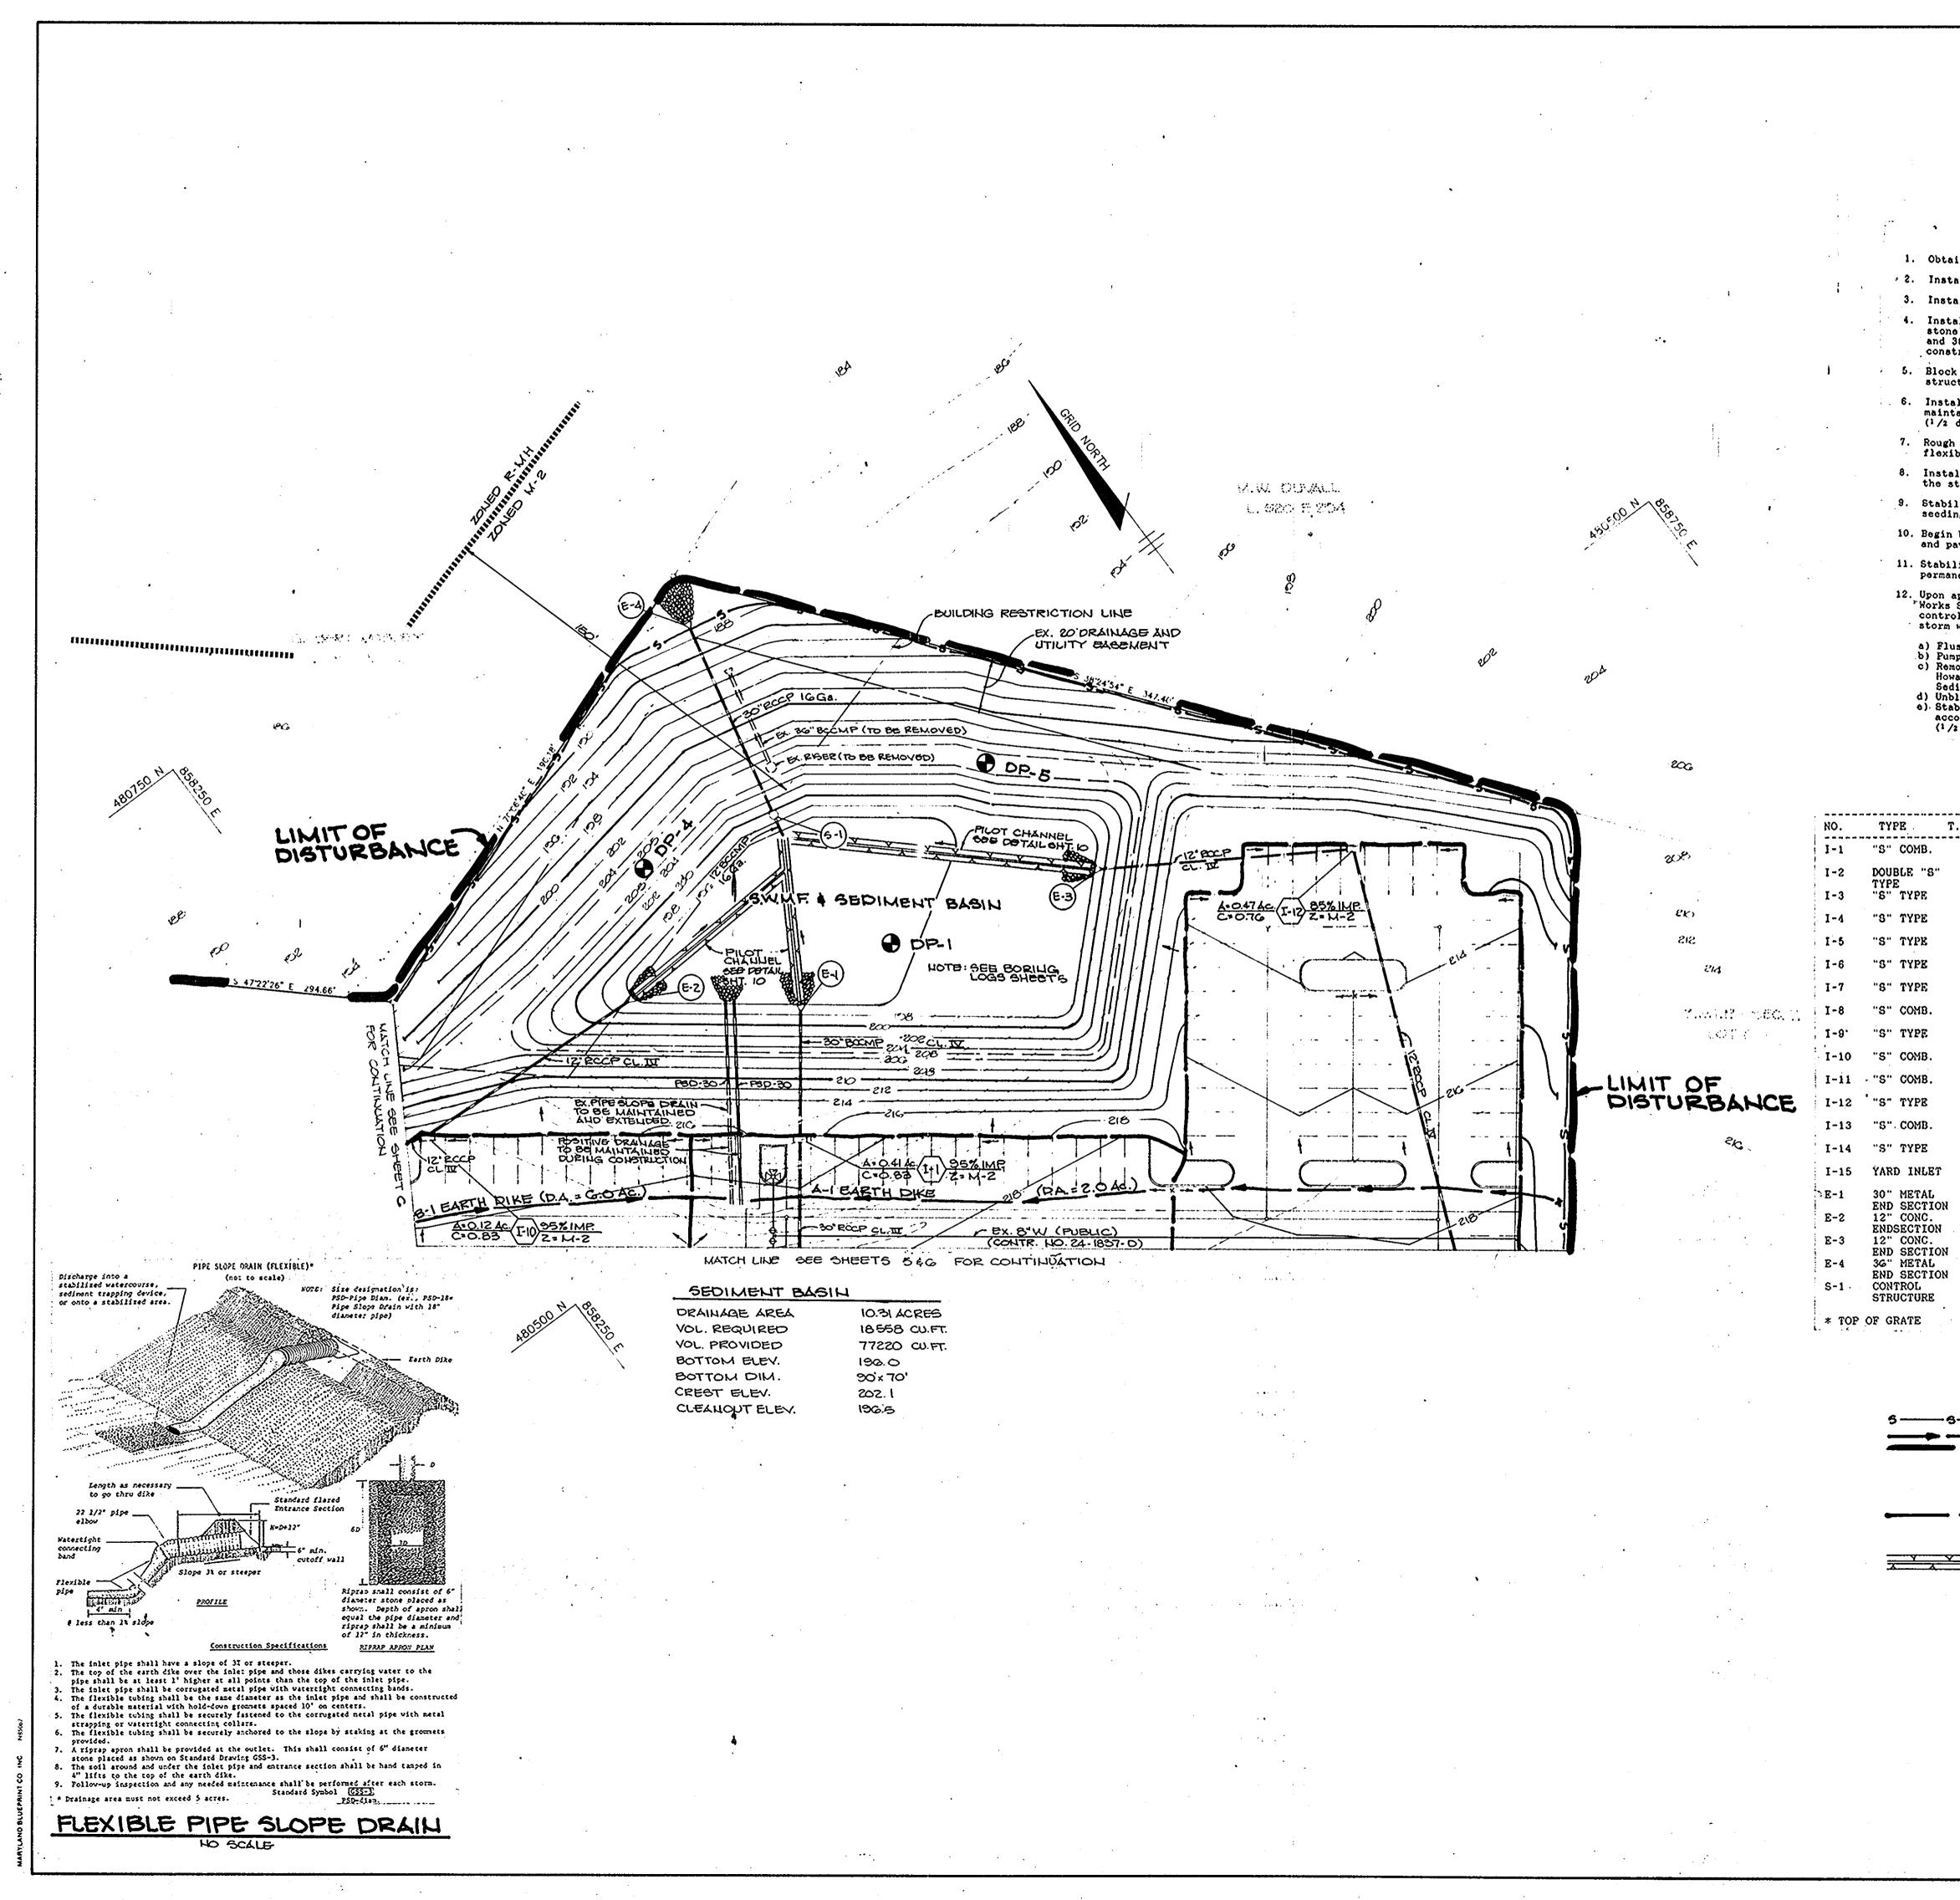
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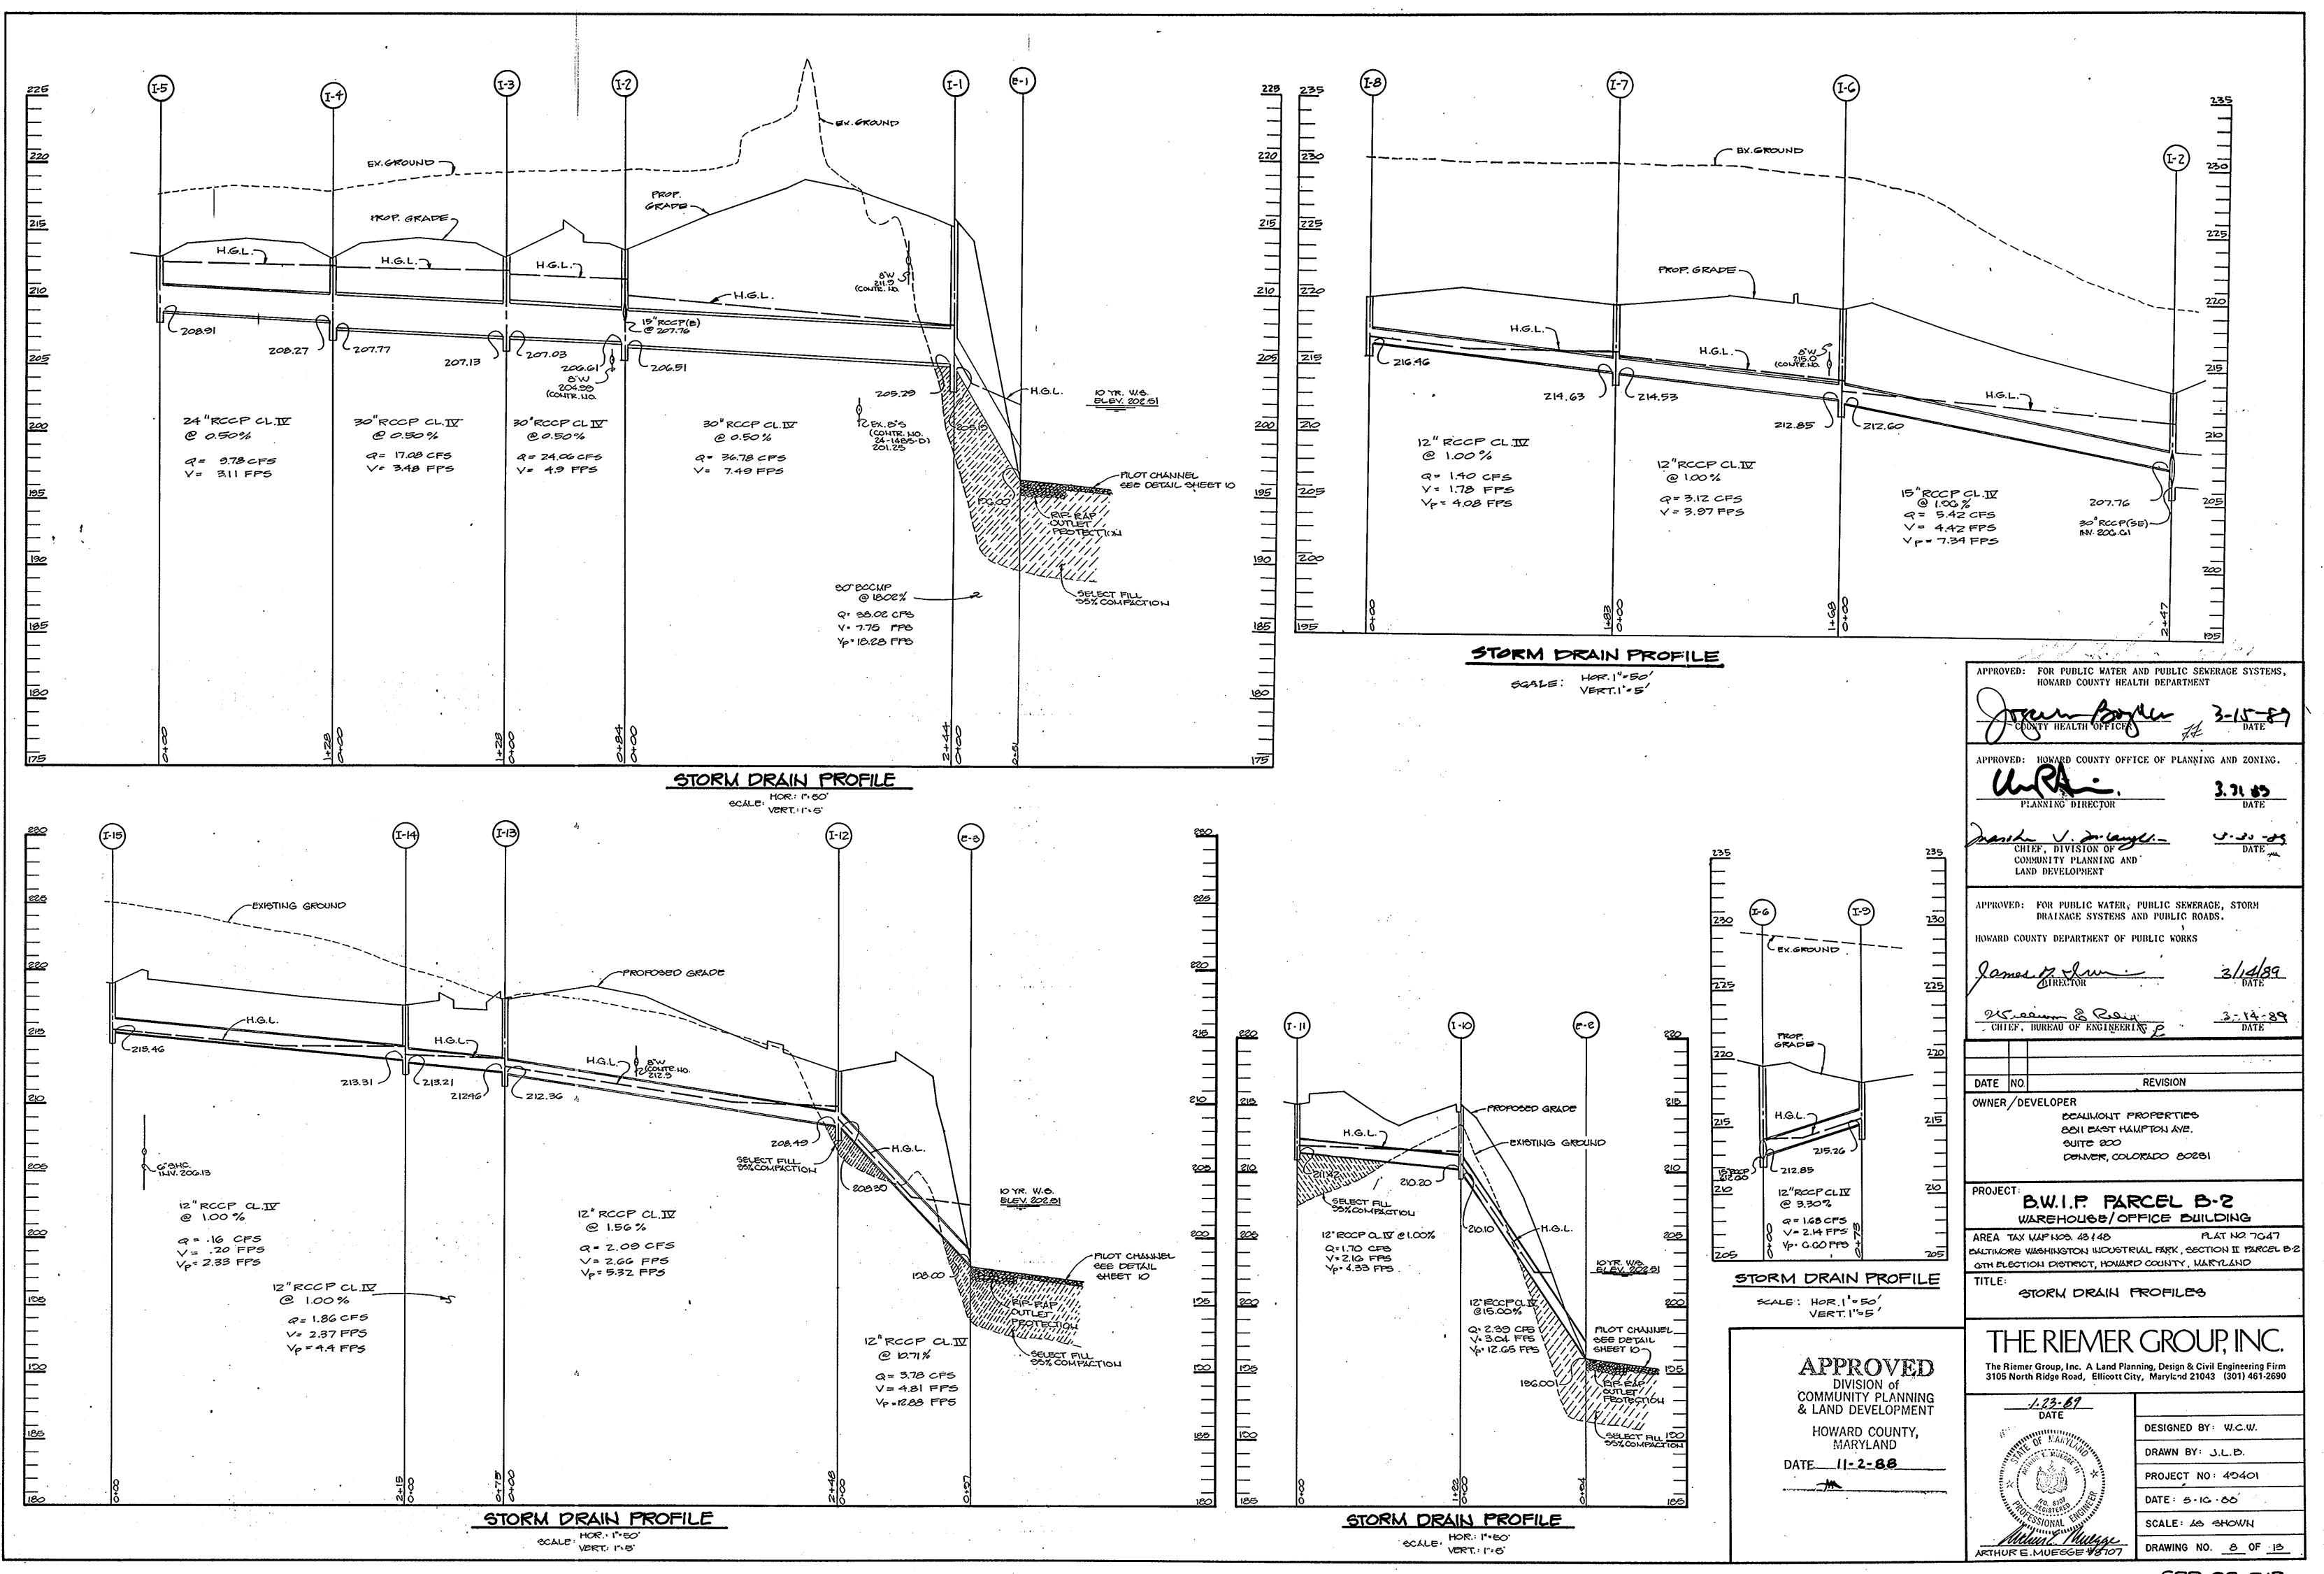
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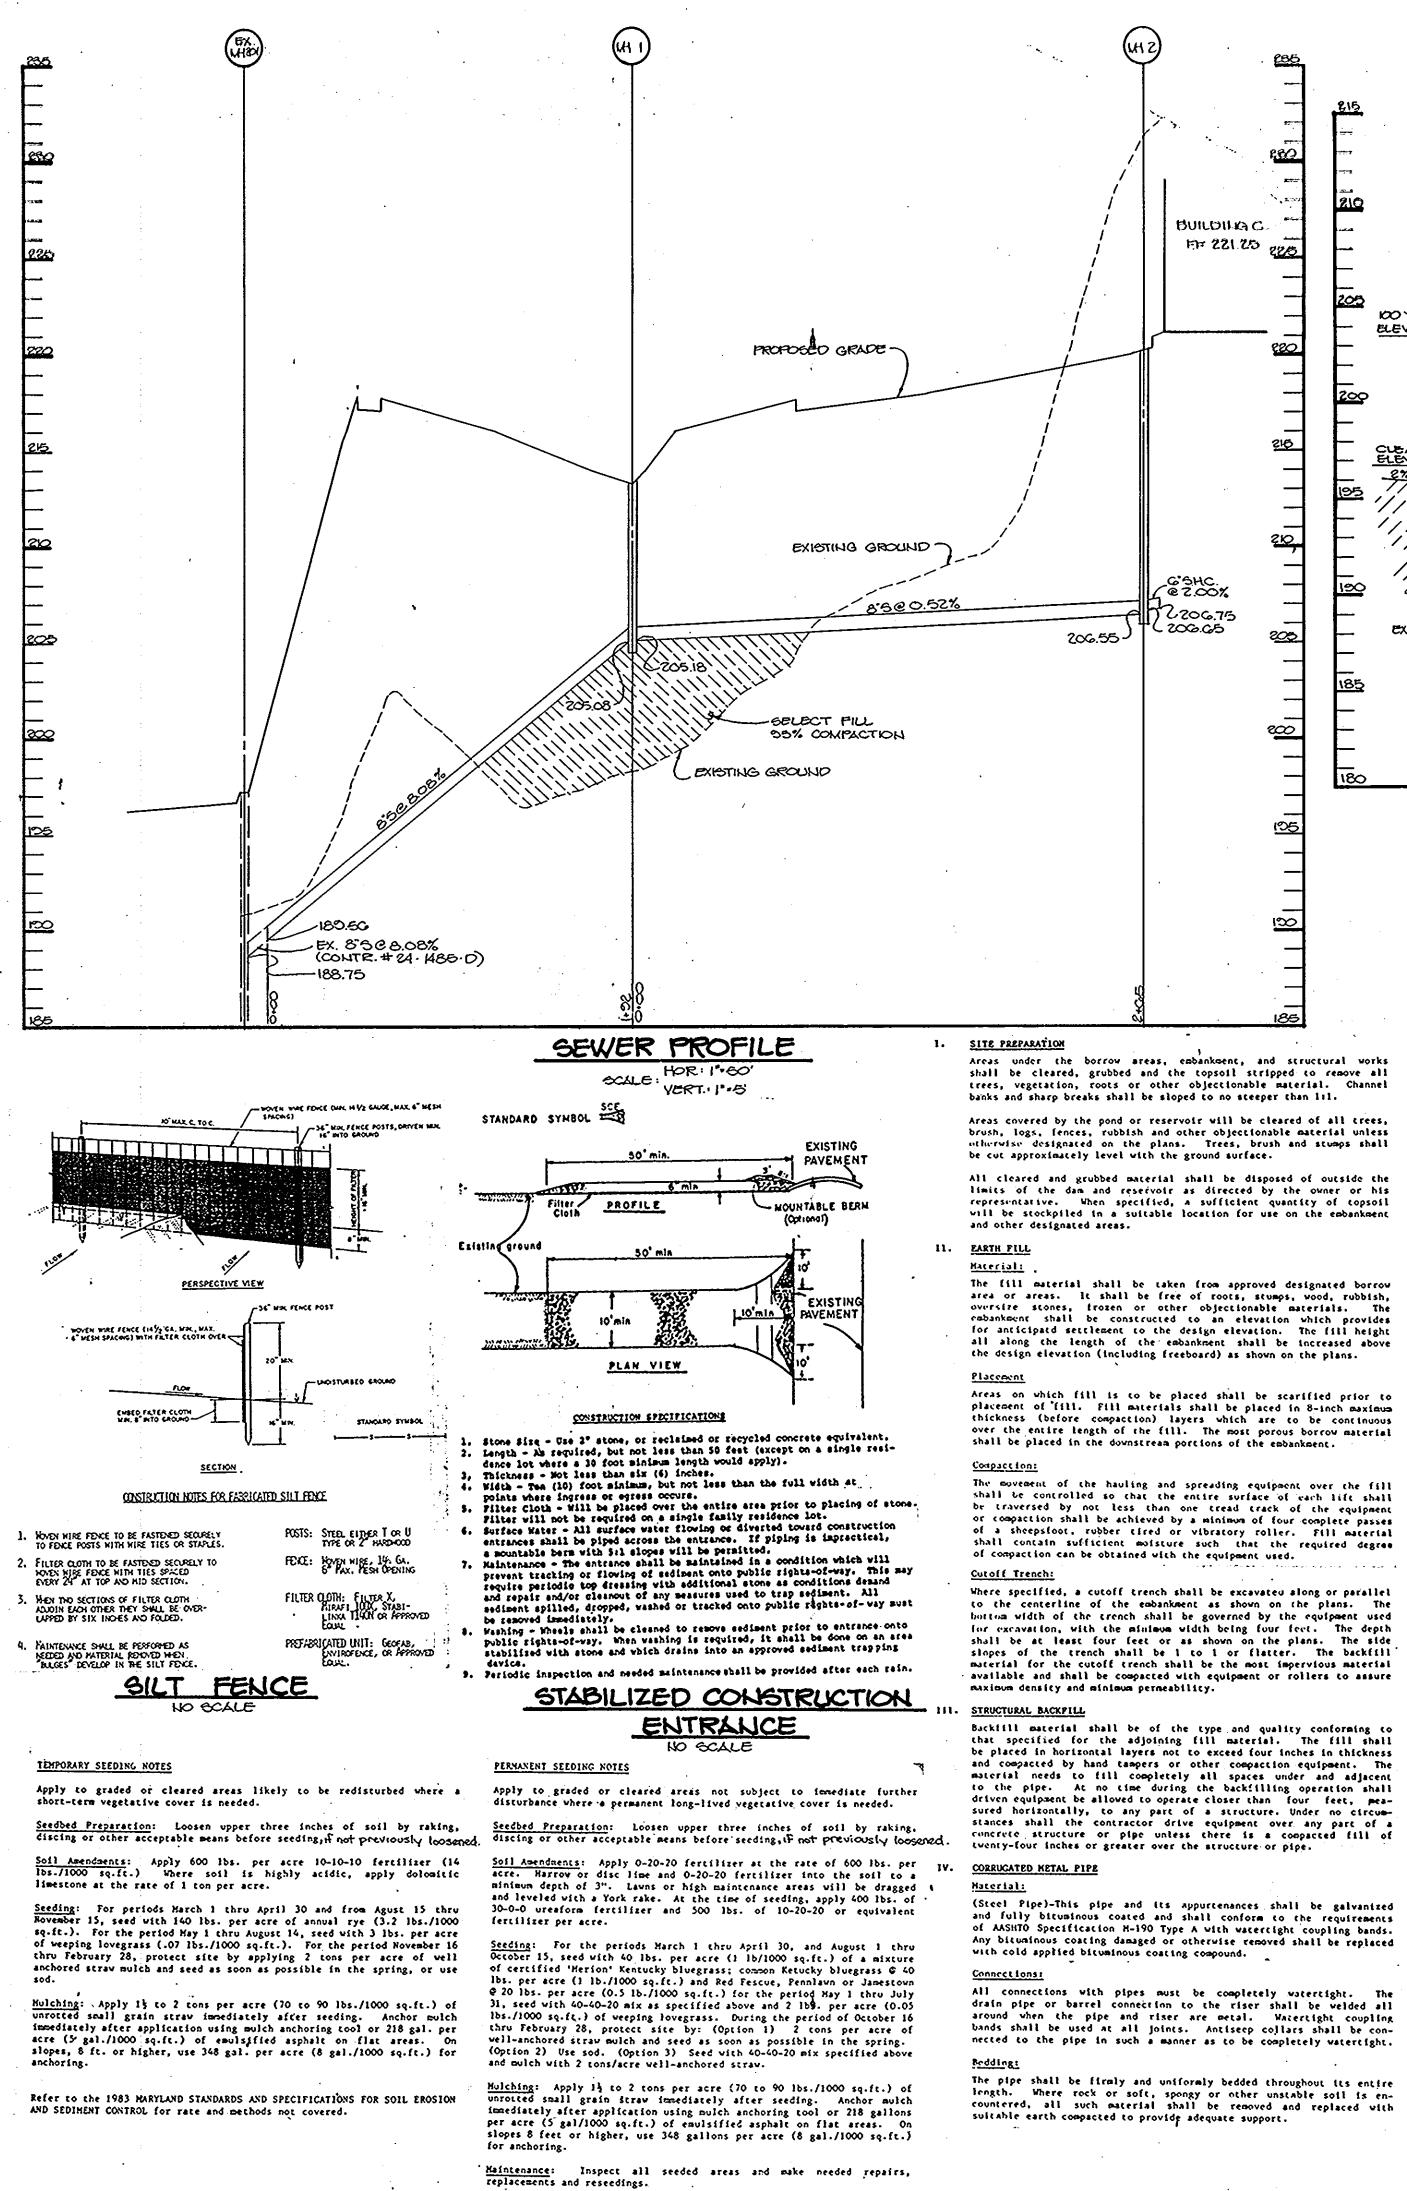



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Block 2-Year low-flow orifice on the control AND SEDIMENT CONTROL REPRESENTS A PRACTICAL AND WORKABLE structure during the sediment control phase. (1/2 day) PLAN BASED ON MY PERSONAL KNOWLEDCE OF THE SITE 6. Install flexible pipe slope drains and earth dikes, and maintain and extend existing flexible pipe slope drain. CONDITIONS. THIS PLAN WAS PREPARED IN ACCORDANCE WITH THE REQUIREMENTS OF THE HOWARD SOIL CONSERVATION DISTRICT. HAVE NOTIFIED THE DEVELOPER THAT HE MUST PROVIDE THE 7. Rough grade site maintaining positive drainage for the flexible pipe slope drains and earth dikes. (15 days) HOWARD SOIL CONSERVATION DISTRICT WITH AN 'AS-BUILT' PLAN OF THE POND WITHIN 30 DAYS OF COMPLETION." 8. Install water, sewer and storm drains. Upon completion of the storm drains remove flexible pipe slope drains. (15 days) i 9. Stabilize the graded area in accordance with the temporary seeding notes. (1/2 day) 10. Begin building construction and install curb and gutter and paving. (15 days) 11. Stabilize all disturbed areas in accordance with the THESE PLANS HAVE BEEN REVIEWED FOR THE HOWARD SOIL permanent seeding notes. (1 day) CONSERVATION DISTRICT AND MEET THE TECHNICAL REQUIREMENTS 12. Upon approval of the Howard County Department of Public Works Sediment Control Inspector, remove all sediment control devices and convert sediment control basin to storm water management facility as follows : FOR SMALL POND CONSTRUCTION, SOIL EROSION AND SEDIMENT CONTR a) Flush storm drain system. (1/2 day) b) Pump out impounded water. (1/2 day) c) Remove sediment and place as directed by the Howard County Department of Public Works Sediment Control Inspector. (1/2 day) Unblock low flow orifice. (1/2 day) e). Stabilize the remaining disturbed areas in PLANS FOR SMALL POND CONSTRUCTION, SOIL EROSION AND accordance with the permanent seeding notes. MENT CONTROL MEET THE REQUIREMENTS OF THE HOWARD SOIL $(1/2 \, day)$ CONSERVATION DISTRICT. VPPROVE HOWARD STRUCTURE SCHEDULK APPROVED: FOR PUBLIC WATER AND PUBLIC SEWERAGE SYSTEMS, REMARKS T.C. ELEY. INV. IN. INV.OUT HOWARD COUNTY HEALTH DEPARTMENT 205.29 205.19 HO.CO. STD. DTL. SD-4.32 215.8 515-85 HO.CO. STD. DTL. SD-4.23 *213.5 206.61 206.51 HO.CO. STD. DTL. SD-4.22 *212.9 207.13 207.03 HO.CO. STD. DTL. SD-4.22 *212.9 207. DACOUNTY OFFICE OF PLANNING AND ZONING. HO.CO. STD. DTL. SD-4.22 *212.9 ----208.91 51.87 HO.CO. STD. DTL. SD-4.22 *219.5 212.85 212.6 212.85 HO.CO. STD. DTL. SD-4.22 *219.6 214.53 214.63 HO.CO. STD. DTL. SD-4.32 CHIEF, DIVISION OF 216.46 A. S. O. J. 220.7 HO.CO. STD. DTL. SD-4.22 COMMUNITY PLANNING AND LAND DEVELOPMENT HO.CO. STD. DTL. SD-4.32 210.10 HO.CO. STD. DTL. SD-4.32 215.7 ----211.42 APPROVED: FOR PUBLIC WATER, PUBLIC SEWERAGE, STORM HO.CO. STD. DTL. SD-4.22 DRAINAGE SYSTEMS AND PUBLIC ROADS. HO.CO. STD. DTL. SD-4.32 218.4 212.46 212.36 HOWARD COUNTY DEPARTMENT OF PUBLIC WORKS HO.CO. STD. DTL. SD-4.22 *217.3 213.31 213.21 HO.CO. STD. DTL. SD-4.14 3/14/89 *219.0 ---215.46 ames VI NUL HO.CO. STD. DTL. SD-5.61 ---HO.CO. STD. DTL. SD-5,51 ---196.00 ---CHIEF, BUREAU OF ENGINEERING P <u>3-14-89</u> DATE HO.CO. STD. DTL. SD-5.51 ----198.00 HO.CO. STD. DTL. SD-5.61 ---186.82 ---SEE DETAIL SHEET NO. 9 DATE NO REVISION OWNER / DEVELOPER BEAUMONT PROPERTIES 8811 EAST HAMPTON AVE. SUITE 200 LEGEND DELIVER, COLORADO 80231 **GILT FENCE** PROJECT EARTH DIKE LIMIT OF DISTURBANCE B.W.I.P. PARCEL B-2 WAREHOUSE/OFFICE BUILDING STABILIZED CONSTRUCTION ENTRANCE 6.C.E. PLAT NO 7047 AREA TAX MAP NOS. 43 \$ 48 BALTIMORE WASHINGTON INDUSTRIAL PARK, SECTION II PARCEL BA DRAILLAGE AREA LINES GTH ELECTION DISTRICT, HOWARD COUNTY, MARYLAND SOIL BORING LOCATION TITLE GRADING, SEDIMENT CONTROL PILOT CHANNEL AND DRAINAGE AREA MAP ZONING DIVISION LINE BIEDEDELEDELEEEEEEEEEEEEE THE RIEMER GROUP, INC. APPROVED The Riemer Group, Inc. A Land Planning, Design & Civil Engineering Firm 3105 North Ridge Road, Ellicott City, Maryland 21043 (301) 461-2690 DIVISION of AMODMC COMMUNITY PLANNING 1.23.89 & LAND DEVELOPMENT DATE DESIGNED BY: W.C.W. HOWARD COUNTY, MARYLAND DRAWN BY W.C.W. DATE 11-2-88 PROJECT NO: 49401 2012/02/02/02/02 DATE: 5-16-88 SCALE: 1= 30 Michun E. / Mulig DRAWING NO. 7 OF 13 AETHUR E. MUEGGE \$8707 5DP-88-213

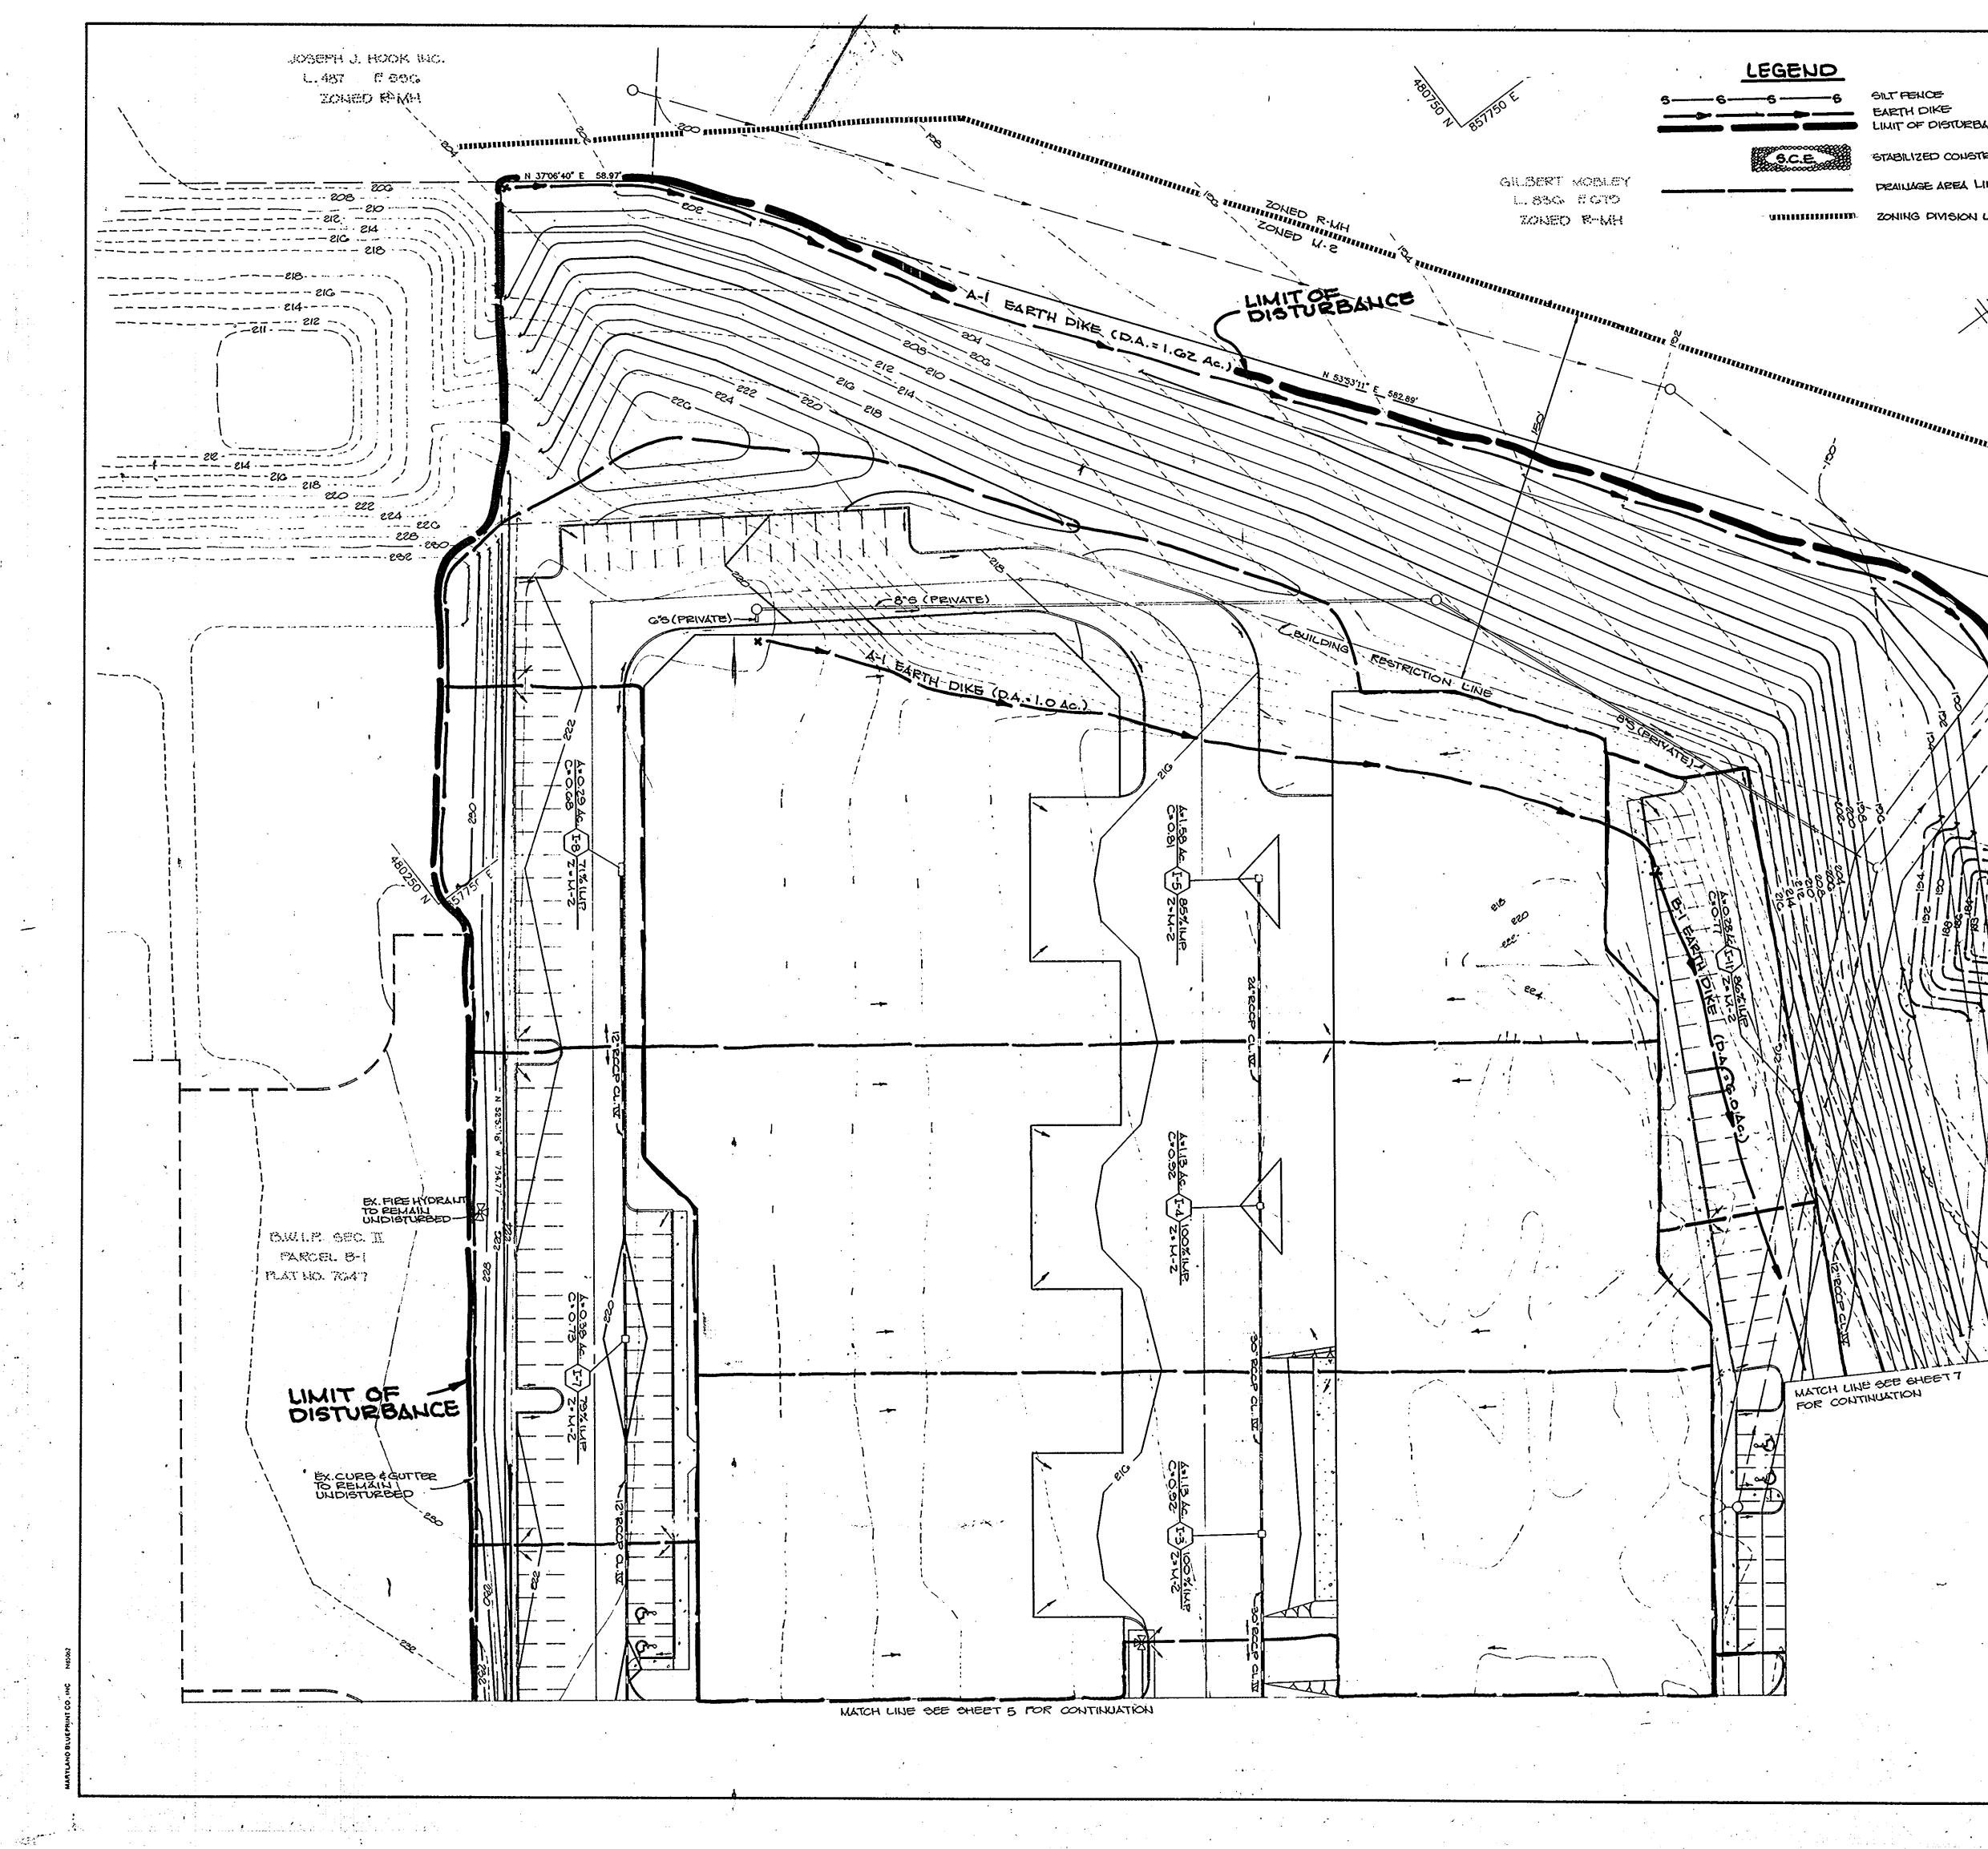

AND BLUEPRINT CO., II

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Haterial

Cement - Normal Portland ASTM Specification C-150. Water - The water used in concrete shall be clean, free from oil, acid, alkali, scales, organic matter or other objectionable substances

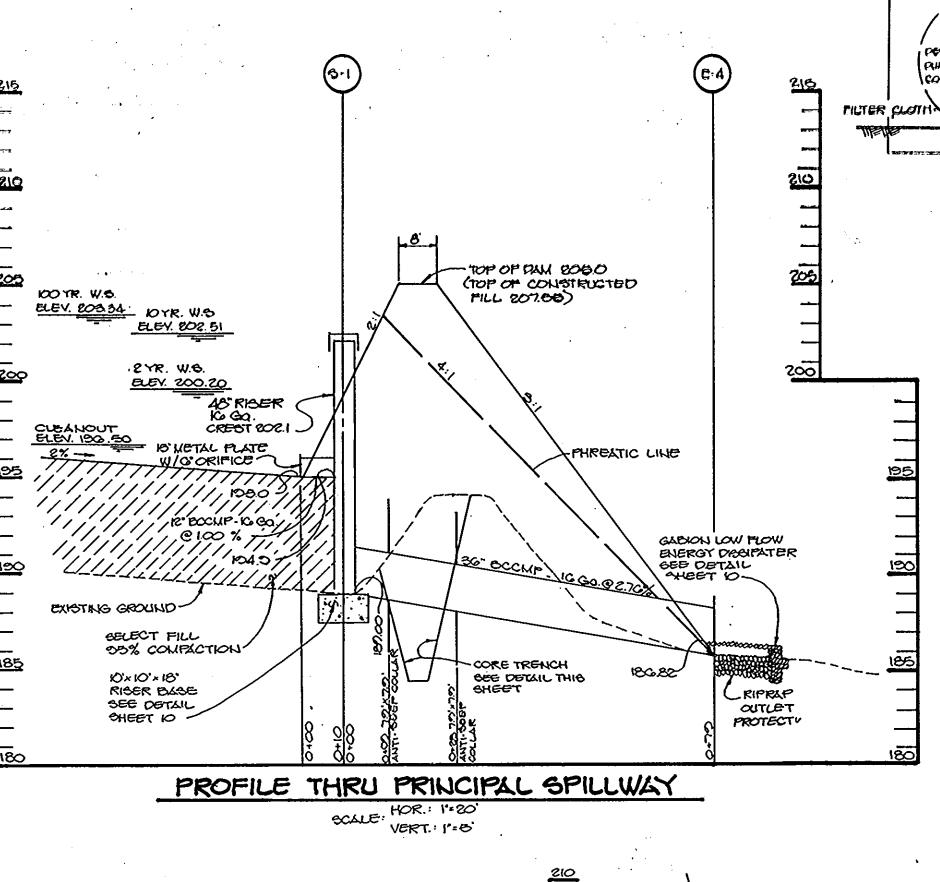Sand - The sand used in concrete shall be clean, hard, strong and durable, and a one-quarter inch sieve. Limestone sand shall not be used. IVV percent pas:

Course Aggregate - The coarse aggregate shall be clean, hard, strong and durable, and free from clay or dire. It shall be well graded with a maximum size of one and one-half (1-3) inches.

Renforcing Steel - The reinforcing steel shall be be deformed bars of intermediate grade billet steel or rail steel conforming to ASTH Specification A-615. Design Hix:

The concrete shall be mixed in the following proportions, measured by weight. The water-cement ration shall be 5-5 to 6 U.S. gallons of water per 94 pound bag of cement. The proportion of materials for the trial mix shall be 1:2:3-3. The combination of aggregates may be adjusted to produce a plastic and workable mix that will not produce harshness in placing or honeycombing in the structure.

<u>Hixing:</u>

The concrete ingredients shall be mixed in batch mixers until the mixture is honogeneous and of uniform consistency. The mixing of each batch shall continue for not less than one and one-half minutes after all the ingredients, except the full amount of water, are in the mixer. The minimum mixing time is predicted on proper cuntrol of the speed of rotation of the mixer and of the introduction of the material, including water, into the mixer. Water shall be added prior to, during, and following the mixer-charging operations. Excessive overmixing requiring the additions of water to perserve the required concrete consistency shall not be permitted. Truck mixing will be allowed provided that the use of this method shall cause no violation of any applicable provisions of the specifications given here.

Torms:

' The forms shall have sufficient strength and rigidity to hold the concrete and to with stand the necessary pressure, tamping, and vibration without deflection from the prescribed lines. They shall be morear-tight and constructed so that they can be removed without hamsering or prying against the concrete.

The inside of forms shall be oiled with a non-staining mineral oil or thoroughly wetted before concrete is placed.

Forns may be removed 24 hours after the placement of concrete. All wire ties and other devices used shall be recessed from the surface of the concrete.

All reinforcing material shall be free of dirt, rust, scale, oil.

Reinforcing Steel:

paint or other coatings. The steel shall be accurately placed and securely tied and blocked into position so that no novement of the steel will occur during placement of concrete.

Consolidatings

Concrete shall be consolidated with internal type mechanical vibrators. Vibration shall be suplemented by spading and hand tamping as necessary to insure smooth and dense concrete along form surfaces, in corners, and around embedded items.

Finishing:

Defective concrete, honeycombed areas, voids left by the removal of the rods, ridges on all concrete surfaces permanently exposed to view or exposed to water on the finished structure, shall be repaired immediately after the removal of forms. All voids shall be reamed and completely filled with dry-patching mortar.


Protection and Curing:

Exposed surfaces of concrete shall be protected from the direct rays of the sun for at least the first three (3) days. All concrete shall be kept continuously motst for at least ten (10) days after being placed. Hoisture may be applied by spraying or sprinkling as necessary to prevent the concrete from drying. Concrete shall not be exposed to freezing during the curing period. Curing compounds may also by used.

Placing Comperature:

Concrete may not be placed at temperatures below 37° F with the temperature falling, or 34° with the temperature rising. STABILIZATION

All barrow areas shall be graded to provide proper drainage and left in a sightly condition. All exposed surfaces of the embankment, spillway, spoil and borrow areas, and berms shall be scabilized by seeding, fertilizing and mulching (if required) in accordance with the vegetative treatment specifications shown on or accompanying the drawings.

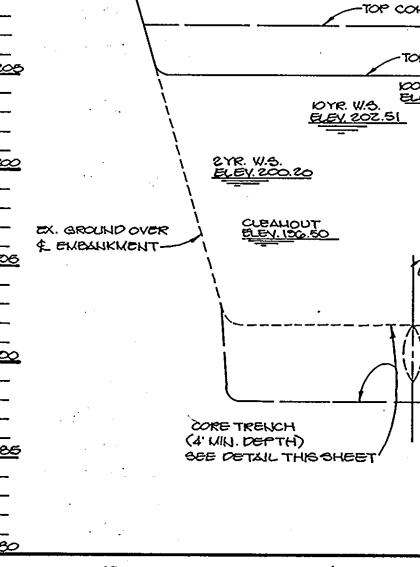

PROFILE THRU & EMBANKMENT SCALE : YERT .: 1' 5'

SEDIMENT CONTROL NOTES

Total Cut

total Fill

. A minimum of 24 hours notice must be given to the Howard County Office of Inspections and Permits prior to the start of any construction (992-2437)

- 2. All vegetative and structural practices are to be installed according to the provisions of this plan and are to be in conformance with the 1983 MARYLAND STANDARDS AND SPECIFICATIONS FOR SOIL EROSION AND SEDIMENT CONTROL.
- 3. Following initial soil disturbance or redisturbance, permanent o temporary stabilization shall be completed within: a) 7 calendar days for all perimeter sediment control structures, dikes, perimeter slopes and all slopes greater than 3:1, b) 14 days as to all other disturbed or graded areas on the project site.
- 4. All sediment traps/basins shown must be fenced and warning signs posted around their perimeter in accordance with Vol. 1, Chapter 12, of the HOWARD COUNTY DESIGN MANUAL, Storm Drainage.
- All disturbed areas must be stabilized within the time period specified above in accordance with the 1983 MARYLAND STANDARDS AND SPECIFICATIONS FOR SOIL EROSION AND SEDIMENT CONTROL for permanent seedings (Sec. 51) sod (Sec. 54), temporary seeding (Sec. 50) and mulching (Sec. 52). Temporary stabilization with mulch alone can only be done when recommended seeding dates do not allow for proper germination and establishment of grasses.
- All sediment control structures are to remain in place and are to be maintained in operative condition until permission for their removal has been obtained from the Howard County Sediment Control Inspector.


7. Site Analysis: Total Area of Site Area Disturbed 'Area to be roofed or paved Area to be vegetatively stabilized

	<u>12.7</u> acres
	12.2 acres
	<u>8.0</u> acres
đ	4.Z acres
	54000 Cu. yds.
	45000 Cu. yds.

- 8. Any sediment control practice which is disturbed by grading activity for placement of utilities must be repaired on the same day of
- Additional sediment controls must be provided, if deemed necessary by the Howard County DPW sediment control inspector.
- 10. Site grading will begin only after all perimeter sediment control
- Sediment will be removed from traps when its depth reaches the clean out elevation shown on the plans.


12" PCCMP IG GO-6" HETAL FLATE RIGER GGA GORIFICE-~ 54" BCCMP 14 00. PEWATERING HUTCH PEWATERING POVICE DEVICE DURING RURING GEPINENT 60 DIMENT BY THE DEVELOPERT CONTROL CONTROL I CERTIPY THAT ALL DEVELOPMENT AND/OR CONSTRUCTION WI BE DONE ACCORDING TO THESE PLANS, AND THAT ANY RESPONSIBLE モィアダイア 8'6/ u//e PERSONNEL INVOLVED IN THE CONSTRUCTION PROJECT WILL HAVE A CERTIFICATE OF ATTENDANCE AT A DEPARTMENT OF NATURA ROOR PLOD RESOURCES APPROVED TRAINING PROGRAM FOR THE CONTROL C • & % wird moch SEDIMENT AND EROSION BEFORE BEGINNING THE PROJECT. I WIL PROVIDE THE HOWARD SOIL CONSERVATION DISTRICT WITH A 'AS-BUILT' PLAN OF THE POND WITHIN 30 DAYS OF COMPLETION I ALSO-AUTHORIZE PERIODIC ON-SITE INSPECTION BY THE HOWAR ORIFICE BLOCKING DETAIL SOIL CONSERVATION DISTRICT." 1/23/09 NO SCALE 225 DEVELOPER BUILDING B FF 2200 BY THE ENGINEER: 220 "I CERTIFY THAT THIS PLAN FOR POND CONSTRUCTION, EROSIO AND SEDIMENT CONTROL REPRESENTS A PRACTICAL AND WORKABLE PLAN BASED ON MY PERSONAL KNOWLEDGE OF THE SIT CONDITIONS. THIS PLAN WAS PREPARED IN ACCORDANCE WITH THE REQUIREMENTS OF THE HOWARD SOIL CONSERVATION DISTRICT. HAVE NOTIFIED THE DEVELOPER THAT HE MUST PROVIDE TH HOWARD SOIL CONSERVATION DISTRICT WITH AN 'AS-BUILT' PLAN OF THE POND WITHIN 30 DAYS OF COMPLETION." 2120 1-23.69 THESE PLANS HAVE BEEN REVIEWED FOR THE HOWARD SOIL CONSERVATION DISTRICT AND MEET THE TECHNICAL REQUIREMENTS POND CONSTRUCTION, SOIL EROSION AND SEDIMENT 206.27 ∠EX.G. BHC @Z.00% EX.85 ILN. 204.47 (CONTR. # 24-1485-D) SEWER PROFILE ESE PLANS FOR SMALL POND CONSTRUCTION, SOIL EROSION AN CALE: HOR .: 1 . 50 EDIMENT CONTROL MEET THE REQUIREMENTS OF THE HOWARD SOIL CONSERVATION DISTRICT VERT .: 1.6 APPROVE 20 TOP CONSTRUCTED FILL 207.80 FOR PUBLIC WATER AND PUBLIC SEWERAGE SYSTEMS HOWARD COUNTY HEALTH DEPARTMENT -TOP OF DAM 205.00 KOYR W.C ELEV. 203.34 COUNTY OFFICE OF PLANNING AND ZONING 33189 CHIEF, DIVISION OF <u>مر. ,</u> 195 EX. 30° BCCMP (TO BE REMOVED) COMMUNITY PLANNING AND LAND DEVELOPMENT APPROVED: FOR PUBLIC WATER, PUBLIC SEWERAGE, STORM 188.57 BOCKIP . 16 CO. ∞ DRAINAGE SYSTEMS AND PUBLIC ROADS. HOWARD COUNTY DEPARTMENT OF PUBLIC WORKS 3/14/89 DATE 60 CHIEF, BUREAU OF ENGIN 3-14-89 DATE ILL MATERIAL SHALL DATE NO REVISION BE MOST IMPERVIOUS MATERIAL AVAILABLE OWNER / DEVELOPER AND SHALL BE PLACED AND TAMPED TO 25% COMPACTION. BEAUMONT PROPERTIES 8811 EAST HANPTON AVE. GUITE 200 DENVER COLORADO 80231 EXISTING GROUND PROJECT B.W.I.P. PARCEL B-2 WAREHOUSE OFFICE BUILDING PLAT NO 7047 AREA TAX MAP NOS. 43 \$ 48 BALTIMORE WASHINGTON INDUSTRIAL PARK, SECTION II PARCEL BE GTH ELECTION DISTRICT, HOWARD COUNTY, MARYLAND TITLE SEWER PROFILES AND DETAILS CORE TRENCH TYP. SECTION NO SCALE THE RIEMER GROUP, INC. The Riemer Group, Inc. A Land Planning, Design & Civil Engineering Firm 3105 North Ridge Road, Ellicott City, Maryland 21043 (301) 461-2690 APPROVED DIVISION of COMMUNITY PLANNING 1-23-89 DATE & LAND DEVELOPMEN DESIGNED BY : W.C.W. HOWARD COUNTY, MARYLAND DRAWN BY: KLO. DATE 11-2-88 PROJECT NO: 40401 DATE: 5-16-88 ures have been installed and are in a functioning condition. SCALE: AS SHOWN -SSIONAL ARTHUR E. MUEGGE # 8107 DRAWING NO. OF 13

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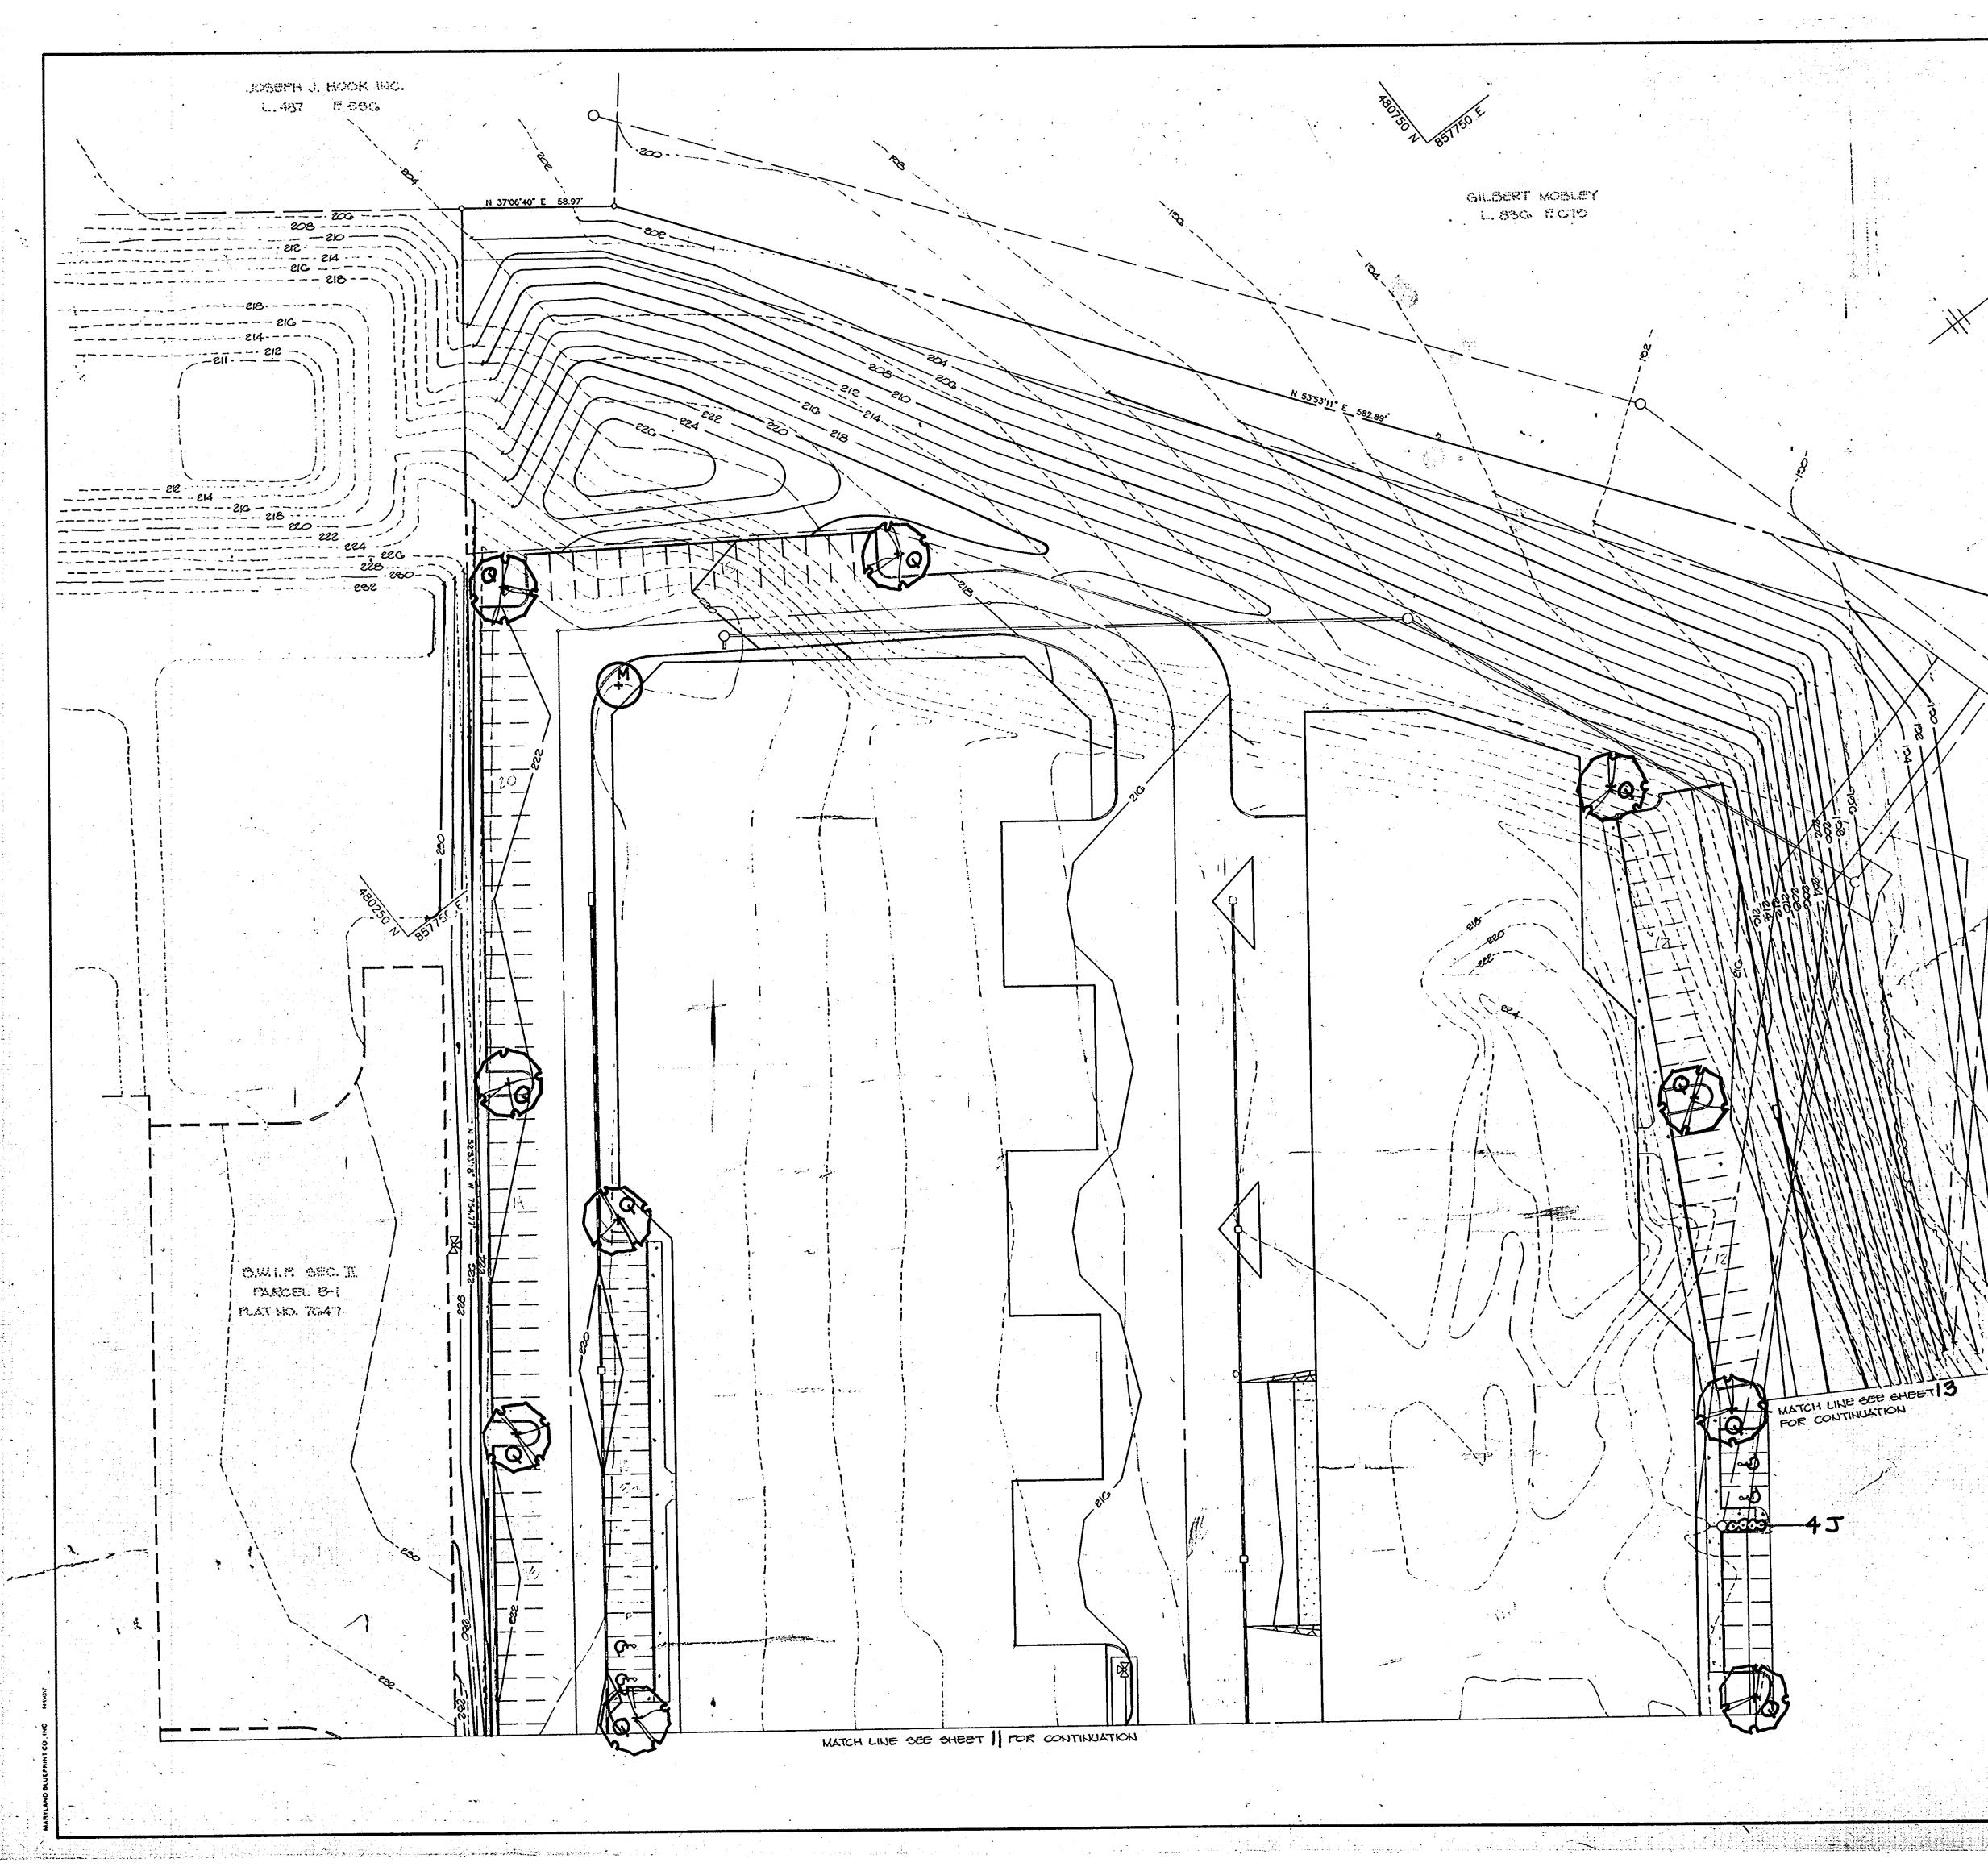


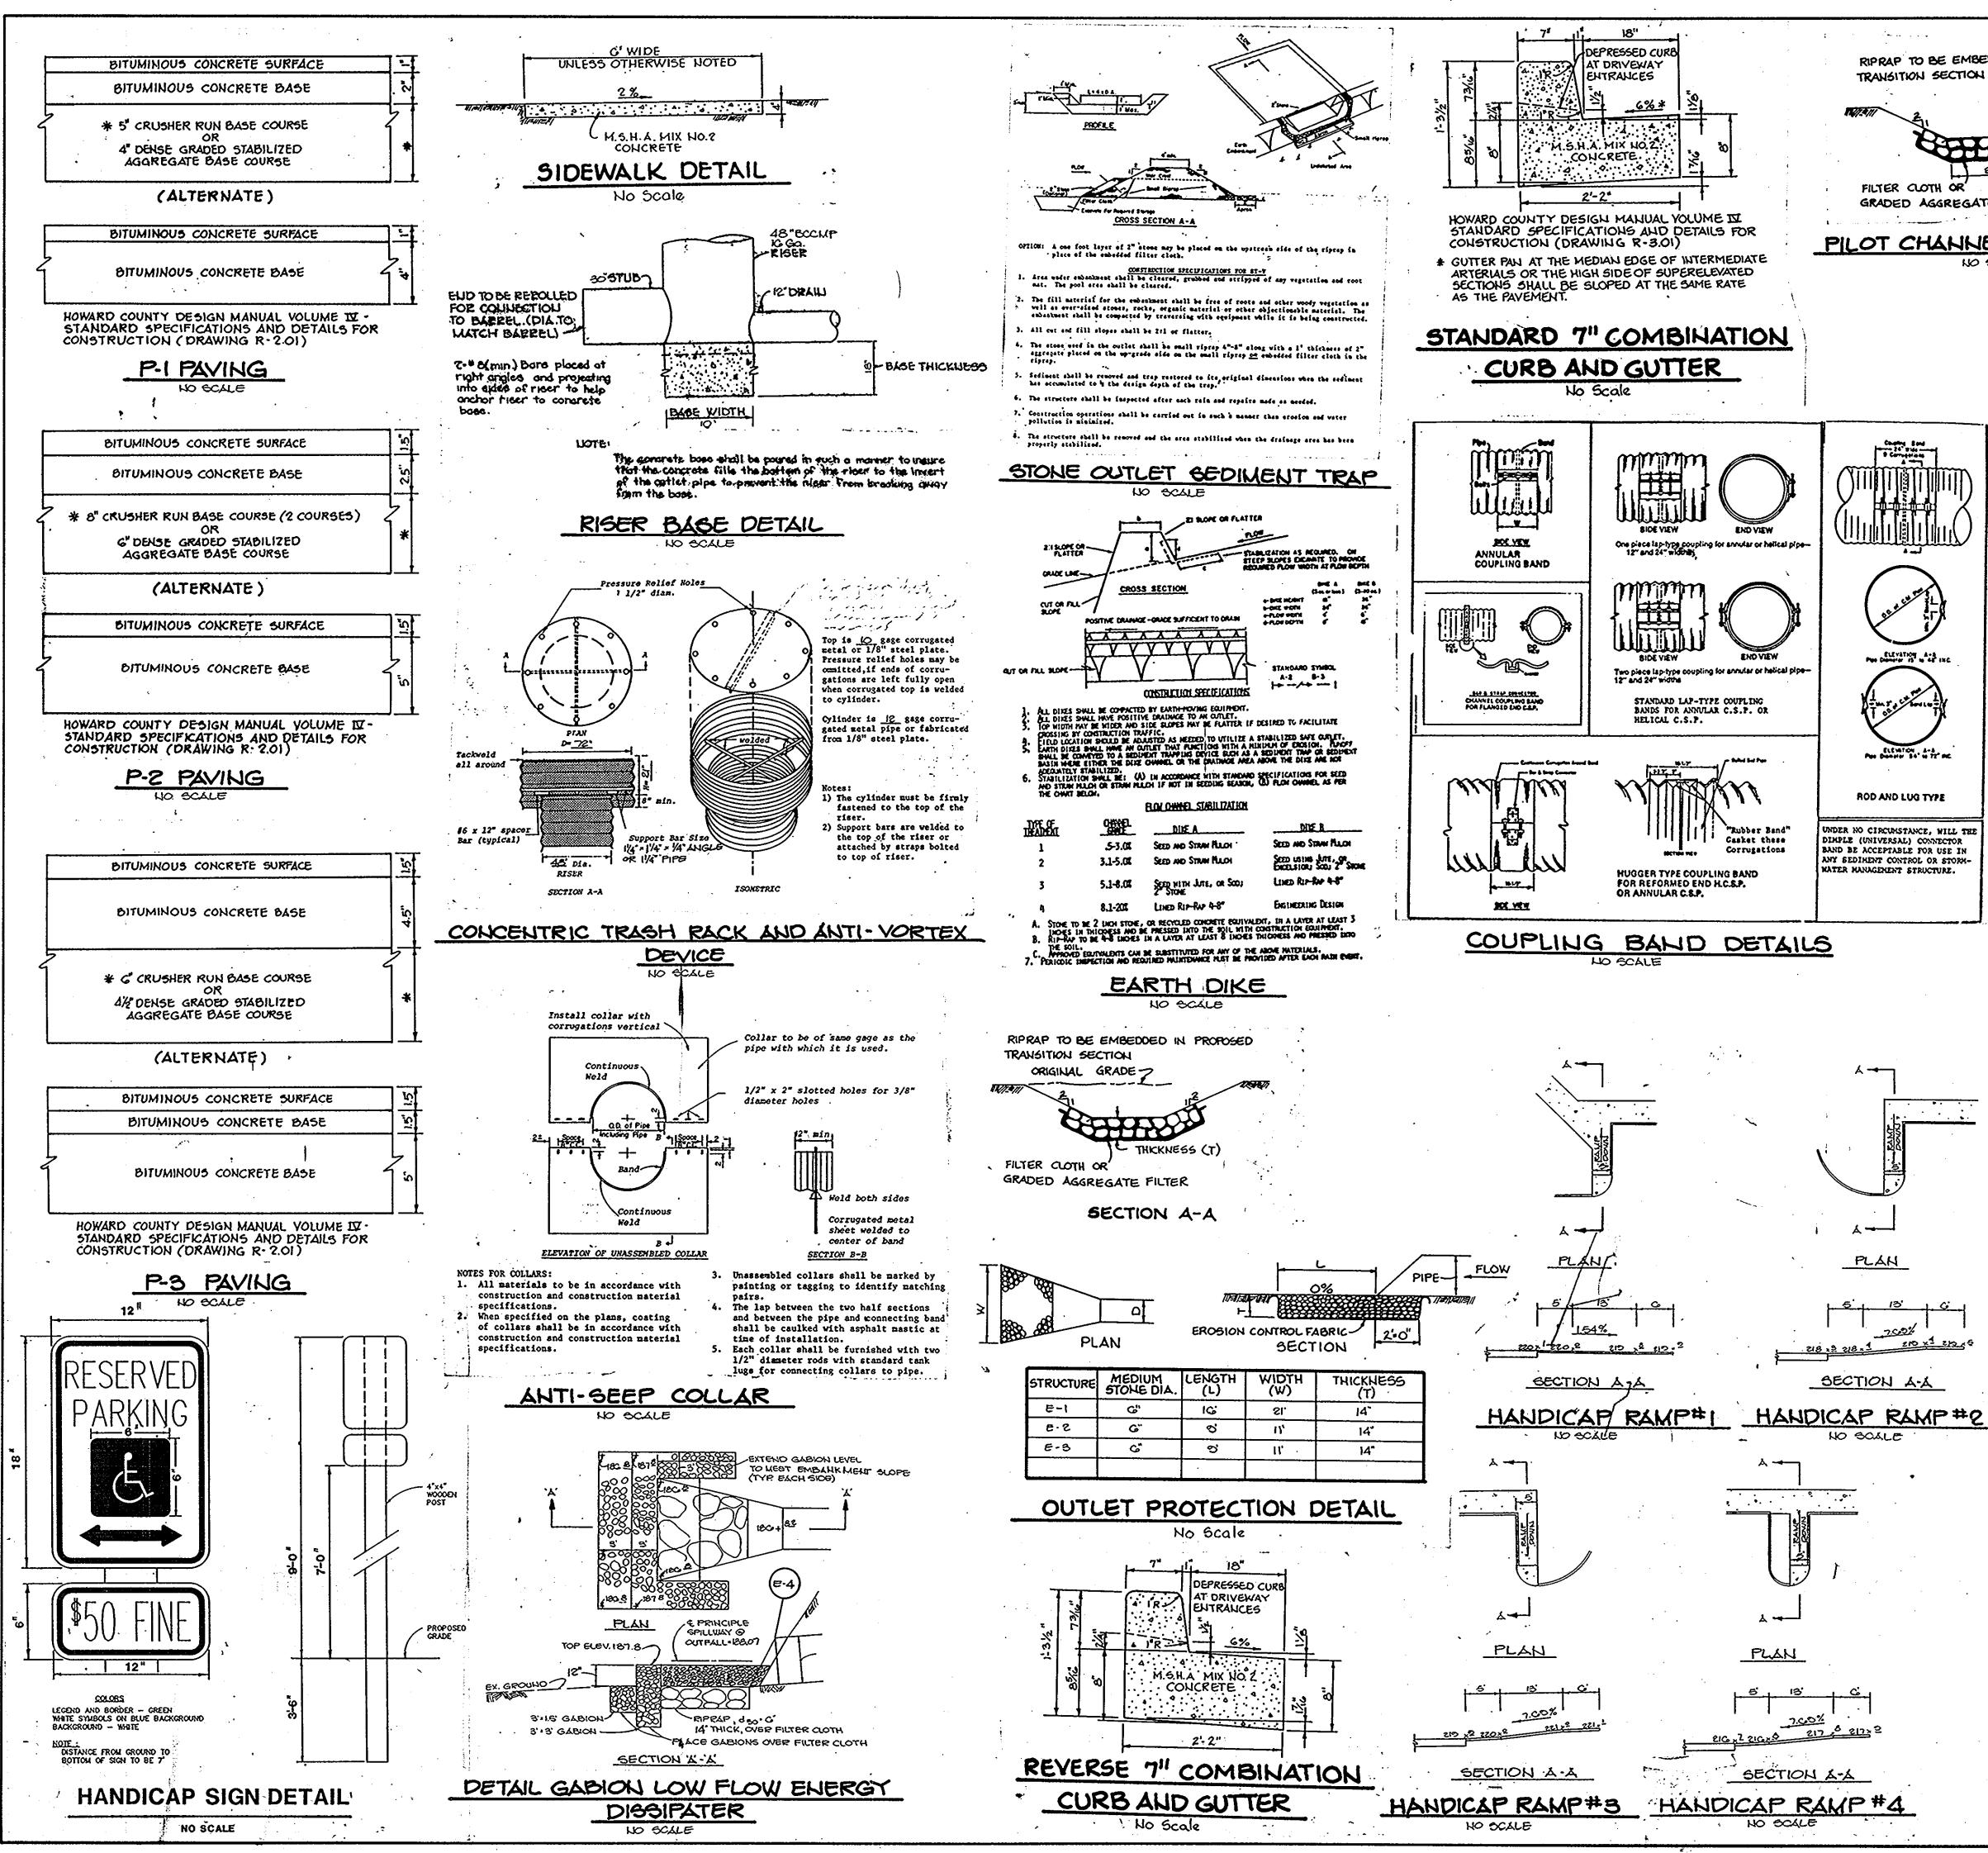RIPRAP TO BE EMBEDDED IN PROPOSED TRANSITION SECTION BY THE DEVELOPER: "I CERTIFY THAT ALL DEVELOPMENT AND/OR CONSTRUCTION WI BE DONE ACCORDING TO THESE PLANS, AND THAT ANY RESPONSIBLE PERSONNEL INVOLVED IN THE CONSTRUCTION PROJECT WILL HAVE A CERTIFICATE OF ATTENDANCE AT A DEPARTMENT OF NATURAL RESOURCES, APPROVED TRAINING PROGRAM FOR THE FILTER CLOTH OR SEDIMENT AND EROSION BEFORE BEGINNING THE PROJECT. I WILL GRADED AGGREGATE FILTER PROVIDE THE HOWARD SOIL CONSERVATION DISTRICT WITH A 'AS-BUILT' PLAN OF THE POND WITHIN 30 DAYS OF COMPLETION. I ALSO AUTHORIZE PERIODIC ON-SITE INSPECTION BY THE HOWARE PILOT CHANNEL CROSS SECTION SOIL CONSERVATION DISTRICT." 122/89 NO SCALE DATE BY THE ENGINEER: 'I CERTIFY THAT THIS PLAN FOR POND CONSTRUCTION, EROSIO AND SEDIMENT CONTROL REPRESENTS A PRACTICAL AND WORKABLE PLAN BASED ON MY PERSONAL KNOWLEDGE OF THE SITE ليه ک CONDITIONS. THIS PLAN WAS PREPARED IN ACCORDANCE WITH THE PLAN REQUIREMENTS OF THE HOWARD SOIL CONSERVATION DISTRICT. HAVE NOTIFIED THE DEVELOPER THAT HE MUST PROVIDE THE HOWARD SOIL CONSERVATION DISTRICT WITH AN 'AS-BUILT' PLAN 8.4C.% 217.8 217.5 OF THE POND WITHIN 30 DAYS OF COMPLETION." Canada 800 1.23:89 SECTION L.A. HANDICAP RAMP#5 NO SCALE THESE PLANS HAVE BEEN REVIEWED FOR THE HOWARD SOI CONSERVATION DISTRICT AND MEET THE TECHNICAL REQUIREMENTS POND CONSTRUCTION, SOIL EROSION AND ELEVATION A-A HESE PLANS FOR SMALL POND CONSTRUCTION, SOIL EROSION AN PLAN SEDIMENT CONTROL MEET THE REQUIREMENTS OF THE HOWARD SOIL CONSERVATION DISTRICT 6.92% ELEVATION A-S Per Denser S4" IN TE ME nan HOWARD S.C.D. SECTION A-A FOR PUBLIC WATER AND PUBLIC SEWERAGE SYSTEMS APPROVED: ROD AND LUG TYPE HANDICAP RAMP # G HOWARD COUNTY HEALTH DEPARTMENT DER NO CIRCUNSTANCE, WILL TEL HO SCALE 3-15-8 HOWARD COUNTY OFFICE OF PLANNING AND ZONING. **APPROVED:** 3.31.89 CHIEF, DIVISION OF DATE ym 6---PLAN COMMUNITY PLANNING AND LAND DEVELOPMENT 217 2 217 2 217 2 217 2 APPROVED: FOR PUBLIC WATER, PUBLIC SEWERAGE, STORM DRAINAGE SYSTEMS AND PUBLIC ROADS. SECTION A.A. HOWARD COUNTY DEPARTMENT OF PUBLIC WORKS HANDICAP RAMP #7 3/14/89 NO SCALE 3-14-89 DATE Weelen & Red CHIEF, BUREAU OF ENGINEER DATE NO. REVISION OWNER / DEVELOPER BEAUMONT PROPERTIES PLAN BOIL EXOT HAMPTON AVE. 210 x 1 210 x SUITE 200 DENVER, COLORADO 80231 218 x9 218 x² 218 x PROJECT B.W.I.P. PARCEL B-2 6ECTION A-A WAREHOUSE /OFFICE BUILDING HANDICAP RAMP#8 AREA TAX MAP NOG. 43 \$ 48 PLAT NO. 76.47 NO BCALE BALTIMORE WASHINGTON INDUSTRUL PARK, SECTION I PARCEL B-2 GTH ELECTION DISTRICT, HOWARD COUNTY, MARYLAND TITLE: DETAIL SHEET THE RIEMER GROUP, INC. APPROVED The Riemer Group, Inc. A Land Planning, Design & Civil Engineering Firm 3105 North Ridge Road, Ellicott City, Maryland 21043 (301) 461-2690 DIVISION of COMMUNITY PLANNING : 1-23-89 & LAND DEVELOPMENT DATE DESIGNED BY : W.C.W. HOWARD COUNTY, MARYLAND DRAWN BY: MAD. DATE 11-2-88 PROJECT NO: 40401 DATE: 5-16-88 SCALE: AS SHOWN Main E. Millige DRAWING NO. 10 OF 15 LATHUR E. HUEGGE BOOT SPP-88-213

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APPROVED: FOR PUBLIC WATER AND PUBLIC SEWERAGE SYSTEMS, HOWARD COUNTY HEALTH DEPARTMENT 3-15-8-9 COUNTY OFFICE OF PLANNING AND ZONING. 221.82 CHIEF, DIVISION OF COMMUNITY PLANNING AND LAND DEVELOPMENT میز ، و ر ، ف DATE Δ • · APPROVED: FOR PUBLIC WATER, PUBLIC SEWERAGE, STORM DRAINAGE SYSTEMS AND PUBLIC ROADS. HOWARD COUNTY DEPARTMENT OF PUBLIC WORKS 3/12/89 DATE James. rlun-CHIEF, BUREAU OF ENGINEERING 3-14-89 DATE REVISION DATE NO OWNER/DEVELOPER BEAUMONT PROPERTIES 8811 E. HAMPTON AVE SUITE 200 DENVER, COLORADO 80231 PROJECT B.W.I.P. PARCEL B-2 WAREHOUSE / OFFICE BUILDING. PLAT NO. 7047 AREA TAX WAP NOS 43 & 48 BALTINORE WASHINGTON INDUSTRIAL PARK, SECTION II PARCEL B-2 OTH ELECTION DISTRICT, HOWSRD COUNTY, MARYLAND TITLE PLANTING PLAN ----THE RIEMER GROUP, INC. The Riemer Group, Inc. A Land Planning, Design & Civil Engineering Firm 3105 North Ridge Road, Ellicott City, Maryland 21043 (301) 461-2690 APPROVED DIVISION OF COMMUNITY PLANNING & LAND DEVELOPMENT 1. 23 :89 DATE DESIGNED BY: LLB HOWARD COUNTY, DRAWN BY: LLB DATE 11-2-88 PROJECT NO: 40401 -DATE : MAY, 1988 SCALE: 1"= 30 Malania Massim DRAWING NO. 11 OF 13 50P-88-213

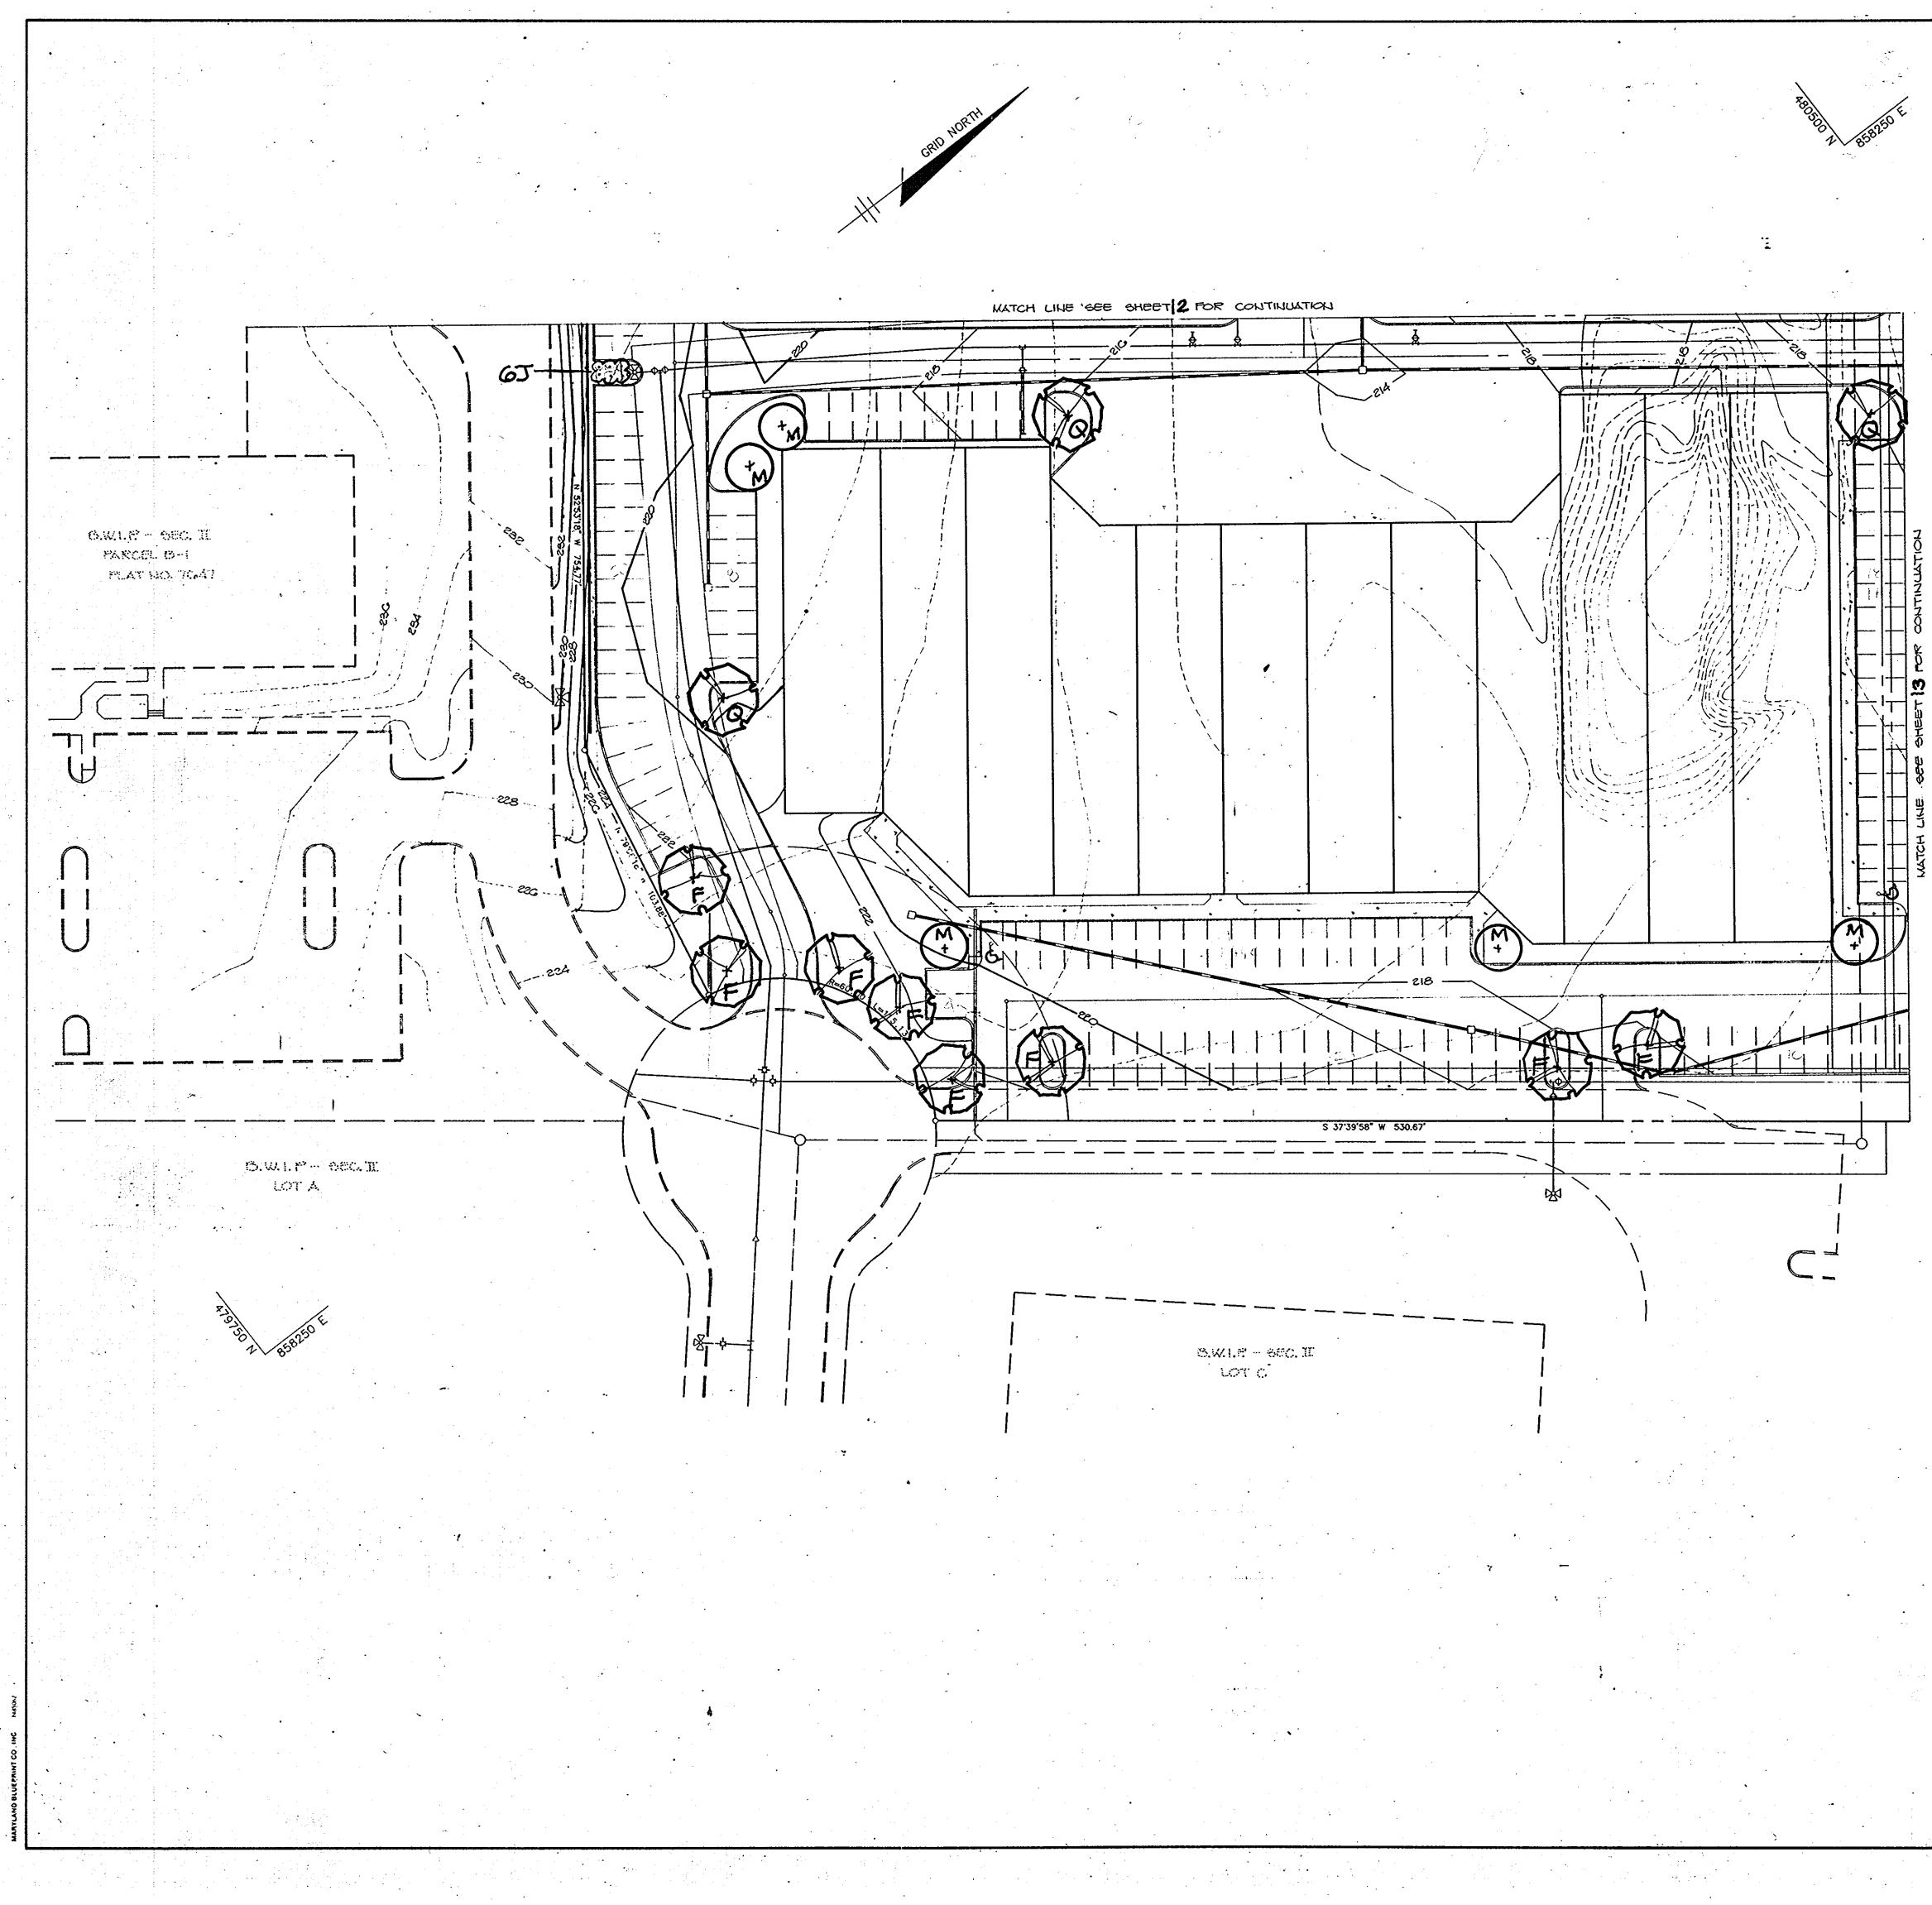

APPROVED: FOR PUBLIC WATER AND PUBLIC SEWERAGE SYSTEMS, IOWARD COUNTY HEALTH DEPARTMENT ICE OF PLANNING AND ZONING. 3.31.80 GILBERT MOBLEY 1.880 CHIEF, DIVISION OF COMMUNITY PLANNING AND S. 20 -29 DATE LAND DEVELOPMENT APPROVED: FOR PUBLIC WATER, PUBLIC SEWERAGE; STORM DRAINAGE SYSTEMS AND PUBLIC ROADS. HOWARD COUNTY DEPARTMENT OF PUBLIC WORKS 3/14/89 DATE 215 LOLAN OF ENGINEERING <u>3-14-89</u> DATE REVISION DATE NO. OWNER/DEVELOPER BEAUMONT PROPERTIES 8811 E. HAMPTON AVE SUITE 200 DENVER, COLORADO 80231 PROJECT B.W.I.P. PARCEL B-2 WAREHOUSE / OFFICE BUILDING PLAT NO. 7047 AREA TAX MAP NOS 43248 DALTIMORE WASHINGTON INDUSTRIAL PARK, SECTION II PARCELBO GTH ELECTION DISTRICT, HOWARD COUNTY, MARYLAND TITLE PLANTING PLAN THE RIEMER GROUP, INC. APPROVED DIVISION of The Riemer Group, Inc. A Land Planning, Design & Civil Engineering Firm 3105 North Ridge Road, Ellicott City, Maryland 21043 (301) 461-2690 COMMUNITY PLANNING & LAND DEVELOPMENT 1.23.89 DESIGNED BY LLB HOWARD COUNTY, MARYLAND DRAWN BY: LLB DATE 11-2-88 PROJECT NO 49401 DATE : MAY, 1988 SCALE: 1" = 30' Milanie noon_ DRAWING NO. 12 OF 13 SDP-88-213

