


VICINITY MAP
SCALE 1" = 2000'

GENERAL NOTES

- TOTAL AREA OF SITE: 3.2972 AC.
- PRESENT ZONING: NEWTOWN (OPEN SPACE - CREDITED)
- PROPERTY IS RECORDED AS PLAT NO. 5849.
- FINAL DEVELOPMENT PLAN CRITERIA: PARCELS 178-A-III PART II, 20544-949 TO 20544-967
- PROPERTY IS SHOWN ON TAX MAP 42, OPEN SPACE LOT 590.
- PARKING DATA:
 - SCOPE OF WORK: CONSTRUCTION OF BATHHOUSE, WADING POOL, MAIN POOL, VOLLEYBALL COURT AND PARKING LOT
 - TOTAL AREA OF BUILDING: 1250 S.F. OR 0.03 AC. (0.94 COVERAGE)
 - TOTAL NUMBER OF PARKING SPACES REQUIRED (PER F.O.P. CRITERIA): NONE COLUMBIA ASSOCIATION REQUIRES 40 SPACES
 - TOTAL NUMBER OF PARKING SPACES PROVIDED:
 - REGULAR SPACES (9' X 18') = 39
 - HANDICAPPED SPACES (11' X 18') = 2
- TOTAL AREA OF OPEN SPACE (GREEN AREA): 1.00 AC. (30%)
THE CONTRACTOR SHALL NOTIFY THE HOWARD COUNTY CONSTRUCTION INSPECTION/PERMITS DIVISION 24 HOURS PRIOR TO COMMENCEMENT OF WORK AT (301) 392-2273.
- HANDICAPPED FACILITIES TO BE CONSTRUCTED IN ACCORDANCE WITH THE "DESIGN OF BARRIER FREE FACILITIES" AND THE "MARYLAND BUILDING CODE FOR THE HANDICAPPED AND AGED".
- ALL PAVING AND STORM DRAIN CONSTRUCTION SHALL BE IN ACCORDANCE WITH THE HOWARD COUNTY ROAD CONSTRUCTION CODE AND STANDARD SPECIFICATIONS.
- EXISTING UTILITIES SHOWN HEREON HAVE BEEN LOCATED FROM FIELD AND OFFICE INFORMATION. THE CONTRACTOR SHALL DETERMINE THE EXACT LOCATION OF EXISTING UTILITIES TO HIS OWN SATISFACTION BEFORE MAKING ANY CONNECTION THERETO OR EXCAVATING IN THE AREA THEREOF.
- THE CONTRACTOR SHALL NOTIFY MISS UTILITY (594-0100) A MINIMUM OF THREE DAYS PRIOR TO BEGINNING ANY CONSTRUCTION SHOWN HEREON.
- SEE ARCHITECTURAL DRAWINGS FOR BUILDING DIMENSIONS.
- STORMWATER MANAGEMENT IS PROVIDED FOR THIS SITE UNDER 7-80-96.
- SEE POOL DRAWINGS FOR DIMENSIONS AND CONSTRUCTION DETAILS.

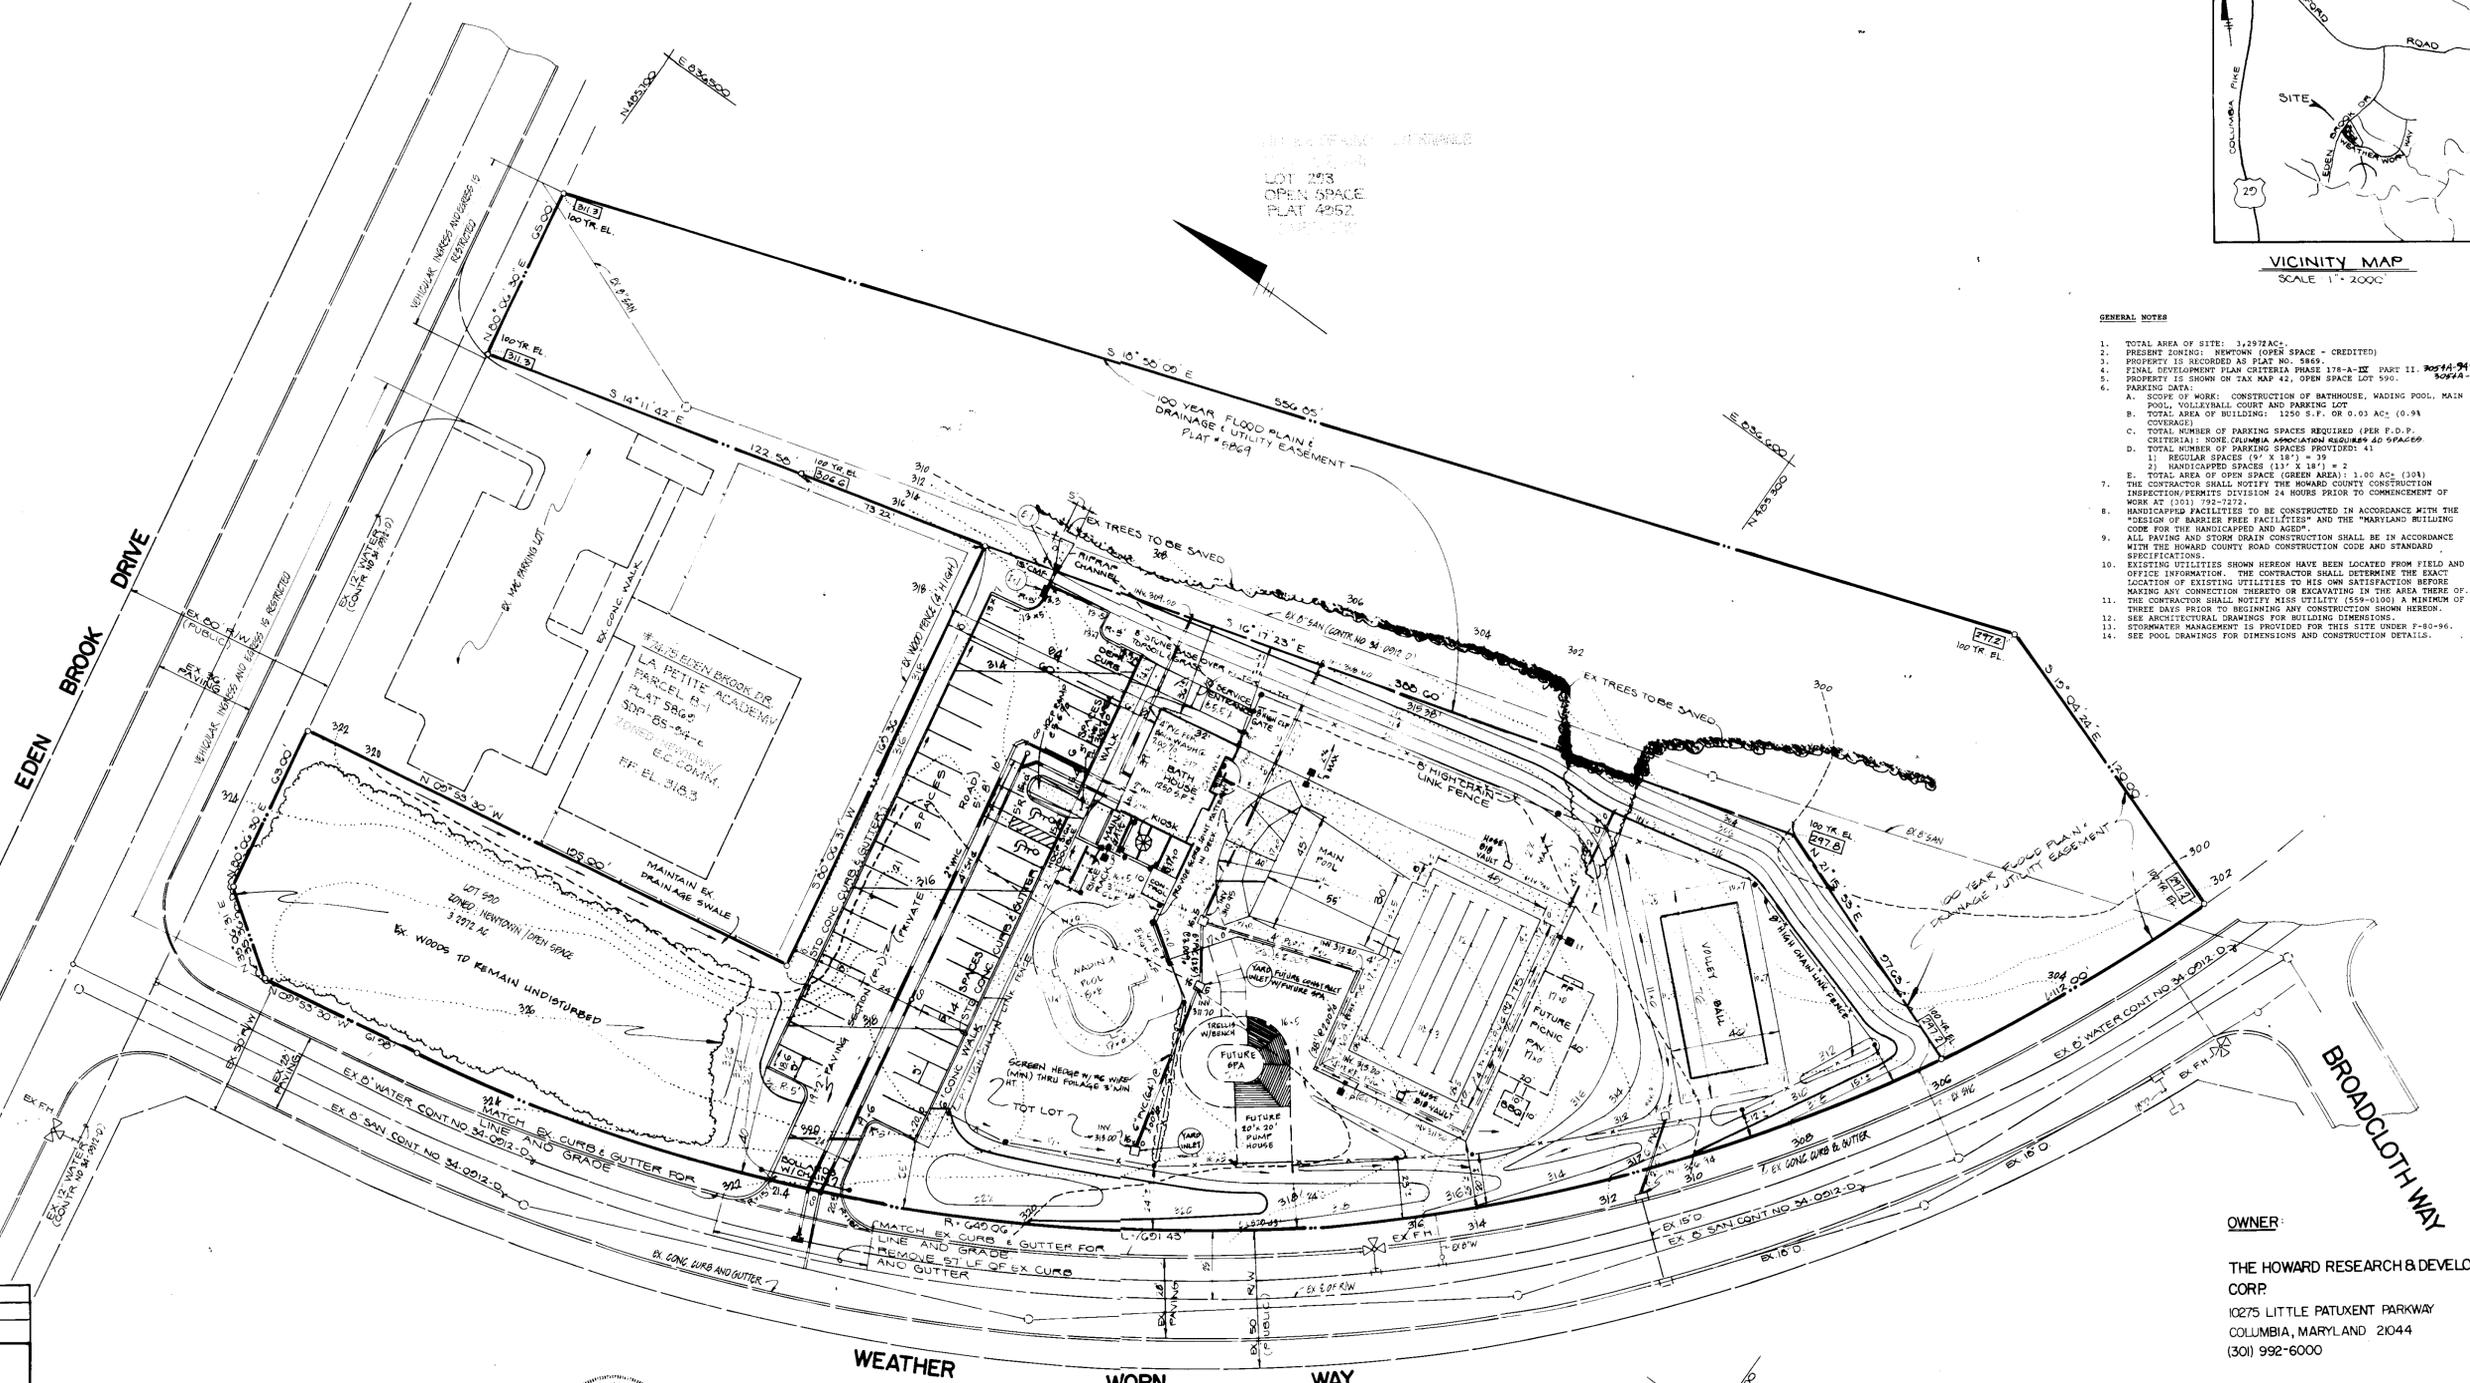

OWNER:
THE HOWARD RESEARCH & DEVELOPMENT CORP.
10275 LITTLE PATUXENT PARKWAY
COLUMBIA, MARYLAND 21044
(301) 992-6000

CONTRACTOR:
METROPOLITAN CONTRACTING CO., INC.
6813 GOLDEN RING ROAD
BALTIMORE, MARYLAND 21237
(301) 574-7515

DEVELOPER:
COLUMBIA ASSOCIATION
ONE KNOLL NORTH, SUITE 400
COLUMBIA, MARYLAND 21045
(301) 730-2616

ADDRESS CHART	
LOT NO.	STREET ADDRESS
590	7425 WEATHER WORN WAY

APPROVED
PLANNING BOARD
OF HOWARD COUNTY
DATE 9-16-87
MM



Dewberry & Davis
ARCHITECTS ENGINEERS PLANNERS SURVEYORS
3700 N. Ridge Road
Suite 100
Ellicott City, Maryland
21043
(301) 461-7478 BALTIMORE
(301) 621-4970 WASHINGTON

ENGINEER'S CERTIFICATE
I HEREBY CERTIFY THAT THIS PLAN FOR EROSION AND SEDIMENT CONTROL REPRESENTS A PRACTICAL AND WORKABLE PLAN BASED ON MY PERSONAL KNOWLEDGE OF THE SITE CONDITIONS AND THAT IT WAS PREPARED IN ACCORDANCE WITH REQUIREMENTS OF THE HOWARD SOIL CONSERVATION DISTRICT.

Signature: *[Signature]* DATE: _____

DEVELOPER'S CERTIFICATE
"I/WE CERTIFY THAT ALL DEVELOPMENT AND CONSTRUCTION WILL BE DONE ACCORDING TO THE PLAN OF DEVELOPMENT AND PLAN FOR EROSION AND SEDIMENT CONTROL AND THAT ALL RESPECTIVE PERSONNEL INVOLVED IN THE CONSTRUCTION PROJECT WILL HAVE A CERTIFICATE OF ATTENDANCE AT A DEPARTMENT OF NATURAL RESOURCES APPROVED TRAINING PROGRAM FOR THE CONTROL OF SEDIMENT AND EROSION BEFORE BEGINNING THE PROJECT. I ALSO AUTHORIZE PERIODIC ON-SITE INSPECTION BY THE HOWARD SOIL CONSERVATION DISTRICT OR THEIR AUTHORIZED AGENTS, AS ARE DEEMED NECESSARY."

Signature: *Jacqueline A. Olwey* DATE: 11/15/87

REVIEWED FOR HOWARD SOIL CONSERVATION DISTRICT AND MEETS TECHNICAL REQUIREMENTS.
Signature: *James McNeil* DATE: 11-19-87
U.S. SOIL CONSERVATION SERVICE DATE

Signature: *Stephen L. Stahl* DATE: 11/19/87
HOWARD SOIL CONSERVATION DISTRICT

APPROVED: OFFICE OF PLANNING AND ZONING
Signature: *[Signature]* DATE: 12-13-87
PLANNING DIRECTOR

Signature: *[Signature]* DATE: 12/18/87
CHIEF, DIVISION OF LAND DEVELOPMENT AND ZONING ADMINISTRATION


APPROVED: HOWARD COUNTY HEALTH DEPARTMENT FOR PUBLIC WATER AND SEWERAGE SYSTEMS.
Signature: *[Signature]* DATE: 12-1-87
HEALTH OFFICER

APPROVED: DEPARTMENT OF PUBLIC WORKS FOR PUBLIC WATER AND SEWER AND STORM DRAINAGE SYSTEMS AND ROADS.
Signature: *[Signature]* DATE: 11/27/87
DIRECTOR, PUBLIC WORKS

Signature: *[Signature]* DATE: 11/27/87
CHIEF BUREAU OF ENGINEERING


SUBDIVISION NAME	SECTION/AREA	LOT NUMBER
VILLAGE OF KINGS CONTRIVANCE	2/3 PHASE 2	LOT 590
PLAT NO.	BLOCK NO.	ZONE
962	9	NT/05
TAX/ZONE	ELEC. DIST.	CENSUS TR
42	6 TH	2622
WATER CODE	SEWER CODE	
6-10	640207	

SITE DEVELOPMENT PLAN
VILLAGE OF KINGS CONTRIVANCE
DICKINSON NEIGHBORHOOD POOL
SECTION 2, AREA 3
OPEN SPACE LOT 590 PHASE 2
TAX MAP 42 PARCEL 62
6th ELECTION DISTRICT HOWARD COUNTY, MD.
SCALE: 1"=30' DATE: JUNE 30, 1987
REVISED: SEPTEMBER 10, 1987
SHEET 1 OF 5
DRAWN: K.A. FRITZ, DESIGNED: B.D. BURTON, CHECKED: B.D. BURTON

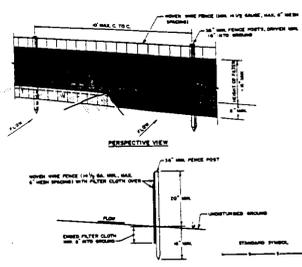


SILT FENCE
NOT TO SCALE

1. NEVER USE FORCE TO BE APPLIED TO FORCE POSTS WITH WIRE TIE OR STAPLES.
2. FILTER CLOTH TO BE FASTENED SECURELY TO WOOD POSTS WITH WIRE TIE OR STAPLES.
3. MAKE NO NOTCHES IN FILTER CLOTH. ALWAYS SAND DOWN ANY WIRE TIE OR STAPLE THAT IS NOT FULLY COVERED BY THE SILT FENCE.
4. MAINTENANCE SHALL BE PROVIDED AS NEEDED AND MUST BE PROVIDED WITHIN 24 HOURS OF THE TIME OF THE FIRST RAINFALL.

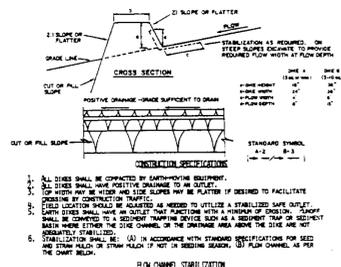


EARTH DIKE
NOT TO SCALE

1. ALL DIKES SHALL BE CONSTRUCTED BY EXISTING CONSTRUCTION.
2. TOP WIDTH SHALL BE 12" MINIMUM AND SHALL BE MAINTAINED THROUGHOUT THE LIFE OF THE DIKE.
3. FILTER CLOTH SHALL BE FASTENED TO THE DIKE WITH WIRE TIE OR STAPLES.
4. MAINTENANCE SHALL BE PROVIDED AS NEEDED AND MUST BE PROVIDED WITHIN 24 HOURS OF THE TIME OF THE FIRST RAINFALL.

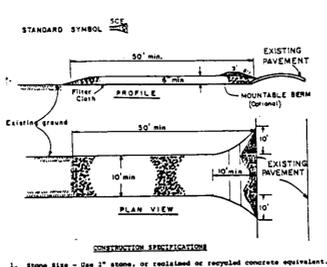


STABILIZED CONSTRUCTION ENTRANCE
NOT TO SCALE

1. Stone Size - Use 2" stone or equivalent of recycled concrete equivalent.
2. Length - As required, but not less than 30 feet (except on a slope less than 1:1 where 45 feet minimum length would apply).
3. Thickness - Not less than 4" (10 inches for slopes greater than 1:1).
4. Width - The 10' foot minimum, but not less than the full width at points where there is a change in slope.
5. Filter Cloth - Will be placed over the entire area prior to placing of stone.
6. Filter Cloth - Will be placed over the entire area prior to placing of stone.
7. Maintenance - The entrance shall be maintained in a condition which will prevent tracking of mud or other material onto the roadway. This may require periodic top dressing with additional stone. All mud and other material shall be removed from the entrance as soon as possible after each rain event.

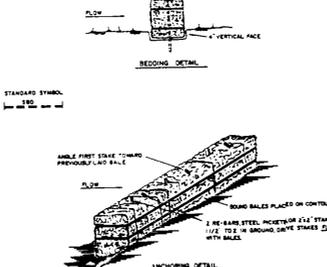


STRAW BALE DIKE
NOT TO SCALE

1. Bales shall be placed on the top of a slope or on the contour and in a row with the top edge of the bale on the contour line.
2. Each bale shall be placed in the soil a minimum of 10 inches, and placed to the full width of the dike.
3. Bales shall be secured in place by either two stakes or rebar driven through the bale. The stakes or rebar shall be driven through the bale to the full width of the dike.
4. Maintenance shall be provided as needed and must be provided within 24 hours of the first rain event.

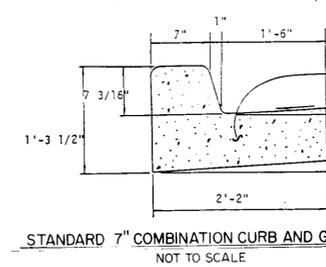


STANDARD 7" COMBINATION CURB AND GUTTER
NOT TO SCALE

1. Curb shall be placed on the top of a slope or on the contour and in a row with the top edge of the curb on the contour line.
2. Each curb shall be placed in the soil a minimum of 10 inches, and placed to the full width of the dike.
3. Bales shall be secured in place by either two stakes or rebar driven through the bale. The stakes or rebar shall be driven through the bale to the full width of the dike.
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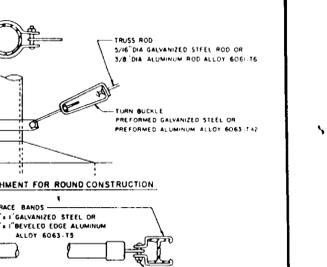
TYPICAL SECTION-SERVICE ENTRANCE
NOT TO SCALE

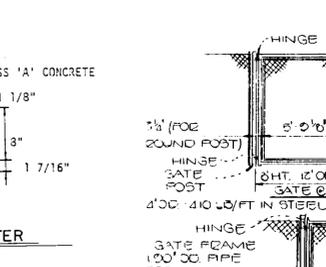1. Curb shall be placed on the top of a slope or on the contour and in a row with the top edge of the curb on the contour line.
2. Each curb shall be placed in the soil a minimum of 10 inches, and placed to the full width of the dike.
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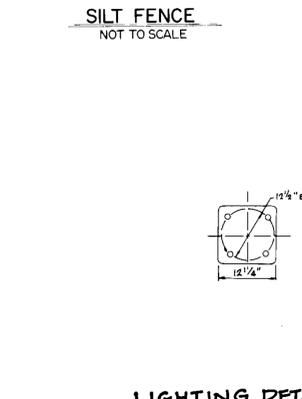
DOUBLE HANDICAPPED PARKING SIGN
NOT TO SCALE

1. Curb shall be placed on the top of a slope or on the contour and in a row with the top edge of the curb on the contour line.
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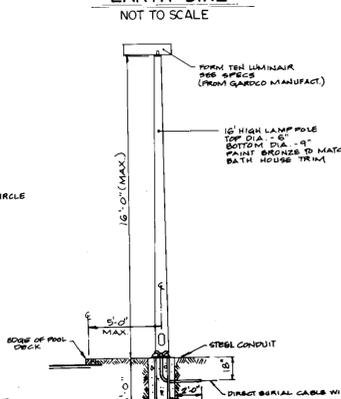
MAIN GATE DETAIL
NOT TO SCALE

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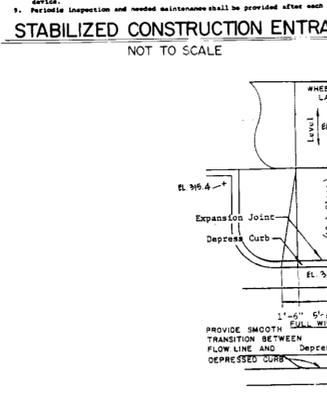
LIGHTING DETAIL
NOT TO SCALE

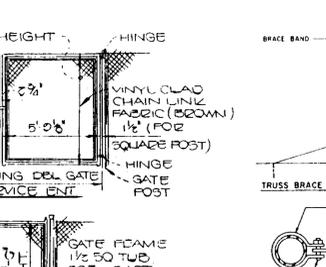1. Curb shall be placed on the top of a slope or on the contour and in a row with the top edge of the curb on the contour line.
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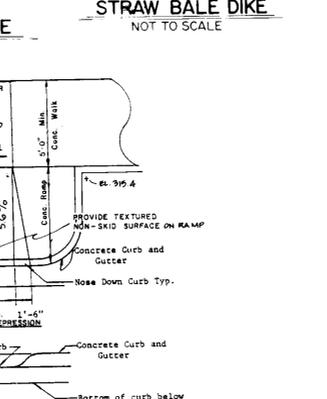
TYPICAL SIDEWALK
NOT TO SCALE

1. Curb shall be placed on the top of a slope or on the contour and in a row with the top edge of the curb on the contour line.
2. Each curb shall be placed in the soil a minimum of 10 inches, and placed to the full width of the dike.
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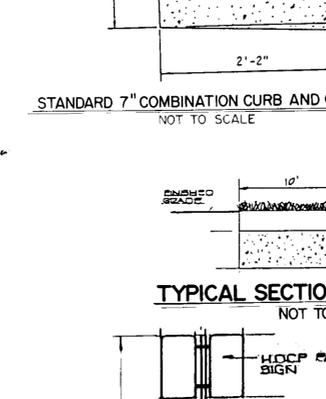
HANDICAPPED RAMP AND CURB CUT DETAIL
NOT TO SCALE

1. Curb shall be placed on the top of a slope or on the contour and in a row with the top edge of the curb on the contour line.
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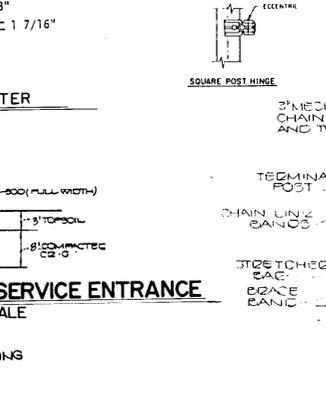
CONCRETE SIDEWALK
NOT TO SCALE

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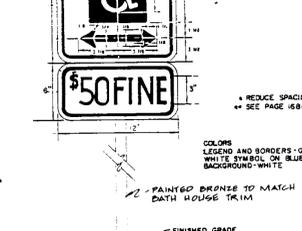
TYPICAL CHAIN LINK FENCE
NOT TO SCALE

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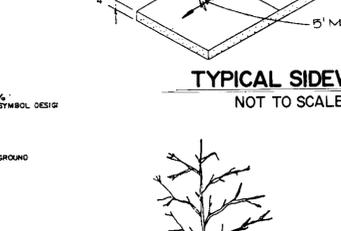
TYPICAL PAVING SECTION (P-1)
NOT TO SCALE

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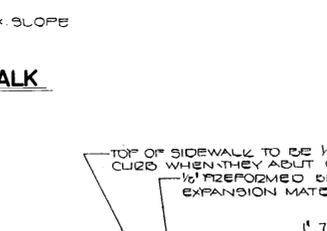
HANDICAP SIGN
NOT TO SCALE

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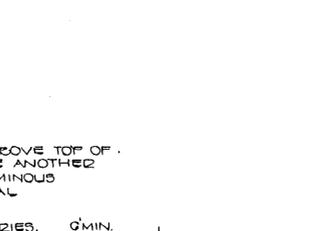
TREE PLANTING DETAIL
NOT TO SCALE

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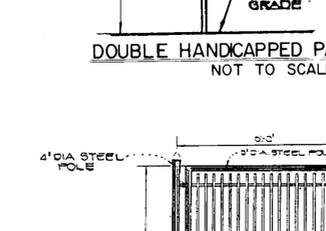
DOUBLE HANDICAPPED PARKING SIGN
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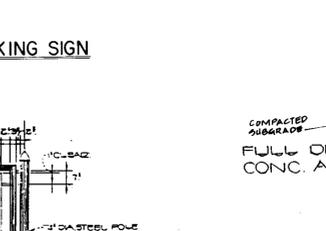
MAIN GATE DETAIL
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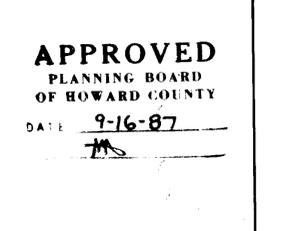
TYPICAL CHAIN LINK FENCE
NOT TO SCALE

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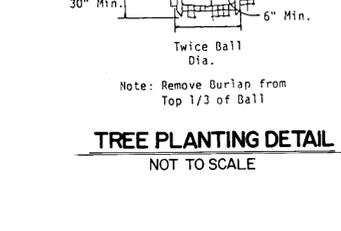
TYPICAL PAVING SECTION (P-1)
NOT TO SCALE

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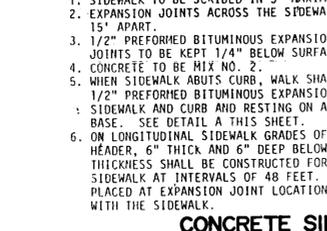
RESERVED PARKING SIGN
NOT TO SCALE

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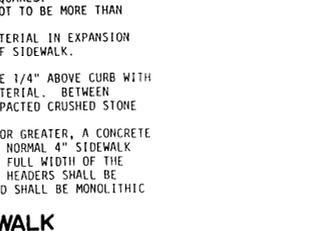
TREE PLANTING DETAIL
NOT TO SCALE

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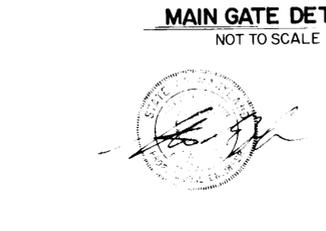
DOUBLE HANDICAPPED PARKING SIGN
NOT TO SCALE

1. Curb shall be placed on the top of a slope or on the contour and in a row with the top edge of the curb on the contour line.
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MAIN GATE DETAIL
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TYPICAL CHAIN LINK FENCE
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TYPICAL PAVING SECTION (P-1)
NOT TO SCALE

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Dewberry & Davis
ARCHITECTS ENGINEERS PLANNERS SERVITORS

3800 N. Ridge Road
Suite 100
Elkton City, Maryland
21043

301-461-7478 (toll-free)
301-621-4970 (Washington DC)

APPROVED PLANNING BOARD OF HOWARD COUNTY

DATE: 9-16-87

ENGINEER'S CERTIFICATE

I HEREBY CERTIFY THAT THIS PLAN FOR EROSION AND SEDIMENT CONTROL REPRESENTS A PRACTICAL AND APPROPRIATE PLAN BASED ON MY PERSONAL KNOWLEDGE OF THE SITE CONDITIONS AND THAT IT HAS BEEN PREPARED IN ACCORDANCE WITH REQUIREMENTS OF THE HOWARD SOIL CONSERVATION DISTRICT.

11/15/87
Jequeline A. Dewey

DEVELOPER'S CERTIFICATE

I HEREBY CERTIFY THAT ALL DEVELOPMENT AND CONSTRUCTION WILL BE IN ACCORDANCE WITH THIS PLAN FOR EROSION AND SEDIMENT CONTROL AND THAT ALL RESPONSIBILITY FOR OBTAINING AND MAINTAINING THIS PLAN FOR EROSION AND SEDIMENT CONTROL WILL BE THE RESPONSIBILITY OF THE DEVELOPER.

11-19-87
U.S. SOIL CONSERVATION SERVICE

REVIEWED FOR HOWARD SOIL CONSERVATION DISTRICT AND MEETS TECHNICAL REQUIREMENTS.

11-19-87
U.S. SOIL CONSERVATION SERVICE

APPROVED: OFFICE OF PLANNING AND DESIGN

12/18/87
PLANNING DIRECTOR

APPROVED: DEPARTMENT OF PUBLIC WORKS FOR PUBLIC WATER AND SEWER AND STORM DRAINAGE SYSTEMS AND ROADS.

11/27/87
PUBLIC WORKS

NOTES AND DETAILS

VILLAGE OF KINGS CONTRIVANCE
DICKINSON NEIGHBORHOOD POOL
SECTION 2 AREA 3
OPEN SPACE LOT 590 PHASE 2
TAX MAP 42 PARCEL 62

6th ELECTION DISTRICT HOWARD COUNTY, MD.
SCALE: AS NOTED DATE: JUNE 30, 1987
REVISED: SEPTEMBER 10, 1987
SHEET 3 OF 3

OWNER:
THE HOWARD RESEARCH & DEVELOPMENT CORP.
10275 LITTLE PATUXENT PARKWAY
COLUMBIA, MARYLAND 21044
(301) 992-6000

CONTRACTOR:
METROPOLITAN CONTRACTING CO., INC.
6813 GOLDEN RING ROAD
BALTIMORE, MARYLAND 21237
(301) 574-7595

DEVELOPER:
COLUMBIA ASSOCIATION
ONE KNOLL NORTH, SUITE 400
COLUMBIA, MARYLAND 21045
(301) 730-2616

APPROVED PLANNING BOARD OF HOWARD COUNTY

DATE: 9-16-87

ENGINEER'S CERTIFICATE

I HEREBY CERTIFY THAT THIS PLAN FOR EROSION AND SEDIMENT CONTROL REPRESENTS A PRACTICAL AND APPROPRIATE PLAN BASED ON MY PERSONAL KNOWLEDGE OF THE SITE CONDITIONS AND THAT IT HAS BEEN PREPARED IN ACCORDANCE WITH REQUIREMENTS OF THE HOWARD SOIL CONSERVATION DISTRICT.

11/15/87
Jequeline A. Dewey

DEVELOPER'S CERTIFICATE

I HEREBY CERTIFY THAT ALL DEVELOPMENT AND CONSTRUCTION WILL BE IN ACCORDANCE WITH THIS PLAN FOR EROSION AND SEDIMENT CONTROL AND THAT ALL RESPONSIBILITY FOR OBTAINING AND MAINTAINING THIS PLAN FOR EROSION AND SEDIMENT CONTROL WILL BE THE RESPONSIBILITY OF THE DEVELOPER.

11-19-87
U.S. SOIL CONSERVATION SERVICE

REVIEWED FOR HOWARD SOIL CONSERVATION DISTRICT AND MEETS TECHNICAL REQUIREMENTS.

11-19-87
U.S. SOIL CONSERVATION SERVICE

APPROVED: OFFICE OF PLANNING AND DESIGN

12/18/87
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APPROVED: DEPARTMENT OF PUBLIC WORKS FOR PUBLIC WATER AND SEWER AND STORM DRAINAGE SYSTEMS AND ROADS.

11/27/87
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EDEN BROOK DRIVE

BROADCLOTH WAY

WEATHER WORN WAY

LOT 253
OPEN SPACE
PLAT 4252

LANDSCAPE LEGEND

- 25 PINUS STOBUS (WHITE PINE) 2"-2 1/2" MIN. CALIPER, 6'-8' MIN. HEIGHT
- 4 TILIA CORDATA (LITTLE LEAF LINDEN) 2"-2 1/2" MIN. CALIPER, 8'-10' MIN. HEIGHT
- 2 ACER RUBRUM (RED MAPLE) 2 1/2"-3" MIN. CALIPER, 12'-14' MIN. HEIGHT
- 1 ACER SACCHARUM (SUGAR MAPLE) 2 1/2"-3" MIN. CALIPER, 12'-14' MIN. HEIGHT
- EVERGREEN HEDGE
- 3 BRADFORD PEAR 2"-2 1/2" MIN. CALIPER 8'-10' MIN. HEIGHT
- 5 LIGHT POLE (16' HIGH)


ADDRESS CHART	
LOT NO.	STREET ADDRESS
990	7625 WEATHER WORN WAY

APPROVED
PLANNING BOARD
OF HOWARD COUNTY
DATE 9-16-87



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DEVELOPER:
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COLUMBIA, MARYLAND 21045
(301) 730-2616

Dewberry & Davis
ARCHITECTS ENGINEERS PLANNERS SERVITORS

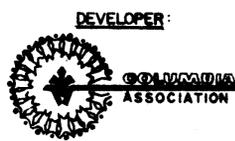5200 Kays Road
Suite 100
Ellicott City, Maryland
21042

301-461-7400
301-461-7400 FAX

ENGINEER'S CERTIFICATE

STATE OF MARYLAND
REGISTERED PROFESSIONAL ENGINEER

John G. [Signature] 11/17/87

DESIGNER'S CERTIFICATE

STATE OF MARYLAND
REGISTERED PROFESSIONAL ENGINEER

Jaqueline A. Slawey 11/15/87

REVIEWED FOR COMPLIANCE WITH DISTRICT AND NEIGHBORHOOD REQUIREMENTS

James M. Helm 11-19-87
U.S. SOIL CONSERVATION SERVICE DATE

THIS DEVELOPMENT IS APPROVED FOR EROSION AND SEDIMENT CONTROL BY THE HOWARD SOIL CONSERVATION DISTRICT

Stephen L. Smith 11/19/87
HOWARD SOIL CONSERVATION DISTRICT

APPROVED FOR PLANNING AND ZONING

U. [Signature] 12/18/87
PLANNING DIRECTOR DATE

James [Signature] 12/18/87
DIRECTOR, PUBLIC WORKS DATE

James [Signature] 12-1-87
CHIEF, BUREAU OF ENGINEERING DATE

BRADSHAW'S HEALTH DEPARTMENT FOR PUBLIC WATER AND SEWERAGE SYSTEMS

Joyce [Signature] 12-1-87

APPROVED DEPARTMENT OF PUBLIC WORKS FOR PUBLIC WATER AND SEWER AND STORM DRAINAGE SYSTEMS AND ROADS.

James [Signature] 11/22/87
DIRECTOR, PUBLIC WORKS DATE

James [Signature] 11/22/87
CHIEF, BUREAU OF ENGINEERING DATE

SUBDIVISION NAME: VILLAGE OF KINGS CONTRIVANCE SECTION/AREA: 1/3 PHASE 2 LOT NUMBER: 42

PLAT NO.: 929 BLOCK NO.: 3 ZONE: NT/09 TAX/ZONE: 42 ELEC. DIST.: 14 TH CENSUS TR.: 9905

WATER CODE: 6 SEWER CODE: 644002

LANDSCAPE PLAN
VILLAGE OF KINGS CONTRIVANCE
DICKINSON NEIGHBORHOOD POOL
SECTION 2, AREA 3
OPEN SPACE LOT 990 PHASE 2
TAX MAP 42 PARCEL 62
6th ELECTION DISTRICT HOWARD COUNTY, MD.
SCALE: 1"=30' DATE: JUNE 30, 1987
REVISED: SEPTEMBER 10, 1987
SHEET 4 OF 5


DRAWN: K.A. FRITZ DESIGNED: B.D. BURTON CHECKED: B.D. BURTON

**DESIGN DATA
SEDIMENT TRAP #1**

1. DRAINAGE AREA TO TRAP: 3.55 AC.I
2. TYPE OF TRAP: STONE OUTLET SEDIMENT TRAP
3. VOLUME REQUIRED: 238 C.Y.
4. VOLUME PROVIDED: 250 C.Y.
5. TRAP SIZE: (TOP DIMENSIONS): 80' x 36'
6. TRAP DEPTH: 3'
7. BOTTOM ELEVATION: 295.60
8. CREST ELEVATION: 299.50
9. CLEAN OUT ELEVATION: 297.00
10. STONE OUTLET LENGTH: 14.2'

CONSTRUCTION SEQUENCE

1. OBTAIN GRADING PERMIT.
 2. INSPECT SEDIMENT CONTROL FEATURES PUT IN PLACE UNDER GRADING PERMIT ISSUED UNDER SDP-88-24 AND MAKE ANY NECESSARY REPAIRS.
 3. CONSTRUCT STORM DRAIN SYSTEM AND ON-SITE UTILITIES. INSTALL INLET PROTECTION DEVICES.
 4. BEGIN BUILDING. DRAINING POOL CONSTRUCTION. CONSTRUCT CURB AND GUTTER AND INSTALL BASE COURSE.
 5. SEDIMENT TRAP SHALL BE REMOVED FROM THE SEDIMENT TRAP WHEN THE CLEANOUT ELEVATION HAS BEEN REACHED.
 6. THE CONTRACTOR SHALL INSPECT AND PROVIDE NECESSARY MAINTENANCE ON THE SEDIMENT AND EROSION CONTROL STRUCTURES SHOWN HEREON, AFTER EACH RAINFALL AND ON A DAILY BASIS.
 7. THE SEDIMENT TRAP SHALL BE OPERATED BY FLOWING THE SEDIMENT FROM SUCH A MANNER AS NOT TO INTERFERE WITH CONSTRUCTION OPERATION OR CAUSE EROSION DOWNGRADE FROM THE SEDIMENT TRAP.
 8. REMOVE SEDIMENT FROM ROADWAYS AND DRESS STONE CONSTRUCTION ENTRANCE AS REQUIRED.
 9. REMOVE STONE CONSTRUCTION ENTRANCE AND STRAM BALE DIKE/SILT FENCE. CLEAN BASE COURSE, APPLY TACK COAT TO BASE COURSE AND LAY SURFACE COURSE.
 10. ALL DISTURBED AREAS DUE TO REMOVAL OF SEDIMENT CONTROL MEASURES SHALL BE GRADED AND STABILIZED WITH PERMANENT SEEDING MIXTURE.
- NOTE: SEDIMENT TRAPS SHALL BE FENCED IN ACCORDANCE WITH CHAPTER 12 OF THE HOWARD COUNTY DESIGN MANUAL VOLUME 1. FENCING SHALL BE SNOW FENCE OR APPROVED EQUAL.

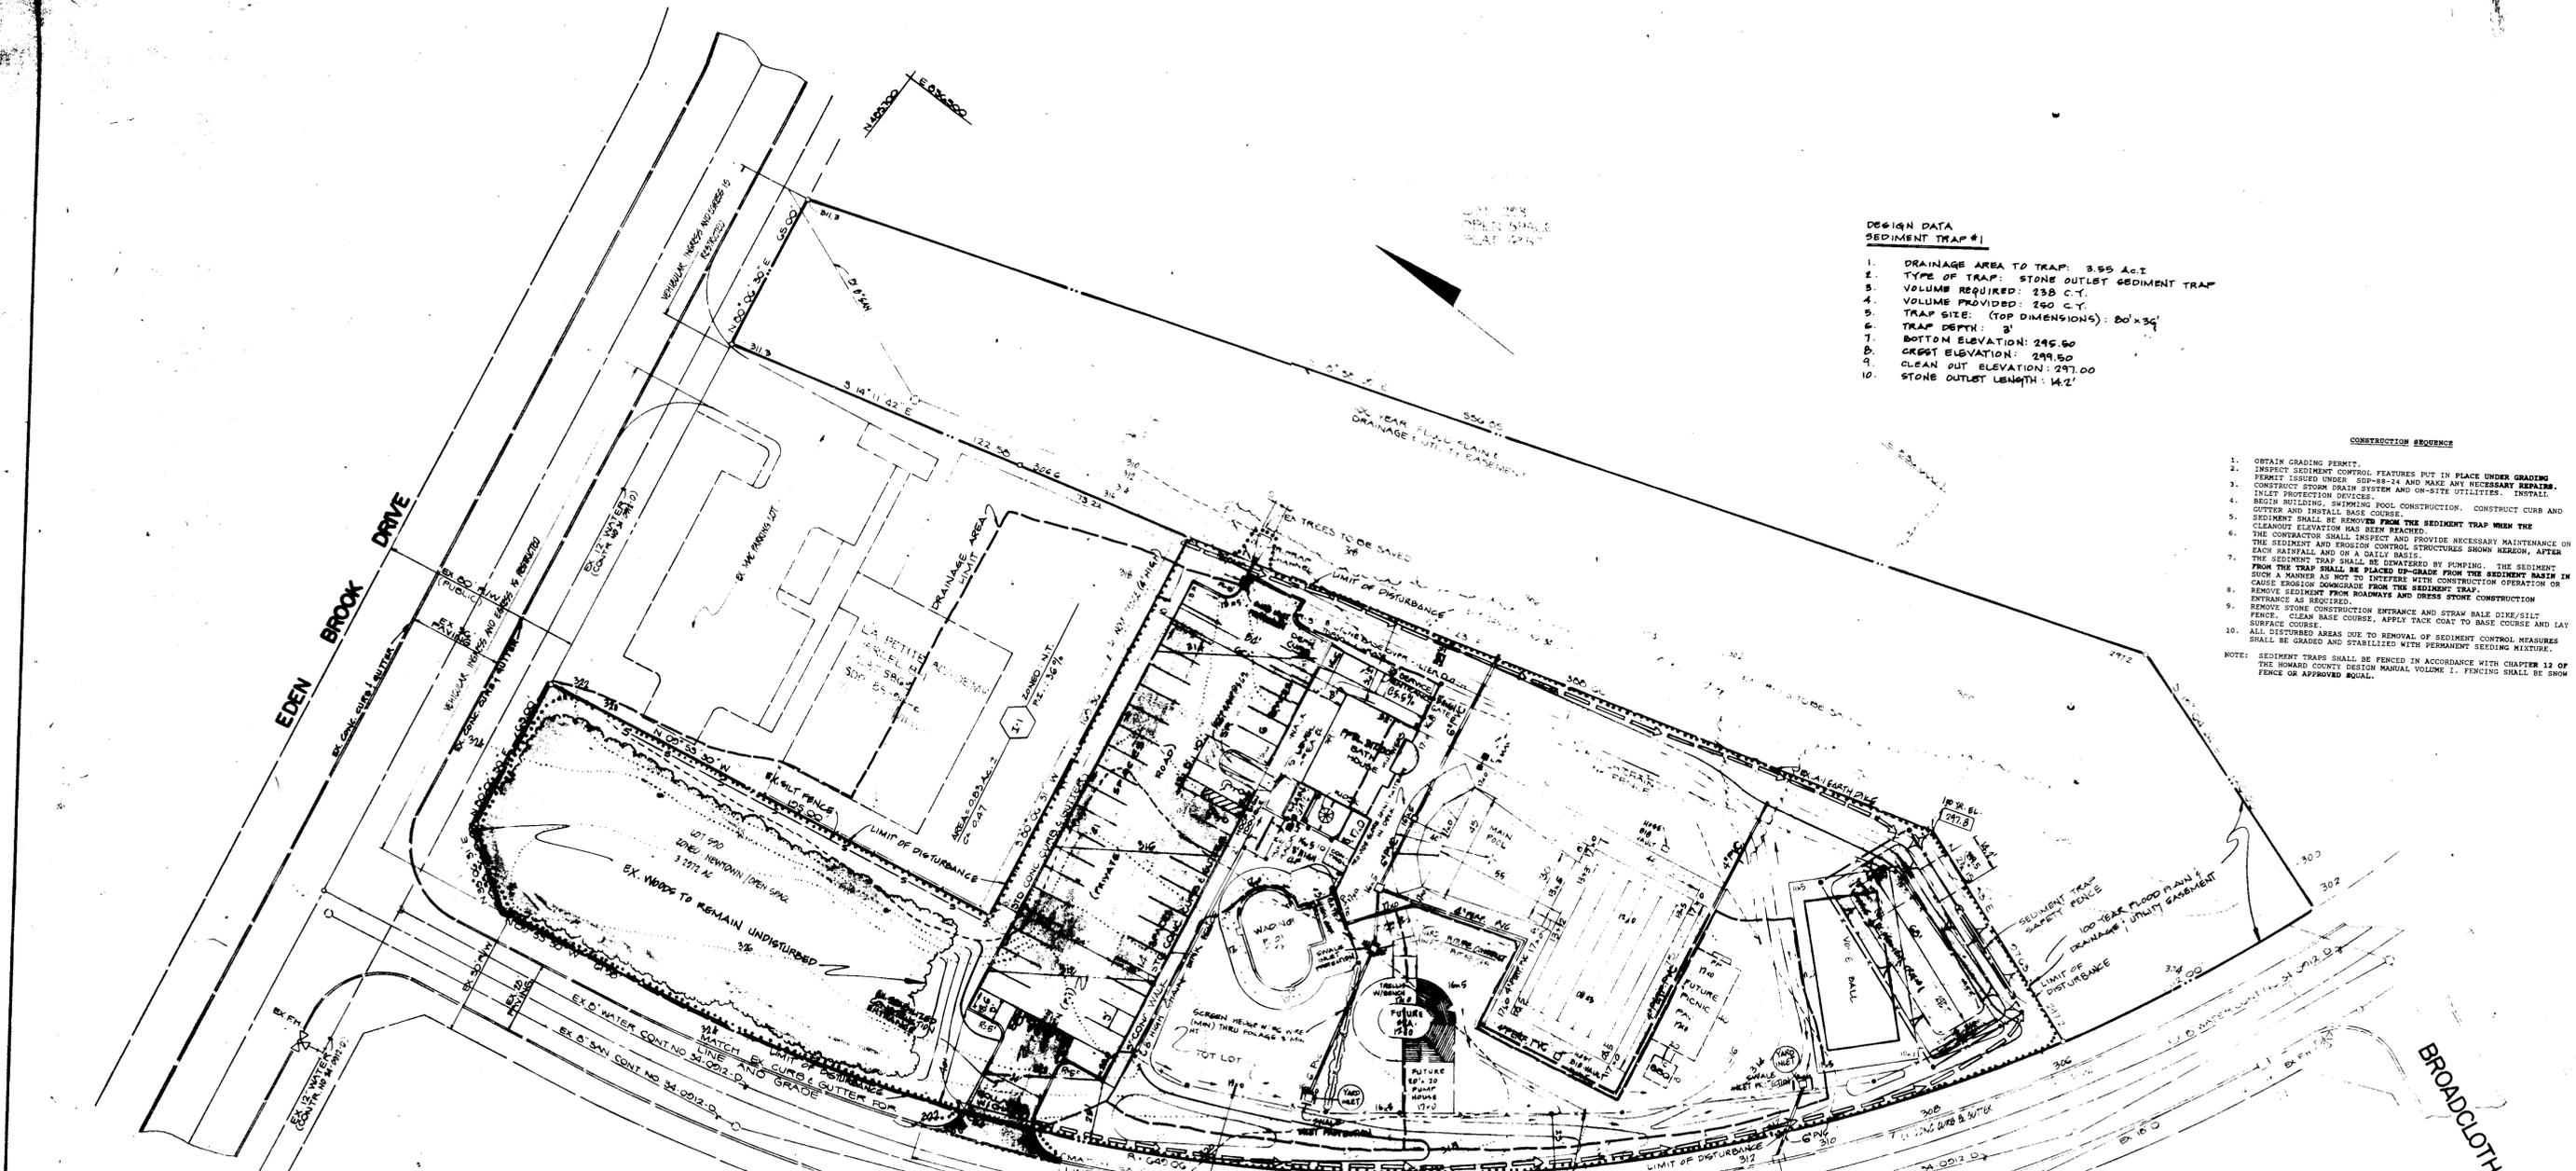

**APPROVED
PLANNING BOARD
OF HOWARD COUNTY**
DATE: 9-16-87



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ARCHITECTS ENGINEERS PLANNERS SERVITORS
3500 N. Ridge Road
Suite 100
Ellicott City, Maryland 21043
(301) 461-7478 BALTIMORE
(301) 621-4970 WASHINGTON

ENGINEER'S CERTIFICATE
I HEREBY CERTIFY THAT THIS PLAN AND ALL WORK CONTAINED HEREON IS A PRACTICAL AND FEASIBLE PLAN BASED ON THE RECORDS OF THE DISTRICT AND THAT I AM PREPARED TO ACCEPT THE REQUIREMENTS OF THE HOWARD SOIL CONSERVATION DISTRICT.

Signature 4/17/87

DEVELOPER'S CERTIFICATE
I HEREBY CERTIFY THAT THE DEVELOPMENT AND CONSTRUCTION OF THE PROJECT DESCRIBED IN THIS PLAN AND ALL WORK CONTAINED HEREON IS IN ACCORDANCE WITH THE DISTRICT AND THAT ALL REQUIREMENTS OF THE DISTRICT HAVE BEEN MET AND THAT I AM PREPARED TO ACCEPT THE REQUIREMENTS OF THE HOWARD SOIL CONSERVATION DISTRICT.

Signature 11/15/87

REVIEWED FOR WASH. SOIL CONSERVATION DISTRICT AND MET. TECHNICAL REQUIREMENTS.

Signature 11-19-87
U.S. SOIL CONSERVATION SERVICE

THIS DEVELOPMENT IS APPROVED FOR EROSION AND SEDIMENT CONTROL BY THE HOWARD SOIL CONSERVATION DISTRICT.

Signature 11/19/87
HOWARD SOIL CONSERVATION DISTRICT

Signature 12/18/87

Signature 12-1-87

Signature 11/22/87

Signature 11/22/87

**SEDIMENT CONTROL PLAN
VILLAGE OF KINGS CONTRIVANCE
DICKINSON NEIGHBORHOOD POOL
SECTION 2, AREA 3
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TAX MAP 42 PARCEL 62
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SHEET 5 OF 5**

DRAWN: K.A. FRITZ | DESIGNED: B.D. BURTON | CHECKED: B.D. BURTON

S.D.P. - 88-24.