


LEGEND

- Existing Contour: - - - - -
- Proposed Contour: ————
- Existing Spot Elevation: 352.3
- Proposed Spot Elevation: +82.53
- Direction of Flow: →
- Existing Trees to Remain: [Tree Symbol]
- Walk Out Basement: [Symbol]
- Proposed Water Quality Swale: [Symbol]

BENCHMARKS

Sta. 35FI	N 170,013.9247	E 410,023.0554	EI.: 122.2752 (meters)
	N 557,787.367	E 1,345,217.304	EI.: 401.165 (feet)
Sta. 36DD	N 170,045.9837	E 411,448.0004	EI.: 119.8332 (meters)
	N 558,056.573	E 1,344,842.314	EI.: 343.153 (feet)

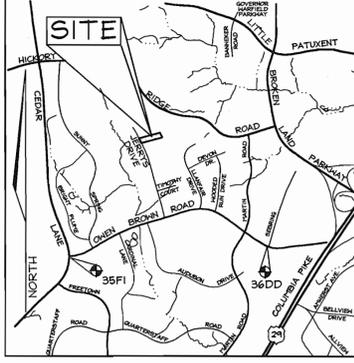




SHEET INDEX

DESCRIPTION	SHEET No.
Site Development Plan	1 of 3
Sediment and Erosion Control and Landscaping Plan	2 of 3
Sediment and Erosion Control Details	3 of 3

- GENERAL NOTES**
- Property is within the Metropolitan District.
 - Public water and sewer will be used within this site.
 - The Contractor shall notify the following utility companies or agencies at least five(5) working days before starting work shown on these plans:
 - Verizon: 1.800.743.0033/410.224.9210
 - AT&T: 1.800.252.1133
 - State Highway Administration: 410.531.5533
 - BGE(Contractor Services): 410.850.4620
 - BGE(Underground Damage Control): 410.787.9068
 - Miss Utility: 1.800.267.7777
 - Colonial Pipeline Company: 410.795.1390
 - Howard County, Dept. of Public Works, Bureau of Utilities: 410.313.4900
 - Howard County Health Department: 410.313.2640
 - The contractor shall notify Miss Utility at 1-800-257-7777 at least 48 hours prior to any excavation work being done.
 - The contractor shall notify the Department of Public Works/Bureau of Engineering Construction Inspection Division at (410) 313-1880 at least five (5) working days prior the start of work.
 - The lots shown hereon comply with the minimum ownership, width and lot area as required by the Maryland State Department of the Environment.
 - On-site topography based on a Field Run Topographic Survey prepared by C.B. Miller & Associates in October, 2001 with one foot contours. Off-site topography based on Howard County 1993 Aerial Topographic Surveys with five foot contours.
 - There are no floodplains or steep slopes on site.
 - The project is in conformance with the latest Howard County Standards unless waivers have been approved.
 - The coordinates shown hereon are based upon the Howard County Geodetic Control which is based on the Maryland State Plane Coordinate system. Howard County monument numbers 35FI and 36DD were used for this project.
 - In accordance with section 128 of the Howard County Zoning Regulations, bay windows, chimneys, or exterior stairways not more than 16 feet in width may project not more than 4 feet into any setbacks. Porches, or decks, open or enclosed may project not more than 10 feet into the front or rear yard setback.
 - Driveway(s) shall be provided prior to issuance of a use and occupancy permit for any new dwelling to insure safe access for fire and emergency vehicles per the following (minimum) requirements:
 - A) Width-12 feet (14' serving more than one residence).
 - B) Surface-6 inches of compacted crusher run base with 1 1/2" Min. tar and chip coating.
 - C) Geometry-max. 15% grade, max. 10% grade change, and 45 foot turning radius.
 - D) Structures (bridges/culverts)-capable of supporting 25 gross tons (H25-loading).
 - E) Drainage elements-capable of safely passing 100 year flood with no more than one foot depth over driveway surface.
 - F) Structure clearance-minimum 12 feet.
 - G) Maintenance-sufficient to insure all weather use.
 - Forest conservation requirements have been provided for this project under F-03-78.
 - For flag or pipe stem lots, refuse collection, snow removal and road maintenance to be provided at the junction of flag or pipe stem and the road r/w and not onto the flag or pipe stem driveway.
 - All Sewer House Connections to be a minimum of 2.0% and a maximum of 5.0% unless otherwise approved by the Department of Public Works. If no slope is shown, 2.0% may be assumed.
 - Landscaping is provided per the approved landscape plan on file with F-03-78.
 - This plan has been prepared in accordance with the provisions of Section 16.124 of The Howard County Code and Landscape Manual. Financial surety for the required 12 trees in the amount of \$3,600.00 for lots 2 and 3. (4 trees, \$1,200.00 for lot 2 and 8 trees, \$2,400.00 for lot 3).
 - There are no wetlands on site. Wetlands evaluation prepared by Exploration Research, Inc. in November, 2001.
 - A. SMI for Channel Protection(Cpv) is not required for this site.
 - B. Water Quality(Nov) for lots 2 and 3 and the new portions of the driveway is provided by disconnecting the roofs and driveways utilizing the Percent Area Method.
 - C. Recharge(Req) for lots 2 and 3 and the new portions of the driveway is provided by disconnecting the roofs and driveways utilizing the Percent Area Method.
 - The property is subject to a design manual waiver from figure 2.17 in Design Manual Volume III, waiving the requirement to perform an 85th percentile speed study. The waiver was approved on February 26, 2002.
 - The property is subject to a waiver of Section 16.132(a)(2)(i)(a) of the Subdivision Regulations of Howard County, waiving the requirement to construct one side of the road up to one-half of the full designated paving section; Section 16.134(b)(1)(i) sidewalks are required on only one side of cul-de-sacs; Section 16.134(a) the developer shall provide street lighting in accordance with the Design Manual; and, Section 16.136 developer shall provide street trees. This waiver, WP-02-100, was approved on May 20, 2002.
 - This subdivision is subject to the fourth edition of the Howard County Subdivision and Land Development regulations.

SITE ANALYSIS DATA CHART

- Total project area: 1.43 Acres
- Area of plan submission: 1.43 Acres
- Limit of disturbed area: 0.9 Acres
- Present zoning: "R-20" per 10/18/93 Comprehensive Zoning Plan.
- Proposed uses for site & structures: single family detached
- Floor space on each level of building(s) per use: See house templates this sheet
- Total number of units allowed: 3
- Total number of units proposed: 2
- Proposed building coverage of site: 0.09 acres; 6.3% of gross lot area
- Howard County file references: F 03-78, SP-02-04, WP-02-100, Contr. #20-3363; Contr. #44-3182

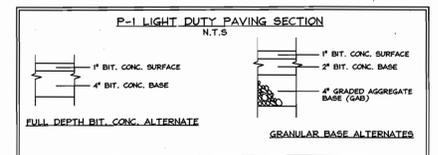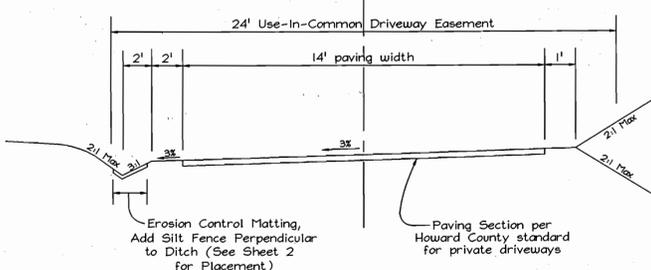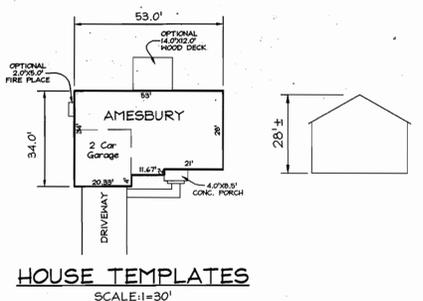

ADDRESS CHART

LOTS	STREET
1	10600 Abigail Drive
2	10604 Abigail Drive
3	10608 Abigail Drive

OWNER/DEVELOPER
 Michael L. Pfau
 3675 Park Avenue
 Ellicott City, MD 21043

SITE DEVELOPMENT PLAN
ABBIE GLEN
 LOTS 1 THRU 3 F-03-78
 TAX MAP 35 GRID 12 PARCEL 179
 5TH ELECTION DISTRICT HOWARD COUNTY, MARYLAND

APPROVED: HOWARD COUNTY DEPARTMENT OF PLANNING AND ZONING
 [Signature] 7/28/03 DATE
 CHIEF, DEVELOPMENT ENGINEERING DIVISION
 [Signature] 7/29/03 DATE
 CHIEF, DIVISION OF LAND DEVELOPMENT
 [Signature] 7/29/03 DATE
 DIRECTOR

TYPICAL DRIVEWAY SECTION
 CLASSIFICATION: USE-IN-COMMON
 NOT TO SCALE

NUMBER	REVISION	DATE


PERMIT INFORMATION CHART

Subdivision Name:	Abbie Glen	Section/Area:	N/A	Lot/Parcel No.:	1-3
Plat #:	15927	Grid:	12	Zoning:	R-20
Water Code:		Tax Map No.:	35	Elect. District:	5th
		Sewer Code:		Census Tract:	6056.02
					E-28
					5375500

FSH Associates
 Engineers Planners Surveyors
 8318 Forrest Street Ellicott City, MD 21043
 Tel: 410-750-2251 Fax: 410-750-7350
 E-mail: FSHAssociates@cs.com


DESIGN BY: PS
 DRAWN BY: AY
 CHECKED BY: ZYF
 SCALE: 1"=30'
 DATE: July 8, 2003
 W.O. No.: 3100
 SHEET No.: 1 OF 3

SOILS LEGEND		
SYMBOL	NAME / DESCRIPTION	SOIL GROUP
ChB2	Chester silt loam, 3 to 8 percent slopes, moderately eroded	B
ChC2	Chester silt loam, 8 to 15 percent slopes, moderately eroded	B
GIB2	Glenns loam, 3 to 8 percent slopes, moderately eroded	B
GIC2	Glenns loam, 8 to 15 percent slopes, moderately eroded	B

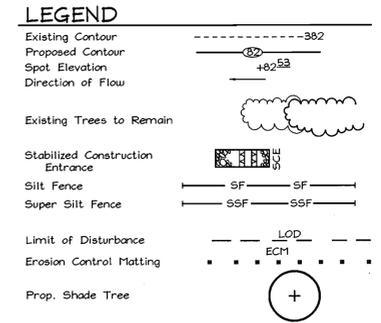

LANDSCAPE SCHEDULE				
KEY	QUAN.	BOTANICAL NAME	SIZE	NOTE
(C)	12	Quercus rubra (Shade Trees) Red Oak	2 1/2"-3" Cal.	B # B


- NOTES:**
- At the time of installation, all shrubs and other plantings herewith listed and approved for this site, shall be of the proper height requirements in accordance with the Howard County Landscaping Manual. In addition, no substitutions or relocation of required plantings may be made without prior review and approval from the Department of Planning and Zoning. Any deviation from this approved Landscape Plan may result in denial or delay in the release of landscape surety until such time as all required materials are planted and/or revisions are made to applicable plans and certificates.
 - This plan has been prepared in accordance with the provisions of Section 16.124 of the Howard County Code and Landscape Manual.
 - Financial surety for the required 12 trees in the amount of \$3,600.00 for lots 2 and 3. (4 trees, \$1,200.00 for lot 2 and 8 trees, \$2,400.00 for lot 3) will be posted as part of the builder's grading permit.

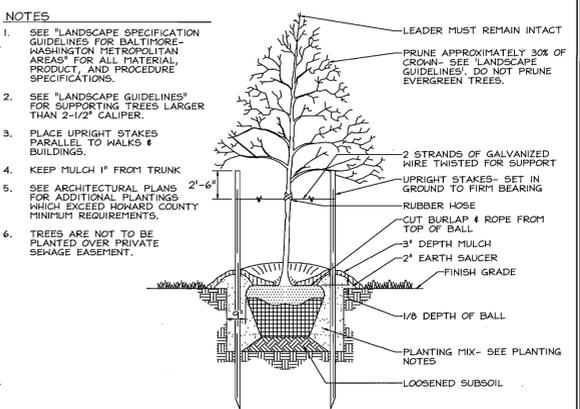

TYPICAL TREE PLANTING AND STAKING
DECIDUOUS TREES UP TO 2-1/2" CALIPER NOT TO SCALE

SCHEDULE A PERIMETER LANDSCAPE EDGE				
CATEGORY	ADJACENT TO ROADWAYS	ADJACENT TO PERIMETER PROPERTIES		
		1	2	3
Perimeter/Frontage Designation		A	A	A
Landscape Type				
Linear Feet of Roadway Frontage/Perimeter		350	124	516
Credit for Existing Vegetation (Yes, No, Linear Feet Describe below if needed)		Yes 40'	Yes 124'	Yes 55'
Credit for Wall, Fence or Berm (Yes, No, Linear Feet Describe below if needed)		No	No	No
Number of Plants Required		1160	5	1160
Shade Trees		-	-	-
Evergreen Trees		-	-	-
Shrubs		-	-	-
Number of Plants Provided		4*	-	8
Shade Trees		-	-	-
Evergreen Trees		-	-	-
Other Trees (2:1 Substitution)		-	-	-
Shrubs (10:1 Substitution)		-	-	-
(Describe Plant Substitution Credits Below if needed)				

* Existing Specimen Tree 2 will remain

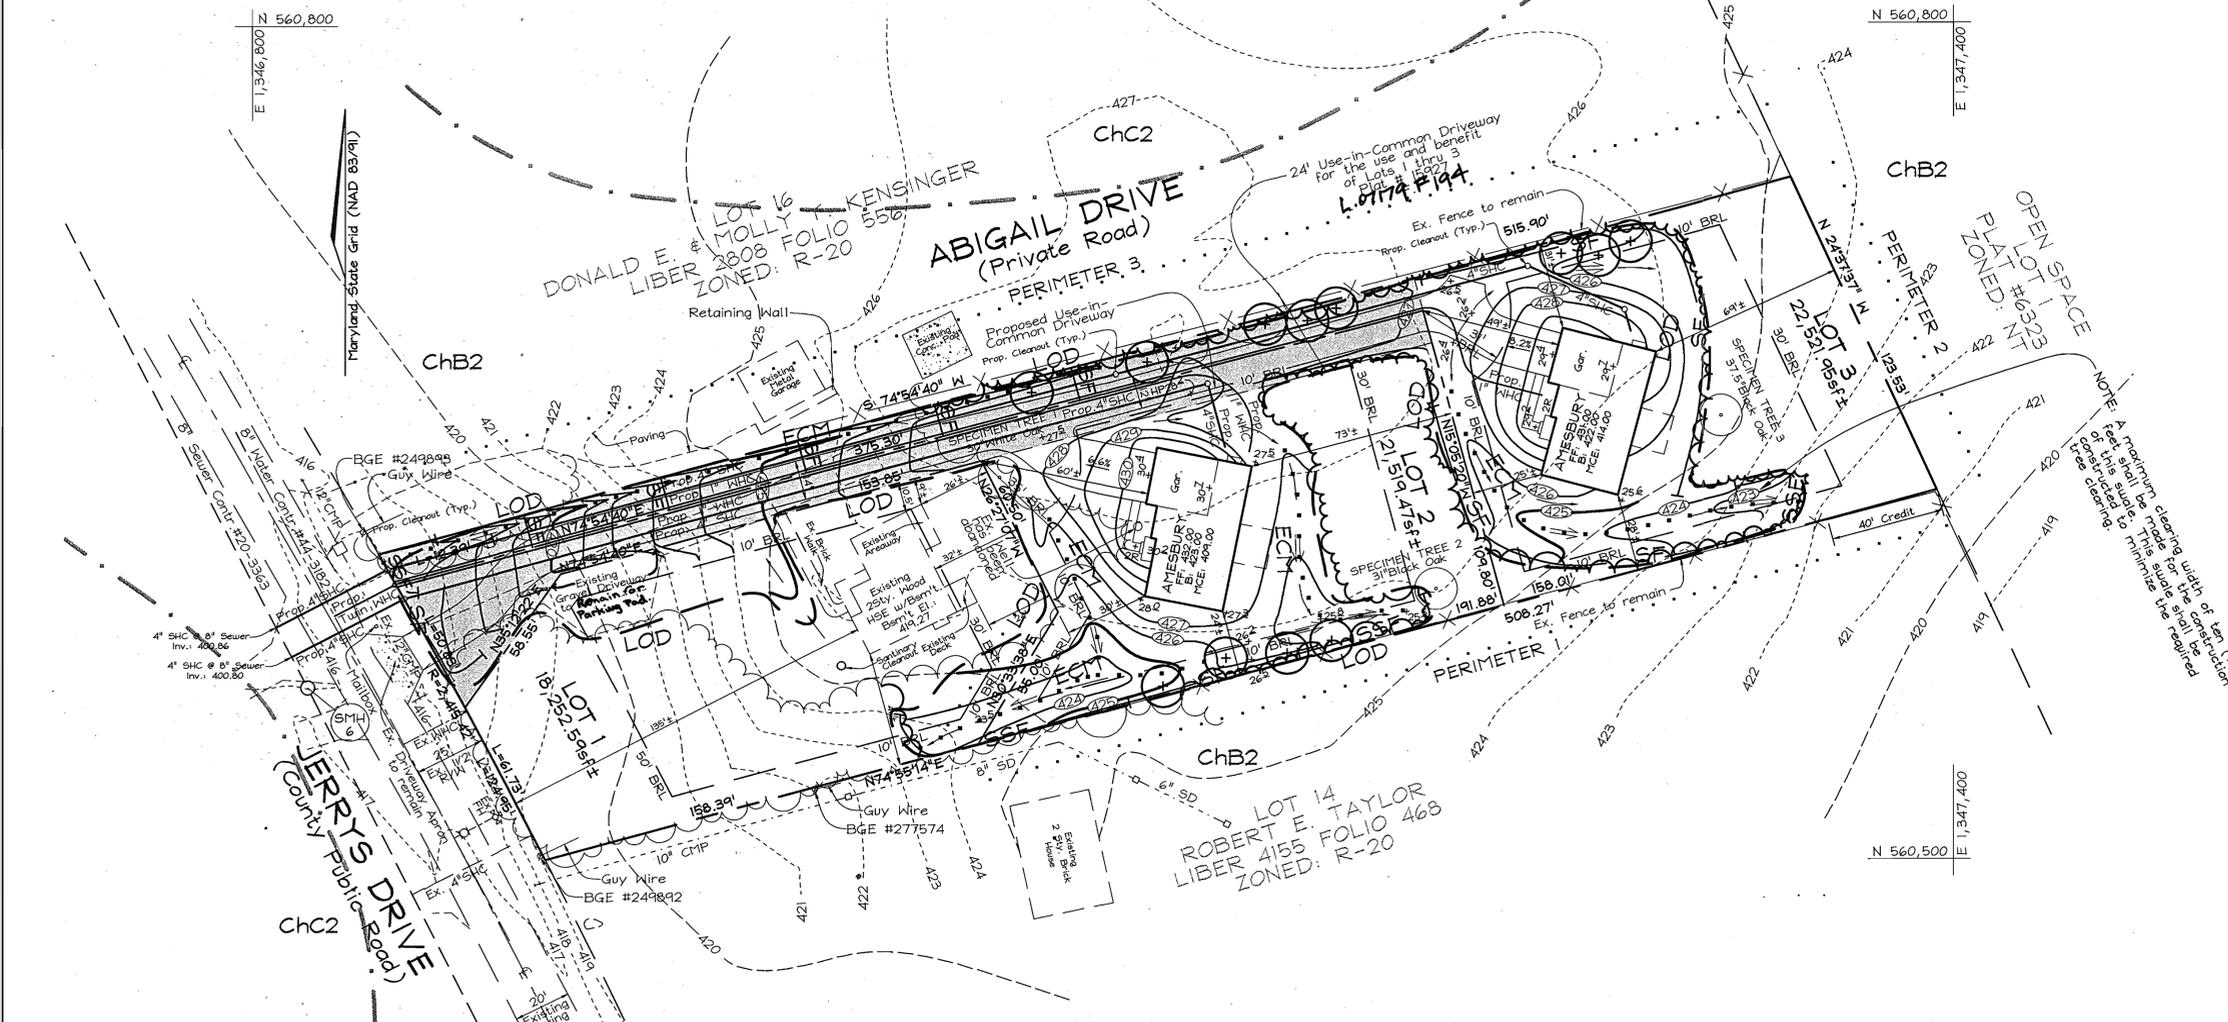

DEVELOPER'S BUILDER'S CERTIFICATE

I/WE CERTIFY THAT THE LANDSCAPING SHOWN ON THIS PLAN WILL BE DONE ACCORDING TO THE PLAN, SECTION 16.124 OF THE HOWARD COUNTY CODE AND THE HOWARD COUNTY LANDSCAPE MANUAL. I/WE FURTHER CERTIFY THAT UPON COMPLETION, A LETTER OF LANDSCAPE INSTALLATION, ACCOMPANIED BY AN EXECUTED ONE(1) YEAR GUARANTEE OF PLANT MATERIALS, WILL BE SUBMITTED TO THE DEPARTMENT OF PLANNING AND ZONING.

SIGNATURE OF DEVELOPER: [Signature] DATE: 7/18/03

APPROVED: HOWARD COUNTY DEPARTMENT OF PLANNING AND ZONING

CHIEF, DEVELOPMENT ENGINEERING DIVISION: [Signature] DATE: 7/29/03

CHIEF, DIVISION OF LAND DEVELOPMENT: [Signature] DATE: 7/29/03

DIRECTOR: [Signature] DATE: 7/29/03

DEVELOPER'S CERTIFICATE

I/WE CERTIFY THAT ALL DEVELOPMENT AND CONSTRUCTION WILL BE DONE ACCORDING TO THIS PLAN FOR SEDIMENT AND EROSION CONTROL AND THAT ALL RESPONSIBLE PERSONNEL INVOLVED IN THE CONSTRUCTION PROJECT WILL HAVE A CERTIFICATE OF ATTENDANCE AT A DEPARTMENT OF THE ENVIRONMENT APPROVED TRAINING PROGRAM FOR THE CONTROL OF SEDIMENT AND EROSION BEFORE BEGINNING THE PROJECT. I ALSO AUTHORIZE PERIODIC ON-SITE INSPECTION BY THE HOWARD SOIL CONSERVATION DISTRICT.

SIGNATURE OF DEVELOPER: [Signature] DATE: 7/18/03

REVIEWED FOR HOWARD SCD AND MEETS TECHNICAL REQUIREMENTS

[Signature] DATE: 7/18/03

USDA-NATURAL RESOURCES CONSERVATION SERVICE

THIS DEVELOPMENT PLAN IS APPROVED FOR SOIL EROSION AND SEDIMENT CONTROL BY THE HOWARD SOIL CONSERVATION DISTRICT

[Signature] DATE: 7/18/03

HOWARD SCD

ENGINEERS CERTIFICATE

I CERTIFY THAT THIS PLAN FOR SEDIMENT AND EROSION CONTROL REPRESENTS A PRACTICAL AND WORKABLE PLAN BASED ON MY PERSONAL KNOWLEDGE OF THE SITE CONDITIONS AND THAT IT WAS PREPARED IN ACCORDANCE WITH THE REQUIREMENTS OF THE HOWARD SOIL CONSERVATION DISTRICT.

[Signature] DATE: 7-9-03

SIGNATURE OF ENGINEER: ZACHARIA Y. FISCH

NUMBER	REVISION	DATE


OWNER/DEVELOPER

Michael L. Pfau
3675 Park Avenue
Elliott City, MD 21043

SEDIMENT AND EROSION CONTROL, AND LANDSCAPING PLAN





ABBIE GLEN
LOTS 1 THRU 3

TAX MAP 35 GRID 12 PARCEL 179
5TH ELECTION DISTRICT HOWARD COUNTY, MARYLAND

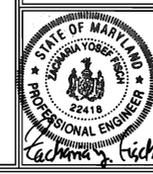

FSH Associates
Engineers Planners Surveyors
8318 Forrest Street, Ellicott City, MD 21043
Tel: 410-750-2251 Fax: 410-750-7350
E-mail: FSHAssociates@cs.com

DESIGN BY: PS
DRAWN BY: AY
CHECKED BY: ZF
SCALE: 1"=30'
DATE: July 8, 2003
W.O. No.: 3100
SHEET No.: 2 OF 3

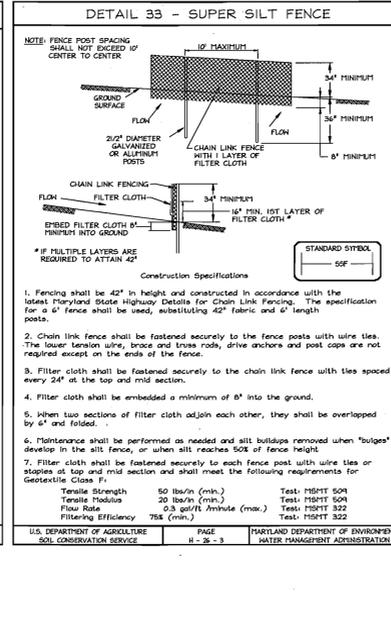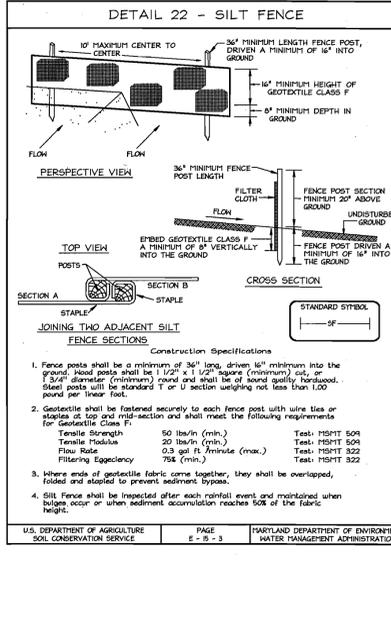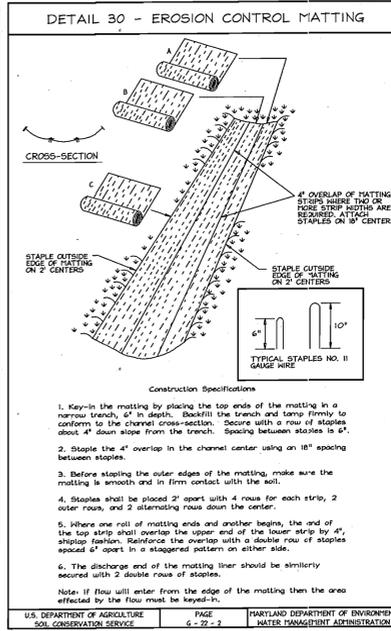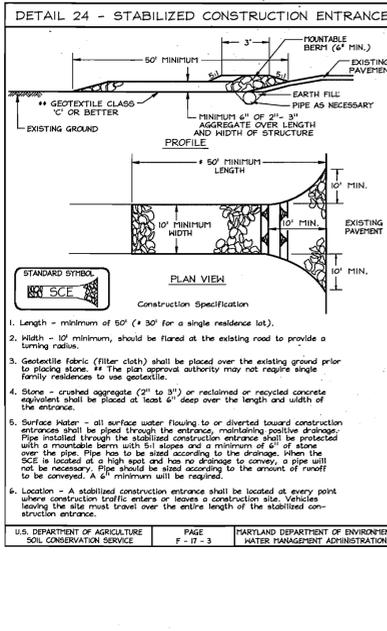

21.0 STANDARDS AND SPECIFICATIONS FOR TOPSOIL

Definition
Placement of topsoil over a prepared subsoil prior to establishment of permanent vegetation.

Purpose
To provide a suitable soil medium for vegetable growth. Soils of certain low moisture content, low nutrient levels, low pH, materials toxic to plants, and/or unacceptable for other reasons shall be replaced.

Conditions Where Practice Applies
1. This practice is limited to areas having 2:1 or flatter slopes where:
a. The texture of the exposed subsoil/parent material is not adequate to produce vegetative growth.
b. The soil material is so shallow that the rooting zone is not deep enough to support plants or furnish continuing supplies of moisture and plant nutrients.
c. The original soil to be vegetated contains material toxic to plant growth.
d. The soil is so acidic that treatment with limestone is not feasible.

2. For the purpose of these Standards and Specifications, areas having slopes steeper than 2:1 require special consideration and design for adequate stabilization, areas having slopes steeper than 2:1 shall have the appropriate stabilization shown on the plans.

Construction and Material Specifications
1. Topsoil salvaged from the existing site may be used provided that it meets the standards as set forth in these specifications. Typically, the depth of topsoil to be salvaged for a given soil type can be found in the representative soil profile section in the Soil Survey published by USDA-SCS in cooperation with Maryland Agricultural Experimental Station.
2. Topsoil Specifications - Soil to be used as topsoil must meet the following:
a. Topsoil shall be a loamy, sandy loam, clay loam, silt loam, sandy clay loam, heavy sand. Other soils may be used if recommended by an agronomist or a soil scientist and approved by the appropriate approval authority. Regardless, topsoil shall not be a mixture of contrasting textures and shall contain less than 5% by volume of chert, rocks, stones, coarse fragments of gravel, sticks, roots, trash, or other materials larger than 1/2\"/>

PERMANENT SEEDING NOTES

APPLY TO GRADED OR CLEARED AREAS NOT SUBJECT TO IMMEDIATE FURTHER DISTURBANCE WHERE A PERMANENT LONG-LIVED VEGETATIVE COVER IS NEEDED.

SEEDBED PREPARATION: Loosen upper three inches of soil by raking, grading or other acceptable means before seeding, if not previously loosened.

SOIL AMENDMENTS: In lieu of soil test recommendations, use one of the following schedules:
1) Preferred-Apply 2 tons per acre dolomitic limestone (92 lbs./1000 sq.ft.) and 600 lbs. per acre 10-10-10 fertilizer (14 lbs./1000 sq.ft.) before seeding. Harrow or disc, to incorporate three inches of soil.
2) Acceptable-Apply 2 tons per acre dolomitic limestone (92 lbs./1000 sq.ft.) and apply 1000 lbs. per acre 10-10-10 fertilizer (23 lbs./1000 sq.ft.) before seeding. Harrow or disc into upper three inches of soil.

SEEDING: For the periods March 1 thru April 30, and August 1 thru October 15, seed with 40 lbs. per acre (14 lbs./1000 sq.ft.) of Turf Type Tall Fescue for the period May 1 thru July 31, seed with 60 lbs. Turf Type Tall Fescue per acre and 2 lbs. per acre (25 lbs./1000 sq.ft.) of seeding legumes. During the period of October 1 thru February 28, protect site by Option (1) 2 tons per acre well anchored straw mulch and seed as soon as possible in the spring. Option (2) Use seed Option (3) Seed with 60 lbs/acre Kentucky 31 Tall Fescue and mulch with 2 tons/acre well anchored straw.

MULCHING: Apply 1/2 to 2 tons per acre (70 to 90 lbs./1000 sq. ft.) of unrotted small grain straw immediately after seeding. Anchor mulch immediately after application using mulch anchoring tool or 200 gallons per acre (5 gal/1000 sq.ft.) of emulsified asphalt on flat areas. On slopes 6 feet or higher, use 340 gallons per acre (8 gal/1000 sq.ft.) for anchoring.

MAINTENANCE: Inspect all seeded areas and make needed repairs, replacements and reseedings.

TEMPORARY SEEDING NOTES
SEEDBED PREPARATION: Apply 600 lbs. per acre 10-10-10 fertilizer (14 lbs./1000 sq.ft.).
SEEDING: For periods March 1 thru April 30 and from August 15 thru November 15, seed with 2 1/2 bushel per acre of annual rye (3.5 lbs./1000 sq.ft.). For the period May 1 thru August 14, seed with 3 lbs. per acre of seeding legumes (07 lbs./1000 sq.ft.). For the period November 1 thru February 28, protect site by applying 2 tons per acre of well anchored straw mulch and seed as soon as possible in the spring.
MULCHING: Apply 1/2 to 2 tons per acre (70 to 90 lbs./1000 sq.ft.) of unrotted small grain straw immediately after seeding. Anchor mulch immediately after application using mulch anchoring tool or 200 gallons per acre (5 gal/1000 sq.ft.) of emulsified asphalt on flat areas. On slopes 6 feet or higher, use 340 gallons per acre (8 gal/1000 sq.ft.) for anchoring.

REFER TO THE NEW MARYLAND STANDARDS AND SPECIFICATIONS FOR SOIL EROSION AND SEDIMENT CONTROL FOR RATE AND METHODS NOT COVERED.

SEDIMENT CONTROL NOTES

1. A minimum of 48 hours notice must be given to the Howard County Department of Inspection, License and Permits Sediment Control Division prior to the start of any construction (313-1880).

2. All vegetation and structural practices are to be installed according to the provisions of this plan and one to be in conformance with the 1994 MARYLAND STANDARDS AND SPECIFICATIONS FOR SOIL EROSION AND SEDIMENT CONTROL and revisions thereto.

3. Following initial soil disturbance or redistribution, permanent or temporary stabilization shall be completed within (a) 7 calendar days for all perimeter sediment control structures, dikes, perimeter slopes, and all slopes greater than 3:1, (b) 14 days for all other disturbed or graded areas on the project site.

4. All sediment traps/basins shown must be fenced and warning signs posted around their perimeter in accordance with Vol. 1, Chapter 7, HOWARD COUNTY DESIGN MANUAL, Storm Drainage.

5. All disturbed areas must be stabilized within the time period specified above in accordance with the 1994 MARYLAND STANDARDS AND SPECIFICATIONS FOR SOIL EROSION AND SEDIMENT CONTROL for permanent seeding, sod, temporary seeding, and mulching (Sec. G). Temporary stabilization with mulch alone shall be done when recommended seeding dates do not allow for proper germination and establishment of grasses.

6. All sediment control structures are to remain in place and are to be maintained in operative condition until permission for their removal has been obtained from the Howard County Sediment Control Inspector.

7. Site Analysis
Total Area: 1.43 Acres
Area Disturbed: 0.21 Acres
Area to be roofed or paved: 0.27 Acres
Area to be vegetatively stabilized: 0.64 Acres
Total Cut: 432 C.Y.
Total Fill: 478 C.Y.
Offsite waste/borrow area location: #1

8. Any sediment control practice which is disturbed by grading activity for placement of utilities must be repaired on the same day of disturbance.

9. Additional sediment controls must be provided, if deemed necessary by the Howard County Sediment Control Inspector.

10. On all sites with disturbed areas in excess of 2 acres, approval of the inspection agency shall be requested upon completion of installation of perimeter erosion and sediment controls, but before proceeding with any other earth disturbance or grading. Other building or grading inspection approvals may not be authorized until this initial approval by the inspection agency is made.

11. Trenches for the construction of utilities is limited to three pipe lengths or that which shall be back-filled and stabilized within one working day, whichever is shorter.
Earthwork quantities are solely for the purpose of calculating fees. Contractor to verify all quantities prior to the start of construction.

12. To be determined by contractor, with pre-approval of the Sediment Control Inspector with an approved and active grading permit.

SEQUENCE OF CONSTRUCTION

1. Obtain Grading permit.
2. Notify Howard County Department of Inspections, License and Permits at (410) 313-1880 at least 24 hours before starting any work.
3. Install Stabilized Construction Entrance, Silt Fence and Super Silt Fence. (1 week)
4. Clear, grub, and rough grade site.
5. Construct use-in-common drive and begin house construction. (2 weeks)
6. Complete house construction, fine grade site, and install Erosion Control Matting. (2 months)
7. Install landscaping. (1 week)
8. During grading and after each rainfall, contractor will inspect and provide necessary maintenance to the sediment control measures on this plan.
9. Following initial soil disturbance or any redistributions, permanent or temporary stabilization shall be completed within:
A. 7 calendar days for all perimeter sediment control structures, dikes, swales and all slopes greater than 3:1.
B. 14 calendar days for all other disturbed areas.
10. Upon stabilization of all disturbed areas and with the permission of the sediment control inspector, remove all sediment control measures and stabilize any remaining disturbed area. (1 week)

SEDIMENT EROSION CONTROL DETAILS

ABBIE GLEN
LOTS 1 THRU 3

TAX MAP 35 GRID 12 PARCEL 179
5TH ELECTION DISTRICT HOWARD COUNTY, MARYLAND



FSH Associates
Engineers Planners Surveyors
6318 Forrest Street, Ellicott City, MD 21043
Tel: 410-750-2251 Fax: 410-750-3350
E-mail: FSHAssociates@cs.com

DESIGN BY: PS
DRAWN BY: AY
CHECKED BY: ZYF
SCALE: 1"=30'
DATE: July 8, 2003
P.L.O. No.: 3100
SHEET No.: 3 OF 3

APPROVED: HOWARD COUNTY DEPARTMENT OF PLANNING AND ZONING
7/15/03
7/29/03
7/15/03

REVIEWED FOR HOWARD SCD AND MEETS TECHNICAL REQUIREMENTS
7/15/03
7/15/03
7/15/03

ENGINEERS CERTIFICATE
I CERTIFY THAT THIS PLAN FOR SEDIMENT AND EROSION CONTROL REPRESENTS A PRACTICAL AND WORKABLE PLAN BASED ON MY PERSONAL KNOWLEDGE OF THE SITE CONDITIONS AND THAT IT WAS PREPARED IN ACCORDANCE WITH THE REQUIREMENTS OF THE HOWARD SOIL CONSERVATION DISTRICT.
7-9-03

DEVELOPER'S CERTIFICATE
I/WE CERTIFY THAT ALL DEVELOPMENT AND CONSTRUCTION WILL BE DONE ACCORDING TO THIS PLAN FOR SEDIMENT AND EROSION CONTROL AND THAT ALL RESPONSIBLE PERSONNEL INVOLVED IN THE CONSTRUCTION PROJECT WILL HAVE A CERTIFICATE OF ATTENDANCE AT A DEPARTMENT OF THE ENVIRONMENT APPROVED TRAINING PROGRAM FOR THE CONTROL OF SEDIMENT AND EROSION BEFORE BEGINNING THE PROJECT. I ALSO AUTHORIZE PERIODIC ON-SITE INSPECTION BY THE HOWARD SOIL CONSERVATION DISTRICT.
7/9/03

OWNER/DEVELOPER
Michael L. Flay
3675 Park Avenue
Ellicott City, MD 21043