

	SHEET INDEX	,
	DESCRIPTION	-
10		
1		
2	SITE DEVELOPMENT PLAN	
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	LANDSCAPE SCHEDULES AND DETAILS	
	THE AND TODAWATED DOAMACE ADEA MAD	
_	PROPOSED CONDITIONS STORMWATER DRAINAGE AREA MAP	
16		
17		
	GENERAL NULLS	
1.	ALL CONSTRUCTION SHALL BE IN ACCORDANCE WITH THE LATEST STANDARDS AND SPECIFICATIONS OF HOWARD COUNTY.	
2.	THE CONTRACTOR SHALL NOTIFY THE DEPARTMENT OF PUBLIC WORKS/BUREAU OF ENGINEERING/	
۷.	CONSTRUCTION INSPECTION DIVISION AT (410) 313-1880 AT LEAST FIVE (5) WORKING DAYS PRIOR TO THE START OF WORK.	
	THE CONTRACTOR SHALL NOTIFY "MISS UTILITY" AT 1-800-257-7777 AT LEAST 48 HOURS PRIOR	
3.	THE CONTRACTOR SHALL NOTIFY MISS UTILITY AT 1-800-237-7777 AT ELAST 48 HOURS FROM	
4.	ALL PLAN DIMENSIONS ARE TO FACE OF CURB AND FACE OF BUILDING UNLESS OTHERWISE NOTED.	
	THE TREAST BUY IS TAKEN FROM HELD SURVEY WITH MAXIMUM TWO FOOT CONTOUR	
5.	INTERVALS PREPARED BY PHR&A, DATED JUNE, 2002 AND AERIAL SURVET BY WINES MAILING BALLE COME,	2001.
6.	THE COORDINATES SHOWN HEREON ARE BASED UPON THE HOWARD COUNTY GEODETIC CONTROL WHICH IS BASED UPON THE MARYLAND STATE PLANE COORDINATE SYSTEM.	
	35C2 AND 35C5 WERE USED.	
7.	WATER IS PUBLIC, CONTRACT NO. 327 S	
8.	SEWER IS PUBLIC, CONTRACT NO. 299-W&S SEWER DRAINAGE AREA: PATUXENT	
. 0.	TREATMENT PLANT: LITTLE PATUXENT WWIP	
9.	APPROXIMATE LOCATION OF EXISTING UTILITIES ARE SHOWN. THE CONTRACTOR SHALL TAKE ALL NECESSARY PRECAUTIONS TO PROTECT THE EXISTING UTILITIES AND MAINTAIN UNINTERRUPTED	
	ARE AND DALLAGE INCURDED DUE TO CONTRACTOR'S OPERATION SHALL BE REPAIRED	
	SERVICE. ANY DAMAGE INCORRED DUE TO CONTRACTOR OF LIGHT ARE SHOWN BASED ON THE BEST IMMEDIATELY AT THE CONTRACTOR'S EXPENSE, EXISTING UTILITIES ARE SHOWN BASED ON THE BEST AVAILABLE INFORMATION.	
17	D. A 100-YEAR FLOODPLAIN STUDY IS NOT REQUIRED FOR THIS PROJECT.	
11	A ROBERTSON, MAG DEEN DEERABED BY EROEHLING AND ROBERTSON, INC.	
12		
1.	<ol> <li>THE PROPERTY LINE SHOWN WAS TAKEN FROM A FIELD SURVEY BY RIEMER MUEGGE A DIVISION PHR&amp;A DATED NOV.2000.</li> </ol>	
	THE PER TOTAL TOTAL OF A NEW TOTAL OF A DEC AREA PER 10-18-93 COMPREHENSIVE ZONING	PLAN.
14	AND FDP-72-A	
1.	5. ALL ELEVATIONS SHOWN ARE BASED ON THE U.S.C. AND G.S. MEAN SEA LEVEL DATUM, 1929.	
1	<ol> <li>SEE DEPARTMENT OF PLANNING AND ZONING FILE NO. SDP-97-45, SDP-75-46, SDP-87-95, SDP-76-30, PB-229, SDP-68-12,SDP-75-32, SDP-00-56, SDP-01-58, WP-01-98, SDP-01-123</li> </ol>	
	FDP-72-A	
1	7. THE CONTRACTOR SHALL TEST PIT EXISTING UTILITIES AT LEAST (5) DAYS BEFORE STARTING WORK SHOWN ON THESE DRAWINGS.	
1	THE REAL PROPONDER FOR CONSTRUCTION MEANS METHODS TECHNIQUES.	
	SEQUENCES, PROCEDURES, AND SAFETY PRECAUTIONS AND PROGRAMS.	
1	<ol> <li>PIPE SHALL NOT BE INSTALLED BY THE CONTRACTOR UNTIL THE LENGTH CALLED FOR AT EACH STATION HAS BEEN APPROVED BY THE ENGINEER IN THE FIELD.</li> </ol>	
	THIN 6"	
2	OF FINISHED GRADE.	
2	21. ALL STORM DRAIN PIPE BEDDING SHALL BE PER HOWARD CO. STANDARD SPECIFICATIONS	
2	22. ALL STORM DRAIN INLETS SHALL BE CONSTRUCTED IN ACCORDANCE WITH HOWARD COUNTY STANDARDS.	
2	23. ALL PIPE ELEVATIONS SHOWN ARE INVERT OF ELEVATIONS.	
	24. STORM DRAIN TRENCHES WITHIN PAVEMENT SHALL BE BACKFILLED AND	
	24. STORM DRAIN TRENCHES WITHIN FAVEMENT SINCLE DE DUNTY DESIGN MANUAL, VOLUME IV, i.e., COMPACTED IN ACCORDANCE WITH THE HOWARD COUNTY DESIGN MANUAL, VOLUME IV, i.e., STANDARD SPECIFICATIONS AND DETAILS FOR CONSTRUCTION, LATEST AMENDMENTS.	
	25. PROFILES STATIONS SHALL BE ADJUSTED AS NECESSARY TO CONFORM TO PLAN	
	DIMENSIONS.	
	26. ALL FILL AREAS WITHIN ROADWAY AND UNDER STRUCTURES TO BE COMPACTED TO A MINIMUM OF 95% COMPACTION OF AASHTO TI80.	
	THIS PROJECT WAS PREPARED BY RIFMER MUEGGE	
	A DIVISION OF PHR&A DATED MARCH 2001	
	28. A TRAFFIC STUDY IS NOT REQUIRED FOR THIS PROJECT.	
	29. ALL PROPOSED AND FUTURE OUTDOOR LIGHTING SHALL COMPLY WITH THE REQUIREMENTS OF	
1	ZONING SECTION 134.	
	30. STORMWATER MANAGEMENT FOR THIS SITE IS PROVIDED VIA BIORETENTION BMP AND AN	
	UNDERGROUND STORAGE FACILITY. THE RECHARGE AND WATER QUALITY VOLUMES WILL BE	
	IN UNDERGROUND PIPES. THE NATURAL AREA CONSERVATION CREDIT HAS BEEN APPLIED TO REDUCE THE WATER QUALITY AND CHANNEL PROTECTION VOLUMES. THE FACILITIES WILL BE	
	PRIVATELY MAINTAINED.	
	31. FOREST CONSERVATION OBLIGATIONS FOR ENTIRE CAMPUS, IN ACCORDANCE WITH SECTION 16.1202	т
	OF THE HOWARD COUNTY CODE AND FOREST CONSERVATION MANUAL, HAVE BEEN MET OF THE PERSONNEL	
	FOR 0.07 ACRES OF REFORESTATION OBLIGATION IN THE AMOUNT OF \$1524.60. SEE SDP-01-58 FOR THE FOREST CONSERVATION PLAN.	-
	THE ANDS STREAMS OR THEIR	
	32. NO CLEARING, GRADING OR CONSTRUCTION IS PERMITTED WITHIN WEILPARDO, STREETING ON ADDRESS BUFFERS AND FOREST CONSERVATION EASEMENT AREAS.	
	$A_{I}$	


مركب ومراجع

# SITE DEVELOPMENT PLAN HOWARD COMMUNITY COLLEGE PARKING LOT 5th ELECTION DISTRICT HOWARD COUNTY, MARYLAND


A PLAN REVISION NOTE: ON OR AROUND JULY 15, ZOIG CAPITAL PROJECT 1158 TITLED HOWARD COMMUNITY COLLEGE BM #2 STREAM REJIDRATION PPOJECT WAS CREATED TO GRADE AND STABILIZE THE EXISTING STREAM BANK ALONG HOCO CONTROL #35-C5 LITLE PATUXENT TRIBUTARY 1 FLUGSTRATED WITHON THE LIMITS OF THIS SITE PLAN. AN ALTERNATIVE COMPLEMENCE ELEV. 452.26 UNDER PROCESSED THROUGH THE DEPARTMENT OF PLANNING AND ZONTING UNDER WITHON WORL ON OCTOBER 21, 2016, S62,148.50 E 1,344,554.47 TO WASYER SECTIONS 16.155 (a)(2)(ii) and 16.1205 (a)(7) OF THE SUBJEVISION AND LADD DEVELOPMENT REGULATIONS SUBJECT TO SIX NUMBER OF APPROVAL CONDITIONS. FOR THE DETAILED CONDITIONS OF ARPROVAL AND THE CURRENT SITE CONDITIONS WITHIN THE DISTURBED AREA PLEASE SEE CAPITAL PROJECT PLAN. 三三三山日 LITTLE PATUXENT S 85'10'40" E 263.15'S FORFS CONSERVAT EASEMENT P +h A +++++++++0+++++++6~ N 564000  $^{\prime}$ BIORETENTION FACILITY FOREST CONSERVATION EASEMENT-N 563600 EX. LABORATORY INSTRUCTIONAL BUILDING SDP-01-123 <u>PLAN</u> SCALE:

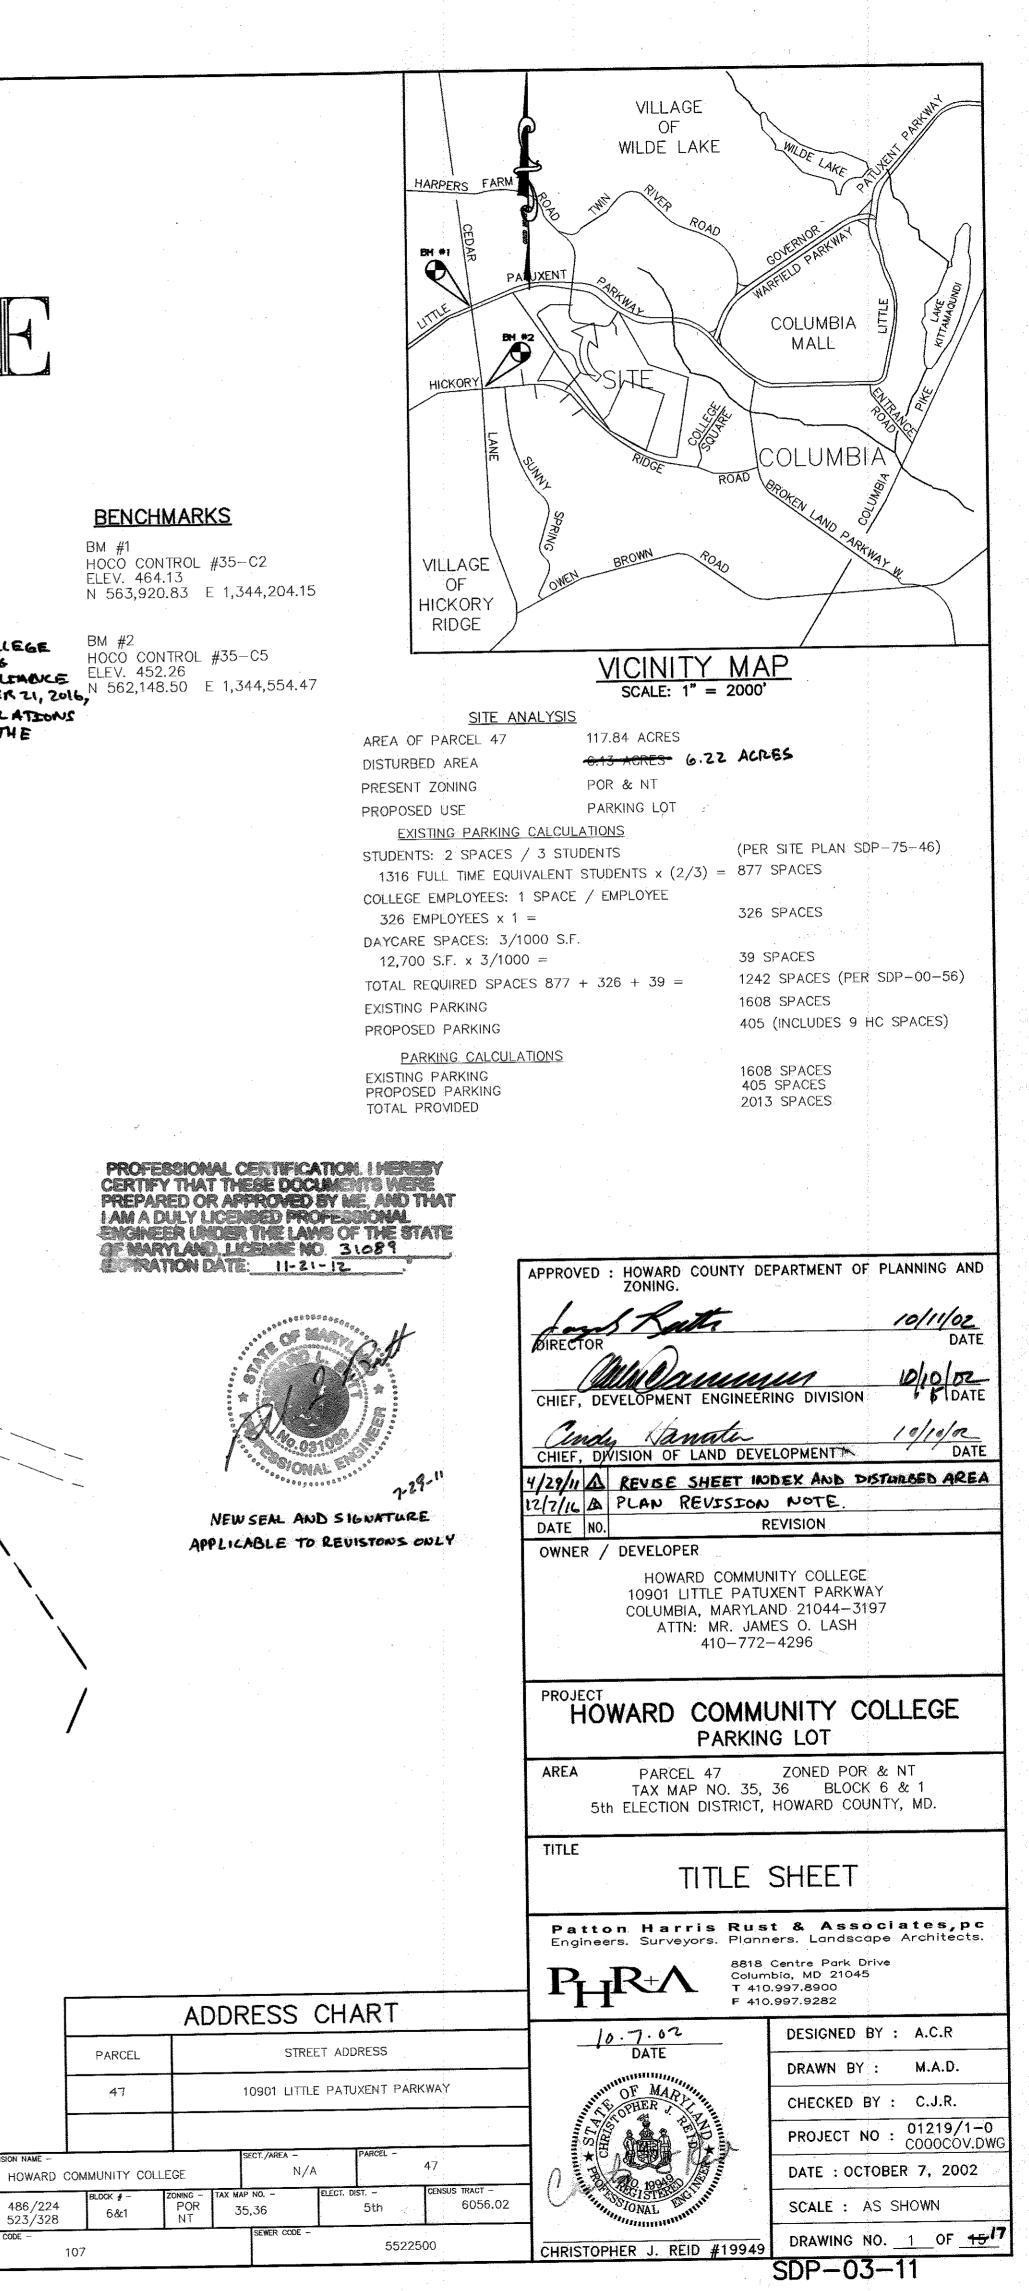

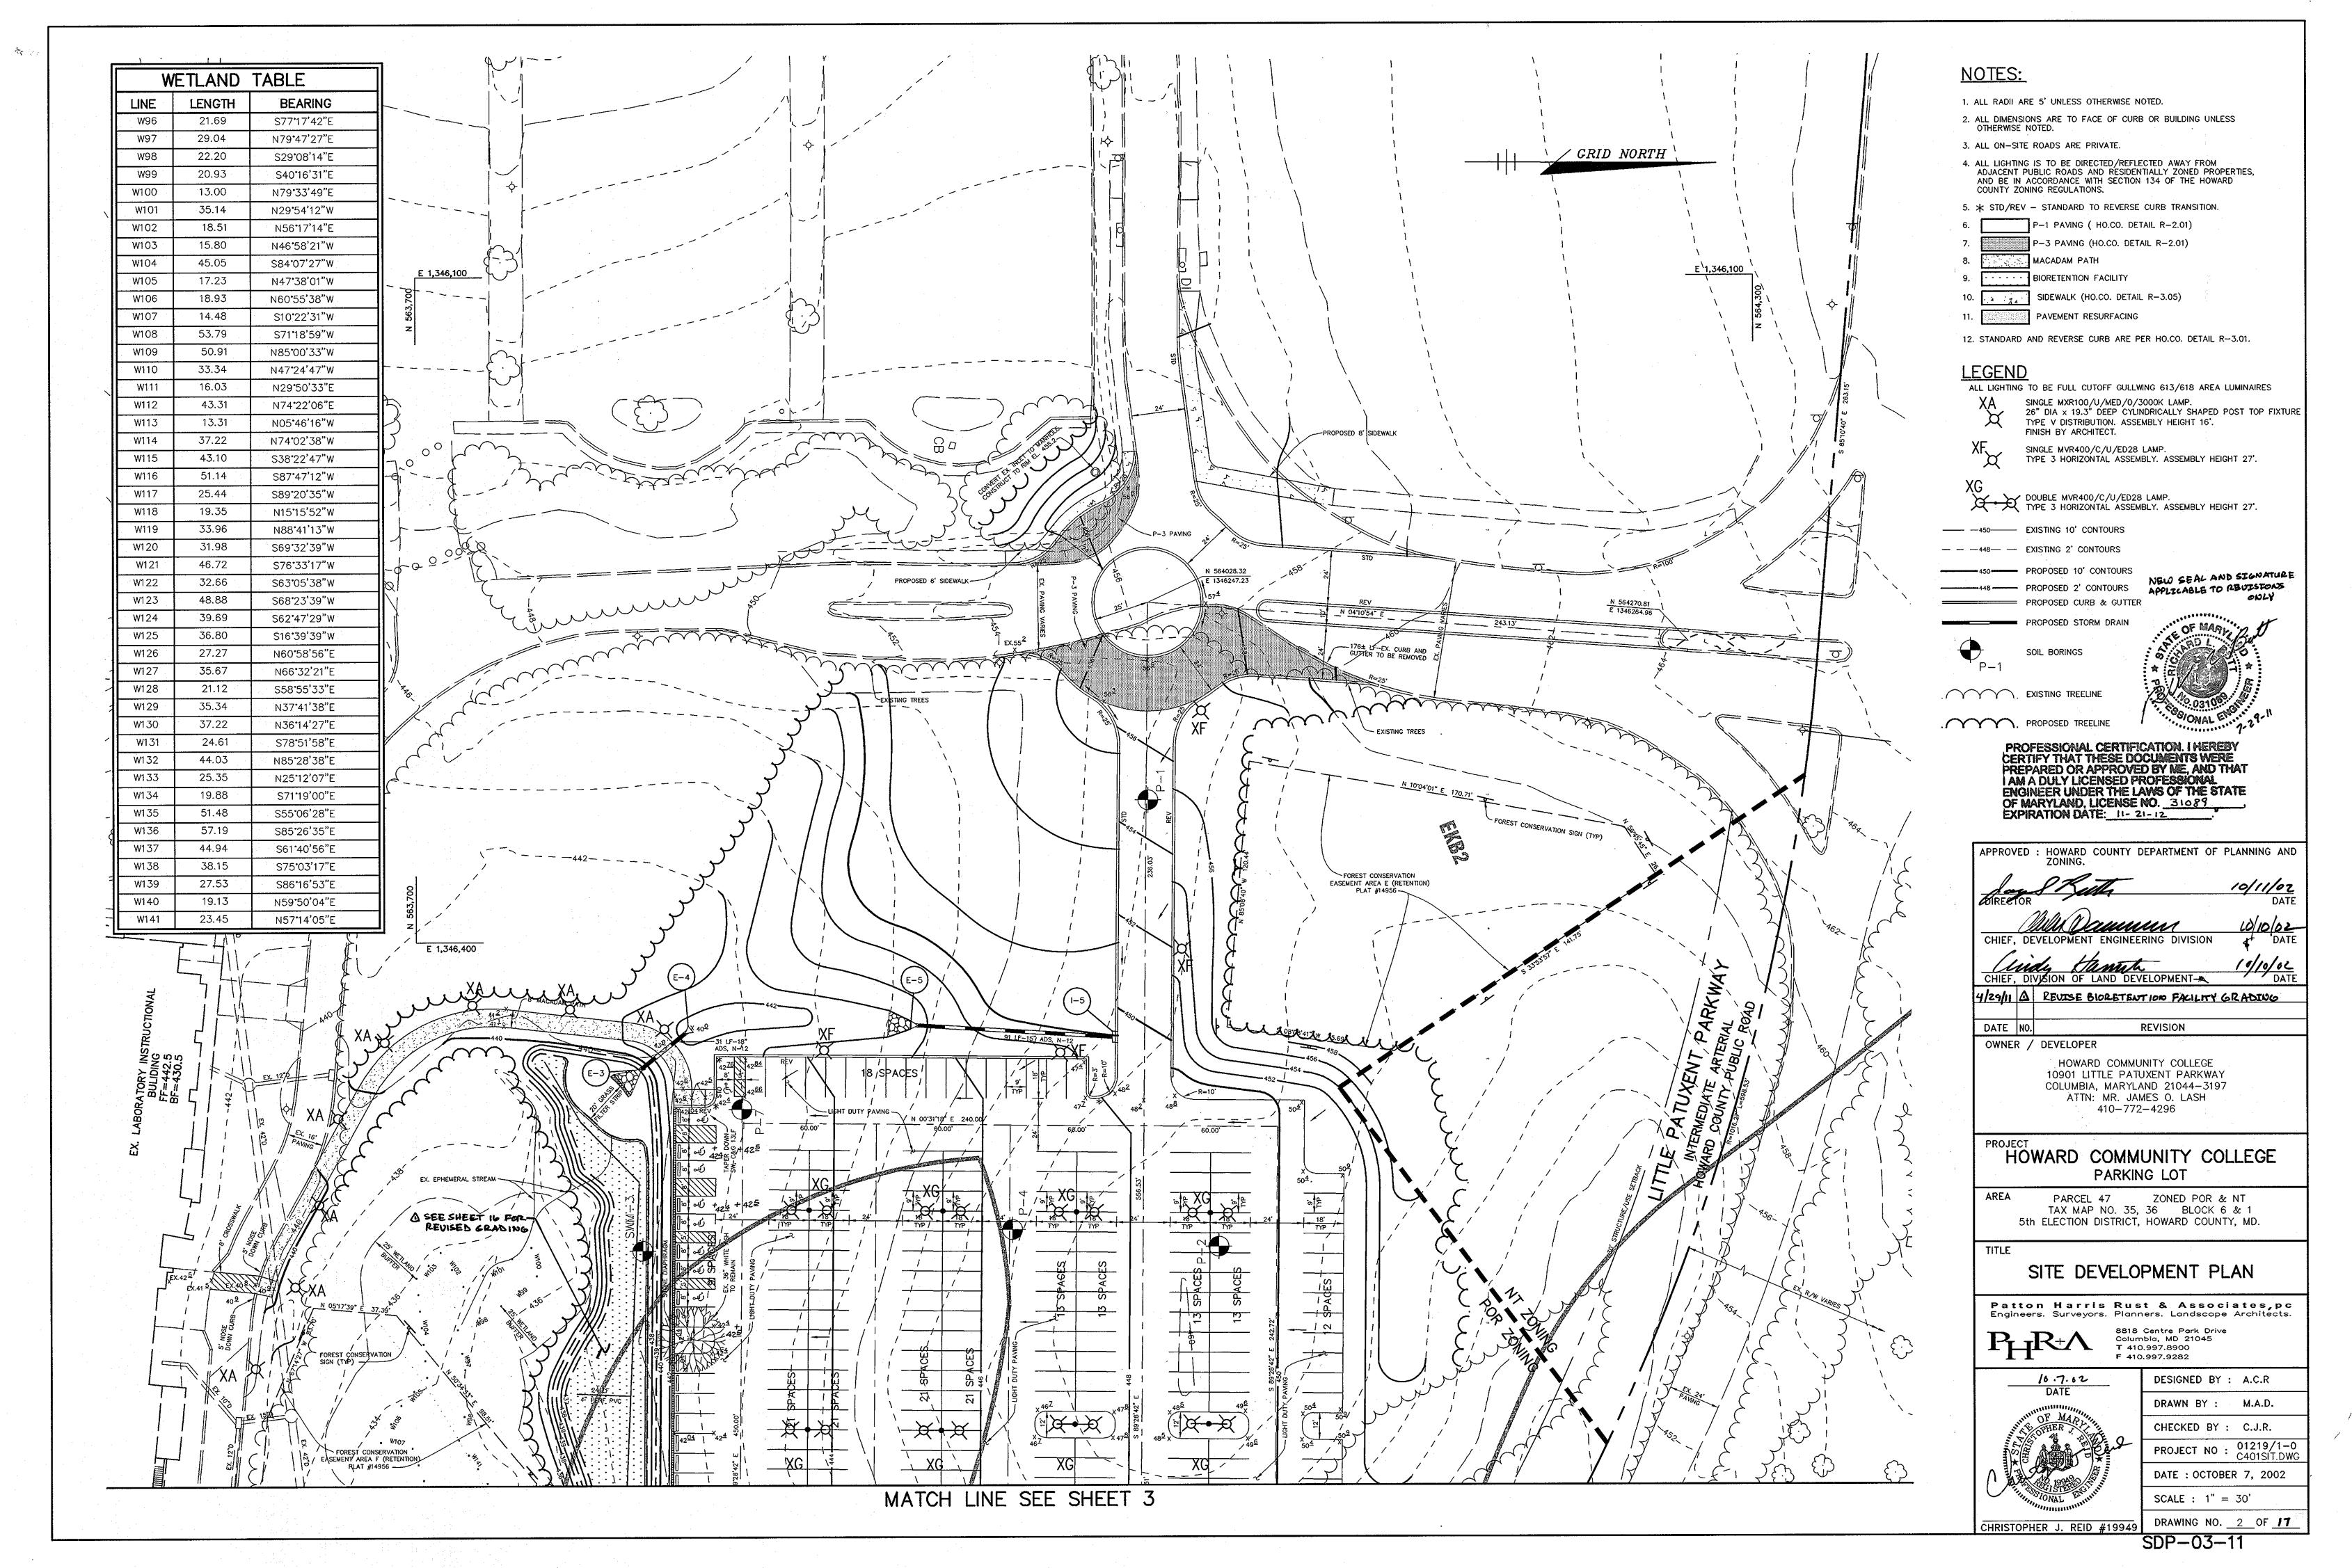

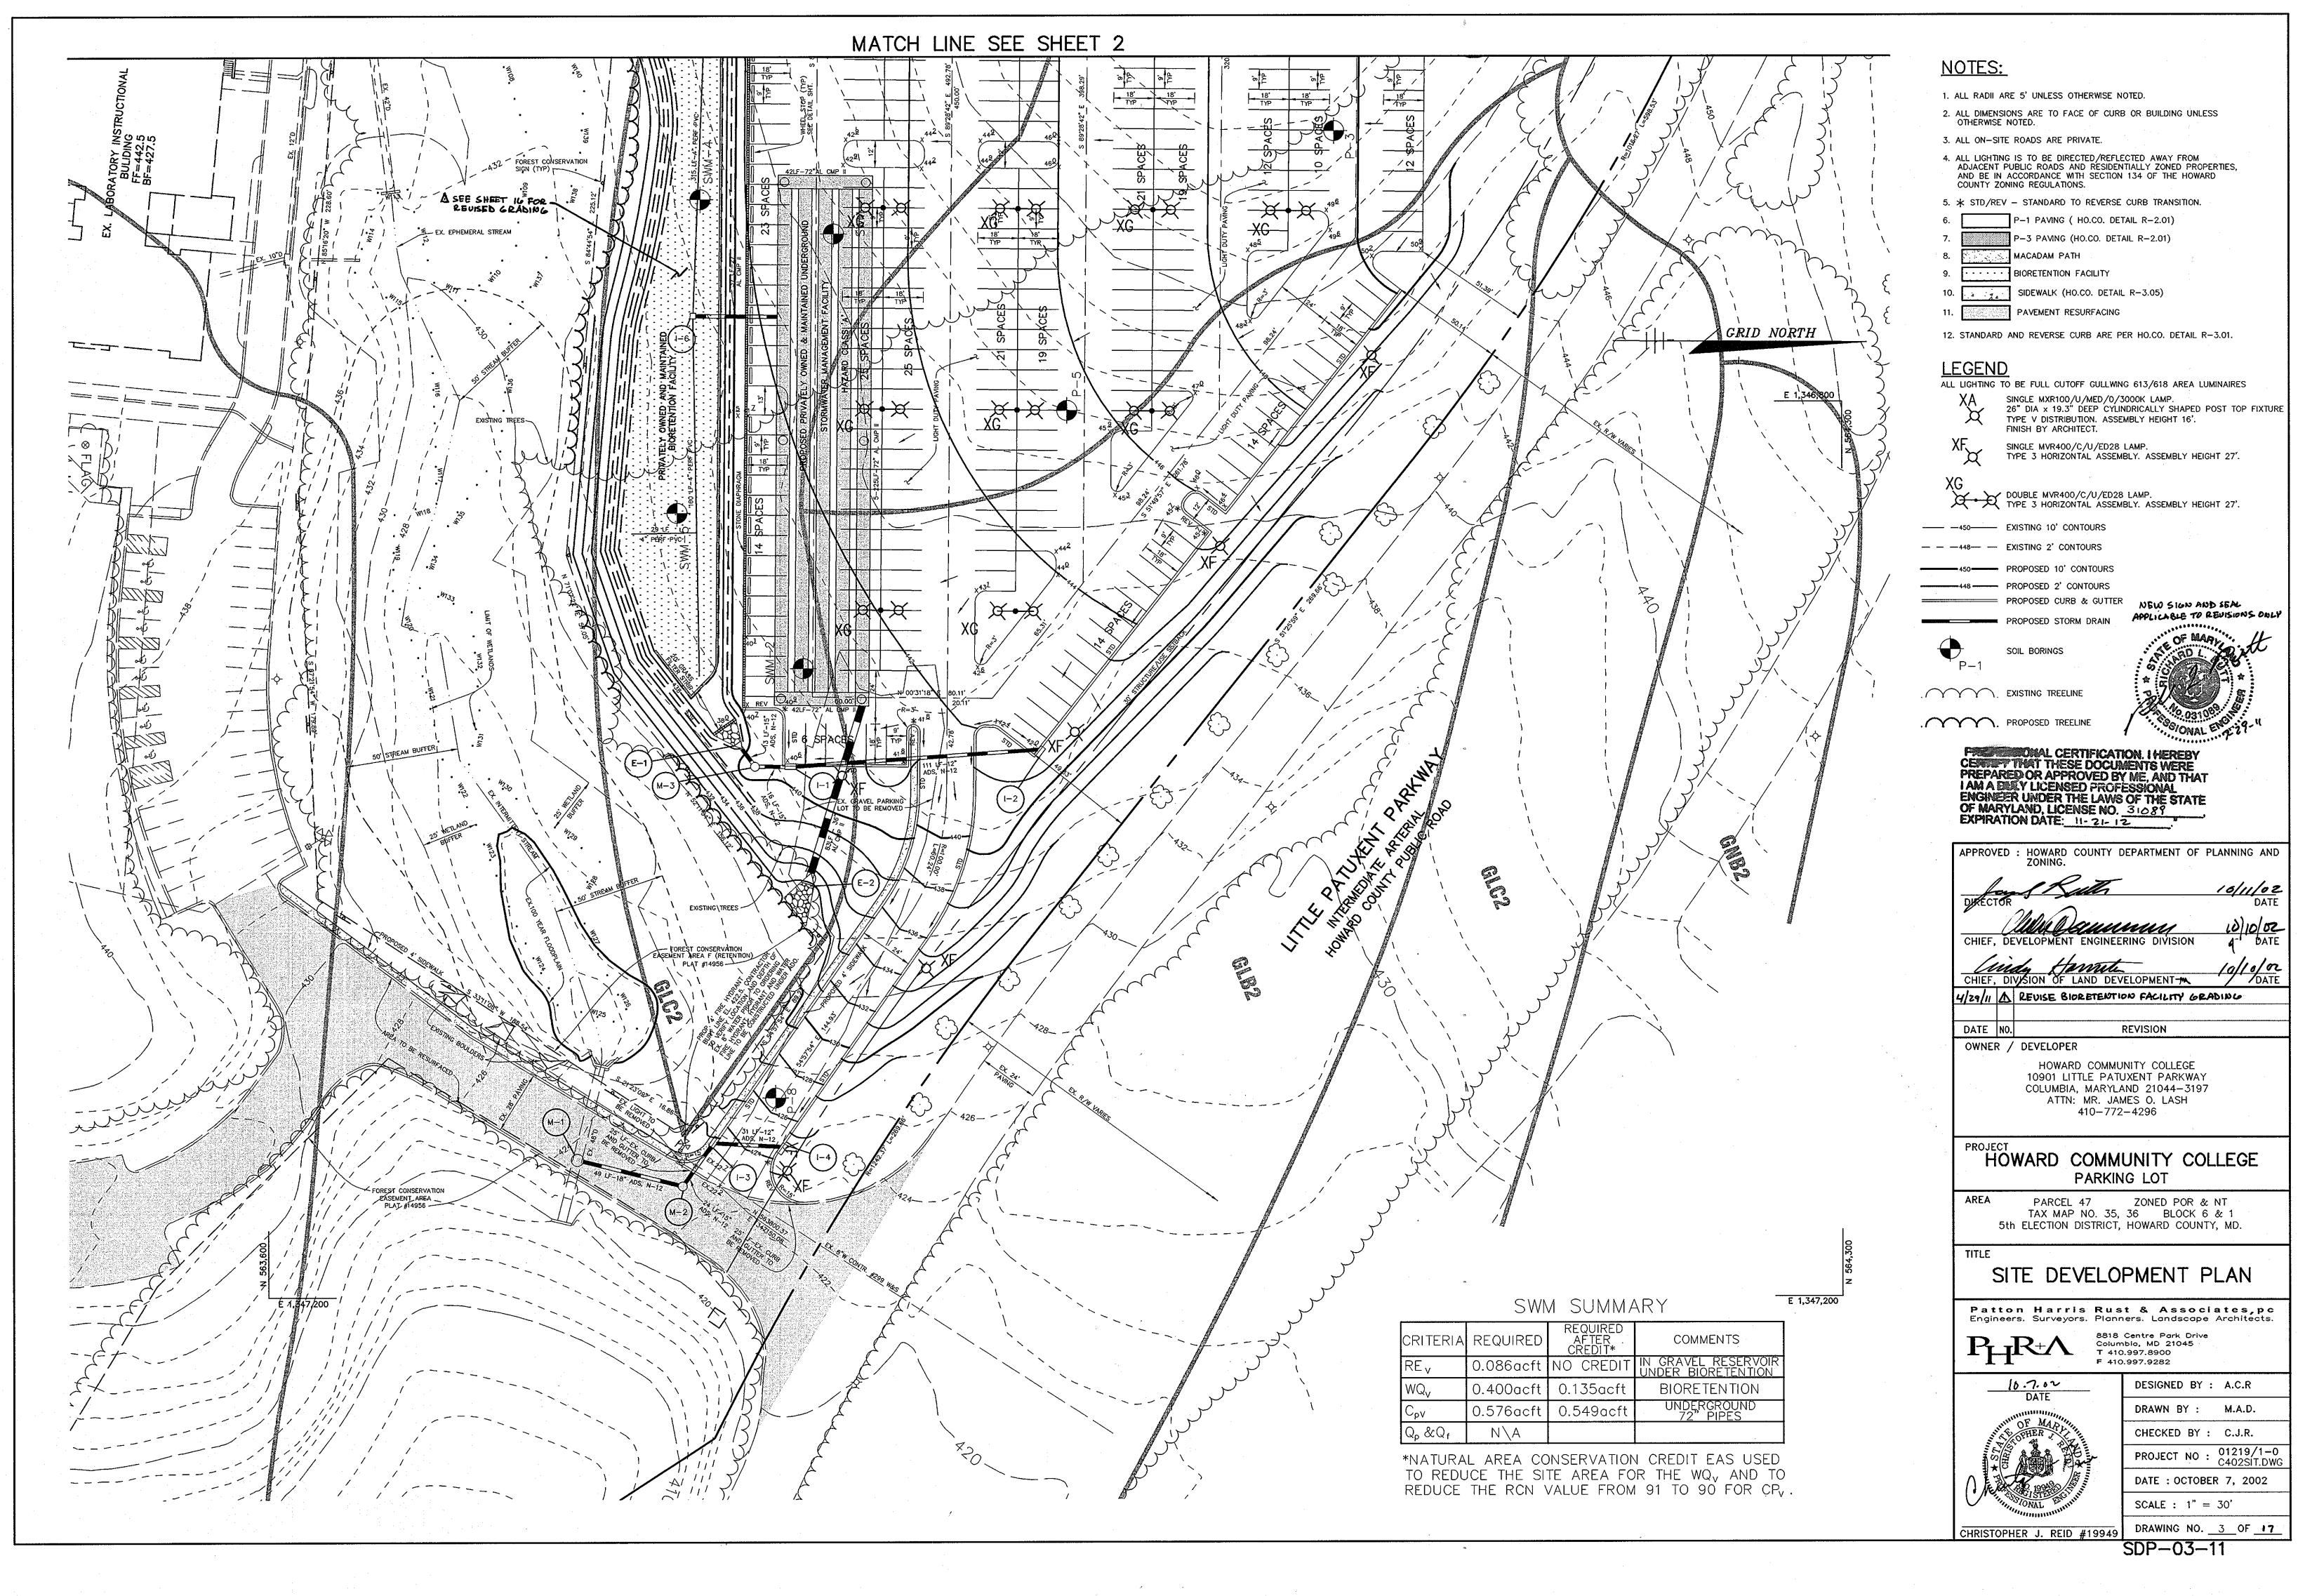

gener – en alta

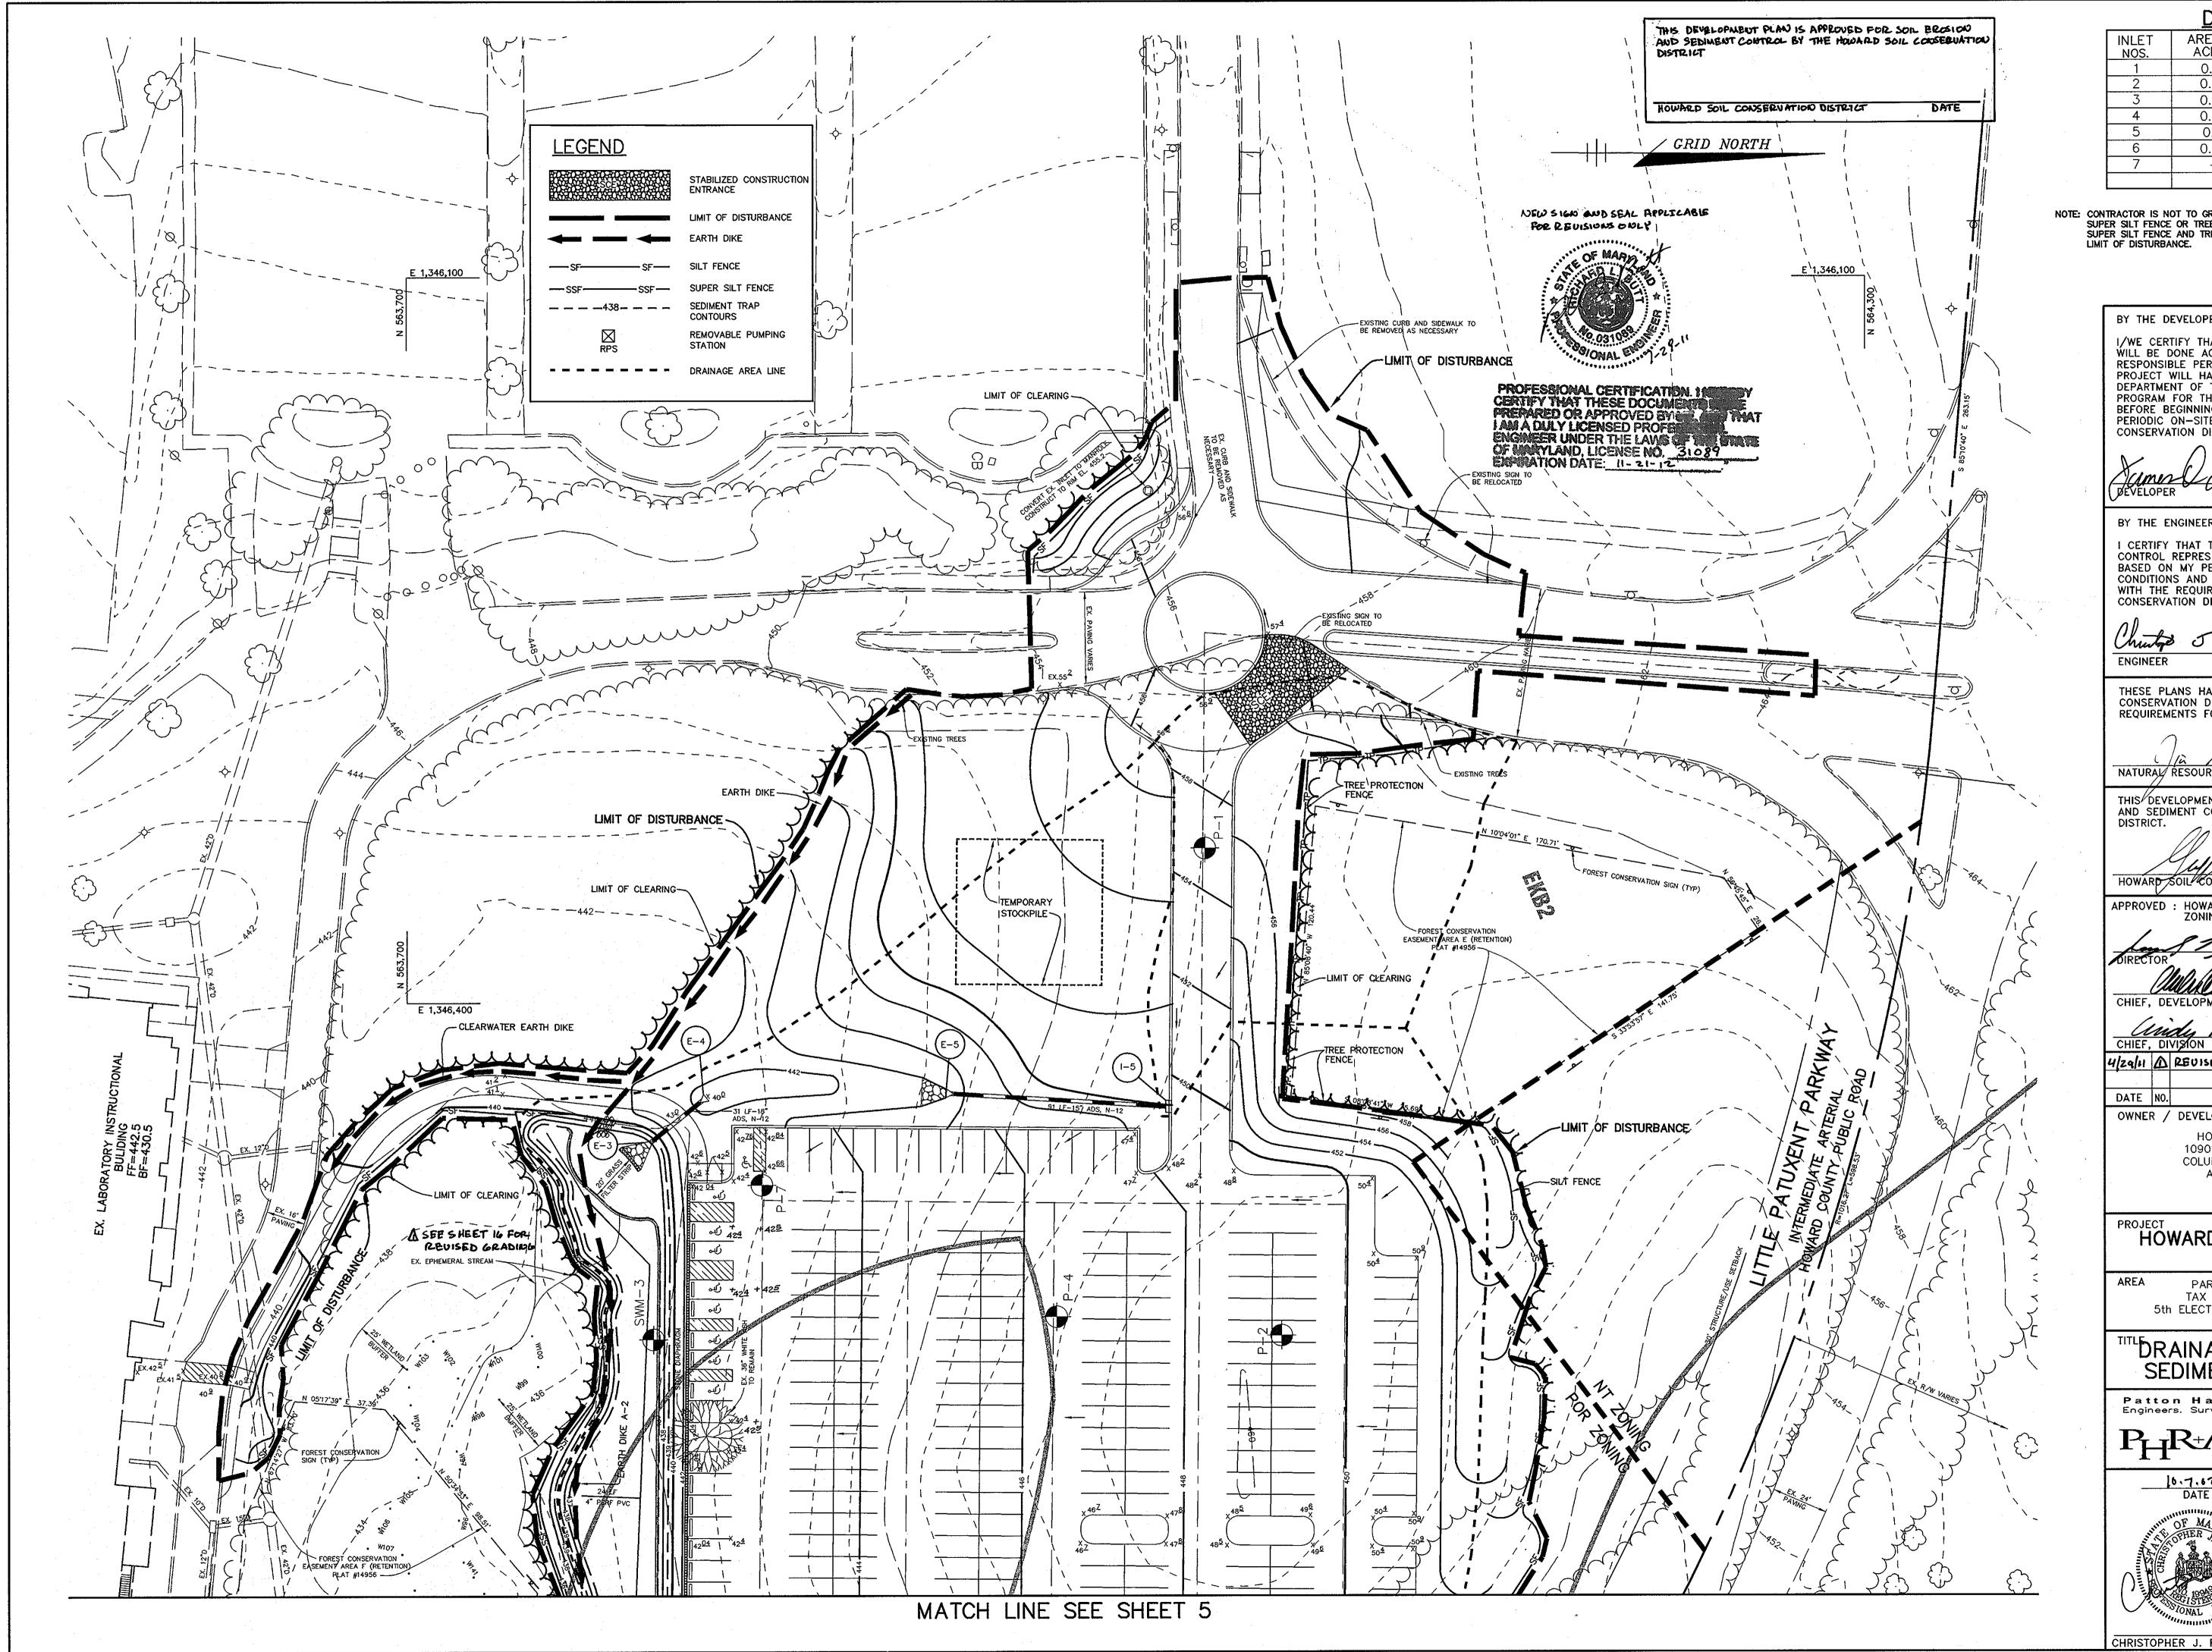

### DRAINAGE DATA AREA IN PERCENT INLET ΎC΄ FACTOR IMPERVIOUS ACRES 0.16 0.86 100 0.20 0.83 95 0.07 0.86 100 0.08 0.86 100 0.86 100 0.11 0.42 0.36 24 ---------------

NOTE: CONTRACTOR IS NOT TO GRADE OR CLEAR PAST SILT FENCE, SUPER SILT FENCE OR TREE PROTECTION FENCE. SILT FENCE, SUPER SILT FENCE AND TREE PROTECTION FENCE ARE LIMIT OF DISTURBANCE.

BY THE DEVELOPER :

I/WE CERTIFY THAT ALL DEVELOPMENT AND CONSTRUCTION WILL BE DONE ACCORDING TO THIS PLAN, AND THAT ANY RESPONSIBLE PERSONNEL INVOLVED IN THE CONSTRUCTION PROJECT WILL HAVE A CERTIFICATE OF ATTENDANCE AT A DEPARTMENT OF THE ENVIRONMENT APPROVED TRAINING PROGRAM FOR THE CONTROL OF SEDIMENT AND EROSION BEFORE BEGINNING THE PROJECT. I ALSO AUTHORIZE PERIODIC ON-SITE INSPECTIONS BY THE HOWARD SOIL CONSERVATION DISTRICT.

ØEVELOPER

10.4.02 DATE

10.7.02

DATE

10/8/02\_\_\_\_\_ DATE

BY THE ENGINEER : I CERTIFY THAT THIS PLAN FOR EROSION AND SEDIMENT CONTROL REPRESENTS A PRACTICAL AND WORKABLE PLAN BASED ON MY PERSONAL KNOWLEDGE OF THE SITE CONDITIONS AND THAT IT WAS PREPARED IN ACCORDANCE WITH THE REQUIREMENTS OF THE HOWARD SOIL CONSERVATION DISTRICT.

THESE PLANS HAVE BEEN REVIEWED FOR THE HOWARD SOIL CONSERVATION DISTRICT AND MEET THE TECHNICAL REQUIREMENTS FOR SOIL EROSION AND SEDIMENT CONTROL.

NATURAL RESOURCES CONSERVATION SERVICE /DATE

THIS DEVELOPMENT PLAN IS APPROVED FOR SOIL EROSION AND SEDIMENT CONTROL BY THE HOWARD SOIL CONSERVATION DISTRICT. 10

HOWARD SOIL CONSERVATION DISTRICT APPROVED : HOWARD COUNTY DEPARTMENT OF PLANNING AND

ZONING. 10/11/02 DATE

MMD aumun 10/10/02 CHIEF, DEVELOPMENT ENGINEERING DIVISION dr<sup>↓</sup> • DATE CHIEF, DIVISION OF LAND DEVELOPMENT DATE

4/29/11 A REVISE BIORETENTION FACILITY GRADING

REVISION OWNER / DEVELOPER HOWARD COMMUNITY COLLEGE 10901 LITTLE PATUXENT PARKWAY COLUMBIA, MARYLAND 21044–3197 ATTN: MR. JAMES O. LASH 410–772–4296


HOWARD COMMUNITY COLLEGE PARKING LOT

PARCEL 47 ZONED POR & NT TAX MAP NO. 35, 36 BLOCK 6 & 1 5th ELECTION DISTRICT, HOWARD COUNTY, MD.


DRAINAGE AREA MAP AND SEDIMENT CONTROL PLAN Patton Harris Rust & Associates,pc Engineers. Surveyors. Planners. Landscape Architects. 8818 Centre Park Drive Columbia, MD 21045 T 410.997.8900  $H^{R+}$ F 410.997.9282 DESIGNED BY · A.C.R 10.7.62

DATE	DESIGNED DT : A.C.R
	DRAWN BY : M.A.D.
OF MAP	CHECKED BY : C.J.R.
	PROJECT NO : 01219/1-0 C201ESC.DWG
	DATE : OCTOBER 7, 2002
I THE STONAL ENGLISHING	SCALE : 1" = 30'
CHRISTOPHER J. REID #19949	DRAWING NO. <u>4</u> OF <u>17</u>

SDP-03-11

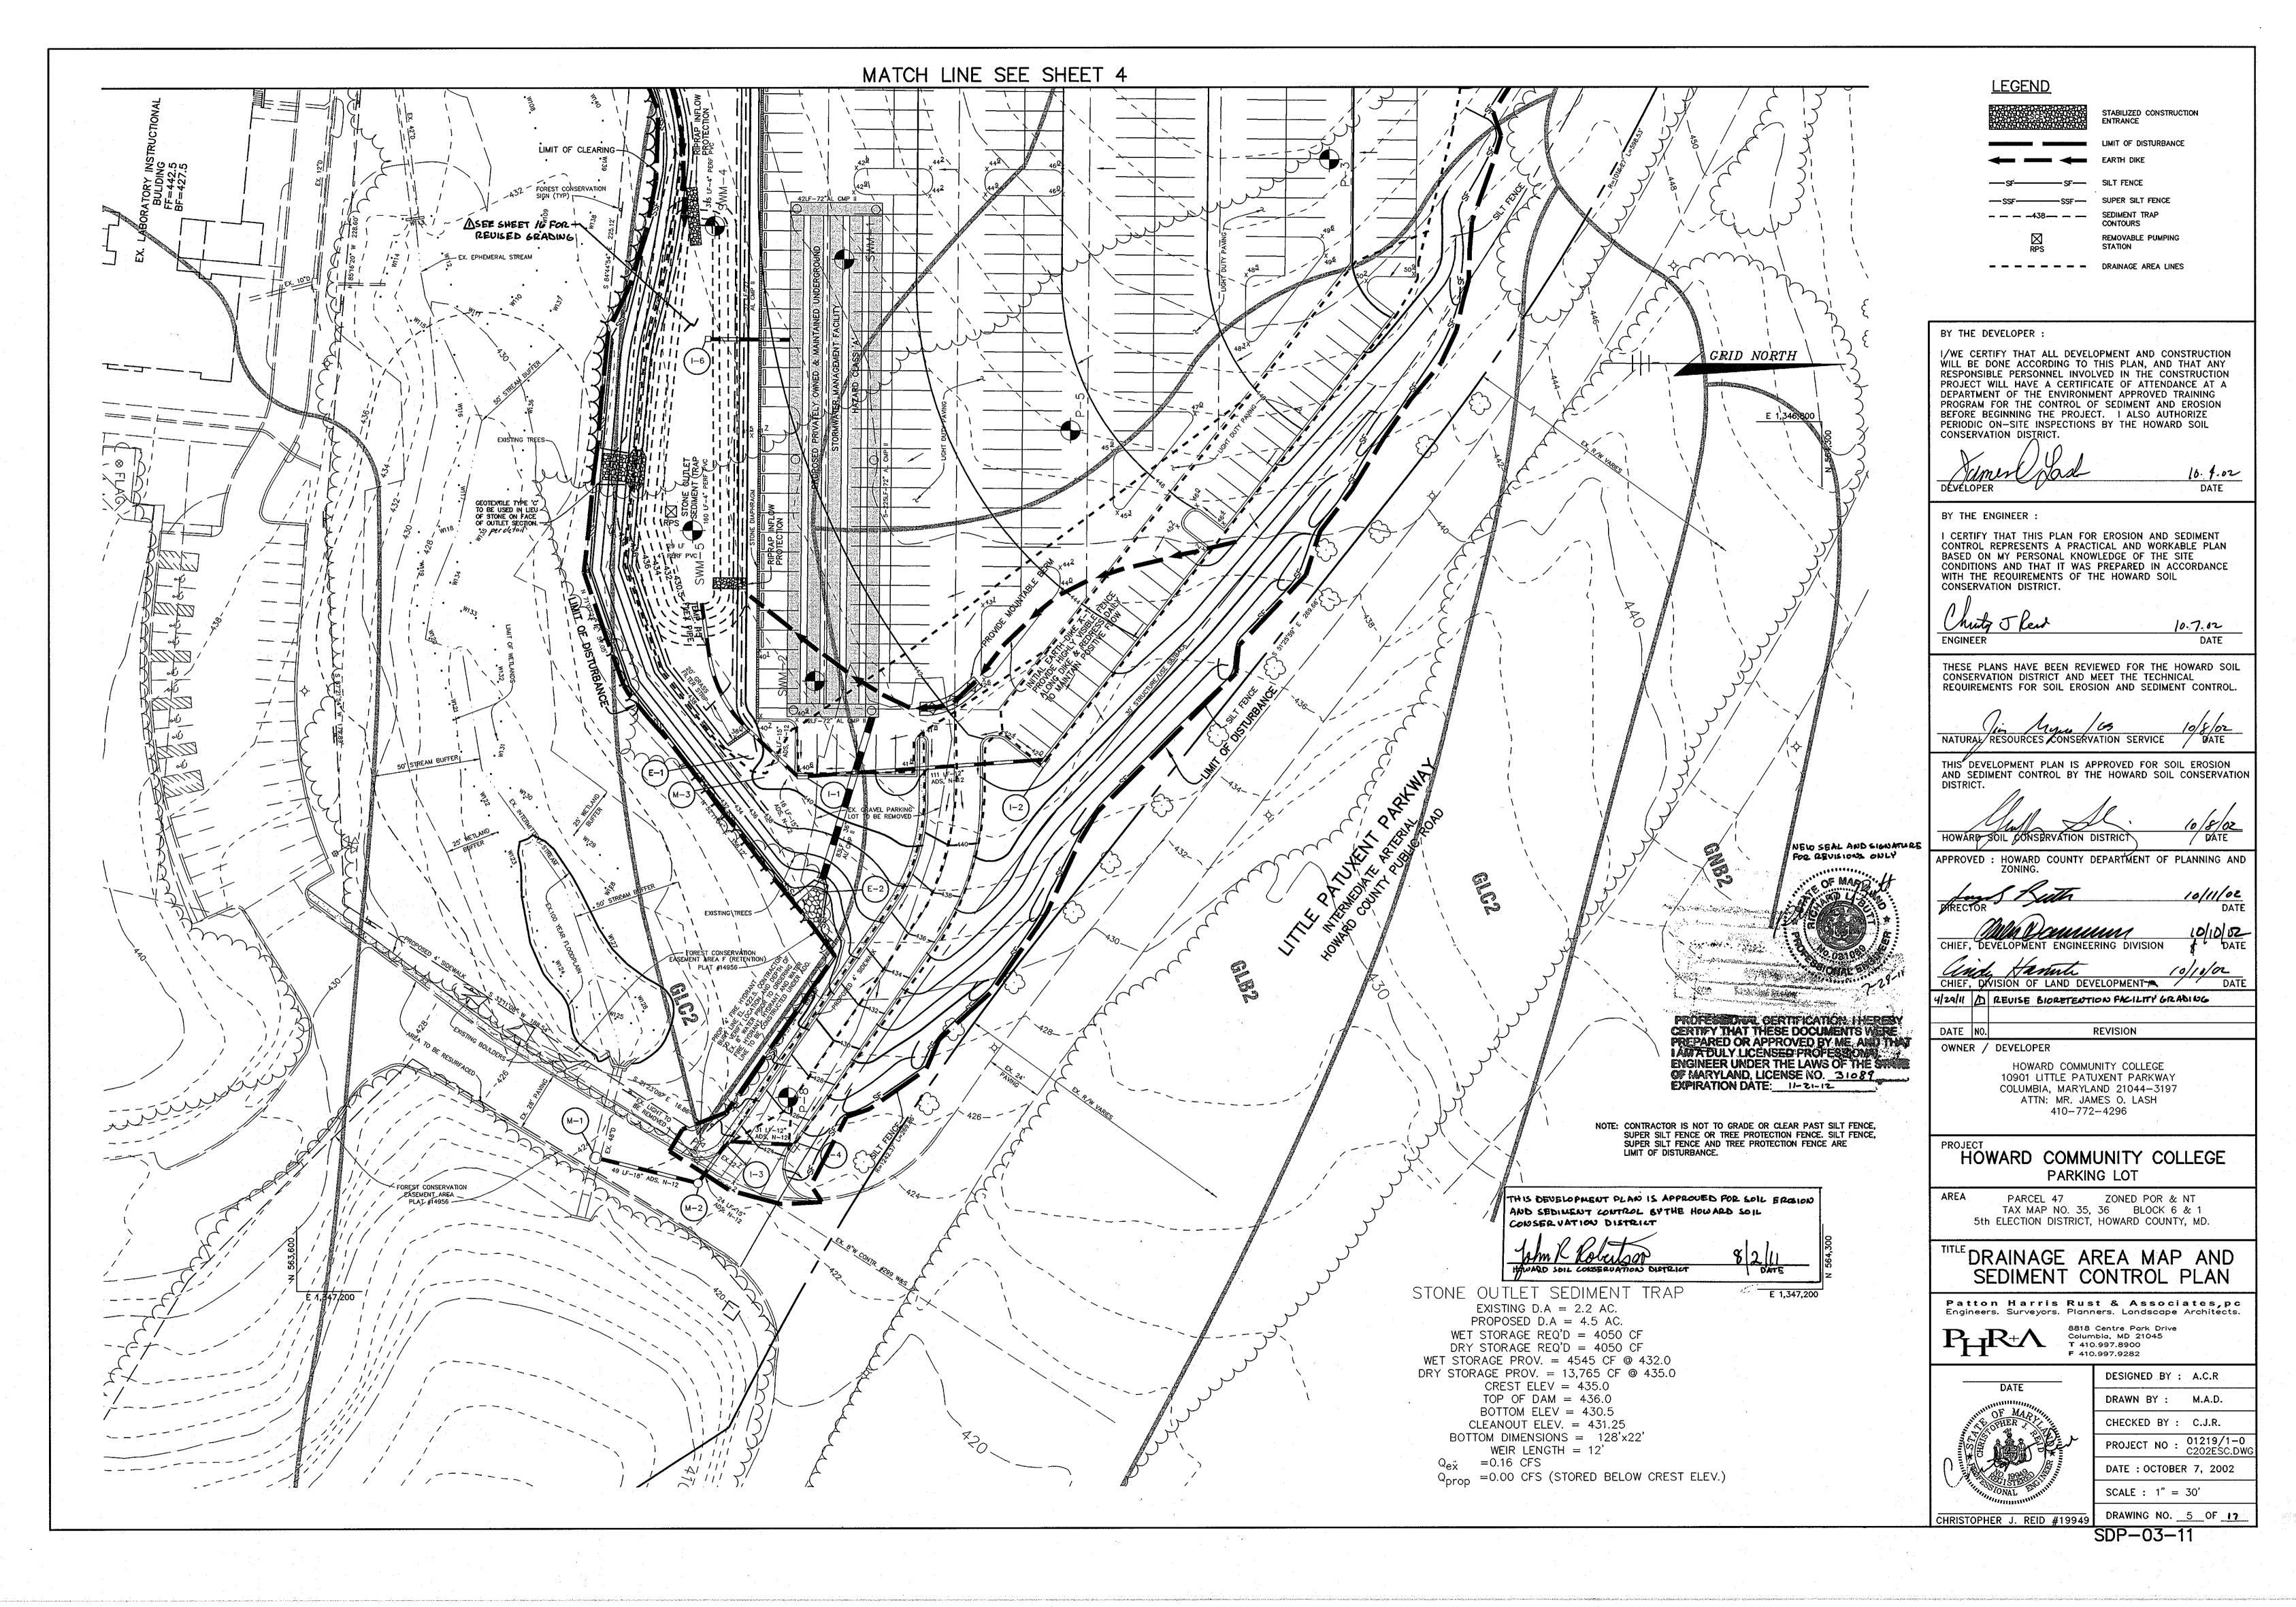

ect\01219\1-0\Engr\Plans\Parking\_Lot\C202ESC.dwg, Layout1, 10/04/2002 03:51:49 PM, HP750C(36).pc3, Arch D - 24 x 36 in. (lands

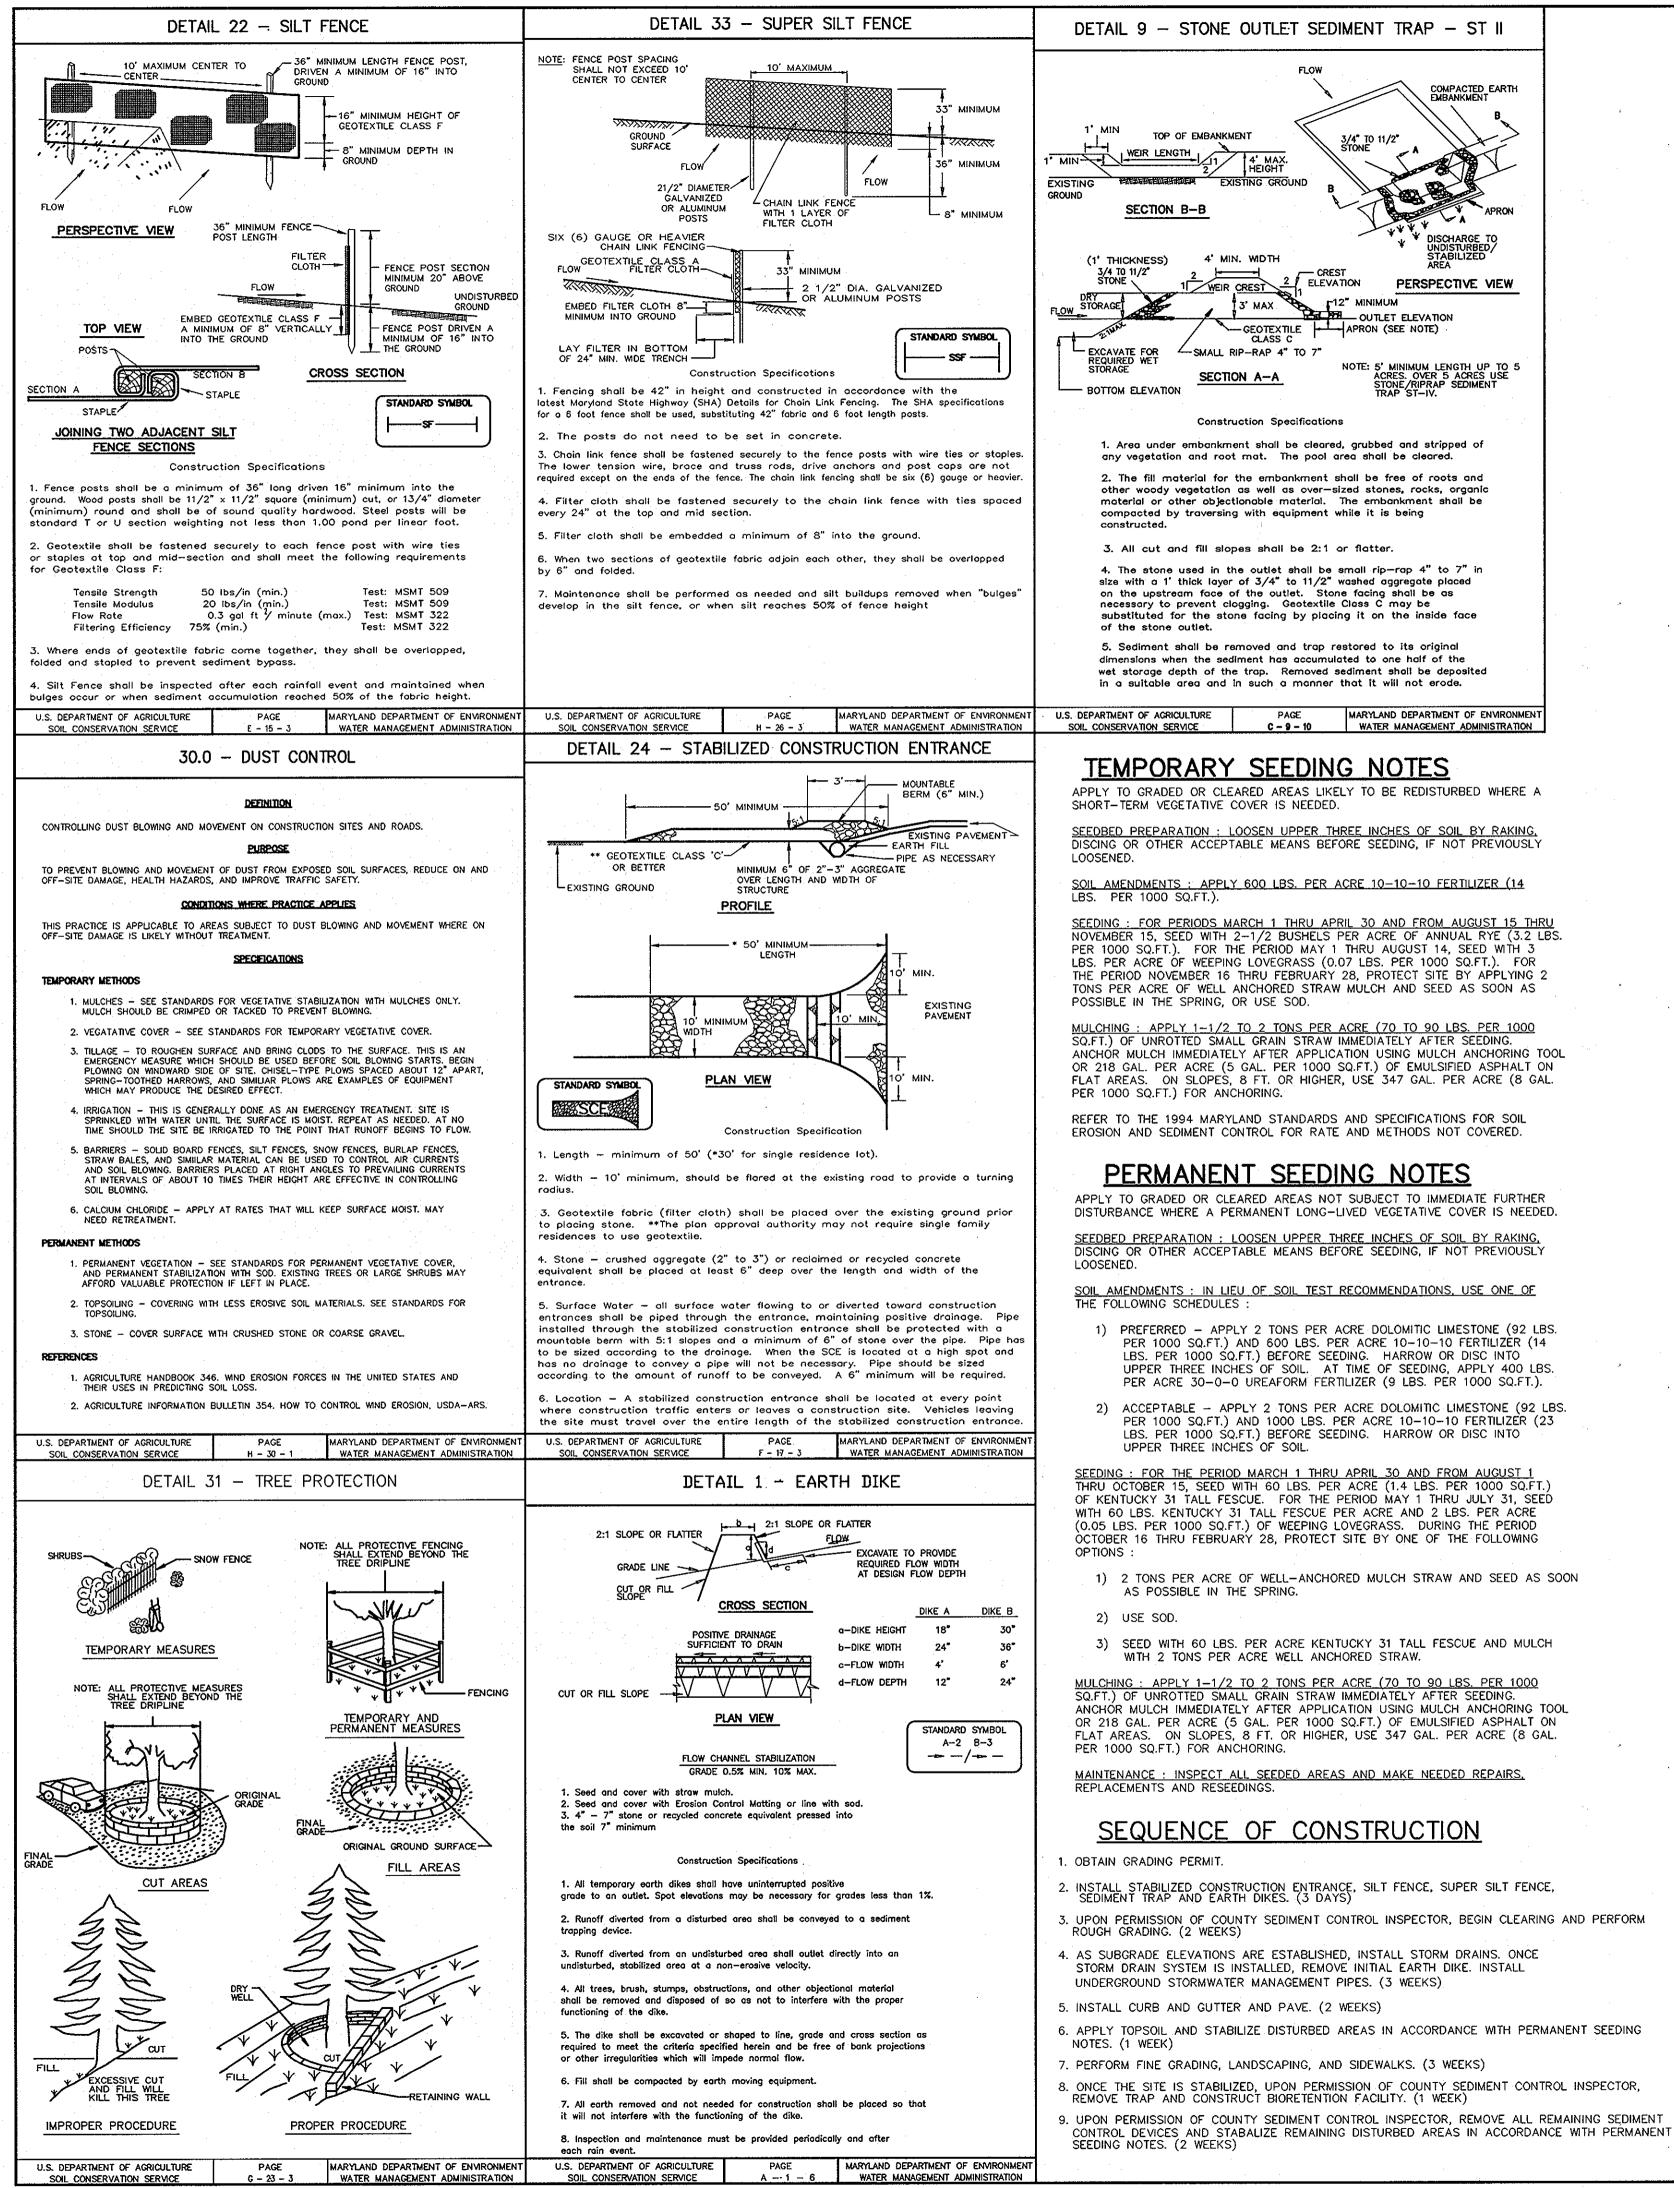

- 1) PREFERRED APPLY 2 TONS PER ACRE DOLOMITIC LIMESTONE (92 LBS. PER 1000 SQ.FT.) AND 600 LBS. PER ACRE 10-10-10 FERTILIZER (14 UPPER THREE INCHES OF SOIL. AT TIME OF SEEDING, APPLY 400 LBS. PER ACRE 30-0-0 UREAFORM FERTILIZER (9 LBS. PER 1000 SQ.FT.).
- PER 1000 SQ.FT.) AND 1000 LBS. PER ACRE 10-10-10 FERTILIZER (23

- 1) 2 TONS PER ACRE OF WELL-ANCHORED MULCH STRAW AND SEED AS SOON

APPLY 1-1/2 TO 2 TONS PER ACRE (70 TO 90 LBS. PER 1000 ANCHOR MULCH IMMEDIATELY AFTER APPLICATION USING MULCH ANCHORING TOOL

6. APPLY TOPSOIL AND STABILIZE DISTURBED AREAS IN ACCORDANCE WITH PERMANENT SEEDING

8. ONCE THE SITE IS STABILIZED, UPON PERMISSION OF COUNTY SEDIMENT CONTROL INSPECTOR, 9. UPON PERMISSION OF COUNTY SEDIMENT CONTROL INSPECTOR, REMOVE ALL REMAINING SEDIMENT

# 21.0 STANDARD AND SPECIFICAT FOR TOPSOIL

### DEFINITION PLACEMENT OF TOPSOIL OVER A PREPARED SUBSOIL PRIOR TO ESTABLISHMENT OF PERMANENT VEGETATION.

<u>PURPOSE</u> TO PROVIDE A SUITABLE SOIL MEDIUM FOR VEGETATIVE GROWTH. SOILS OF CONCERN HAVE LOW MOISTURE CONTENT, LOW NUTRIENT LEVELS, LOW PH, MATERIALS TOXIC TO PLANTS, AND/OR UNACCEPTABLE SOIL GRADATION.

- CONDITIONS WHERE PRACTICE APPLIES I. THIS PRACTICE IS LIMITED TO AREAS HAVING 2:1 OR FLATTER SLOPES WHERE: A. THE TEXTURE OF THE EXPOSED SUBSOIL/PARENT MATERIAL IS NOT ADEQUATE TO PRODUCE VEGETATIVE GROWTH. B. THE SOIL MATERIAL IS SO SHALLOW THAT THE ROOTING ZONE IS NOT DEEP ENOUGH TO SUPPORT PLANTS OR FURNISH CONTINUING SUPPLIES OF MOISTURE AND PLANT NUTRIENTS. THE ORIGINAL SOIL TO BE VEGETATED CONTAINS MATERIAL TOXIC TO PLANT GROWTH.
- . THE SOIL IS SO ACIDIC THAT TREATMENT WITH LIMESTONE IS NOT FEASIBLE. II. FOR THE PURPOSE OF THESE STANDARDS AND SPECIFICATIONS, AREAS HAVING SLOPES STEEPER THAN 2:1 REQUIRE SPECIAL CONSIDERATION AND DESIGN FOR ADEQUATE STABILIZATION. AREAS HAVING SLOPES STEEPER THAN 2:1
- SHALL HAVE THE APPROPRIATE STABILIZATION SHOWN ON THE PLANS. CONSTRUCTION AND MATERIAL SPECIFICATIONS
- I. TOPSOIL SALVAGED FROM THE EXISTING SITE MAY BE USED PROVIDED THAT IT MEETS THE STANDARDS AS SET FORTH IN THESE SPECIFICATIONS. TYPICALLY, THE DEPTH OF TOPSOIL TO BE SALVAGED FOR A GIVEN SOIL TYPE CAN BE FOUND IN THE REPRESENTATIVE SOIL PROFILE SECTION IN THE SOIL SURVEY PUBLISHED BY USDA-SCS IN COOPERATION WITH MARYLAND AGRICULTURAL EXPERIMENTATION STATION.
- II. TOPSOIL SPECIFICATIONS SOIL TO BE USED AS TOPSOIL MUST MEET THE FOLLOWING: I. TOPSOIL SHALL BE A LOAM, SANDY LOAM, CLAY LOAM, SILT LOAM, SANDY CLAY LOAM, LOAMY SAND. OTHER SOILS MAY BE USED IF RECOMMENDED BY AN AGRONOMIST OR SOIL SCIENTIST AND APPROVED BY THE APPROPRIATE APPROVAL AUTHORITY. REGARDLESS, TOPSOIL SHALL NOT BE A MIXTURE OF CONTRASTING TEXTURED SUBSOILS AND SHALL CONTAIN LESS THAN 5% BY VOLUME OF CINDERS, STONES, SLAG, COARSE FRAGMENTS, GRAVEL, STICKS, ROOTS, TRASH, OR OTHER MATERIALS LARGER THAN 1"" IN DIAMETER.
- II. TOPSOIL MUST BE FREE OF PLANTS OR PLANT PARTS SUCH AS BERMUDA GRASS, QUACKGRASS, JOHNSONGRASS, NUTSEDGE, POISON IVY, THISTLE, OR OTHERS AS SPECIFIED.
- III. WHERE SUBSOIL IS EITHER HIGHLY ACIDIC OR COMPOSED OF HEAVY CLAYS, GROUND LIMESTONE SHALL BE SPREAD AT THE RATE OF 4-8 TONS/ACRE (200-400 POUNDS PER 1,000 SQUARE FEET) PRIOR TO THE PLACEMENT OF TOPSOIL. LIME SHALL BE DISTRIBUTED UNIFORMLY OVER DESIGNATED AREAS AND WORKED INTO THE SOIL
- IN CONJUNCTION WITH TILLAGE OPERATIONS AS DESCRIBED IN THE FOLLOWING PROCEDURES.

II. FOR SITES HAVING DISTURBED AREAS UNDER 5 ACRES: I. PLACE TOPSOIL (IF REQUIRED) AND APPLY SOIL AMENDMENTS AS SPECIFIED IN <u>20.0 VEGETATIVE</u> <u>STABILIZATION</u> – BSECTION I – VEGETATIVE STABILIZATION METHODS AND MATERIALS. III. FOR SITES HAVING DISTURBED AREAS OVER 5 ACRES:

- I. ON SOIL MEETING TOPSOIL SPECIFICATIONS, OBTAIN TEST RESULTS DICTATING FERTILIZER AND LIME AMENDMENTS REQUIRED TO BRING THE SOIL INTO COMPLIANCE WITH THE FOLLOWING: A. PH FOR TOPSOIL SHALL BE BETWEEN 6.0 AND 7.5. IF THE TESTED SOIL DEMONSTRATES A PH OF LESS THAN 6.0, SUFFICIENT LIME SHALL BE PRESCRIBED TO RAISE THE PH TO 6.5 OR HIGHER. B. ORGANIC CONTENT OF TOPSOIL SHALL BE NOT LESS THAN 1.5 PERCENT BY WEIGHT. C. TOPSOIL HAVING SOLUBLE SALT CONTENT GREATER THAN 500 PARTS PER MILLION SHALL NOT BE USED. NO SOLO OP SEED SHALL NOT BE DIACED ON SOUL MALE HAS BEEN THE ATED WITH SOUL STEPLIANTS OP D. NO SOD OR SEED SHALL BE PLACED ON SOIL WHICH HAS BEEN TREATED WITH SOIL STERILANTS OR CHEMICALS USED FOR WEED CONTROL UNTIL SUFFICIENT TIME HAS ELAPSED (14 DAYS MIN.) TO PERMIT DISSIPATION OF PHYTO-TOXIC MATERIALS
- NOTE: TOPSOIL SUBSTITUTES TO AMENDMENTS, AS RECOMMENDED BY A QUALIFIED AGRONOMIST OR SOIL SCIENTIST AND APPROVED BY THE APPROPRIATE APPROVAL AUTHORITY MAY BE USED IN LIEU OF NATURAL TOPSOIL. II. PLACE TOPSOIL (IF REQUIRED) AND APPLY SOIL AMENDMENTS AS SPECIFIED IN <u>20.0 VEGETATIVE</u> <u>STABILIZATION</u> - BSECTION I - VEGETATIVE STABILIZATION METHODS AND MATERIALS.
- V. TOPSOIL APPLICATION I. WHEN TOPSOILING, MAINTAIN NEEDED EROSION AND SEDIMENT CONTROL PRACTICES SUCH AS DIVERSIONS
- GRADE STABILIZATION STRUCTURES, EARTH DIKES, SLOPE SILT FENCE AND SEDIMENT TRAPS AND BASINS. II. GRADES ON THE AREAS TO BE TOPSOILED, WHICH HAVE BEEN PREVIOUSLY ESTABLISHED, SHALL BE MAINTAINED, ALBEIT 4" - 8" HIGHER IN ELEVATION.
- III. TOPSOIL SHALL BE UNIFORMLY DISTRIBUTED IN A 4" 8" LAYER AND LIGHTLY COMPACTED TO A MINIMUM THICKNESS OF 4". SPREADING SHALL BE PERFORMED IN SUCH A MANNER THAT SODDING OR SEEDING CAN PROCEED WITH A MINIMUM OF ADDITIONAL SOIL PREPARATION AND TILLAGE. ANY IRREGULARITIES IN THE SURFACE RESULTING FROM TOPSOILING OR OTHER OPERATIONS SHALL BE CORRECTED IN ORDER TO PREVENT THE FORMATION OF DEPRESSIONS OR WATER POCKETS.
- IV. TOPSOIL SHALL NOT BE PLACED WHILE THE TOPSOIL OR SUBSOIL IS IN A FROZEN OR MUDDY CONDITION, WHEN THE SUBSOIL IS EXCESSIVELY WET OR IN A CONDITION THAT MAY OTHERWISE BE DETRIMENTAL TO PROPER GRADING AND SEEDBED PREPARATION.
- VI. ALTERNATIVE FOR PERMANENT SEEDING INSTEAD OF APPLYING THE FULL AMOUNTS OF LIME AND COMMERCIAL ERTILIZER, COMPOSTED SLUDGE AND AMENDMENTS MAY BE APPLIED AS SPECIFIED BELOW:
- 1. COMPOSTED SLUDGE MATERIAL FOR USE AS A SOIL CONDITIONER FOR SITES HAVING DISTURBED AREAS OVER 5 ACRES SHALL BE TESTED TO PRESCRIBE AMENDMENTS AND FOR SITE HAVING DISTURBED AREAS UNDER 5 ACRES SHALL CONFORM TO THE FOLLOWING REQUIREMENTS:
- A. COMPOSTED SLUDGE SHALL BE SUPPLIED BY, OR ORIGINATE FROM, A PERSON OR PERSONS THAT ARE PERMITTED (AT THE TIME OF ACQUISITION OF THE COMPOST) BY THE MARYLAND DEPARTMENT OF THE ENVIRONMENT UNDER COMAR 26.04.06. B. COMPOSTED SLUDGE SHALL CONTAIN AT LEAST 1 PERCENT NITROGEN, 1.5 PERCENT PHOSPHORUS, AND 0.2
- PERCENT POTASSIUM AND HAVE A PH OF 7.0 TO 8.0. IF COMPOST DOES NOT MEET THESE REQUIREMENTS, THE APPROPRIATE CONSTITUENTS MUST BE ADDED TO MEET THE REQUIREMENTS PRIOR TO USE. COMPOSTED SLUDGE SHALL BE APPLIED AT A RATE OF 1 TON/1,000 SQUARE FEET. COMPOSTED SLUDGE SHALL BE AMENDED WITH A POTASSIUM FERTILIZER APPLIED AT THE RATE OF 4 LB/1,000
- SQUARE FEET, AND 1/3 THE NORMAL LIME APPLICATION RATE.

REFERENCES: GUIDELINE SPECIFICATIONS, SOIL PREPARATION AND SODDING. MD-VA, PUB. #1, COOPERATIVE EXTENSION SERVICE, UNIVERSITY OF MARYLAND AND VIRGINIA POLYTECHNIC INSTITUTES. REVISED 1973.

# STANDARD SEDIMENT CONTROL NOTES

- 1. A MINIMUM OF 48 HOURS NOTICE MUST BE GIVEN TO THE HOWARD COUNTY DEPARTMENT OF INSPECTIONS, LICENSES AND PERMITS, SEDIMENT CONTROL DIVISION PRIOR TO THE START OF ANY CONSTRUCTION (313-1855)
- 2. ALL VEGETATIVE AND STRUCTURAL PRACTICES ARE TO BE INSTALLED ACCORDING TO THE PROVISIONS OF THIS PLAN AND ARE TO BE IN CONFORMANCE WITH THE 1994 MARYLAND STANDARDS AND SPECIFICATIONS FOR SOIL EROSION AND SEDIMENT CONTROL AND REVISIONS THERETO.
- 3. FOLLOWING INITIAL SOIL DISTURBANCE OR RE-DISTURBANCE, PERMANENT OR TEMPORARY STABILIZATION SHALL BE COMPLETED WITHIN: A)7 CALENDAR DAYS FOR ALL PERIMETER SEDIMENT CONTROL STRUCTURES, DIKES, PERIMETER SLOPES, AND ALL SLOPES STEEPER THAN 3.1, B) 14 DAYS AS TO ALL OTHER DISTURBED OR GRADED AREAS ON THE PROJECT SITE.
- 4. ALL SEDIMENT TRAPS/BASINS SHOWN MUST BE FENCED AND WARNING SIGNS POSTED AROUND THE PERIMETER IN ACCORDANCE WITH VOL. 1, CHAPTER 7, OF THE HOWARD COUNTY DESIGN MANUAL, STORM DRAINAGE.
- 5. ALL DISTURBED AREAS MUST BE STABILIZED WITHIN THE TIME PERIOD SPECIFIED ABOVE IN ACCORDANCE WITH THE 1994 MARYLAND STANDARDS AND SPECIFICATIONS FOR SOIL EROSION AND SEDIMENT CONTROL FOR PERMANENT SEEDING, SOD, TEMPORARY SEEDING, AND MULCHING (SEC. G.). TEMPORARY STABILIZATION WITH MULCH ALONE SHALL ONLY BE DONE WHEN RECOMMENDED SEEDING DATES DO NOT ALLOW FOR PROPER GERMINATION AND ESTABLISHED OF GRASSES.
- 6. ALL SEDIMENT CONTROL STRUCTURES ARE TO REMAIN IN PLACE AND ARE TO BE MAINTAINED IN OPERATIVE CONDITION UNTIL PERMISSION FOR THEIR REMOVAL HAS BEEN OBTAINED FROM THE HOWARD COUNTY SEDIMENT CONTROL INSPECTOR.
- 7. SITE ANALYSIS: TOTAL AREA OF SITE

AFFECT THE WORK

- AREA DISTURBED AREA TO BE ROOFED OR PAVED .
- AREA TO BE VEGETATIVELY STABILIZED TOTAL CUT TOTAL FILL
- OFFSITE WASTE AREA LOCATION TO HAVE ACTIVE GRADING PERMIT AND BE PREAPPROVED BY INSPECTOR BEFORE MATERIAL LEAVES SITE. 8. ANY SEDIMENT CONTROL PRACTICE WHICH IS DISTURBED BY GRADING ACTIVITY
- FOR PLACEMENT OF UTILITIES MUST BE REPAIRED ON THE SAME DAY OF DISTURBANCE
- 9. ADDITIONAL SEDIMENT CONTROLS MUST BE PROVIDED, IF DEEMED NECESSARY BY THE HOWARD COUNTY SEDIMENT CONTROL INSPECTOR.
- 10. ON ALL SITES WITH DISTURBED AREAS IN EXCESS OF 2 ACRES, APPROVAL OF THE INSPECTION AGENCY SHALL BE REQUESTED UPON COMPLETION OF INSTALLATION OF PERIMETER EROSION AND SEDIMENT CONTROLS, BUT BEFORE PROCEEDING WITH ANY OTHER EARTH DISTURBANCE OR GRADING. OTHER BUILDING OR GRADING INSPECTION APPROVALS MAY NOT BE AUTHORIZED UNTIL THIS INITIAL APPROVAL BY THE INSPECTION AGENCY IS MADE.
- 11. TRENCHES FOR THE CONSTRUCTION OF UTILITIES IS LIMITED TO THREE PIPE LENGTHS OR THAT WHICH SHALL BE BACK-FILLED AND STABILIZED WITHIN ONE WORKING DAY, WHICHEVER IS SHORTER.
- 12. SITE GRADING WILL BEGIN ONLY AFTER ALL PERIMETER SEDIMENT CONTROL MEASURES HAVE BEEN INSTALLED AND ARE IN A FUNCTIONING CONDITION.
- 13. SEDIMENT WILL BE REMOVED FROM TRAPS WHEN ITS DEPTH REACHES CLEAN OUT ELEVATION SHOWN ON THE PLANS.
- 14. CUT AND FILL QUANTITIES PROVIDED UNDER SITE ANALYSIS DO NOT REPRESENT BID QUANTITIES. THESE QUANTITIES DO NOT DISTINGUISH BETWEEN TOPSOIL. STRUCTURAL FILL OR EMBANKMENT MATERIAL, NOR DO THEY REFLECT CONSIDERATION OF UNDERCUTTING OR REMOVAL OF UNSUITABLE MATERIAL. THE CONTRACTOR SHALL FAMILIARIZE HIMSELF WITH SITE CONDITIONS WHICH MAY

<u> ONS</u>
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117.84 ACRES 5.5 ACRES 3.3 ACRES 2.3 ACRES 23117 CU. YARDS 12422 CU. YARDS

NEW SEAL AND SIGNATURE APPLICABLE TO REVISIONS ONLY

PROFESSIONAL CERTIFICATION. I HEREBI CERTIFY THAT THESE DOCUMENTS WERE PREPARED OR APPROVED BY ME, AND THAT FRIGNEER UN ER THE LAWS OF THE STATE OF MARYLAND, LICENSE NO. 31089 EXPRATION CAVE: 11-21-12

SEQUENCE OF CONSTRUCTION FOR REVISED BIORETENTION FACILITY

I. OBTAIN GRADING PERMIT

2. INSTALL STABILIZED CONSTRUCTION ENTRANCE, SUPER SILT FENCE AND INLET PROTECTION (3 DAYS)

3. UP ON PERMISSION OF COUNTY SEDIMENT CONTROL INSPECTOR, BEGIN EXCAVATION OF EXISTING BIORETENTION FACILITY AND GRADING FOR NELO BIORETENTION FACILITY, DURING CONSTRUCTION, INSTALL AND MAINTAIN REMOVABLE PUMPING STATION AND FLITER BAG. (3 WEEKS)

4 APPLY TOPSOIL AND STABILIZE DISTURBED AREAS IN ACCORDANCE WITH PERMANENT SEEDING NOTES (I WEEK)

5. ONCE THE SITE IS STABILIZED, UPON PERMISSION OF COUNTY SEDIMENT CONTROL INSPECTOR, REMOVE ALL REMAINING SEDIMENT CONTROL DEVICES AND STABILIZE REMAINING AREAS IN A CLORD ANCE WITH PERMANENT SERDING NOTES (I WEEK)

> BY THE DEVELOPER I/WE CERTIFY THAT ALL DEVELOPMENT AND CONSTRUCTION WILL BE DONE ACCORDING TO THIS PLAN, AND THAT ANY RESPONSIBLE PERSONNEL INVOLVED IN THE CONSTRUCTION PROJECT WILL HAVE A CERTIFICATE OF ATTENDANCE AT A DEPARTMENT OF THE ENVIRONMENT APPROVED TRAINING PROGRAM FOR THE CONTROL OF SEDIMENT AND EROSION BEFORE BEGINNING THE PROJECT. I ALSO AUTHORIZE PERIODIC ON-SITE INSPECTIONS BY THE HOWARD SOIL CONSERVATION DISTRICT.

mens DÉVELOPER

BY THE ENGINEER

I CERTIFY THAT THIS PLAN FOR EROSION AND SEDIMENT CONTROL REPRESENTS A PRACTICAL AND WORKABLE PLAN BASED ON MY PERSONAL KNOWLEDGE OF THE SITE CONDITIONS AND THAT IT WAS PREPARED IN ACCORDANCE WITH THE REQUIREMENTS OF THE HOWARD SOIL CONSERVATION DISTRICT.

Churty J Ker ENGINEEF

DATE THESE PLANS HAVE BEEN REVIEWED FOR THE HOWARD SOIL CONSERVATION DISTRICT AND MEET THE TECHNICAL

10.4.02

DATE

10.7.02

DAT

Ner 03. NATURAL RESOURCES CONSERVATION SERVICE

REQUIREMENTS FOR SOIL EROSION AND SEDIMENT CONTROL.

THIS DEVELOPMENT PLAN IS APPROVED FOR SOIL EROSION AND SEDIMENT CONTROL BY THE HOWARD SOIL CONSERVATION DISTRICT.

HOWARD SOIL CONSERVATION DISTRICT APPROVED : HOWARD COUNTY DEPARTMENT OF PLANNING AND

70NING. 10/11/02

Vauuuu CHIEF, DEVELOPMENT ENGINEERING DIVISION Januti (Mah 0/10/02

CHIEF, DIVISION OF LAND DEVELOPMENT 12all A REVISED SEQUENCE OF CONSTRUCTION DATE NO. REVISION

OWNER / DEVELOPER HOWARD COMMUNITY COLLEGE


**10901 LITTLE PATUXENT PARKWAY** COLUMBIA, MARYLAND 21044-3197 ATTN: MR. JAMES O. LASH 410-772-4296

PROJECT HOWARD COMMUNITY COLLEGE PARKING LOT

AREA PARCEL 47 ZONED POR & NT TAX MAP NO. 35, 36 BLOCK 6 & 1 5th ELECTION DISTRICT, HOWARD COUNTY, MD.

TITLE SEDIMENT CONTROL NOTES AND DETAILS Patton Harris Rust & Associates,pc

Engineers. Surveyors. Planners. Landscape Architects. 8818 Centre Park Drive Columbia, MD 21045 **T** 410.997.8900

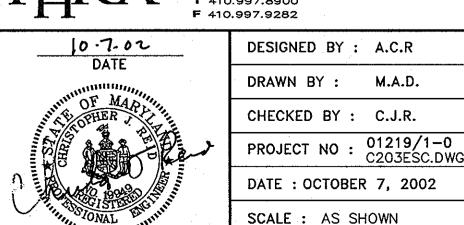

CHRISTOPHER J. REID #19949

DRAWING NO. 6 OF 17 SDP-03-1<sup>-</sup>

NED PLAN REVISION

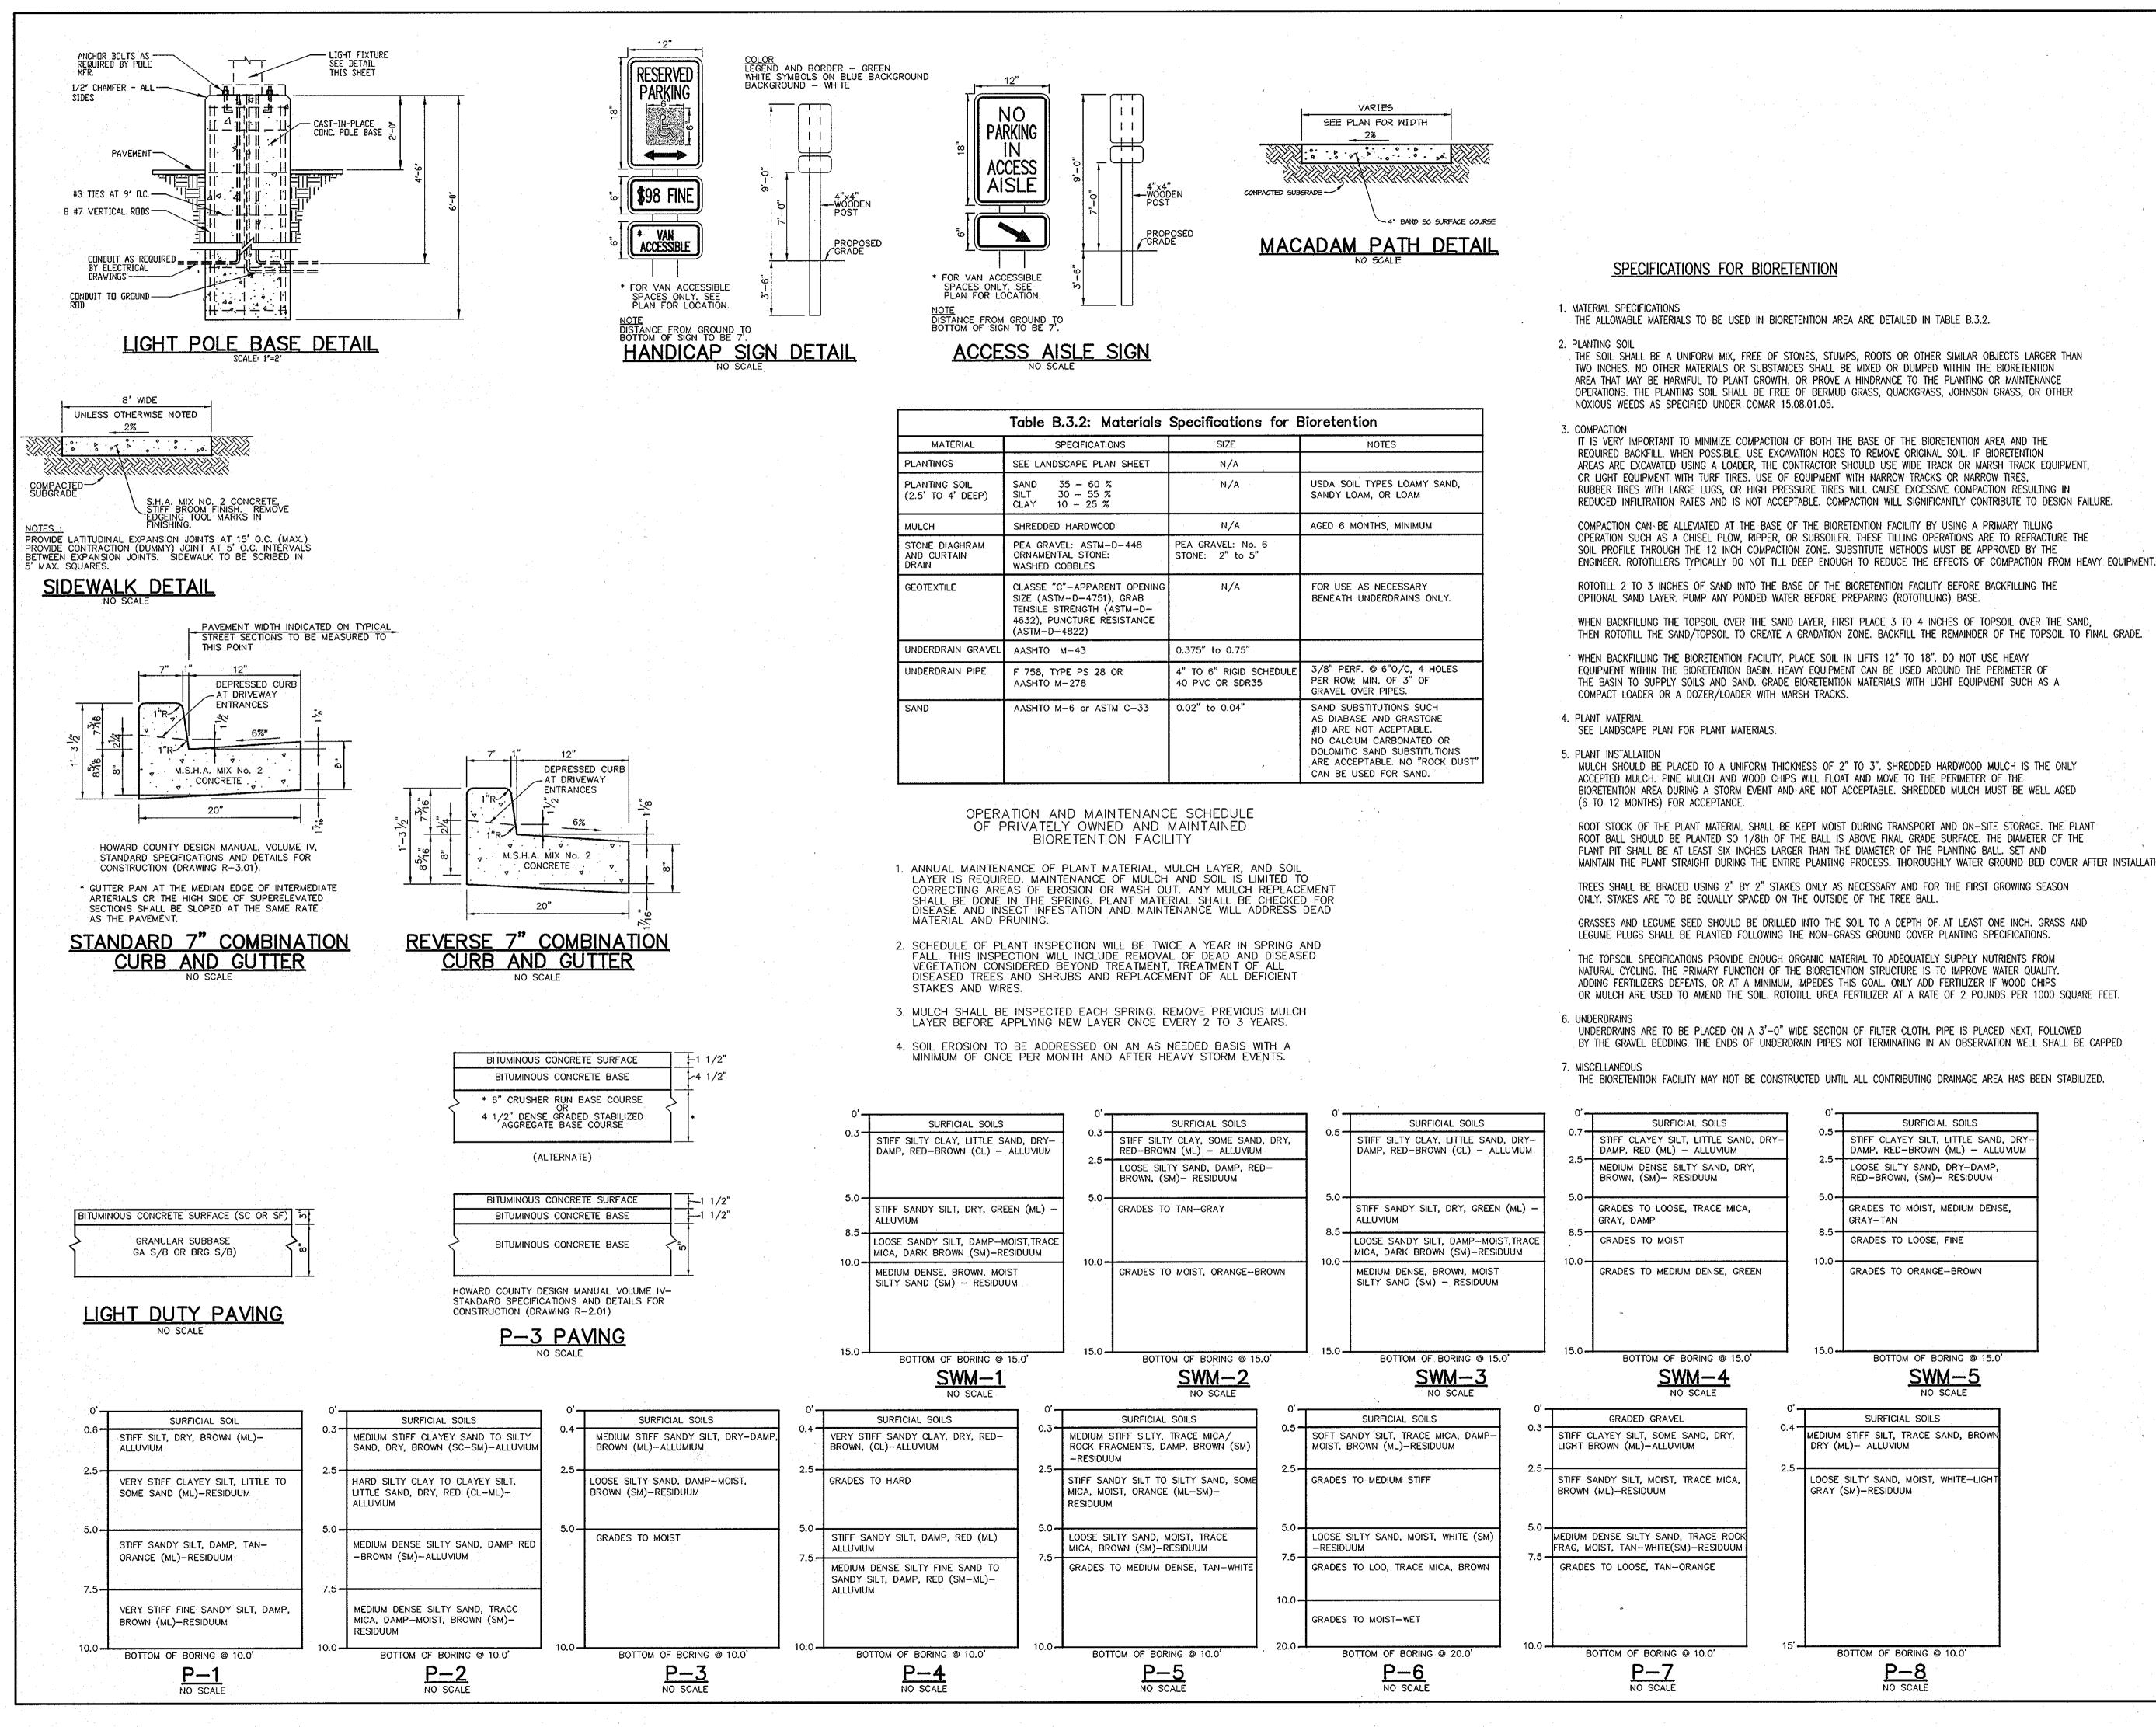


	Table B.3.2: Materials	Specifications for E	Bioretention
MATERIAL	SPECIFICATIONS	SIZE	NOTES
PLANTINGS	SEE LANDSCAPE PLAN SHEET	N/A	
PLANTING SOIL (2.5' TO 4' DEEP)	SAND 35 - 60 % SILT 30 - 55 % CLAY 10 - 25 %	N/A	USDA SOIL TYPES LOAMY SAND, SANDY LOAM, OR LOAM
MULCH	SHREDDED HARDWOOD	N/A	AGED 6 MONTHS, MINIMUM
STONE DIAGHRAM AND CURTAIN DRAIN	PEA GRAVEL: ASTM-D-448 ORNAMENTAL STONE: WASHED COBBLES	PEA GRAVEL: No. 6 STONE: 2" to 5"	
GEOTEXTILE	CLASSE "C"-APPARENT OPENING SIZE (ASTM-D-4751), GRAB TENSILE STRENGTH (ASTM-D- 4632), PUNCTURE RESISTANCE (ASTM-D-4822)	N/A	FOR USE AS NECESSARY BENEATH UNDERDRAINS ONLY.
UNDERDRAIN GRAVEL	AASHTO M-43	0.375" to 0.75"	
UNDERDRAIN PIPE	F 758, TYPE PS 28 OR AASHTO M-278	4" TO 6" RIGID SCHEDULE 40 PVC OR SDR35	3/8" PERF. @ 6"0/C, 4 HOLES PER ROW; MIN. OF 3" OF GRAVEL OVER PIPES.
SAND	AASHTO M-6 or ASTM C-33	0.02" to 0.04"	SAND SUBSTITUTIONS SUCH AS DIABASE AND GRASTONE #10 ARE NOT ACEPTABLE. NO CALCIUM CARBONATED OR DOLOMITIC SAND SUBSTITUTIONS ARE ACCEPTABLE. NO "ROCK DUST" CAN BE USED FOR SAND.

REDUCED INFILTRATION RATES AND IS NOT ACCEPTABLE. COMPACTION WILL SIGNIFICANTLY CONTRIBUTE TO DESIGN FAILURE


THEN ROTOTILL THE SAND/TOPSOIL TO CREATE A GRADATION ZONE. BACKFILL THE REMAINDER OF THE TOPSOIL TO FINAL GRADE.

MAINTAIN THE PLANT STRAIGHT DURING THE ENTIRE PLANTING PROCESS. THOROUGHLY WATER GROUND BED COVER AFTER INSTALLATION.


OR MULCH ARE USED TO AMEND THE SOIL. ROTOTILL UREA FERTILIZER AT A RATE OF 2 POUNDS PER 1000 SQUARE FEET.


BY THE GRAVEL BEDDING. THE ENDS OF UNDERDRAIN PIPES NOT TERMINATING IN AN OBSERVATION WELL SHALL BE CAPPED

THE BIORETENTION FACILITY MAY NOT BE CONSTRUCTED UNTIL ALL CONTRIBUTING DRAINAGE AREA HAS BEEN STABILIZED.

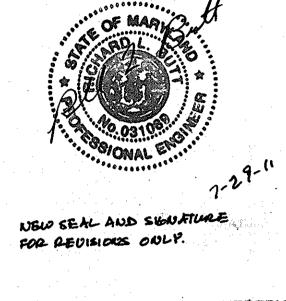


PROFESSIONAL CERTIFICATION. I HEREBY CERTIFY THAT THESE DOCUMENTS WERE PREPARED OR APPROVED BY ME, AND THAT I AM A DULY LICENSED PROFESSIONAL ENGINEER UNDER THE LAWS OF THE STATE OF MARYLAND, LICENSE NO. 31089 EXPIRATION DATE: 11-21-12

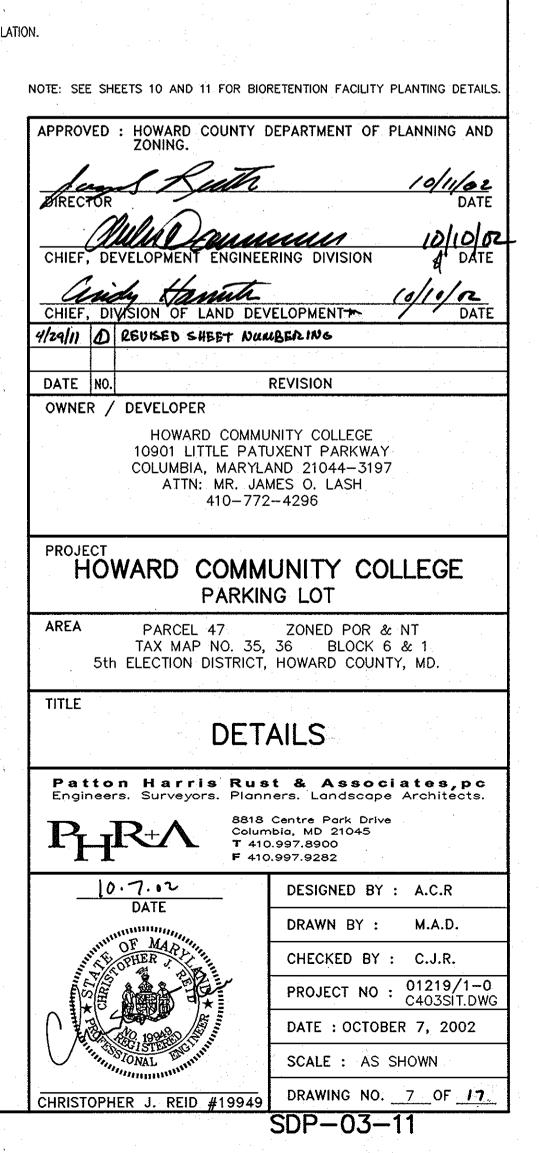


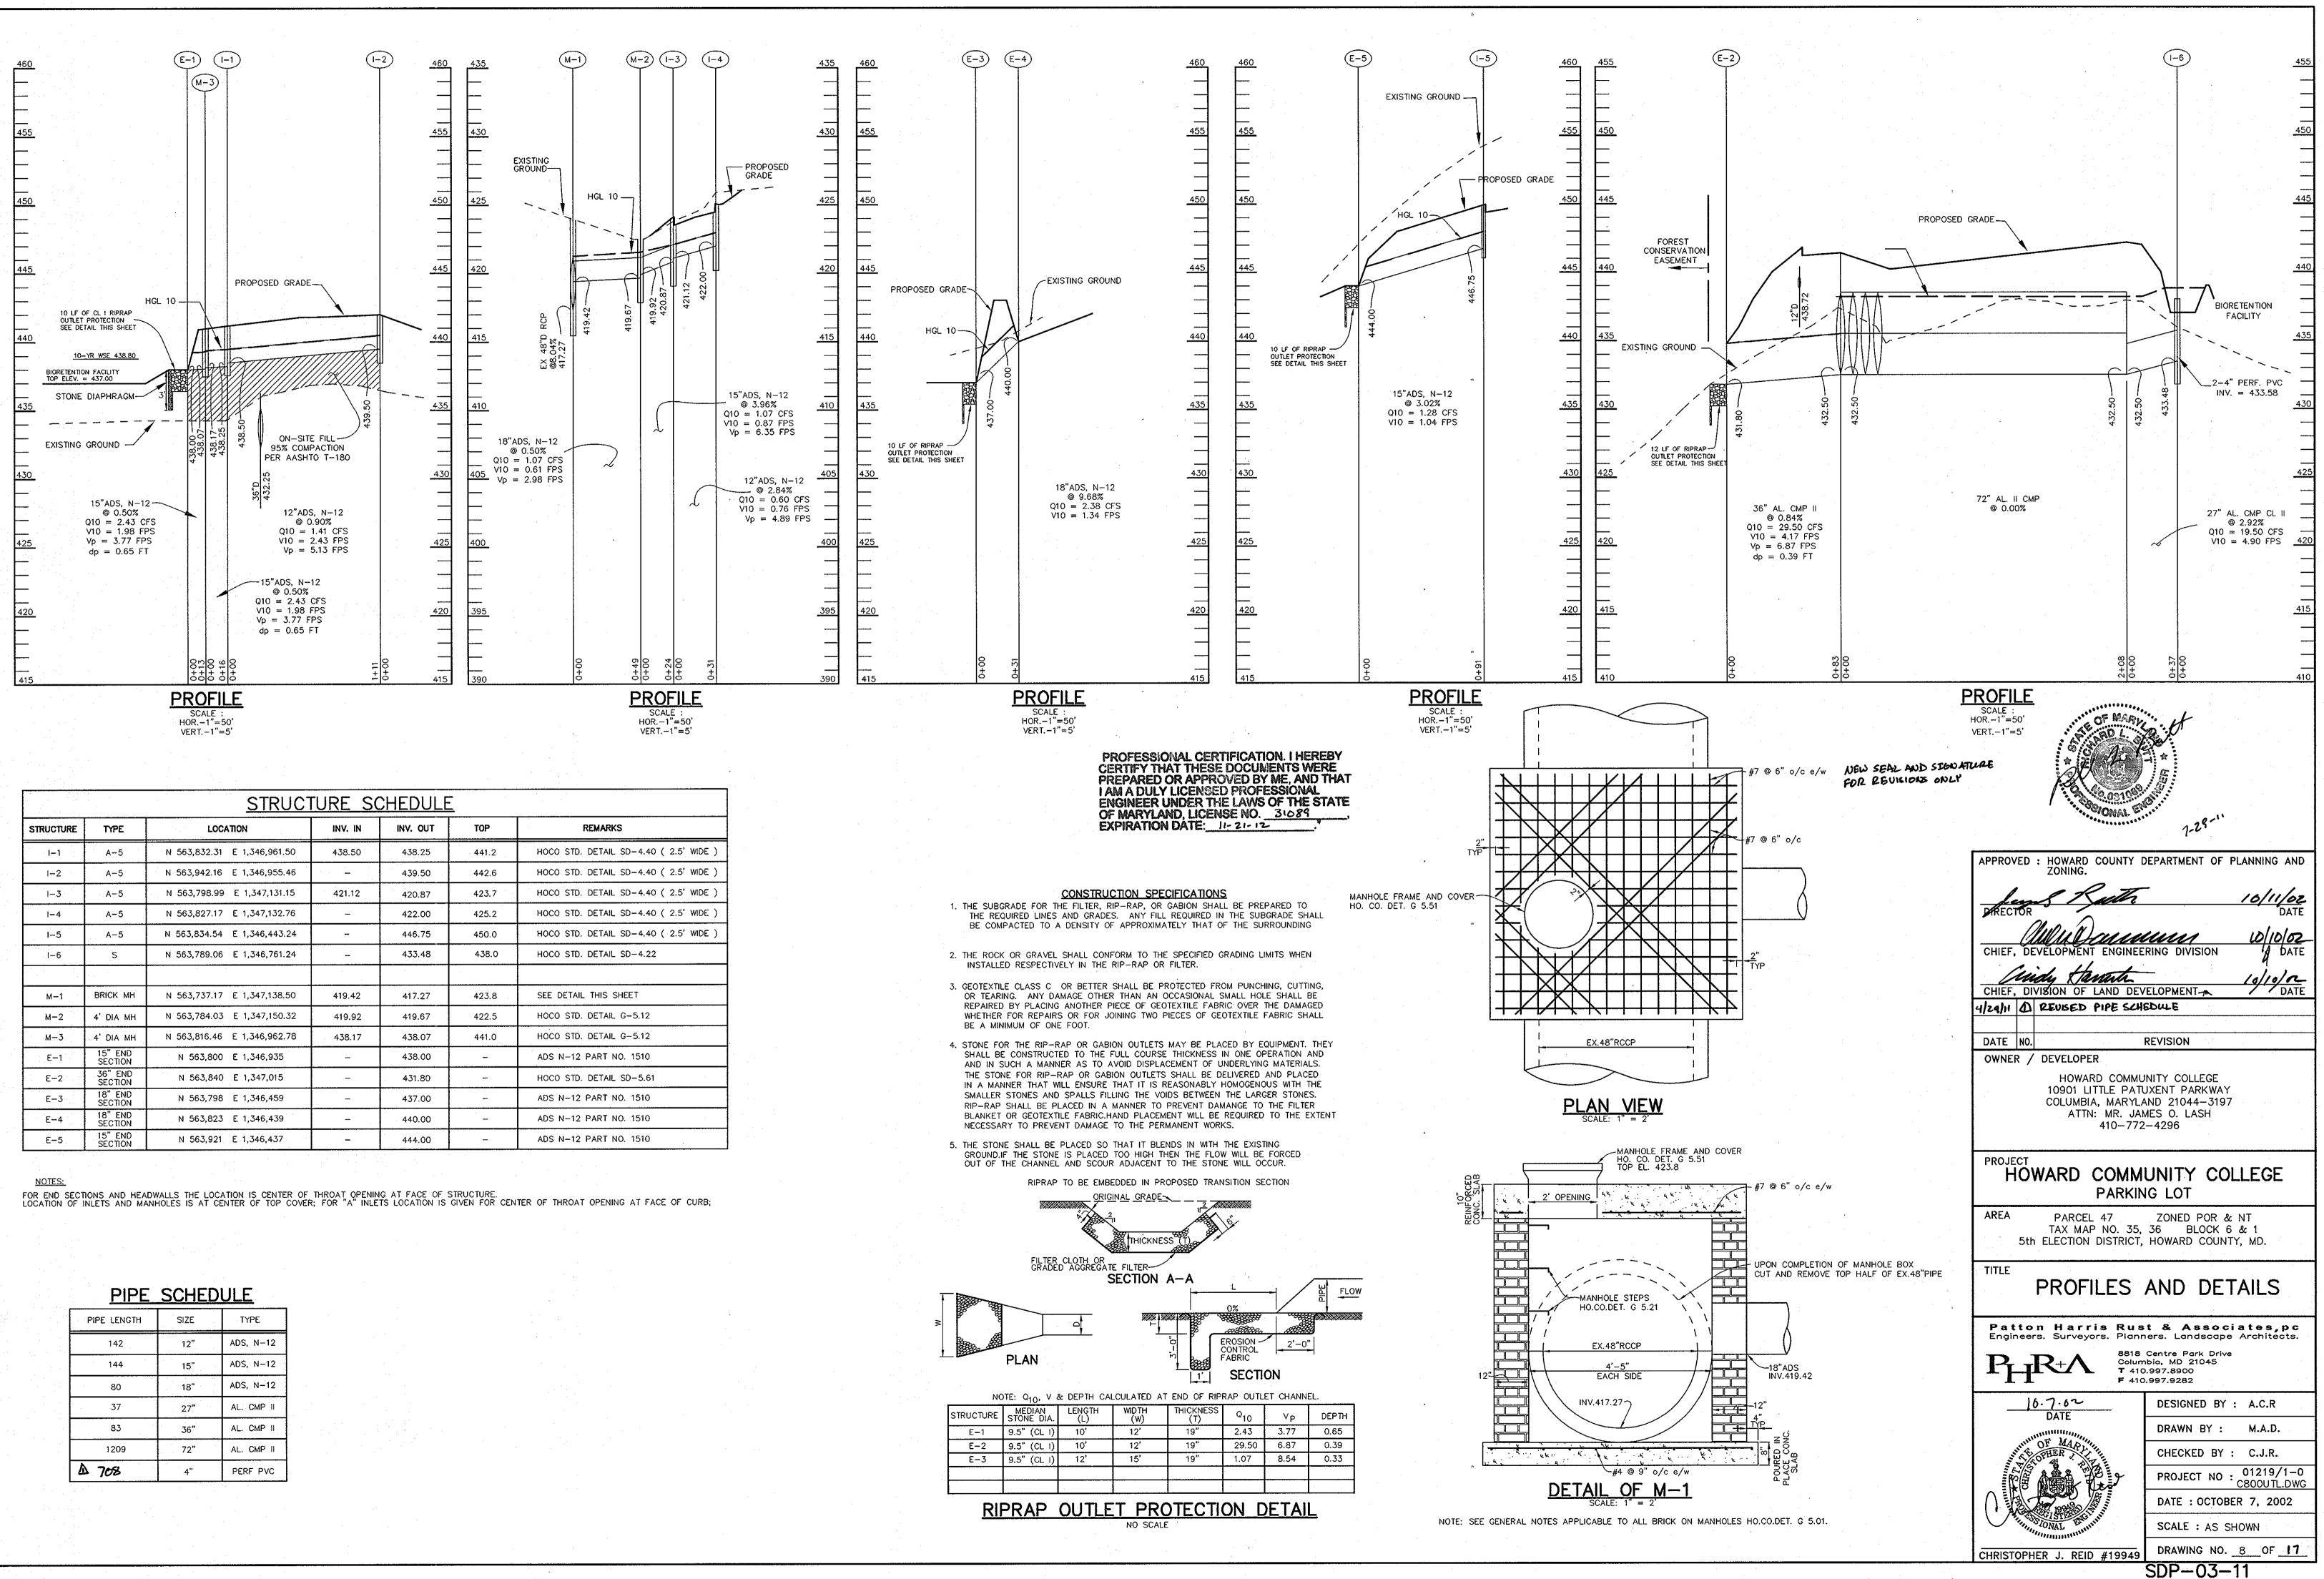

<u>P</u>	<u>IP</u>	E	S	<u>C</u>	Η	E	D	<u>U</u>	L	E	

SIZE	TYPE
12"	ADS, N-12
15"	ADS, N-12
18"	ADS, N-12
27"	AL. CMP II
36"	AL. CMP II
72"	AL. CMP II
4"	PERF PVC
	15" 18" 27" 36" 72"

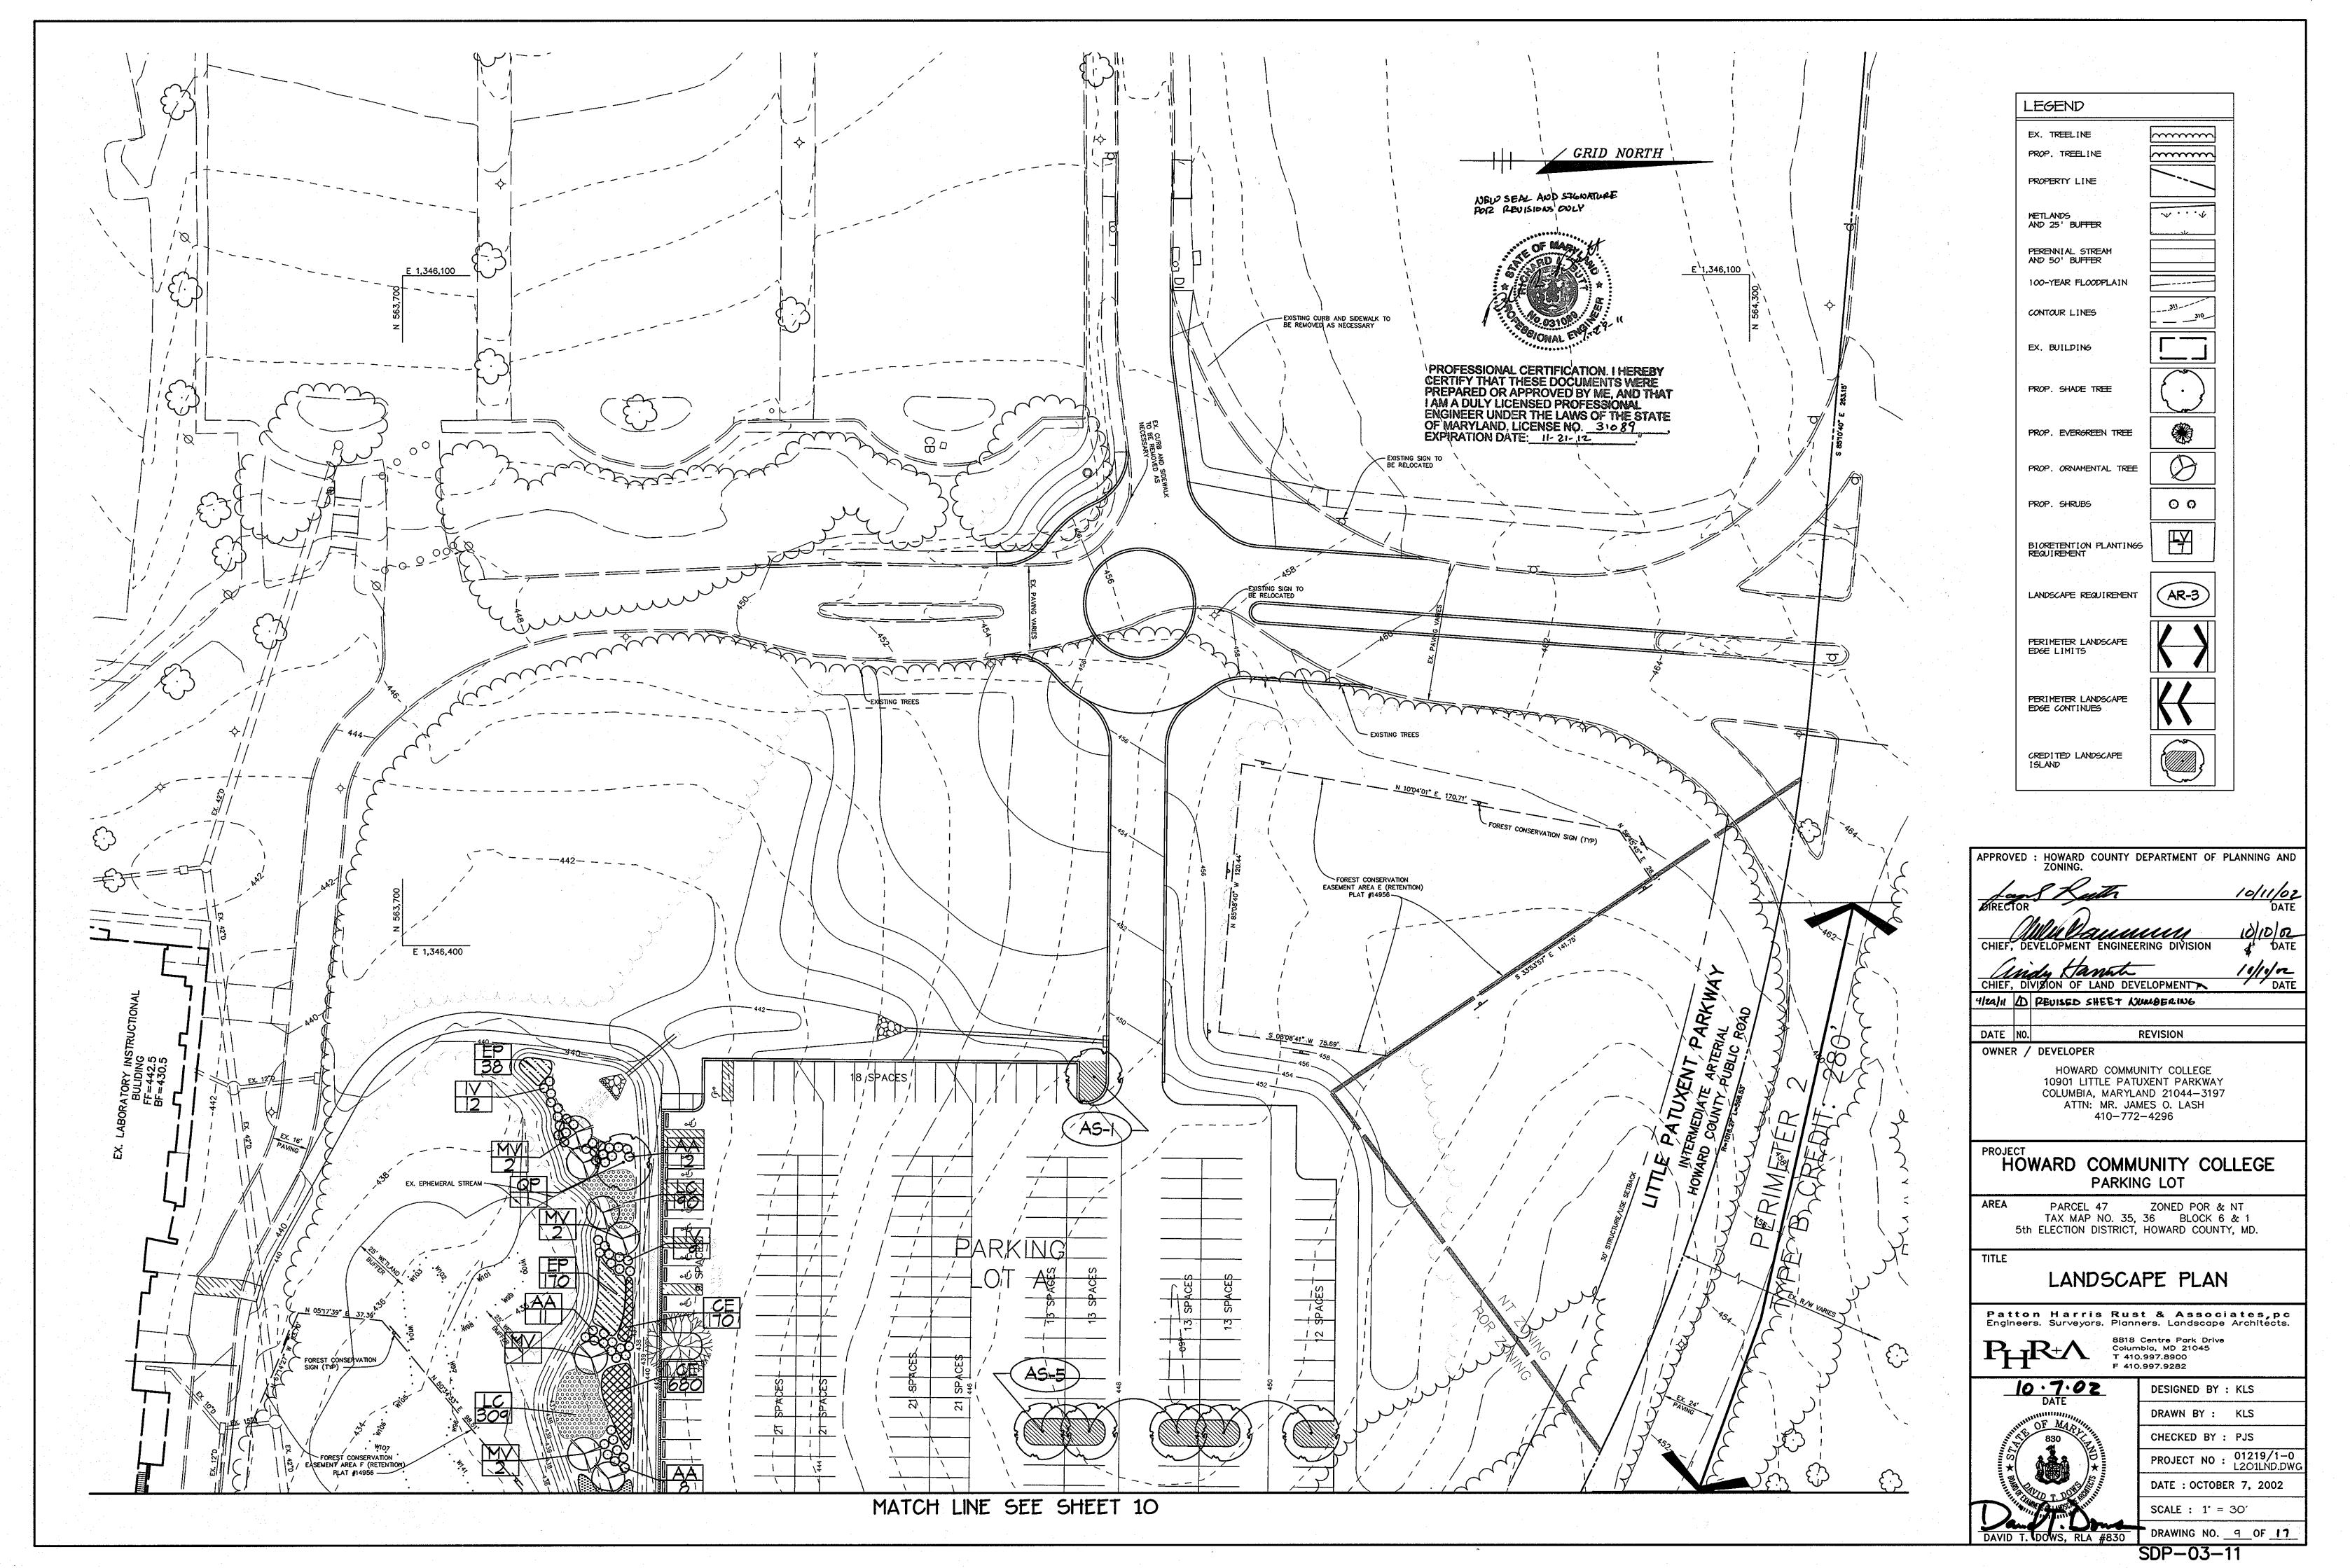

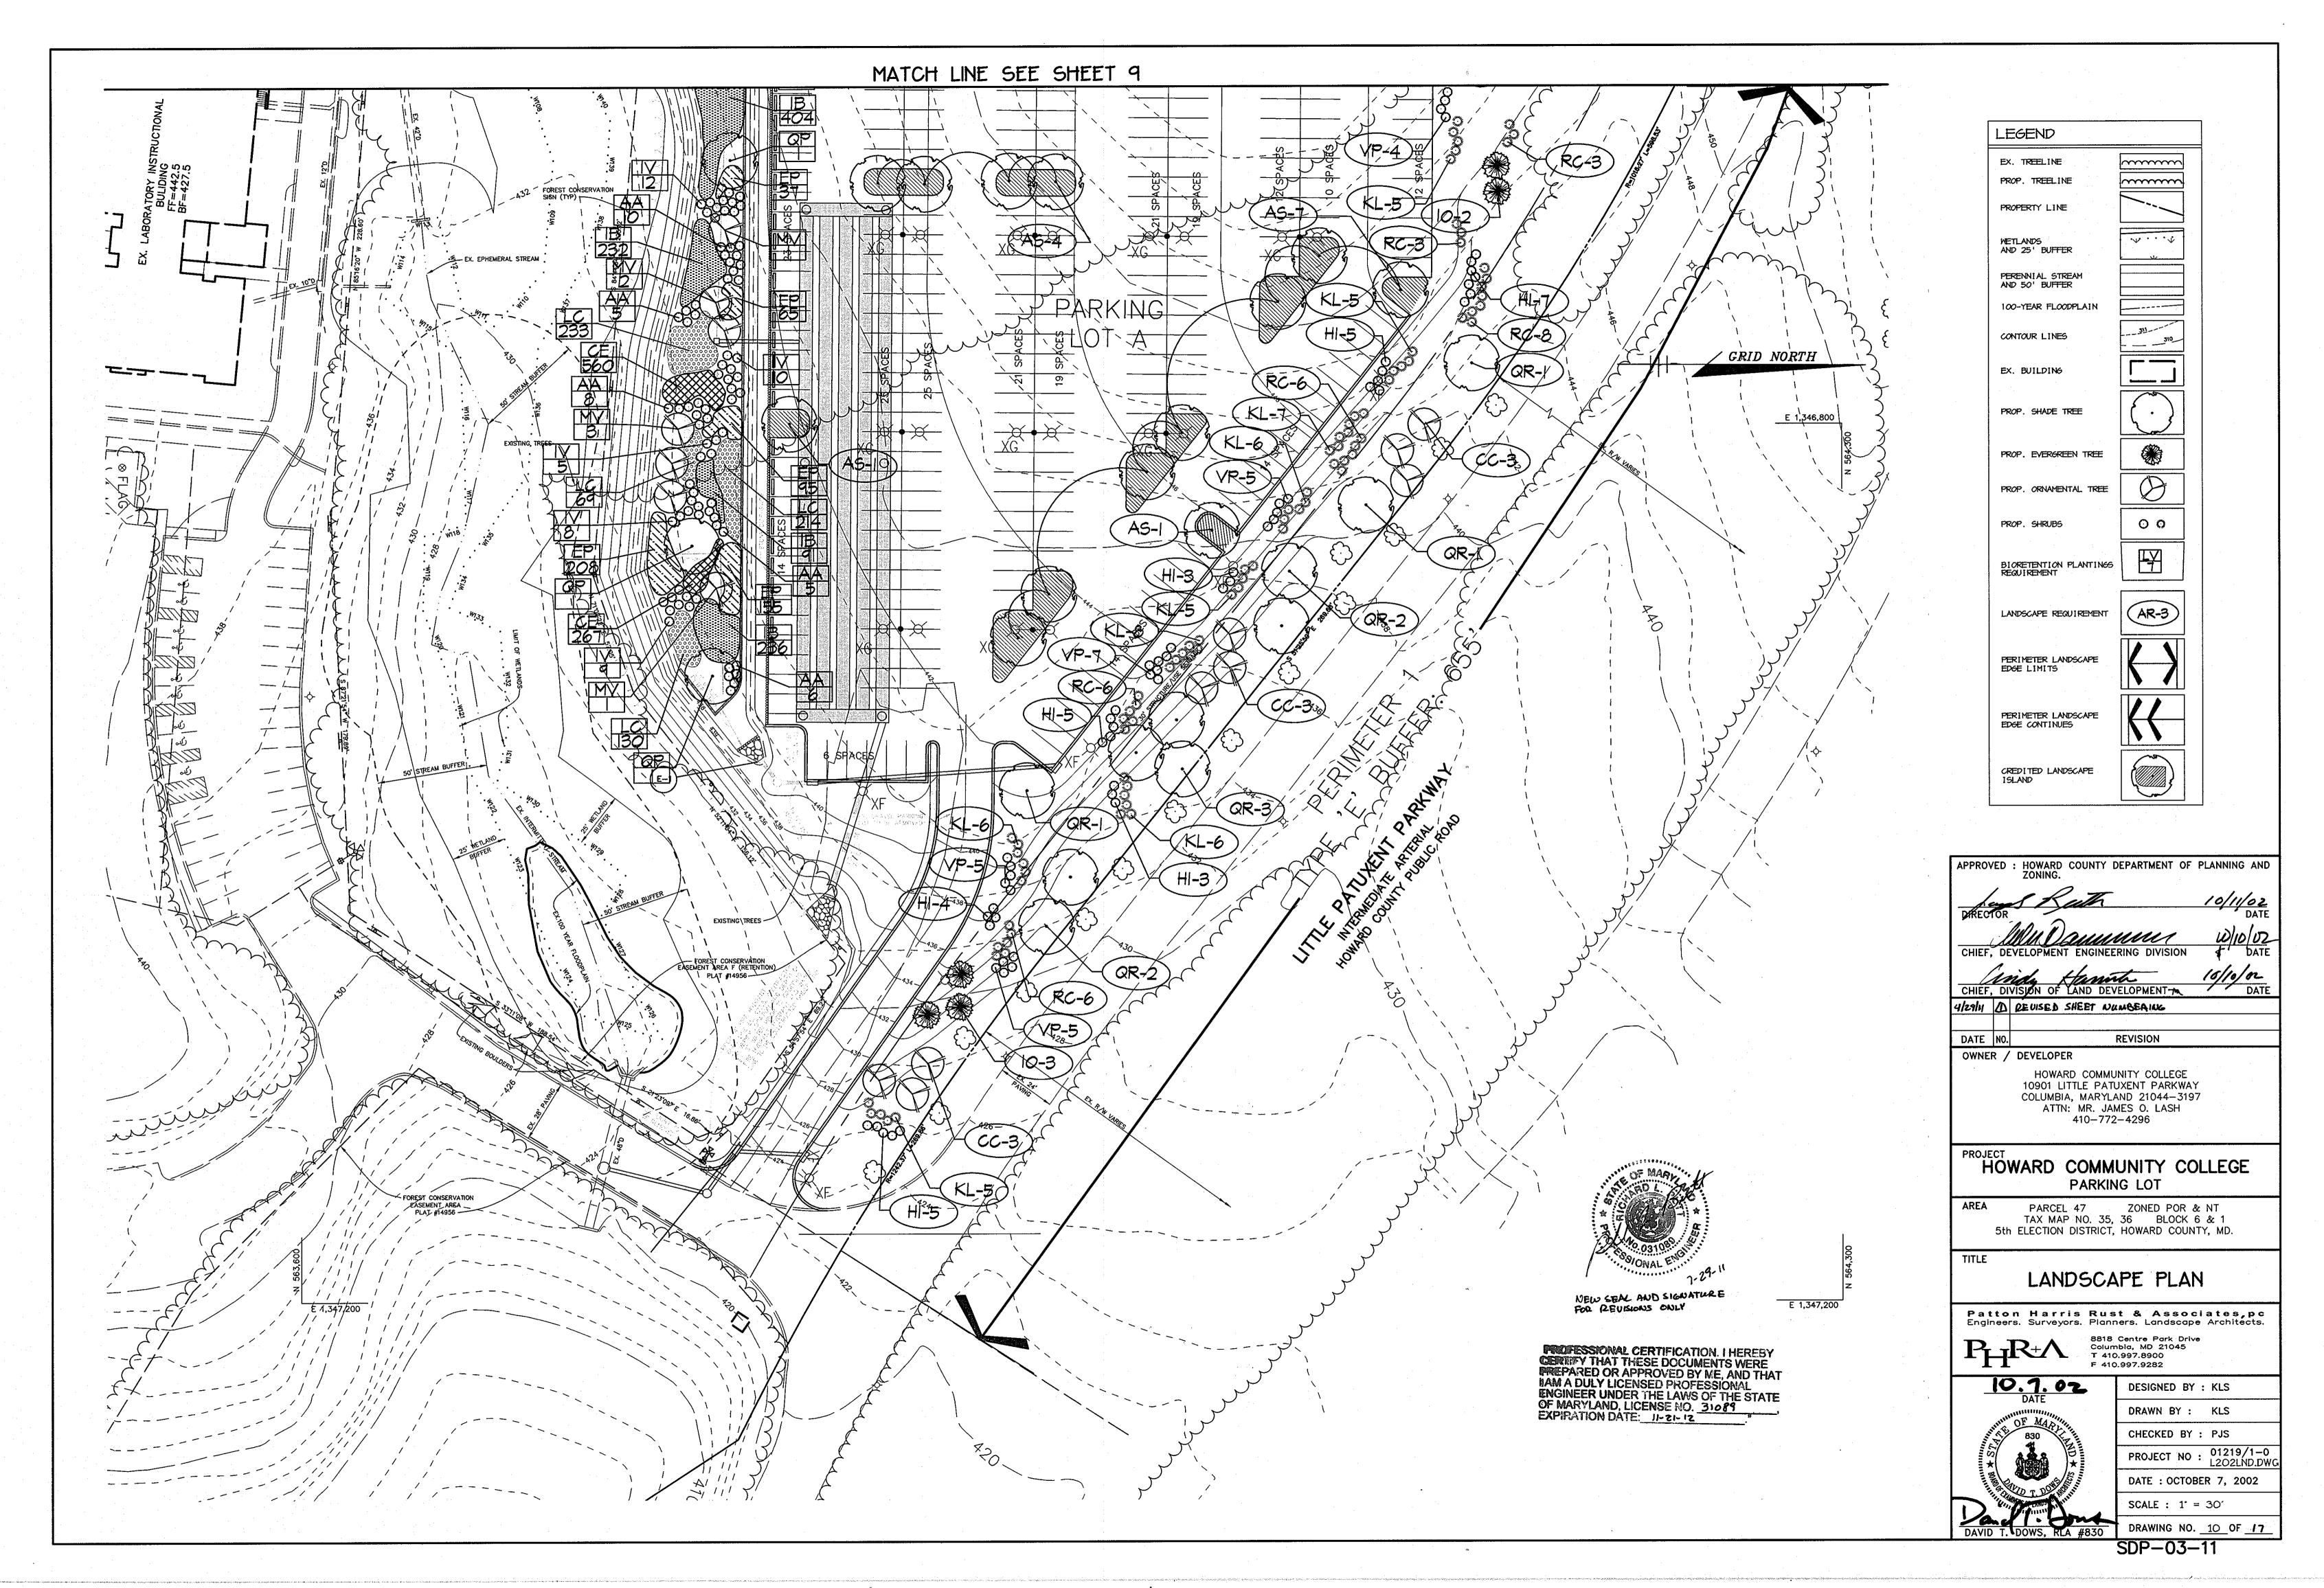


SCHEDULE A - PERIMETER LANDSCAPE EDGE							
	ADJACENT TO ROADWAYS	ADJACENT TO ROADWAYS					
PERIMETER	2	1					
LANDSCAPE TYPE	В	E					
LINEAR FEET OF ROADWAY FRONTAGE/ PERIMETER	280*	655´±					
CREDIT FOR EXISTING DRIVE AISLE CLINEAR FEETD	NO	NO					
CREDIT FOR EXISTING VEGETATION (YES. NO. LINEAR FEET) (DESCRIBE BELOW IF NEEDED)	YES 280±	NO					
LINEAR FEET REMAINING	<b>O</b>	0					
CREDIT FOR WALL. FENCE. OR BERM (YES/NO/LINEAR FEET)	NO -	NO -					
NUMBER OF PLANTS REQUIRED SHADE TREES EVERGREEN TREES SHRUBS	000	16 0 163					
NUMBER OF PLANTS PROVIDED SHADE TREES EVERGREEN TREES SMALL FLOWERING TREES SHRUBS	0000	10 5 9 143					

SCHEDULE A SUBSTITUTION NOTES:

PERIMETER 1: (9) ORNAMENTAL TREES AND (3) EVERGREEN WERE SUBSTITUTED FOR (6) SHADE TREES AND (2) EVERGREEN TREES WERE SUBSTITUTED FOR (20) SHRUBS.

SCHEDULE B - PARKING LOT INTERNAL LAND	SCAPING
PARKING LOT	A
NUMBER OF PARKING SPACES	407
NUMBER OF SHADE TREES REQUIRED (1/20 SPACES)	20
NUMBER OF TREES PROVIDED SHADE TREES OTHER TREES (2:1 SUBSTITUTION)	20
NUMBER OF ISLANDS REQUIRED (1/20 SPACES)	20
NUMBER OF ISLANDS PROVIDED (200 SF/ISLAND)	20

	PLANT LIST							
SYMBOL	QTY.	SCIENTIFIC/ COMMON NAME	SIZE	ROOT	REMARKS			
AS	20	Acer saccharum 'Green Mountain' Green Mountain Sugar Maple	2.5"-3" cal.	B <b>t</b> B	Plant as shown			
QR	10	Quercus rubra Red Oak	2.5"-3" cal.	B¢B	Plant as shown			
IO	5	Ilex opaca American Holly	5-6' ht.	B <b>4</b> B	Plant as shown			
	٩	Cercis canadensis Eastern Redbud	1.5"-2" cal.	B¢B	Plant as shown			
HI	32	Hamamelis x intermedia 'Arnold Promise' Arnold Promise Witchhazel	24"-30" ht.	Cont.	Plant as shown			
KL	53	Kalmia latifolia Mountain Laurel	30"-36" ht.	cont.	Plant as shown			
RC	32	Rhododendron catawblense Catawba Rhododendron	24"-30" ht.	Cont.	Plant as shown			
٧P	26	Viburnum plicatum var. tomentosum Doublefile Viburnum	24"-30" ht.	Cont.	Plant as shown			

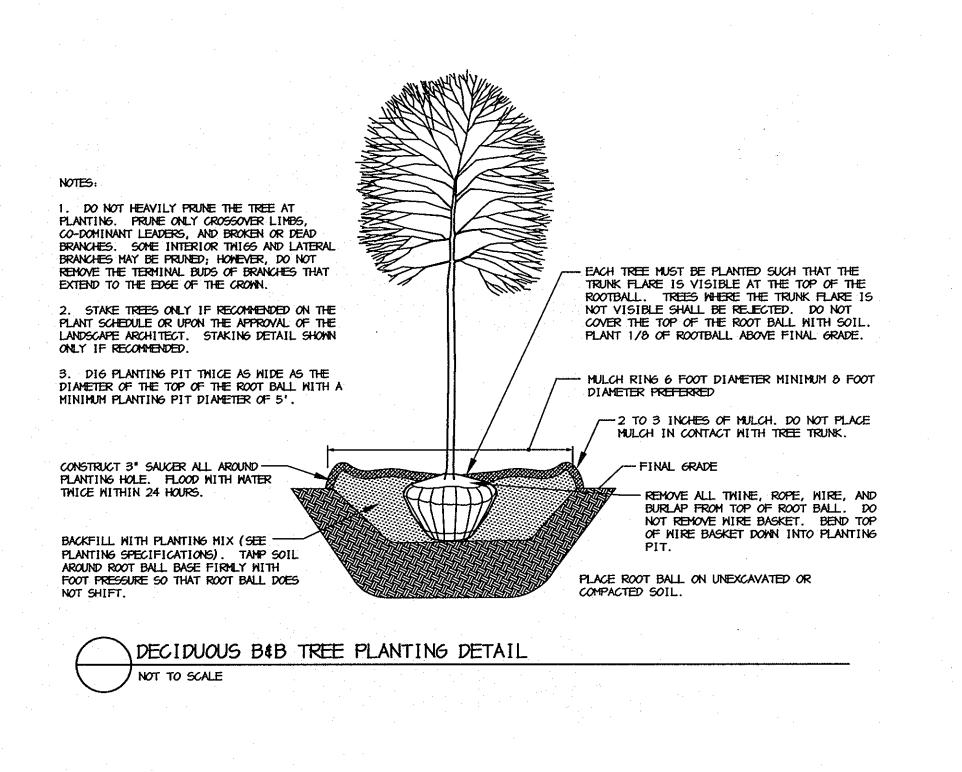

3. Unless otherwise specified, all general conditions, planting operations, details and planting specifications shall conform to the most recent edition of the 'Landscape Specification Guidelines by the Landscape Contractors Association of MD. DC. + VA. (hereinafter 'Landscape Guidelines') approved by the Landscape Contractors Association of Metropolitan Washington and the Potomac Chapter of the American Society of Landscape Architects.

7. Contractor is responsible for installing all material in the proper planting season for each plant type. All planting is to be completed within growing season of completion of site construction. Do not plant Pinus strobus or XCupressacyparis leylandii between November 15 and March 15. Landscape plants are not to be installed before site is graded to final grade. 8. Contractor to regrade. fine grade. sod, hydroseed and straw mulch all areas disturbed by their work.

11. All shrubs and groundcover areas shall be planted in continuous planting beds. prepared as specified, unless otherwise indicated on plans. (See Specification 13). Beds to be mulched with minimum 2° and maximum 3° of composted, double-shredded hardwood mulch throughout. 12. Positive drainage shall be maintained on planting beds (minimum 2 percent slope).

13. Bed preparation shall be as follows: Till into a minimum depth of 6°1 yard of Compro or Leafgro per 200 SF of planting bed. and 1 yard of topsoil per 100 SF of bed. Add 3 lbs of standard 5-10-5 fertilizer per cubic yard of planting mix and till. Ericaceous plants (Azaleas. Rhododendrons. etc.): top dress after planting with iron sulfate or comparable product according to package directions. Taxus baccata 'Repandens' (English weeping yews): Top dress after planting with 1/4 to 1/2 cup line each.

## PLANTING SPECIFICATIONS

1. Plants, related material, and operations shall meet the detailed description, as given on the plans and as described herein. Where discrepancies exist between Standards + Guidelines referenced within these specifications and the Howard County Landscape Manual, the latter takes precedence.

2. All plant material unless otherwise specified, that is not nursery grown, uniformly branched, does not have a vigorous root system, and does not conform to the most recent edition of the American Association of Nurserymen (AAN) Standards will be rejected. Plant material that is not healthy. vigorous. free from defects. decay. disfiguring roots. sunscald injuries. abrasions of the bark, plant disease, insect pest eggs, borers and all forms of insect infestations or objectionable disfigurements will be rejected. Plant material that is weak or which has been cut back from larger grades to meet specified requirements will be rejected. Trees with forked leaders will be rejected. All B + B plants shall be freshly dug; no healed-in plants or plants from cold storage will be accepted.

4. Contractor shall guarantee all plant material for a period of one year after date of acceptance in accordance with the appropriate section on the Landscape Guidelines. Contractor's attention is directed to the maintenance requirements found within the one year specifications including watering and replacement of specified plant material.

5. Contractor shall be responsible for notifying all relevant and appropriate utility companies. utility contractors, and 'Miss Utility' a minimum of 48 hours prior to the beginning of any work. Contractor may make minor adjustments in spacing and location of plant material to avoid conflicts with utilities. Major changes will require the approval of the landscape architect. Damage to existing structure and utilities shall be repaired at the expense of the Contractor.

6. Protection of existing vegetation to remain shall be accomplished via the temporary installation of 4 foot high snow fence at the drip line. see detail.

9. Bid shall be based on actual site conditions. No extra payment shall be made for work arising from actual site conditions differing from those indicated on drawings and specifications.

10. Plant quantities are provided for the convenience of the contractor only. If discrepancies exist between quantities shown on plan and those shown on the plant list. the quantities on the plan take precedence. Where discrepancies on the plan exist between the symbols and the callout leader. the number of symbols take precedence.


14. Planting mix: For trees not in a prepared bed, mix 50% Compro or Leafgro with 50% soil from tree hole to use as backfill, see tree planting detail.

15. Weed + insect controls incorporate a pre-emergent herbicide into the planting bed following recommended rates on the label. For tree planting, apply a pre-emergent on top of soil and root ball before mulching. Caution: For areas to be planted with a ground cover. be sure to carefully check the chemical used to assure its adaptability to the specific groundcover to be treated. Maintain the mulch weed-free for the extent of the warranty period. Under no circumstances is a pesticide containing chlorpyrifos to be used as a means of pest control.

16. Water: All plant material planted shall be watered thoroughly the day of planting. All plant material not yet planted shall be properly protected from drying out until planted. At a minimum, water unplanted plant material daily and as necessary to avoid dessication.

17. Pruning: Do not heavily prune trees and shrubs at planting. Prune only broken, dead, or diseased branches.

18. All areas within contract limits disturbed during or prior to construction not designated to receive plants and mulch shall be fine graded, grass seed planted, and covered with straw mulch.

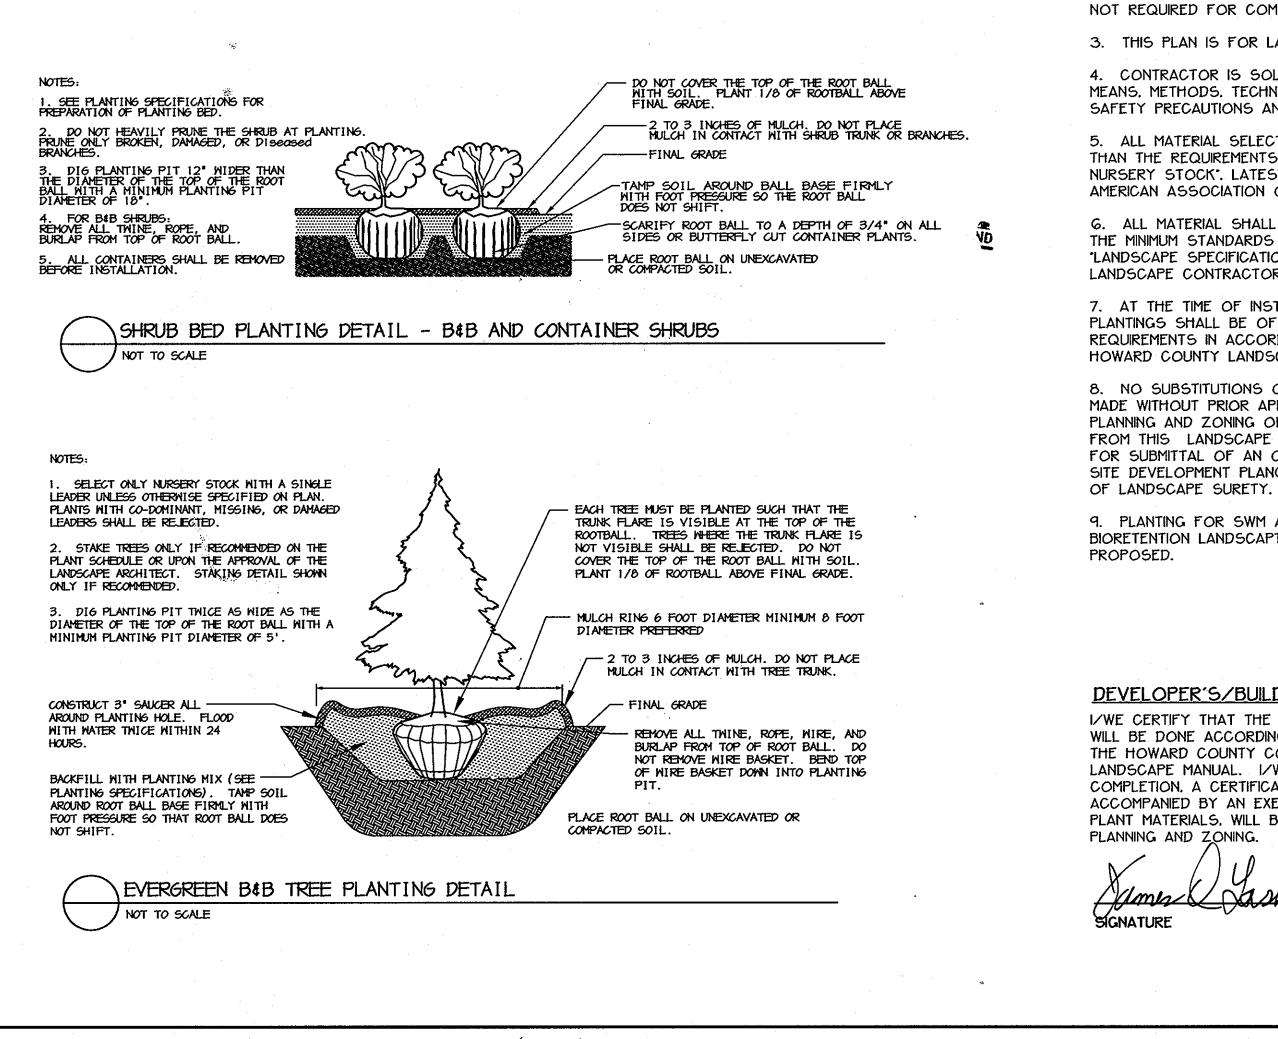

GENERAL NOTES: 1. THIS PLAN HAS BEEN PREPARED IN ACCORDANCE WITH THE PROVISIONS OF SECTION 16.124 OF THE HOWARD COUNTY CODE AND THE LANDSCAPE MANUAL.

2. FINANCIAL SURETY FOR THE REQUIRED LANDSCAPING IS NOT REQUIRED FOR COMMUNITY COLLEGE PROJECTS.

BIORETENTION PLANT LIST						
SYMBOL	QTY.	SCIENTIFIC/ COMMON NAME	SIZE	ROOT	REMARKS	
QP	4	Quercus palustris Pin Oak	2.5"-3" cal.	B¢B	Plant as shown	
MV	14	Magnolla virginiana Swamp Magnolia	6'-8' ht.	B¢B	Plant as shown	
AA	65	Aronia arbutifolia Red Chokeberry	24" ht.	B₫B	Plant as shown	
I٧	65	Itea verticilata 'Red Sprite' Winterberry	24" ht.	B¢B	Plant as shown	
CE	1677	Carex elata 'Aurea' Bowles Golden Sedge	Bare root	B\$B	6" Spacing	
EP	792	Eupatorium Purpurea Joe Pye Weed	1 Gallon	B4B	18" Spacing	
IB	<b>963</b>	Iris versicolor 'Blue Flag' Blue Flag Iris	Bare root	Cont.	18" Spacing	
LC	1145	Lobelia cardinalis Cardinal Flower	1 Gallon	cont.	18" Spacing	

PROFESSIONAL CERTIFICATION. I HEREBY CERTIFY THAT THESE DOCUMENTS WERE PREPARED OR APPROVED BY ME, AND THAT I AM A DULY LICENSED PROFESSIONAL ENGINEER UNDER THE LAWS OF THE STATE OF MARYLAND, LICENSE NO. 31089 EXPIRATION DATE: 11-21-12

	······································
SCHEDULE D - STORMWATER MANAGEMENT AREA LANDS	CAPING
S.W.M. POND PERIMETER	1
LANDSCAPE TYPE	
LINEAR FEET OF TOTAL PERIMETER	
CREDIT FOR EX. VEGETATION (NO OR YES + Z)	
CREDIT FOR OTHER PROP. LANDSCAPING (NO OR YES + 2)	
LINEAR FEET OF REMAINING PERIMETER	*
NUMBER OF TREES REQUIRED: SHADE TREES	
EVERGREEN TREES	
NUMBER OF PLANTS PROVIDED	
SHADE TREES EVERGREEN TREES	
OTHER TREES (2:1 SUBSTITUTION. 50% MAX.)	

\* SEE GENERAL NOTE #9

NEW SEAL AND SIGNATURE FOR REVISIONS ONLY

of MAD

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'Onal <sup>e</sup>

CHIEF.

DATE NO.

PROJECT

AREA

DAVID

OWNER / DEVELOPER

10.7.02

DOWS

ZONING.

APPROVED : HOWARD COUNTY DEPARTMENT OF PLANNING AND

annun

REVISION

HOWARD COMMUNITY COLLEGE

10901 LITTLE PATUXENT PARKWAY COLUMBIA, MARYLAND 21044-3197

ATTN: MR. JAMES O. LASH

410-772-4296

HOWARD COMMUNITY COLLEGE

PARKING LOT

5th ELECTION DISTRICT, HOWARD COUNTY, MD.

AND DETAILS

Patton Harris Rust & Associates,pc

8818 Centre Park Drive

DESIGNED BY : KLS

DRAWN BY : KLS

CHECKED BY : PJS

DATE : OCTOBER 7, 2002

DRAWING NO. 11 OF 17

SCALE : AS SHOWN

**PROJECT NO :** 

SDP-03-11

01219/1-0

L2O3LND.DWG

Columbia, MD 21045

T 410.997.8900

F 410.997.9282

Engineers. Surveyors. Planners. Landscape Architects.

TITLE LANDSCAPE SCHEDULES

PARCEL 47 ZONED POR & NT

TAX MAP NO. 35, 36 BLOCK 6 & 1

DEVELOPMENT ENGINEERING DIVISION

CHIEF. DIVISION OF LAND DEVELOPMENT

4/24/11 A REVISED SHEET NUMBERING

10/11/02

1/0/n

/ DATE

DATE

3. THIS PLAN IS FOR LANDSCAPING PURPOSES ONLY.

4. CONTRACTOR IS SOLELY RESPONSIBLE FOR CONSTRUCTION MEANS, METHODS, TECHNIQUES, SEQUENCES, PROCEDURES, AND SAFETY PRECAUTIONS AND PROGRAMS.

5. ALL MATERIAL SELECTED SHALL BE EQUAL TO OR BETTER THAN THE REQUIREMENTS OF THE USA STANDARD FOR NURSERY STOCK". LATEST EDITION, AS PUBLISHED BY THE AMERICAN ASSOCIATION OF NURSERYMEN.

6. ALL MATERIAL SHALL BE PLANTED IN ACCORDANCE WITH THE MINIMUM STANDARDS CITED IN THE LATEST EDITION OF "LANDSCAPE SPECIFICATION GUIDELINES" PUBLISHED BY THE LANDSCAPE CONTRACTORS ASSOCIATION.

7. AT THE TIME OF INSTALLMENT, ALL SHRUBS AND OTHER PLANTINGS SHALL BE OF THE PROPER HEIGHT AND/OR SPREAD REQUIREMENTS IN ACCORDANCE WITH THIS PLAN AND THE HOWARD COUNTY LANDSCAPE MANUAL.

8. NO SUBSTITUTIONS OR RELOCATION OF PLANTS MAY BE MADE WITHOUT PRIOR APPROVAL FROM THE DEPARTMENT OF PLANNING AND ZONING OF HOWARD COUNTY. ANY DEVIATION FROM THIS LANDSCAPE PLAN MAY RESULT IN A REQUIREMENT FOR SUBMITTAL OF AN OFFICIAL "REDLINE REVISION" TO THE SITE DEVELOPMENT PLAN(S) AND/OR DENIAL IN THE RELEASE


9. PLANTING FOR SWM AREAS IS PROVIDED WITH BIORETENTION LANDSCAPTING. NO ADDITIONAL PLANTING IS


DEVELOPER'S/BUILDER'S CERTIFICATE:

I/WE CERTIFY THAT THE LANDSCAPING SHOWN ON THIS PLAN WILL BE DONE ACCORDING TO THE PLAN. SECTION 16.124 OF THE HOWARD COUNTY CODE AND THE HOWARD COUNTY LANDSCAPE MANUAL. I/WE FURTHER CERTIFY THAT UPON COMPLETION. A CERTIFICATION OF LANDSCAPE INSTALLATION. ACCOMPANIED BY AN EXECUTED ONE YEAR GUARANTEE OF PLANT MATERIALS, WILL BE SUBMITTED TO THE DEPARTMENT OF

16.4-02 DATE


<u>m</u> TRAFFIC LIGHT WIT PUBLIC F YAWAAA TNAXUTAG ATTLY ENB<sub>5</sub> 00% FLOW = FCYTY \_\_\_\_\_\_ - - + A = 4.32 ACRCN = 6.57. 4 1 stanter and the X 4270 OTOURING CITO  $\bigcirc$ 

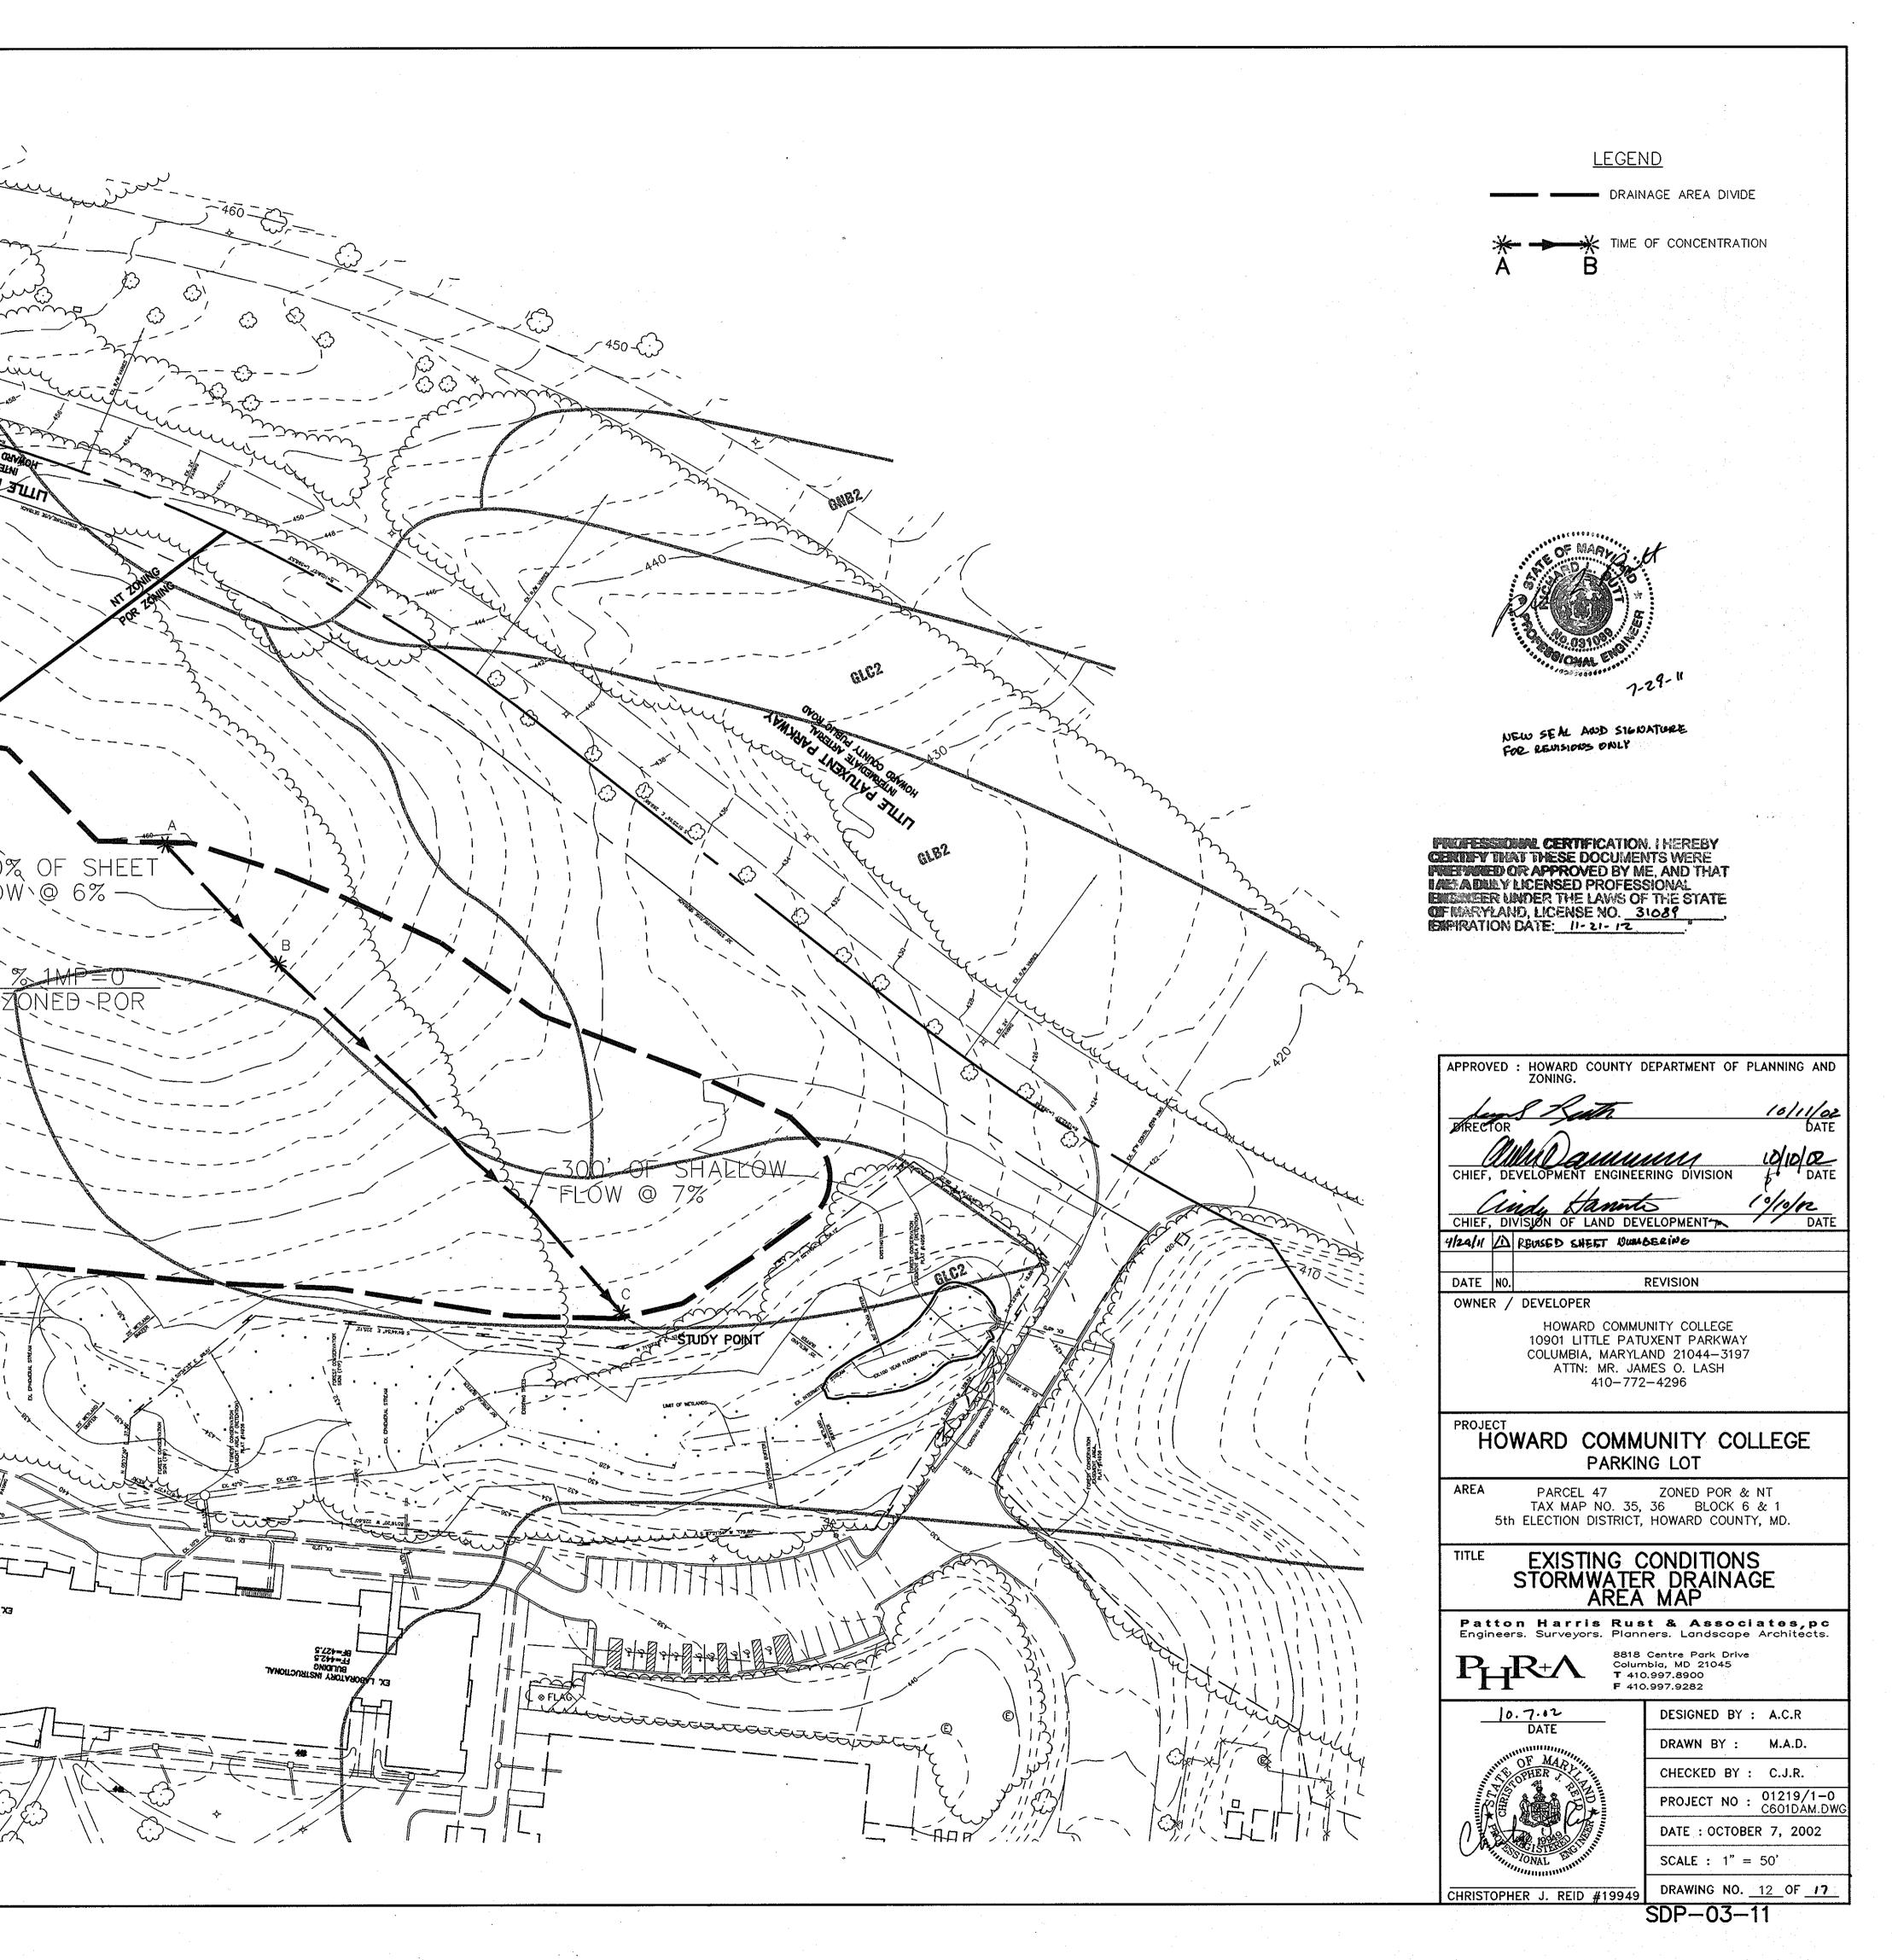

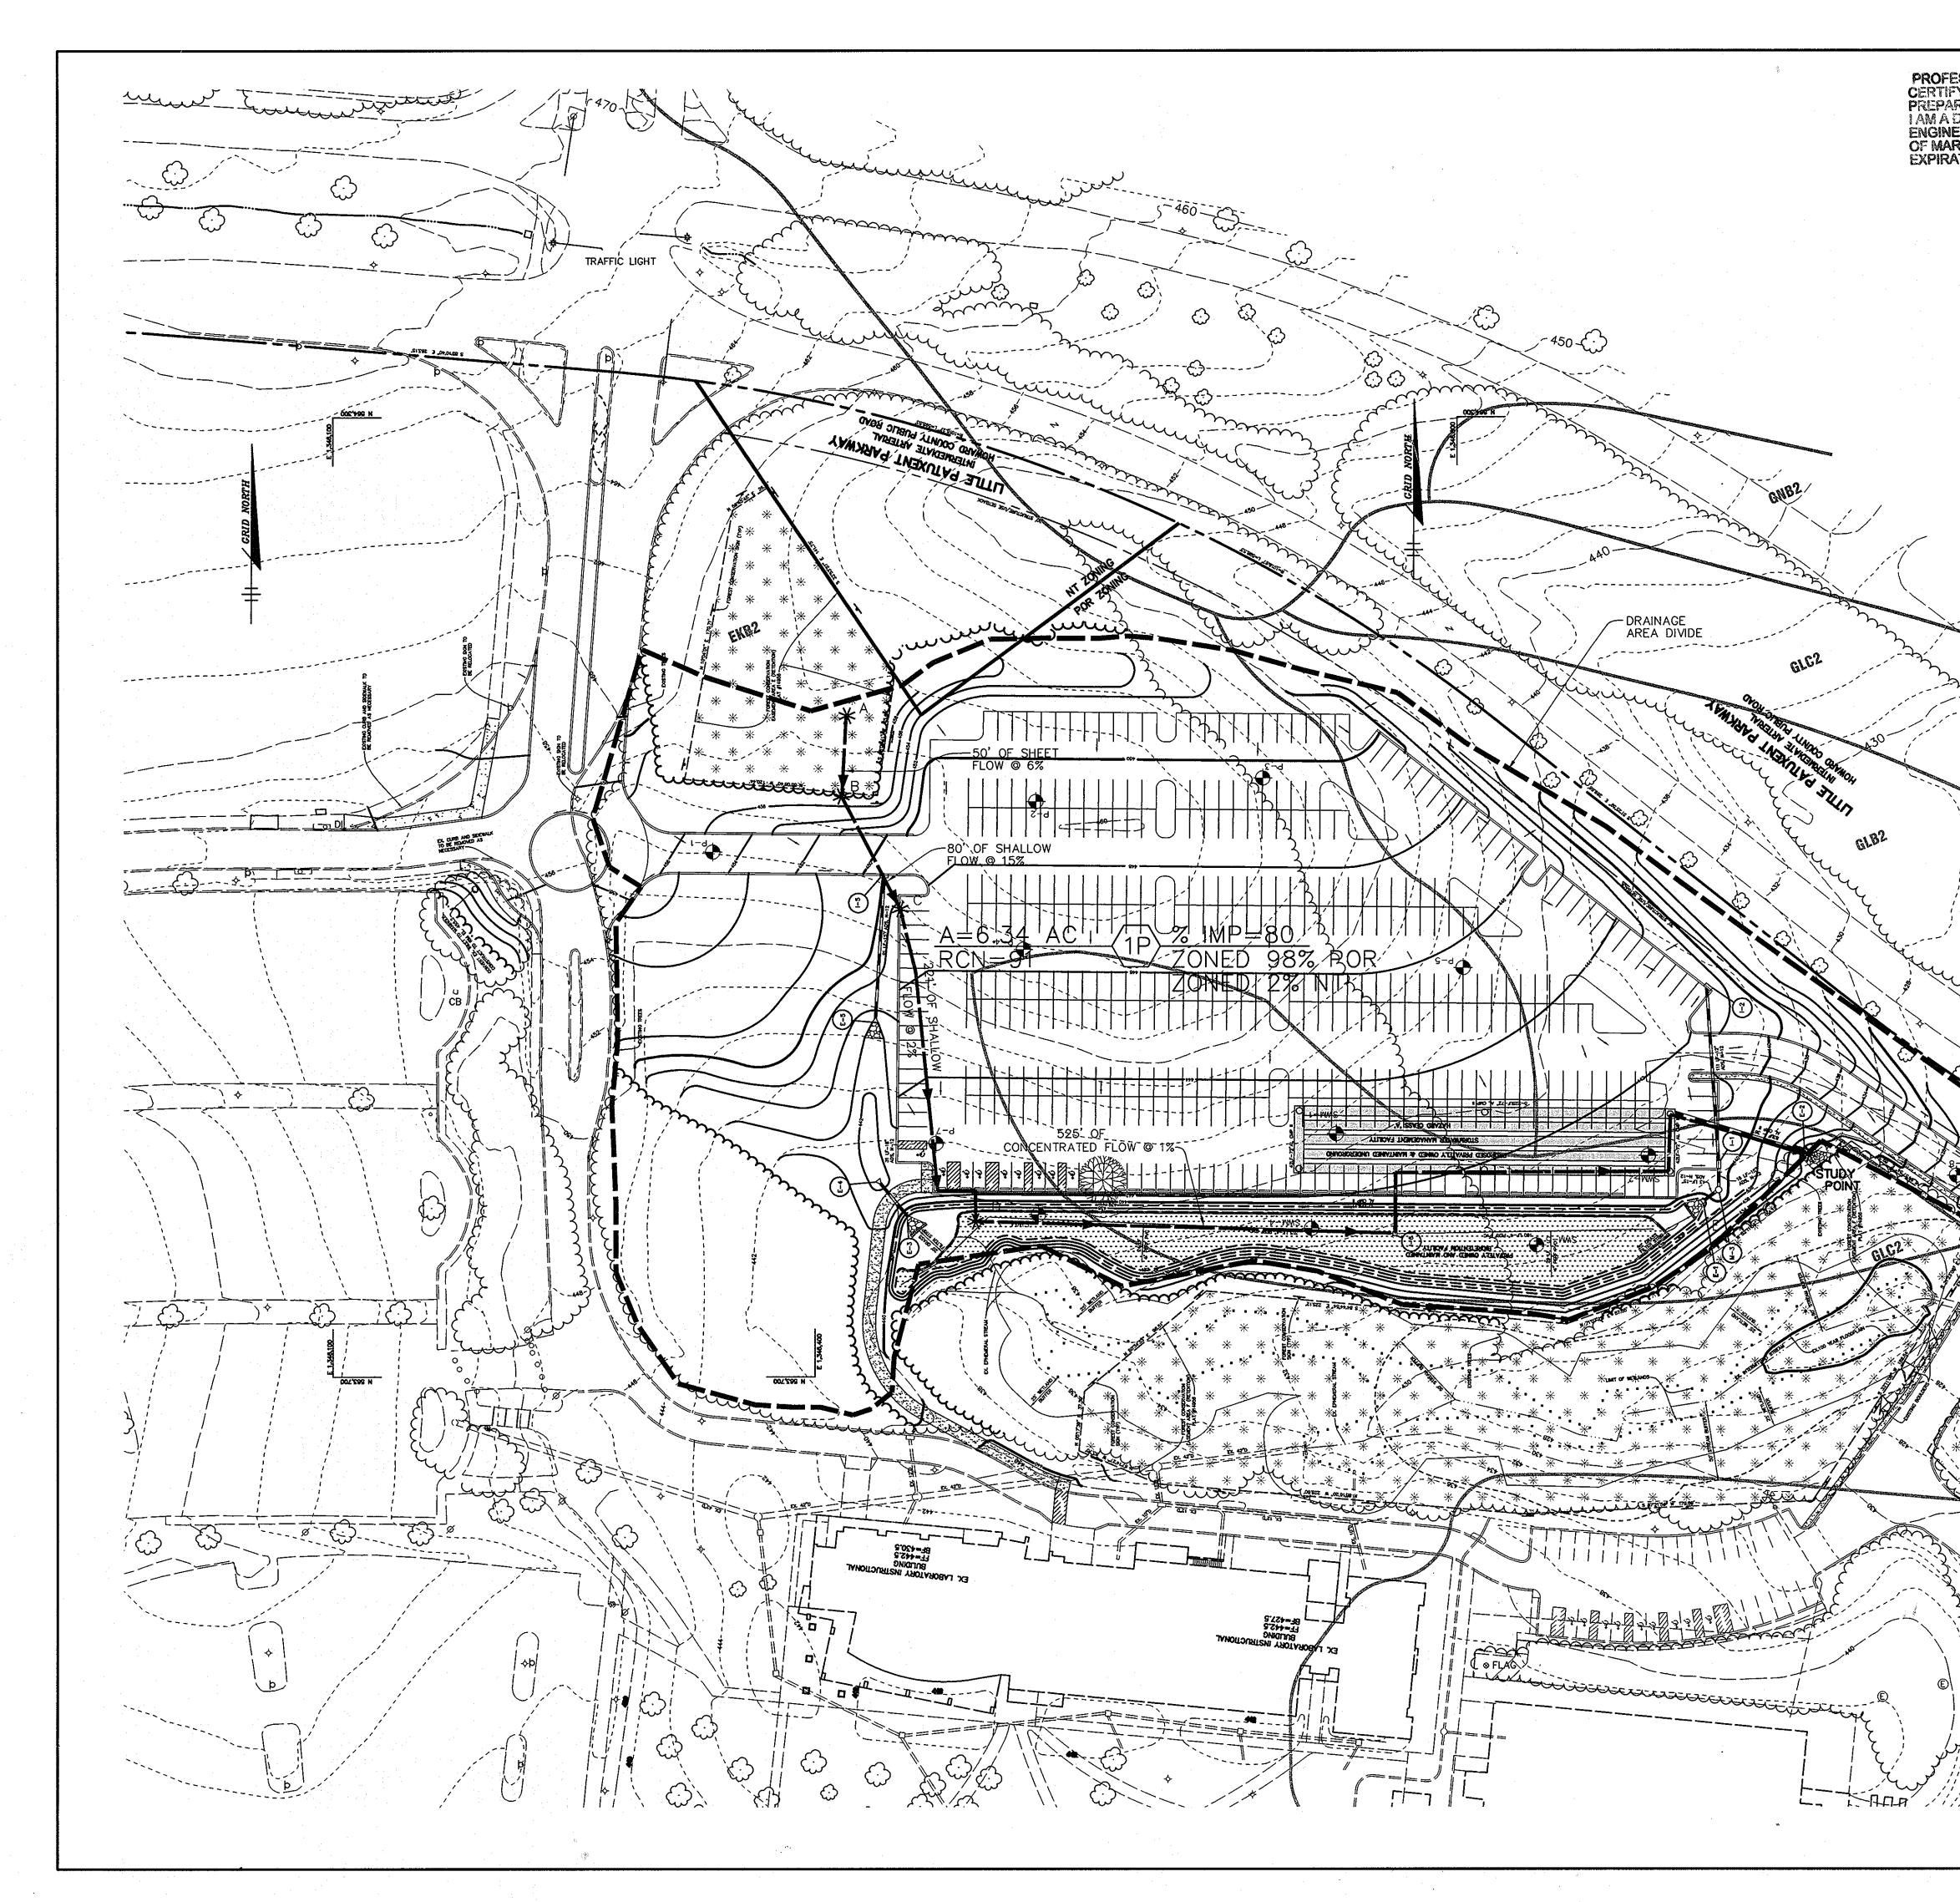


PROFESSIONAL CERTIFICATION. I HEREBY CERTIFY THAT THESE DOCUMENTS WERE PREPARED OR APPROVED BY ME, AND THAT I AM A DULY LICENSED PROFESSIONAL ENGINEER UNDER THE LAWS OF THE STATE OF MARYLAND, LICENSE NO. <u>31089</u> EXPIRATION DATE: <u>11-21-12</u> <u>LEGEND</u> NEW SEAL AND SUGDATURE DRAINAGE AREA DIVIDE FOR REVISIONS ONLY K TIME OF CONCENTRATION NATURAL AREA AND \* \* \* FOREST CONSERVATION \* \* \* EASEMENT \* \* \* > BY THE DEVELOPER : N 204'200 I/WE CERTIFY THAT ALL DEVELOPMENT AND CONSTRUCTION WILL BE DONE ACCORDING TO THIS PLAN, AND THAT ANY RESPONSIBLE PERSONNEL INVOLVED IN THE CONSTRUCTION PROJECT WILL HAVE A CERTIFICATE OF ATTENDANCE AT A DEPARTMENT OF THE ENVIRONMENT APPROVED TRAINING PROGRAM FOR THE CONTROL OF SEDIMENT AND EROSION BEFORE BEGINNING THE PROJECT. I ALSO AUTHORIZE PERIODIC ON-SITE INSPECTIONS BY THE HOWARD SOIL CONSERVATION DISTRICT. 10.4.02 DEVELOPER DATE BY THE ENGINEER : I CERTIFY THAT THIS PLAN FOR EROSION AND SEDIMENT CONTROL REPRESENTS A PRACTICAL AND WORKABLE PLAN BASED ON MY PERSONAL KNOWLEDGE OF THE SITE CONDITIONS AND THAT IT WAS PREPARED IN ACCORDANCE WITH THE REQUIREMENTS OF THE HOWARD SOIL CONSERVATION DISTRICT. 10.7.02 DATE ENGINEER THESE PLANS HAVE BEEN REVIEWED FOR THE HOWARD SOIL CONSERVATION DISTRICT AND MEET THE TECHNICAL REQUIREMENTS FOR SOIL EROSION AND SEDIMENT CONTROL. NATURAL RESOURCES CONSERVATION SERVICE DATE THIS DEVELOPMENT PLAN IS APPROVED FOR SOIL EROSION AND SEDIMENT CONTROL BY THE HOWARD SOIL CONSERVATION DISTRICT. And I DATE HOWARD SOIL CONSERVATION DISTRICT APPROVED : HOWARD COUNTY DEPARTMENT OF PLANNING AND ZONING. 10/11/02 DATE CHIEF, DEVELOPMENT ENGINEERING DIVISION OID DATE 10/02 Indy Tanat CHIEF, DIVISION OF LAND DEVELOPMENT DATE 4/2/11 D REVISED SHEET NUMBERING DATE NO. REVISION OWNER / DEVELOPER HOWARD COMMUNITY COLLEGE 10901 LITTLE PATUXENT PARKWAY COLUMBIA, MARYLAND 21044-3197 ATTN: MR. JAMES O. LASH 410-772-4296 PROJECT HOWARD COMMUNITY COLLEGE PARKING LOT PARCEL 47 ZONED POR & NT TAX MAP NO. 35, 36 BLOCK 6 & 1 5th ELECTION DISTRICT, HOWARD COUNTY, MD. AREA PROPOSED CONDITIONS STORMWATER DRAINAGE AREA MAP TITLE Patton Harris Rust & Associates,pc Engineers. Surveyors. Planners. Landscape Architects 8818 Centre Park Drive Columbia, MD 21045 T 410.997.8900 P<sub>H</sub>R-A F 410.997.9282 16.7.02 DATE DESIGNED BY : A.C.R DRAWN BY : M.A.D. CHECKED BY : C.J.R. PROJECT NO : 01219/1-0 C602DAM.DWG DATE : OCTOBER 7, 2002 **SCALE :** 1" = 50'DRAWING NO. <u>13</u> OF <u>17</u> CHRISTOPHER J. REID #19949 SDP-03-11


01219\1-0\Engr\Plans\Parking\_Lot\C602DAM.dwg, Layout1, 10/04/2002 04:49:37 PM, HP1050C\_Normal(36).pc3, Arch D - 24 x 36 in. (landscape), 1:

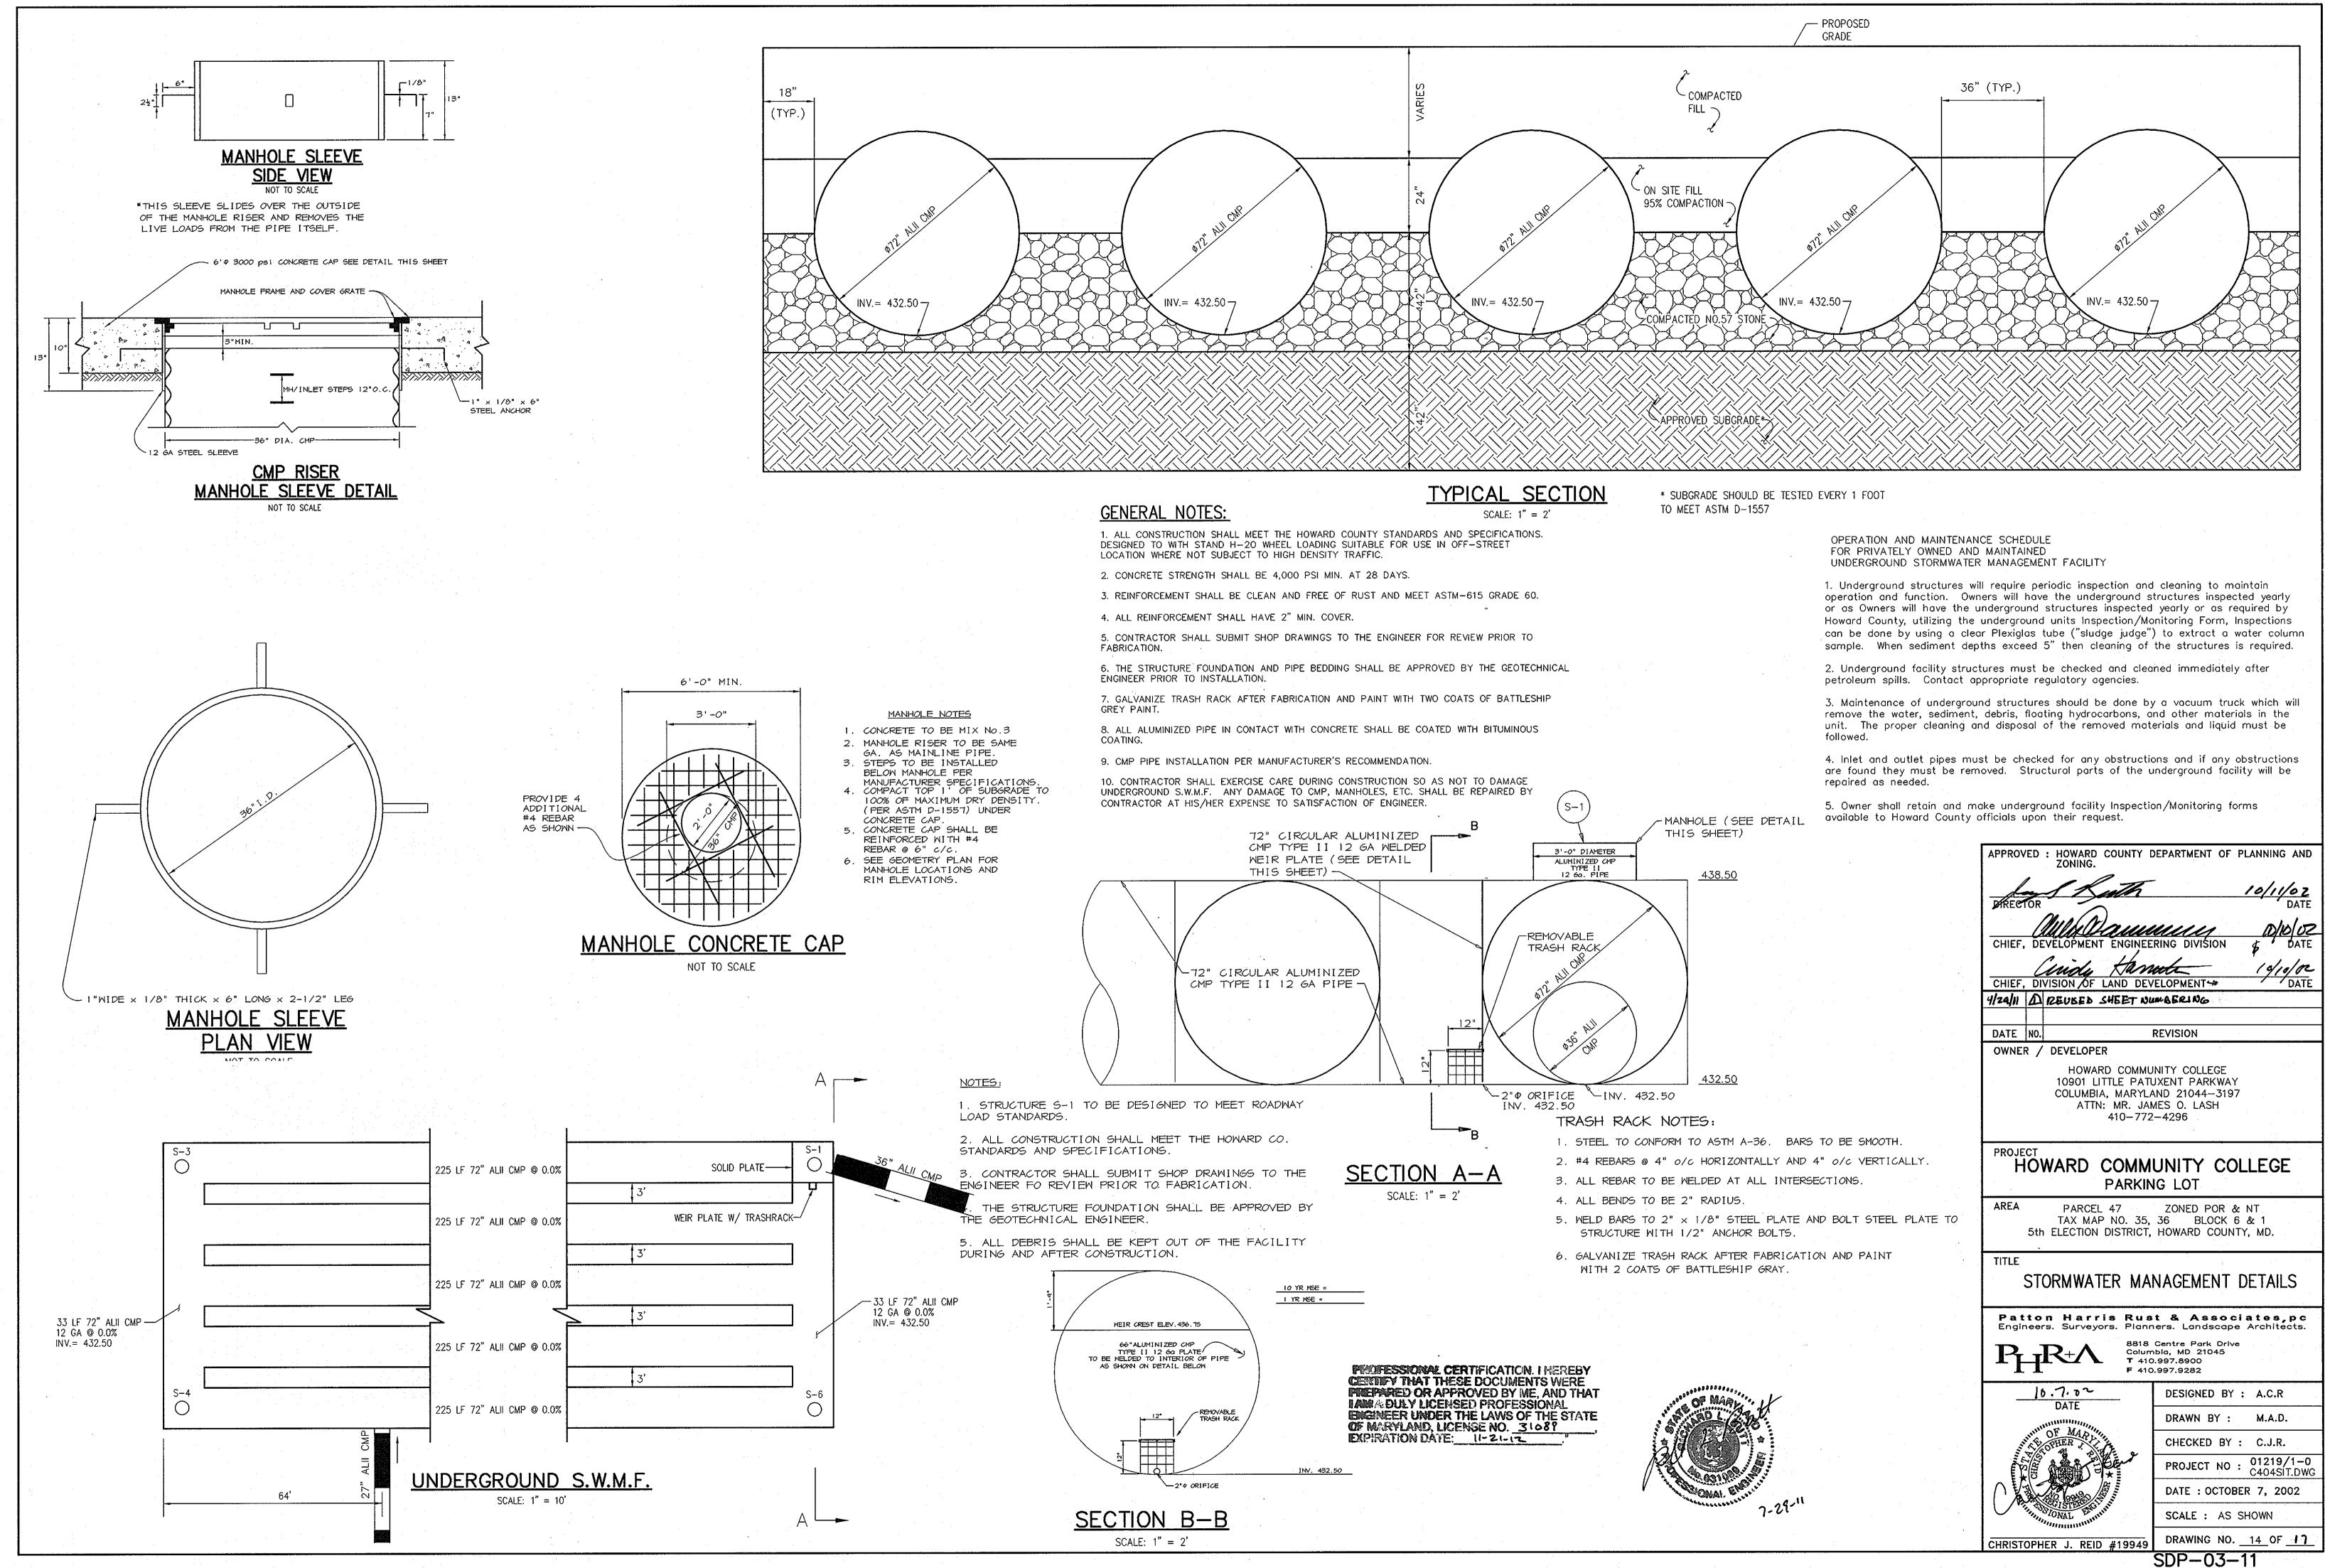

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/ THIS SHEET		
	APPROVED : HOWARD COUNTY ZONING.	DEPARTMENT OF PLANNING AND
438.50		
	DIRECTOR	<u> </u>
	Munhan	Million
	CHIEF, DEVELOPMENT ENGINE	ERING DIVISION & DATE
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	CHIEF, DIVISION OF LAND DE	
	4/24/11 D REUSED SHEET N	un BRING
	DATE NO.	REVISION
	OWNER / DEVELOPER	
432.50	HOWARD COMM	
432.50	10901 LITTLE PAT COLUMBIA, MARYL	AND 21044-3197
K NOTES:	ATTN: MR. JA 410-77	
CONFORM TO ASTM A-36, BARS TO BE SMOOTH.	,	
@ 4" 0/C HORIZONTALLY AND 4" 0/C VERTICALLY.	PROJECT	IUNITY COLLEGE
TO BE WELDED AT ALL INTERSECTIONS.		NG LOT
TO BE 2" RADIUS.	1051	ZONED POR & NT
TO 2" $\times$ 1/8" STEEL PLATE AND BOLT STEEL PLATE TO EWITH 1/2" ANCHOR BOLTS.	TAX MAP NO. 35	
TRASH RACK AFTER FABRICATION AND PAINT DATS OF BATTLESHIP GRAY.	TITLE	
	STORMWATER MA	NAGEMENT DETAILS
	<b>Patton Harris Ru</b> Engineers. Surveyors. Plan	<b>st &amp; Associates,pc</b> ners. Landscape Architects.
		Centre Park Drive mbia, MD 21045 0.997.8900 0.997.9282
20000000000000000000000000000000000000	10.7.02	DESIGNED BY : A.C.R
	DATE	DRAWN BY : M.A.D.
	WITH OF MAR IN	CHECKED BY : C.J.R.
		PROJECT NO : 01219/1-0 C404SIT.DWG
A DECONAL ENGINE		DATE : OCTOBER 7, 2002
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	CHRISTOPHER J. REID #19949	DRAWING NO. 14 OF 17
		SDD 07 11



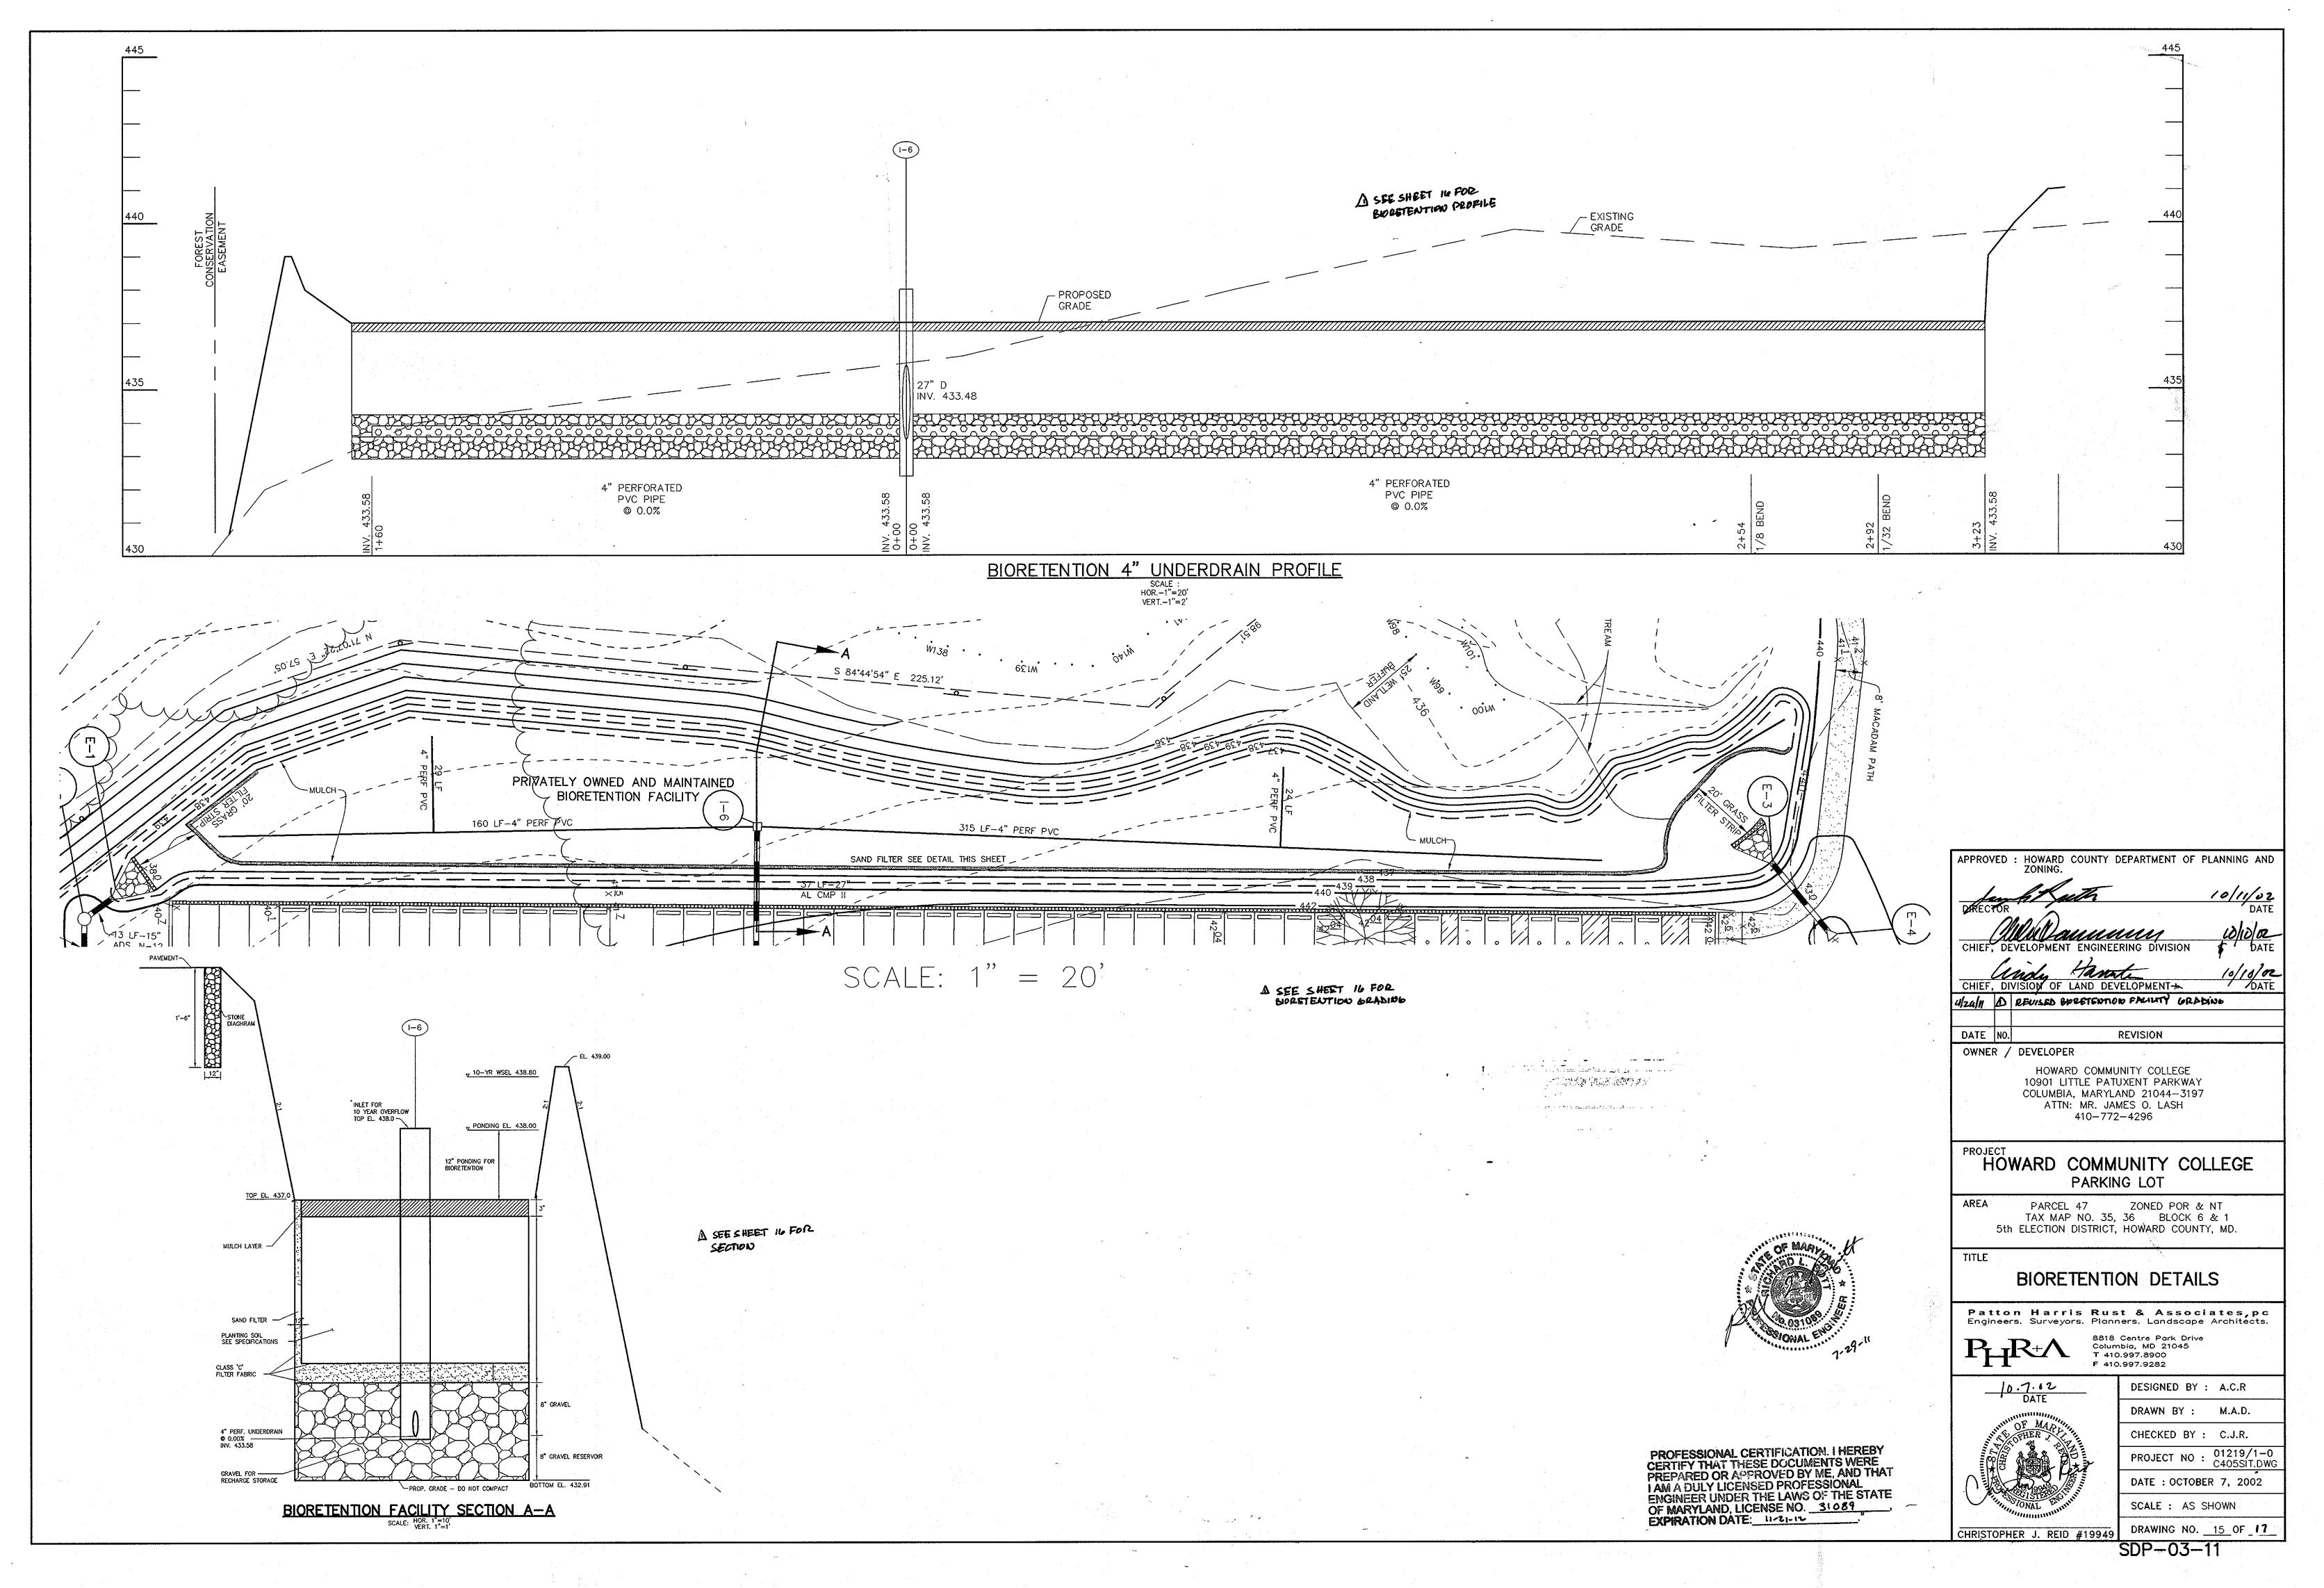
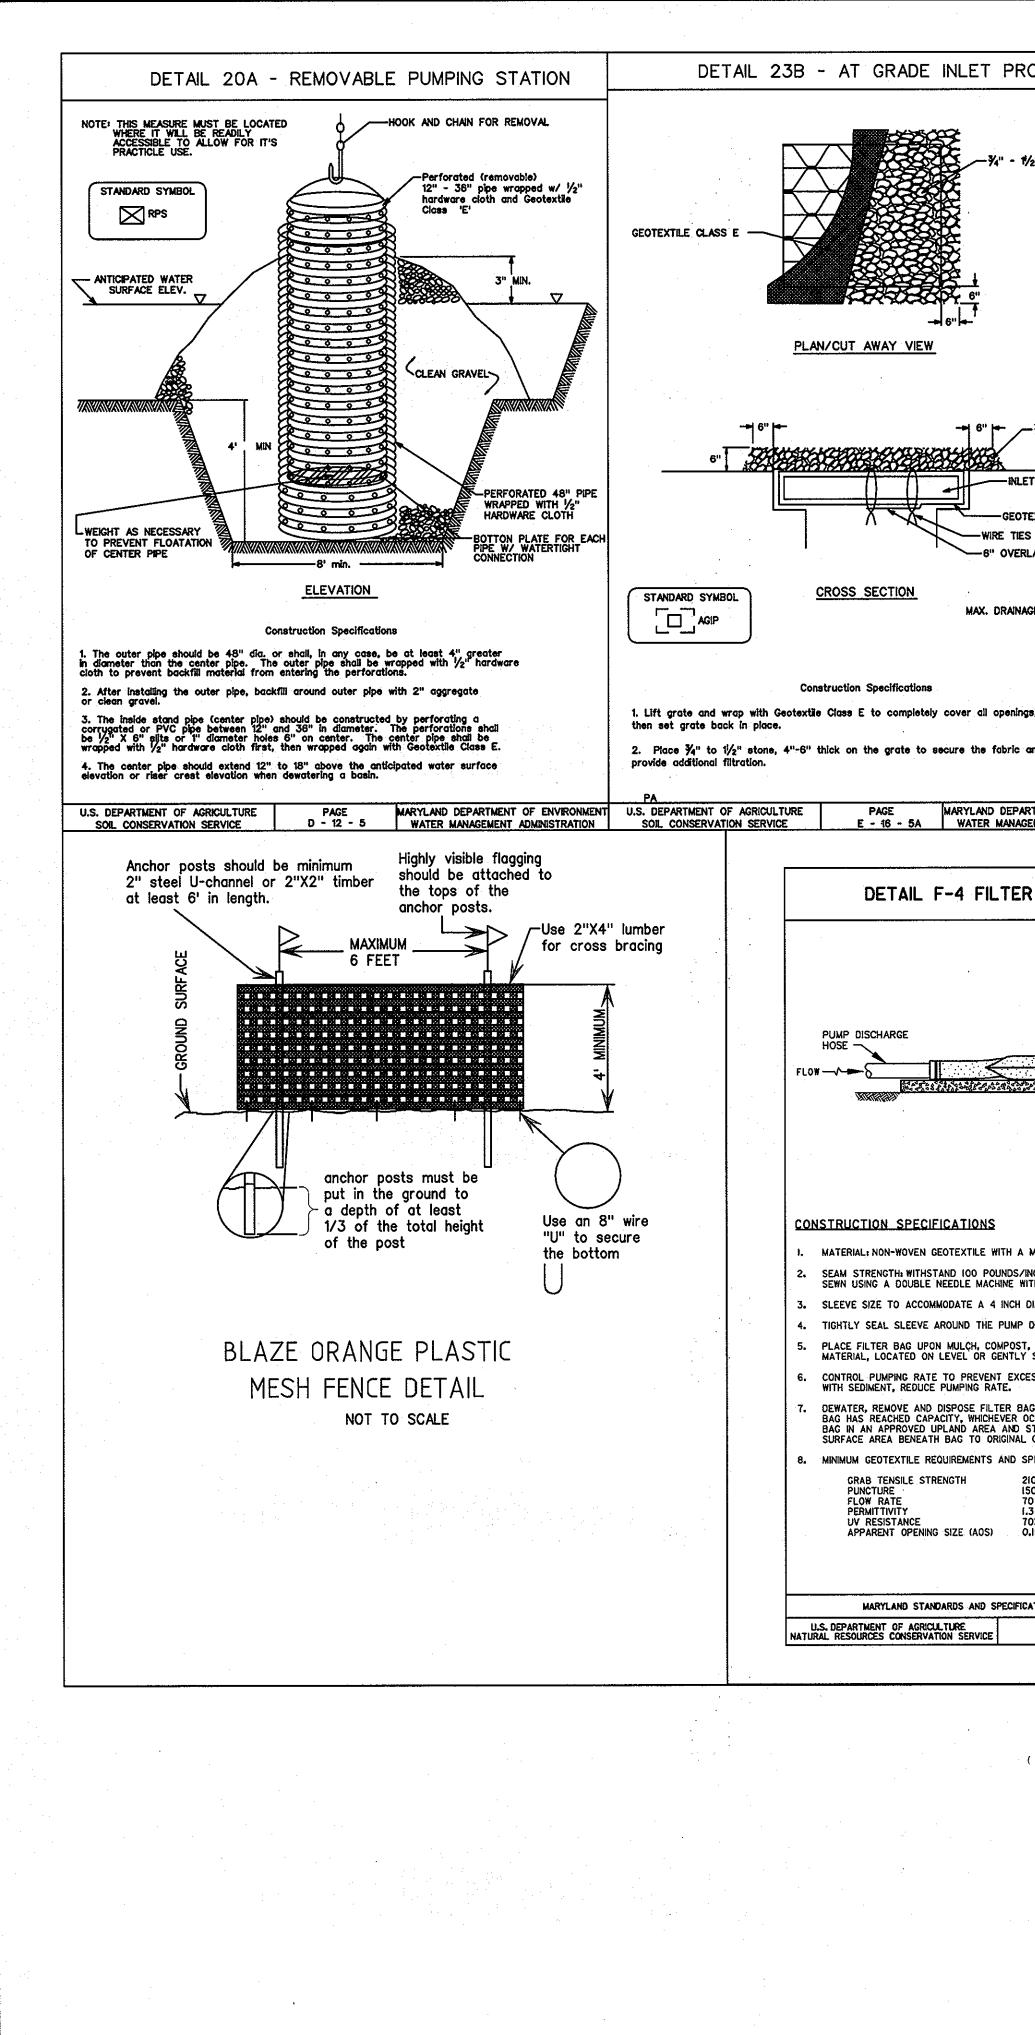
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ROTECTION	DETAIL	30 - E	ROSION C	ONTROL	MATTING	;			EROSIC	ON CONTRO	DL MATT	ING	
t½" STONE	CROSS-SECTION	B (11)		, 			n c d	arrow trench, 6 onform to the bout 4" down a	Const atting by pice 3" in depth. channel cros slope from t	ruction Specification cing the top ends a Backfill the trench is-section. Secure he trench. Spacing the channel center	s f the matting and tamp firr with a row of between stap	in a niy to staples les is 6".	
				**************************************	' OVERLAP OF TRIPS WHERE T DRE STRIP WTD GUURED. ATTAC TAPLES ON 18"	MATTING WO OR THS ARE	5 3 4 6 5 5 5 5 5 5 5 5 5 5 5 5 5 5 5 5 5 5	etween staples. 5. Before staplin hatting is smooth 5. Staples shall buter rows, and 5. Where one ra- he top strip sh- hiplap fashion. i	ng the outer th and in fir be placed 2 2 alternation of matting all overlap to Reinforce the	edges of the matt m contact with the g apart with 4 rows g rows down the ce he upper end of the s overlap with a do wred pattern on eith	ing, make sure soil. for each stri inter. begins, the er blower strip t uble row of st	the p, 2 d of y 4",	
	STAPLE OUTSIDE EDGE OF MATTING ON 2' CENTERS			×	OUTSIDE MATTING ENTERS	CENTERS	• • • • • •	ecured with 2 (	double rows	the edge of the m		) Greg	
NAGE AREA - 1/4 ACRE				6"	ES NO. 11			15			· · · · · · · · · · · · · · · · · · ·		
c and PARTMENT OF ENVIRONMENT LAGEMENT ADMINISTRATION	U.S. DEPARTMENT OF AGRICULT SOIL CONSERVATION SERVIC	TURE DE	PAGE G - 22 - 2	MARYLAND DEP WATER MAN/	PARTMENT OF E AGEMENT ADMIN	INVIRONMENT	U.S. DEPA Soil C	RTMENT OF AG ONSERVATION S	rkulture Ervice	PAGE G - 22 - 2	MARYLAN A WATER	D DEPARTMENT	OF ENVIRONA
FILTER BAG	STANDARD SYMBOL												
	SLOPE 57 MAX.										· · · · · · · · · · · · · · · · · · ·		
S/INCH USING ASTM D-4884 WITH HIGH STRENGTH THREAD H DIAMETER PUMP DISCHARGE IP DISCHARGE HOSE WITH A S IST, STRAW BALES OR OTHER LY SLOPING (5% MAXIMUM) ST XCESSIVE PRESSURE WITHIN T	HOSE. STRAP OR SIMILAR DEVICE. R LOCAL AGENCY APPROVED ABILIZED AREA. HE FILTERBAG. AS THE BAG FILLS			<b>y</b>									
COCCURS FIRST. SPREAD THE D STABILIZED BY THE END OI AL CONDITION UPON REMOVAL SPECIFICATIONS: 210 LB 150 LB 70 GAL/MIN/SF 1.3 SEC-1 70% STRENGTH AT 500 HOI 0,15-0,18 MM	ASTM D-4632 ASTM D-4833 ASTM D-4491 ASTM D-4491										•		
FICATIONS FOR SOIL EROSION A MARY F.12	IND SEDIMENT CONTROL LAND DEPARTMENT OF ENVIRONMENT ITER MANAGEMENT ADMINISTRATION DRAFT October 15, 2009												
· (					E OF MAA	hig ff							



THIS SEAL OPMENT PLAN IS APPROVED FO SEDIMENT CONTROL BY THE HOWARD SOIL	R SOIL EROSION AND CONSERVATION DISTRICT.
HOWARD SOIL CONSERVATION DISTRICT	RATE

PROFESSIONAL CERTIFICATION. I HEREBY CERTIFY THAT THESE DOCUMENTS WERE PREPARED ON APPROVED BY ME, AND THAT I AM A DULY LICENSED PROFESSIONAL ENGINEER UNDER THE LAWS OF THE STATE OF MARYLAND, LICENSE NO. 31089 EXPIRATION DATE: 11-21-12

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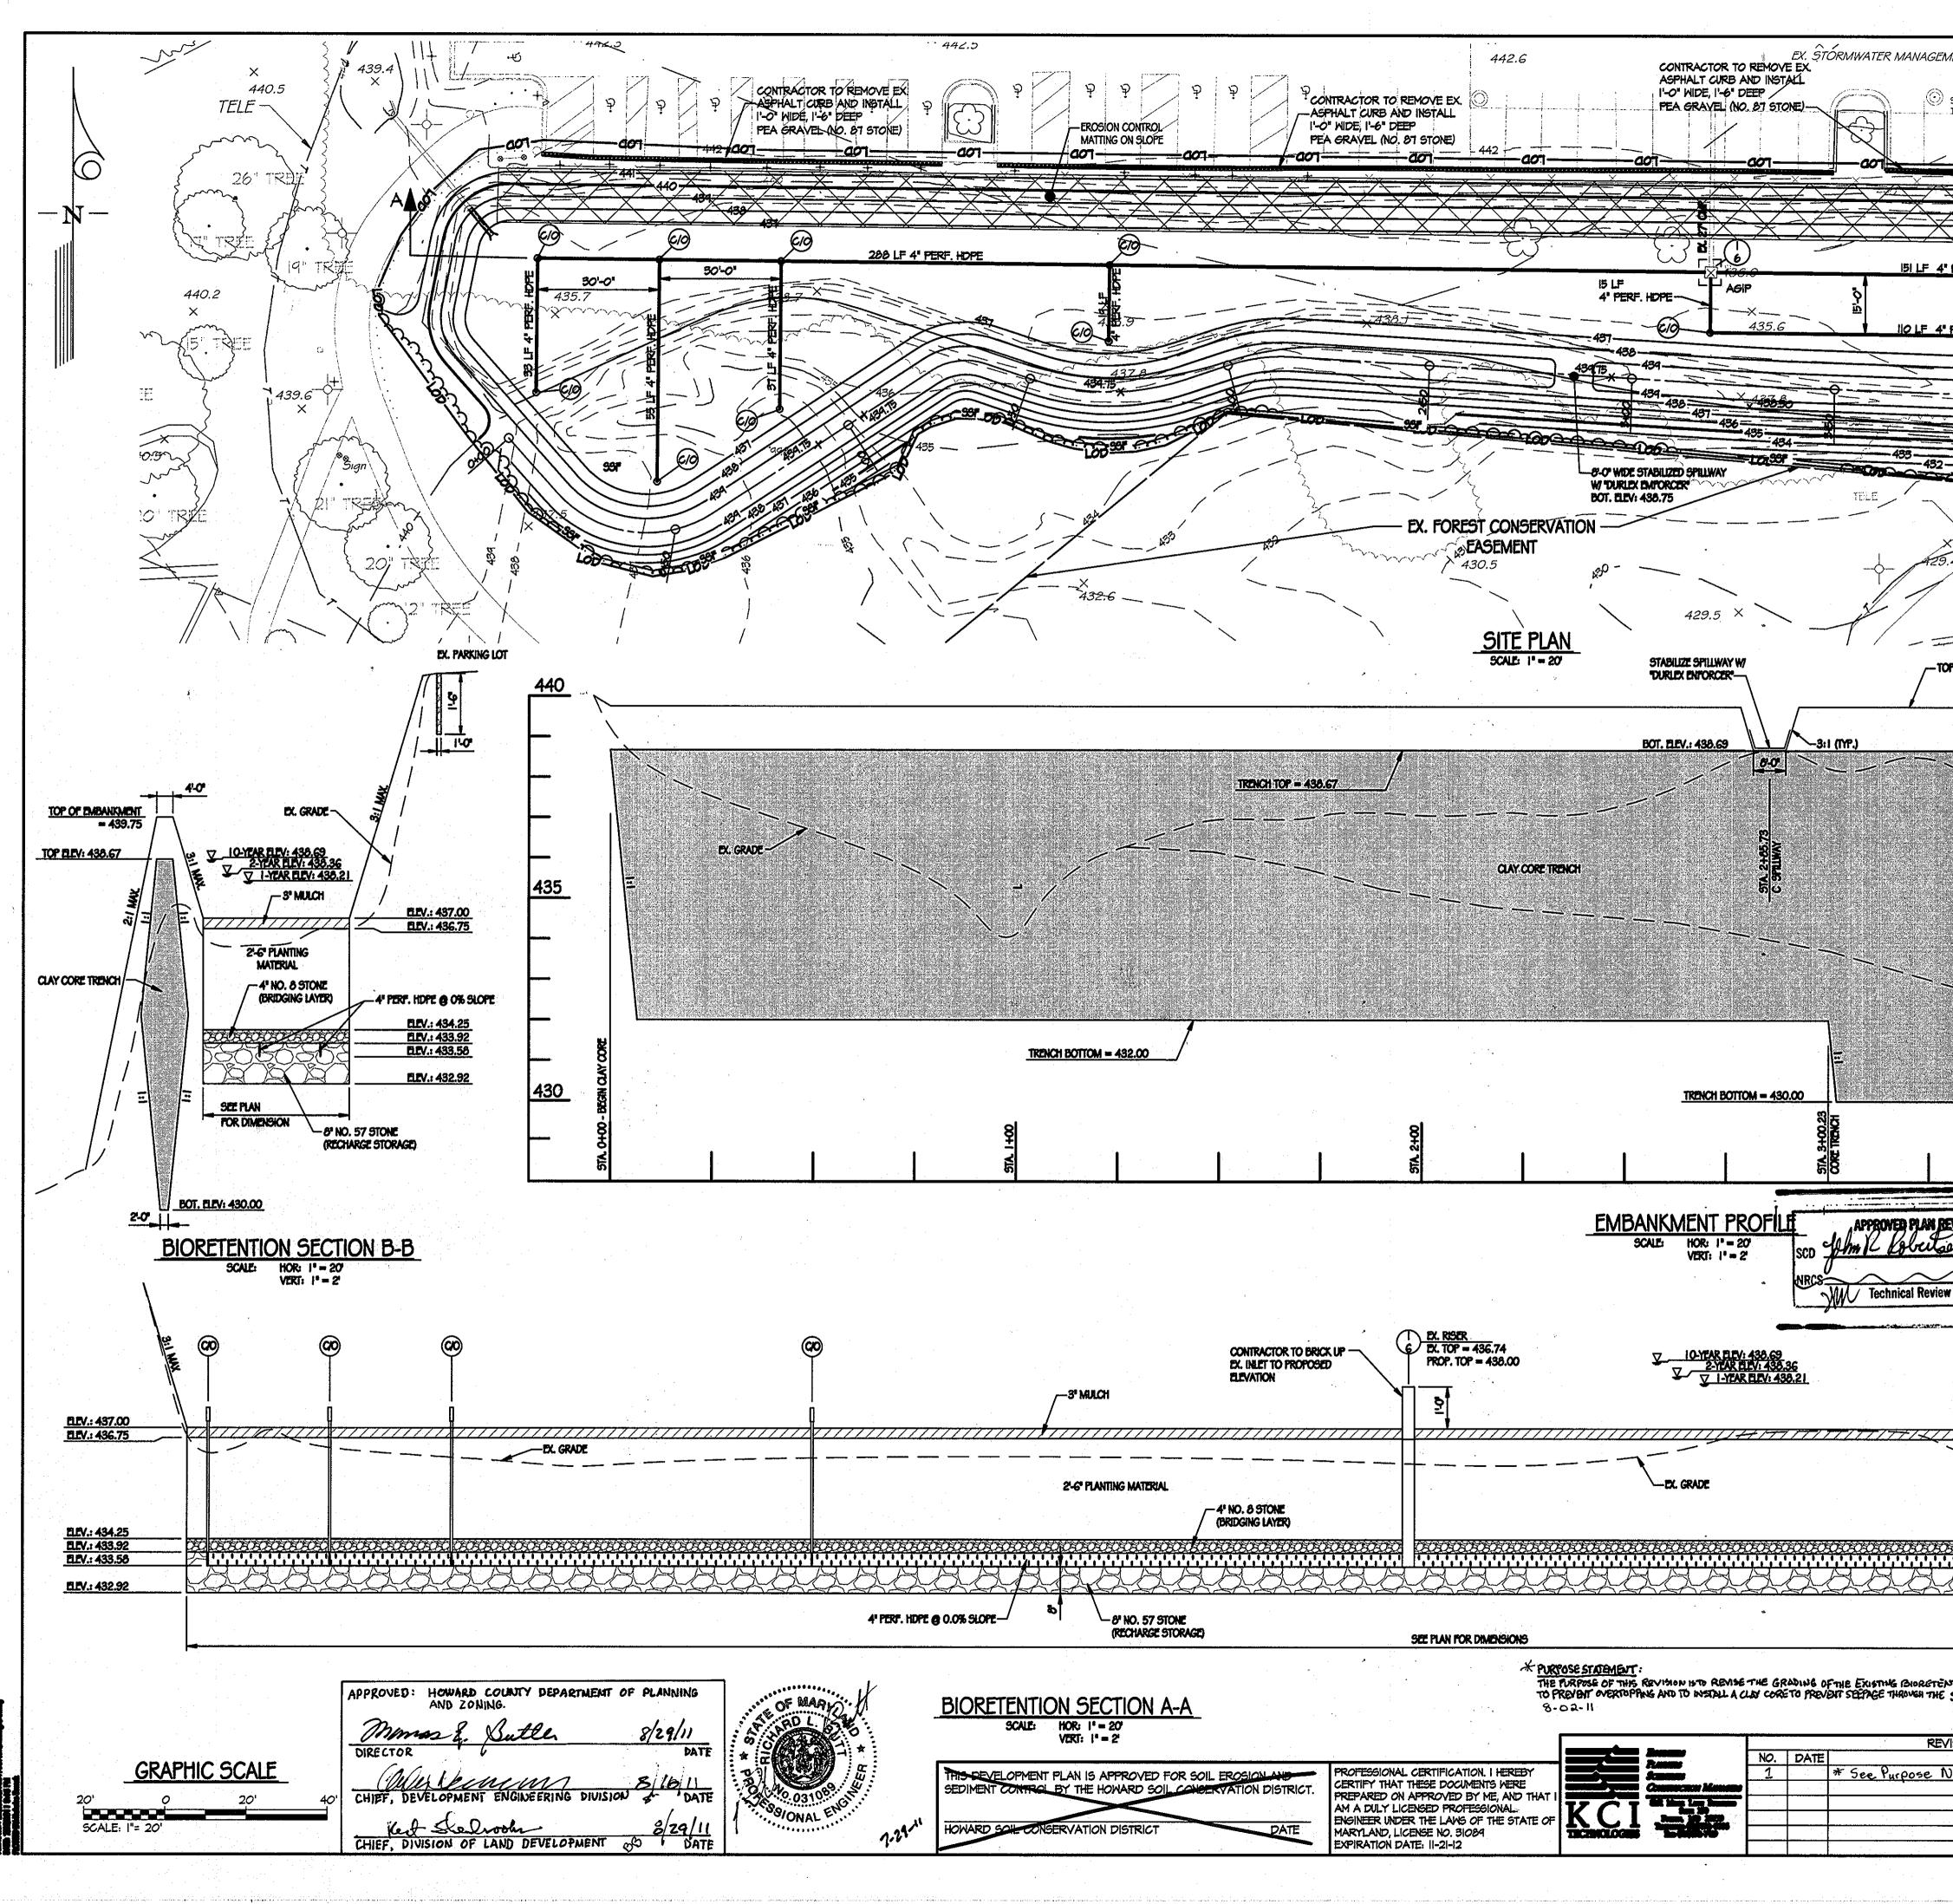
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1		* See Purpose			
	1. A.				

-36

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7	
	APPROVED : HOWARD COUNTY DEPARTMENT OF PLAUNING AND ZONING.
	momos & Suttle 8/29/11
	DIRECTOR
	CHIEF, DEVELOPMENT ENGINEERING DIVISION & DATE
	Kart Shen wohn 8/24/11
	CHIEF, DIVISION OF LAND DEVELOPMENT BB DATE APPROVED: FOR PUBLIC OR PRIVATE (pick only one) WATER
	NO PUBLIC OR PRIVATE (pick only one) SEWERAGE SYSTEM
	County Health Officer Howard County Health Department
	THESE PLANS FOR SMALL FOND CONSTRUCTION, SOIL EROSION AND
	SEDIMENT CONTROL MEET THE REQUIREMENTS OF THE HOWARD COUNTY CONSERVATION DISTRICT.
	HOWARD S.C.D. DATE
	By the engineer:
APPROVED PLAN REVISION	"I CERTIFY THAT THIS PLAN FOR EROSION AND SEDIMENT CONTROL REPRESENTS A PRACTICAL AND WORKABLE PLAN BASED ON MY
SCD JAM TO AJOURAN N JUL	PERSONAL KNOWLEDGE OF THE SITE CONDITIONS, AND THAT IT WAS PREPARED IN ACCORDANCE WITH THE REQUIREMENTS OF THE
NRC Technical Review Date	HOWARD COUNTY SOIL CONSERVATION DISTRICT."
	SIGNATURE OF ENGINEER DATE
owner: Howard Community College	BY THE DEVELOPER: "I/WE CERTIFY THAT ALL DEVELOPMENT AND CONSTRUCTION WILL BE
owner: Howard Community College 1091 Little Patuxent Parkway Columbia, MD 21044	DONE ACCORDING TO THIS PLAN FOR SEDIMENT AND EROSION CONTROL, AND THAT ALL RESPONSIBLE PERSONNEL INVOLVED IN
	THE CONSTRUCTION PROJECT WILL HAVE A CERTIFICATE OF ATTENDANCE AT A DEPARTMENT OF THE ENVIRONMENT APPROVED
	TRAINING PROGRAM FOR THE CONTROL OF SEDIMENT AND EROSION BEFORE BEGINNING THE PROJECT. I ALSO AUTHORIZE PERIODIC ON-SITE INSPECTION BY THE HOWARD COUNTY SOIL CONSERVATION
APPROVED	TY DISTRICT
PLANNING BOARD OF HOWARD COUN	
PLANNING BOARD OF HOWARD COUN DATE	SIGNATURE OF DEVELOPER DATE
PLANNING BOARD OF HOWARD COUN DATE DATE O5-18-2011 HOWAAPD	DRAWING NO.
PLANNING BOARD OF HOWARD COUN DATE DATE DATE O5-18-2011 HOWARD	COUNTY COMMUNITY COLLEGE
DATE DATE	DRAWING NO.



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EX. (RADE (2011))	<u>= 435</u>
BIORETENTION (2002)	
	51A 5+12.72- 51A 5+12.72- 5065 TRENCH
APPROVED: FOR PUBLIC OR PRIVATE (pick of the second of the	Date TION, SOIL EROSION AND
CO TOP ELEV: 438.67 HOWARD S.C.D. BY THE ENGINEER: 'I CERTIFY THAT THIS PLAN FOR EROSION REPRESENTS A PRACTICAL AND WORKABL PERSONAL KNOWLEDGE OF THE SITE COND	E PLAN BASED ON MY
CLAY CORE TRENCH CLAY CORE TRENCH CLAY CORE TRENCH CLAY CORE TRENCH CLAY CORE TRENCH CLAY CORE TRENCH CLAY CORE TRENCH COLORATION DIS COLORATION DIS	WIREMENTS OF THE
The certify that all development and done according to this plan for sed control, and that all responsible per the construction project will have a attendance at a department of the e training program for the control of before beginning the project. I also on-site inspection by the howard county district.	MENT AND EROSION RESONNEL INVOLVED IN CERTIFICATE OF INVIRONMENT APPROVED F SEDIMENT AND EROSION AUTHORIZE PERIODIC NTY SOIL CONSERVATION
BOT. FLEV: 430.00 2-0 	8-2-2011 DATE DRAWING NO. 16: M
DES BY NAB DES BY NAB DRN BY NTN NTN REVISED SITE DEVELOPMENT PLAN BIORETENTION SITE PLAN AND PROFILES SI	SHEET IG OF W7 KCI PROJECT NUMBER OIOBITI95.46R