


SHEET INDEX

SHEET No.	TITLE
1	SITE DEVELOPMENT PLAN
2	SEDIMENT CONTROL PLAN
3	SEDIMENT CONTROL NOTES & DETAILS


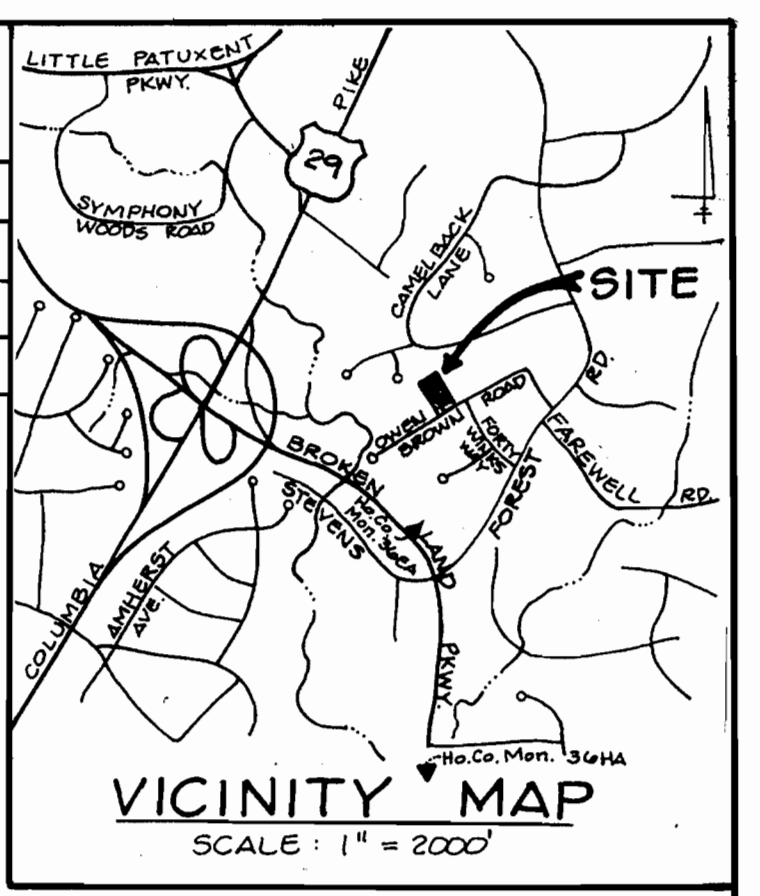


LEGEND:

- 382 --- EXISTING GROUND
- 382 --- PROPOSED GRADE
- (+ in circle) EXISTING TREES TO BE REMOVED ON LOT 1 ONLY
- (+ in circle) EXISTING TREES TO REMAIN
- x-x-x- EXISTING FENCE
- PROPOSED DRYWELL
- DRAINAGE DIRECTION

FLOOR PLAN NOTES:

- Dimensions shown reflect normal foundation plan (No brick).
- Unless otherwise noted, all bumpouts, bay windows etc. reflect first floor projections.
- The location of minor structures and minor architectural features including cornices, eaves, cantilevered building features, bay windows and window wells, oriel, vestibules, balconies, chimneys, heating or air conditioning units and exterior stairways and ramps (above or below grade) and open or enclosed porches are subject to Section 128.A.1 Supplementary Zoning District Regulations of the Howard County Zoning Regulations.

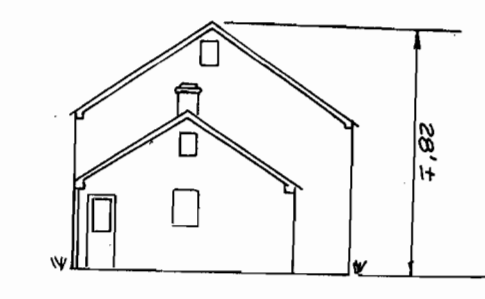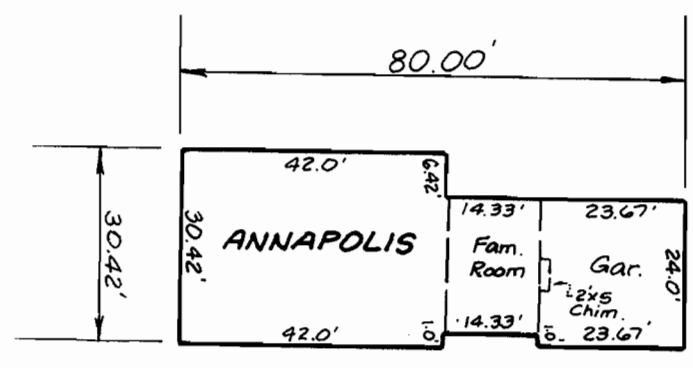

TYPICAL HOUSE PLAN AND PROFILE



SCHEDULE A PERIMETER LANDSCAPE EDGE

Category	Adjacent to Roadways	Adjacent to Perimeter Properties
Landscape Type	B	A
Linear Feet of Roadway Frontage/Perimeter	89 LF	199 LF
Credit for Existing Vegetation (Yes, No, Linear Feet) (Describe below if needed)	Yes 89 LF (1)	Yes 199 LF (2)
Credit for Wall, Fence or Berm (Yes, No, Linear Feet) (Describe below if needed)	No	No
Number of Plants Provided		
Shade Trees	2	3
Evergreen Trees	2	1
Other Trees (2:1 substitution)	2	1
Shrubs (10:1 substitution) (Describe plant substitution credits below if needed)	3	4

Comments (1) Credit for 3 Ex. Shade Trees (Twin 24" Locust and Ex. 21" Locust) Credit for 2 Evergreens (Twin 14" Cedar) (2) Credit for 4 Ex. Shade Trees.

Note: Complex projects may require expansion of the schedule to accommodate multiple land uses on-site or on adjacent properties.

1. This plan has been prepared in accordance with provisions of Section 16.124 of the Howard County Code and the Landscape Manual.

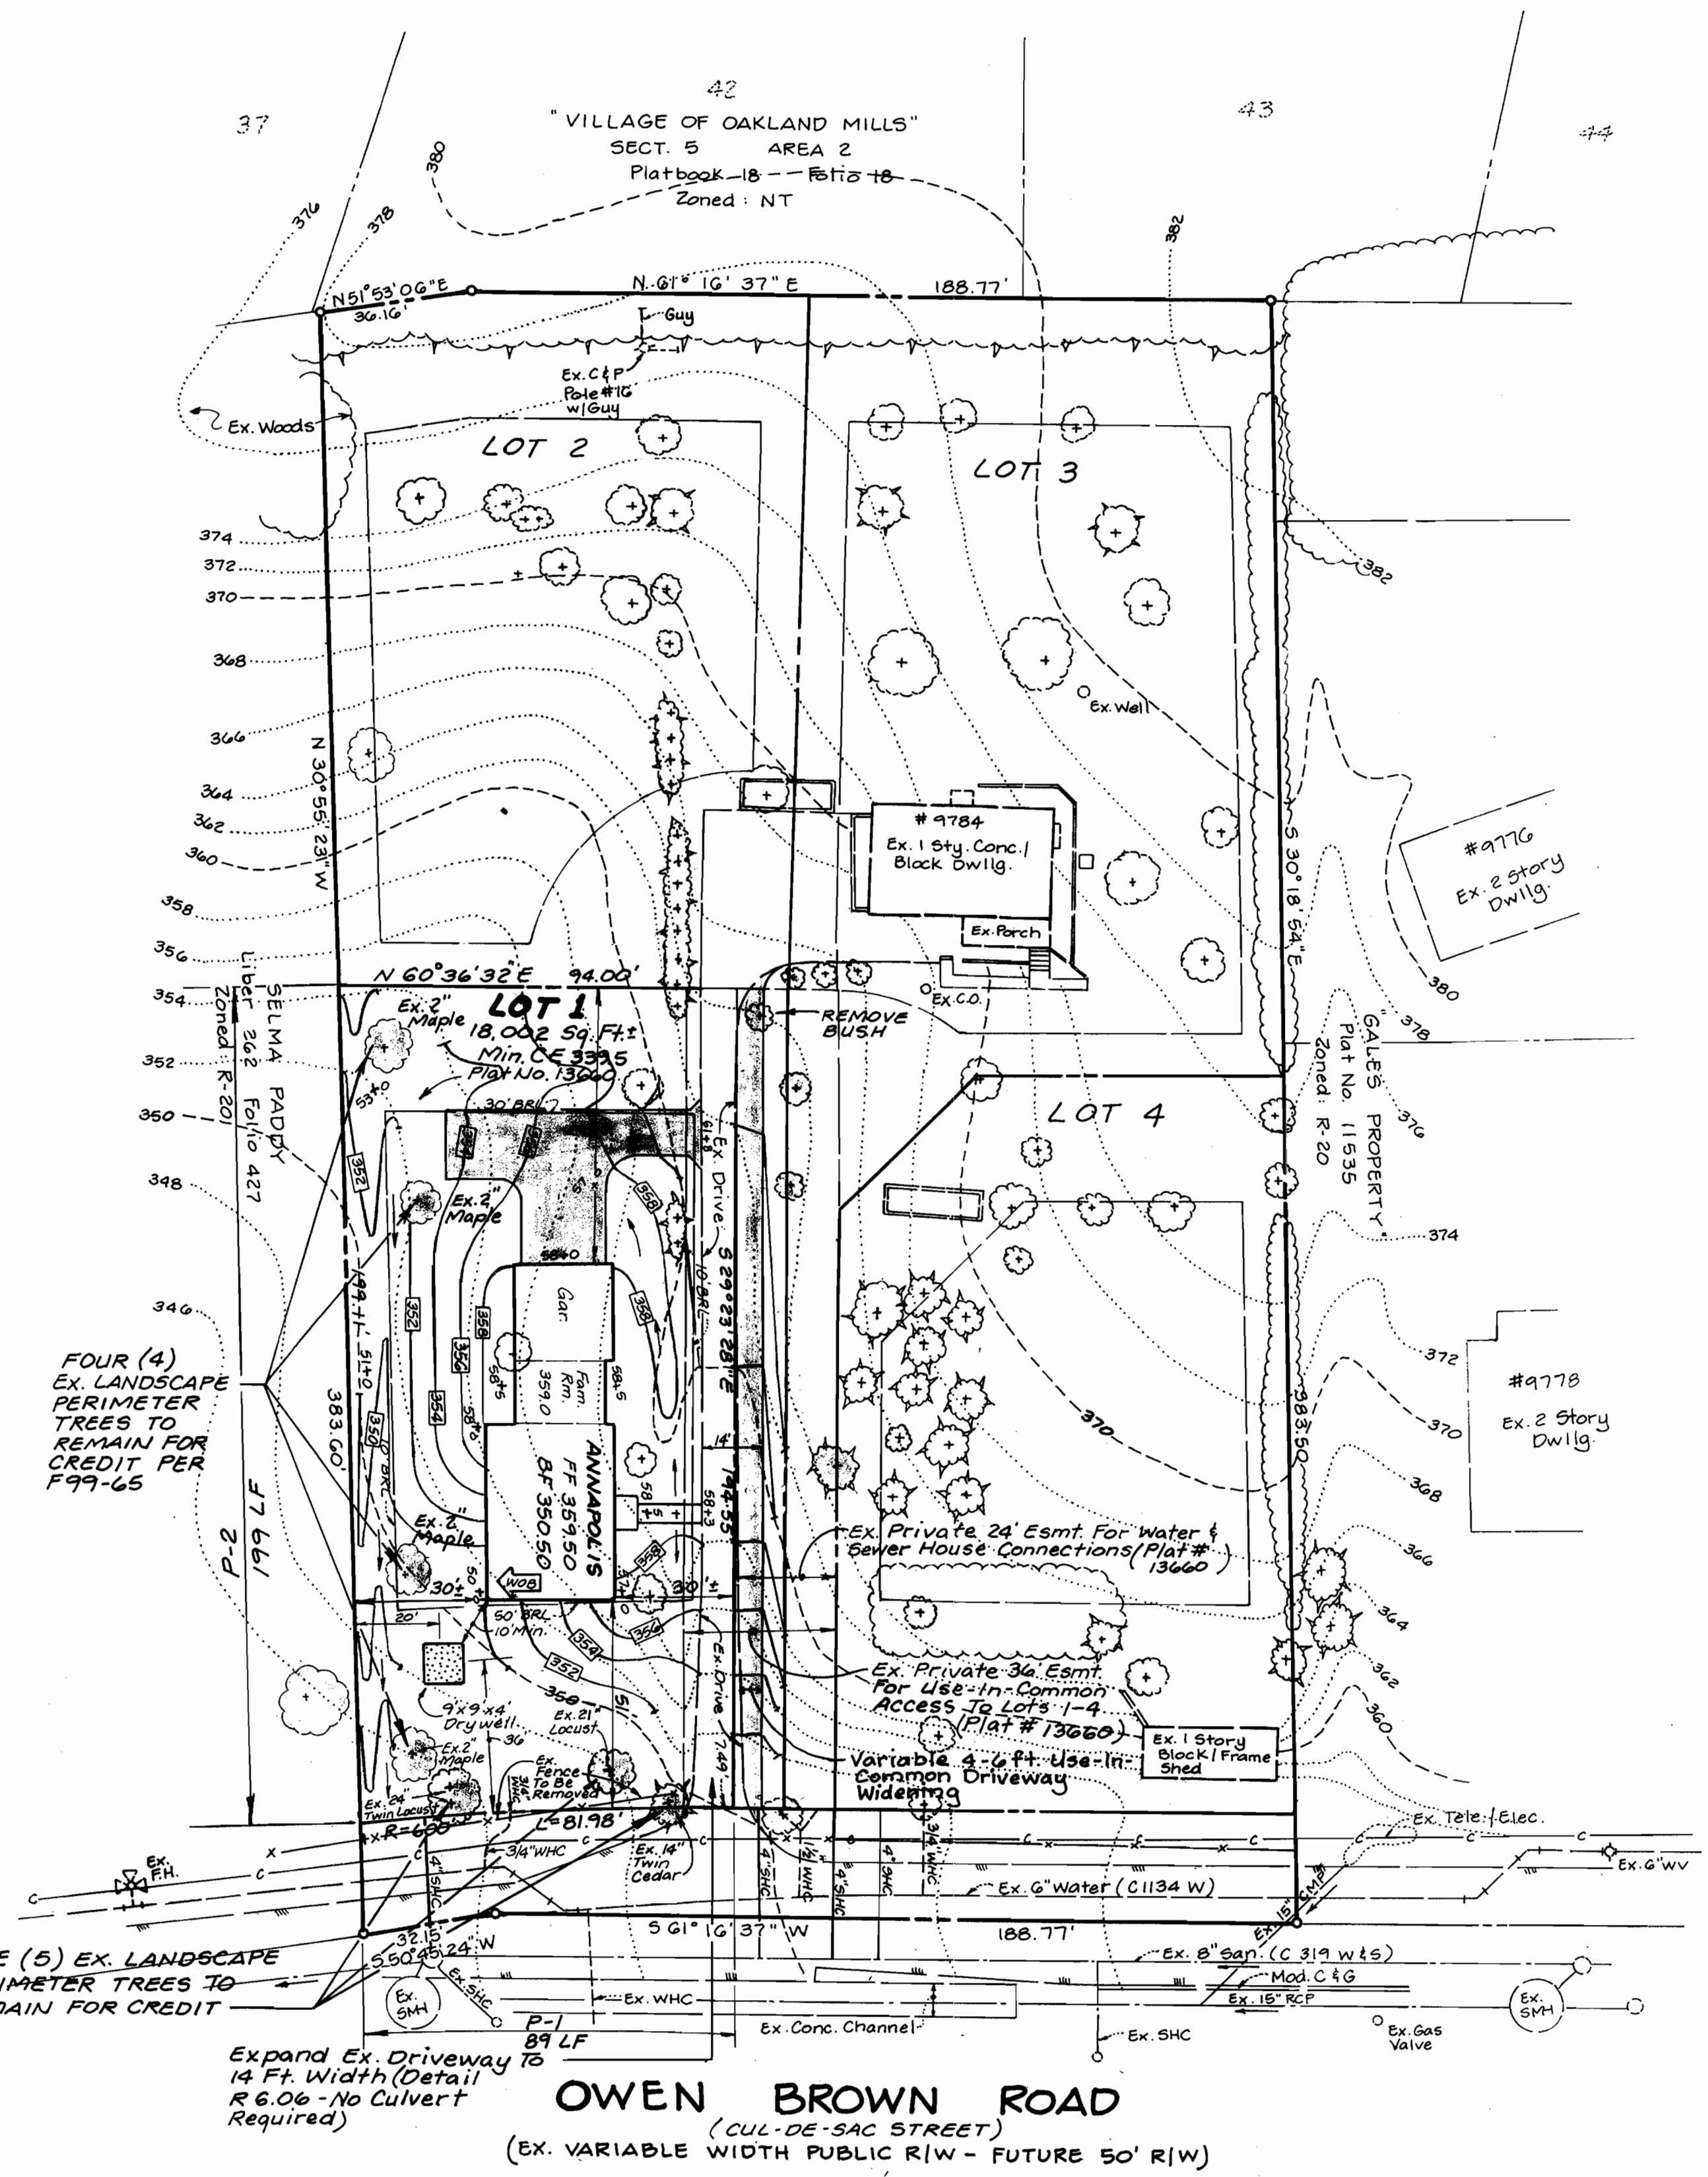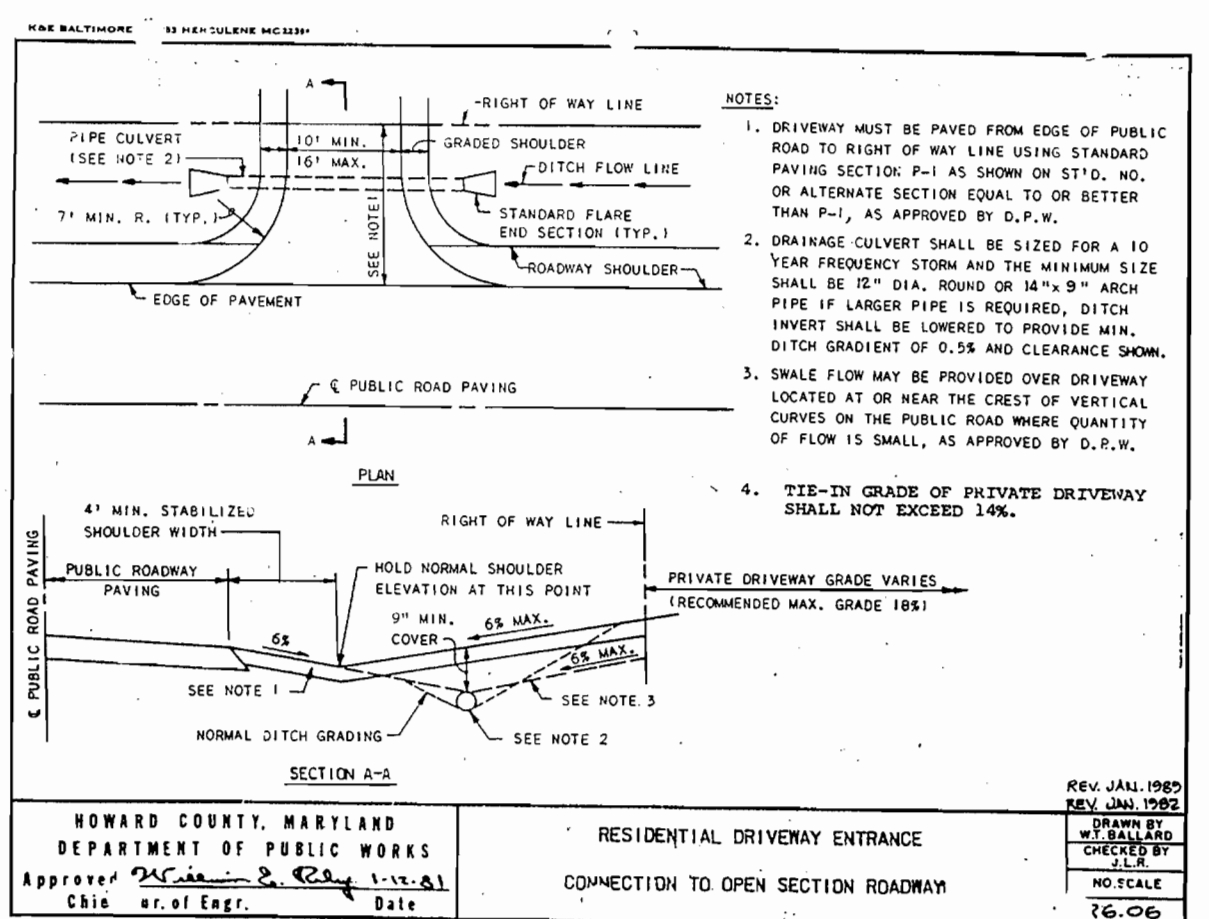

FOUR (4) EX. LANDSCAPE PERIMETER TREES TO REMAIN FOR CREDIT PER F99-65

FIVE (5) EX. LANDSCAPE PERIMETER TREES TO REMAIN FOR CREDIT

Expand Ex. Driveway to 14 Ft. Width (Detail R 6.06 - No Culvert Required)

OWEN BROWN ROAD (CUL-DE-SAC STREET) (EX. VARIABLE WIDTH PUBLIC R/W - FUTURE 50' R/W)



ENGINEER'S CERTIFICATE

"I HEREBY CERTIFY THAT THIS PLAN FOR PERIMETER CONTROL REPRESENTS A PRACTICAL AND WORKABLE DESIGN BASED ON MY PERSONAL KNOWLEDGE OF THE SITE CONDITIONS AND THAT IT WAS PREPARED IN ACCORDANCE WITH REQUIREMENTS OF THE HOWARD COUNTY ZONING DISTRICT."

Signature: *David A. Hampton* 10/28/99  
Professional Engineer

THESE PLANS HAVE BEEN REVIEWED FOR THE HOWARD SOIL CONSERVATION DISTRICT AND MEET THE TECHNICAL REQUIREMENTS.

Signature: *Clay Simmons* 10/15/99  
Natural Resource Conservation

APPROVED: DEPARTMENT OF PLANNING & ZONING

Signature: *David A. Hampton* 10/22/99  
Chief, Development Engineering Division

DEVELOPER'S CERTIFICATE

"I/WE CERTIFY THAT ALL DEVELOPMENT AND/OR CONSTRUCTION WILL BE DONE ACCORDING TO THESE PLANS AND THAT ANY RESPONSIBLE PERSONNEL INVOLVED IN THE CONSTRUCTION PROJECT WILL HAVE A CERTIFICATE OF ATTENDANCE AT A DEPARTMENT OF THE ENVIRONMENT APPROVED TRAINING PROGRAM FOR THE CONTROL OF EROSION AND SEDIMENT BEFORE BEGINNING THE PROJECT. I ALSO AUTHORIZE PERIODIC ON-SITE INSPECTION BY THE HOWARD SOIL CONSERVATION DISTRICT OR THEIR AUTHORIZED AGENTS, AS ARE DEEMED NECESSARY."

Signature: *Hal C. Markon* 10/14/99  
Developer

THIS DEVELOPMENT PLAN IS APPROVED FOR SOIL EROSION AND SEDIMENT CONTROL BY THE HOWARD SOIL CONSERVATION DISTRICT.

Signature: *John R. Robinson* 10/15/99  
Howard Soil Conservation District

Signature: *Andi Hamulla* 10/25/99  
Chief, Division of Land Development

Signature: *John R. Robinson* 10/26/99  
Director

No.	DATE	DESCRIPTION
1		9788 OWEN BROWN ROAD
ADDRESS CHART		

PROPERTY OF: WESS HAVEN	SECTION / AREA	LOT No. / PARCEL
PLAT REF 13660	BLOCK No. 9 ZONE R-20 TAX / ZONE 36 EL. DIST. 6th	1 P/0 36
WATER CODE: E09	SEWER CODE: 5480000	





**LDE, INC.**  
9250 Rumsey Road, Suite 106, Columbia, MD. 21045  
(410) 715-1070 (301) 596-3424 (410) 715-9540 (Fax)

DESIGNED: B.D.B.	SITE DEVELOPMENT PLAN <b>WESS HAVEN</b> Lot 1	SCALE: 1" = 30'
DRAWN: K.B.W.		DRAWING: 1 OF 3
CHECKED: B.D.B.	TAX MAP No. 36 BLOCK 9 PARCEL No. 36 6th ELECTION DISTRICT HOWARD COUNTY, MARYLAND	JOB No. 99-033
DATE: 8/99	Owner: <b>JAMES P. HANSON</b> 9843 Rainier Court Columbia, MD. 21046 (301) 776-0118	Builder: <b>HAL C. MARKER CO., INC</b> 10524 Hunters Way Laurel, Maryland 20723 (301) 776-8228

FILE No. SDP00-23

**LEGEND**

- ..... LIMIT OF DISTURBANCE
- SF — SF SILT FENCE
- SSF — SSF SUPER SILT FENCE
- [SCE] STABILIZED CONSTRUCTION ENTRANCE
- ..... PERMANENT SWALE WITH EROSION CONTROL MATTING
- SSFD — SUPER SILT FENCE DIVERSION
- TPF — TREE PROTECTION FENCE

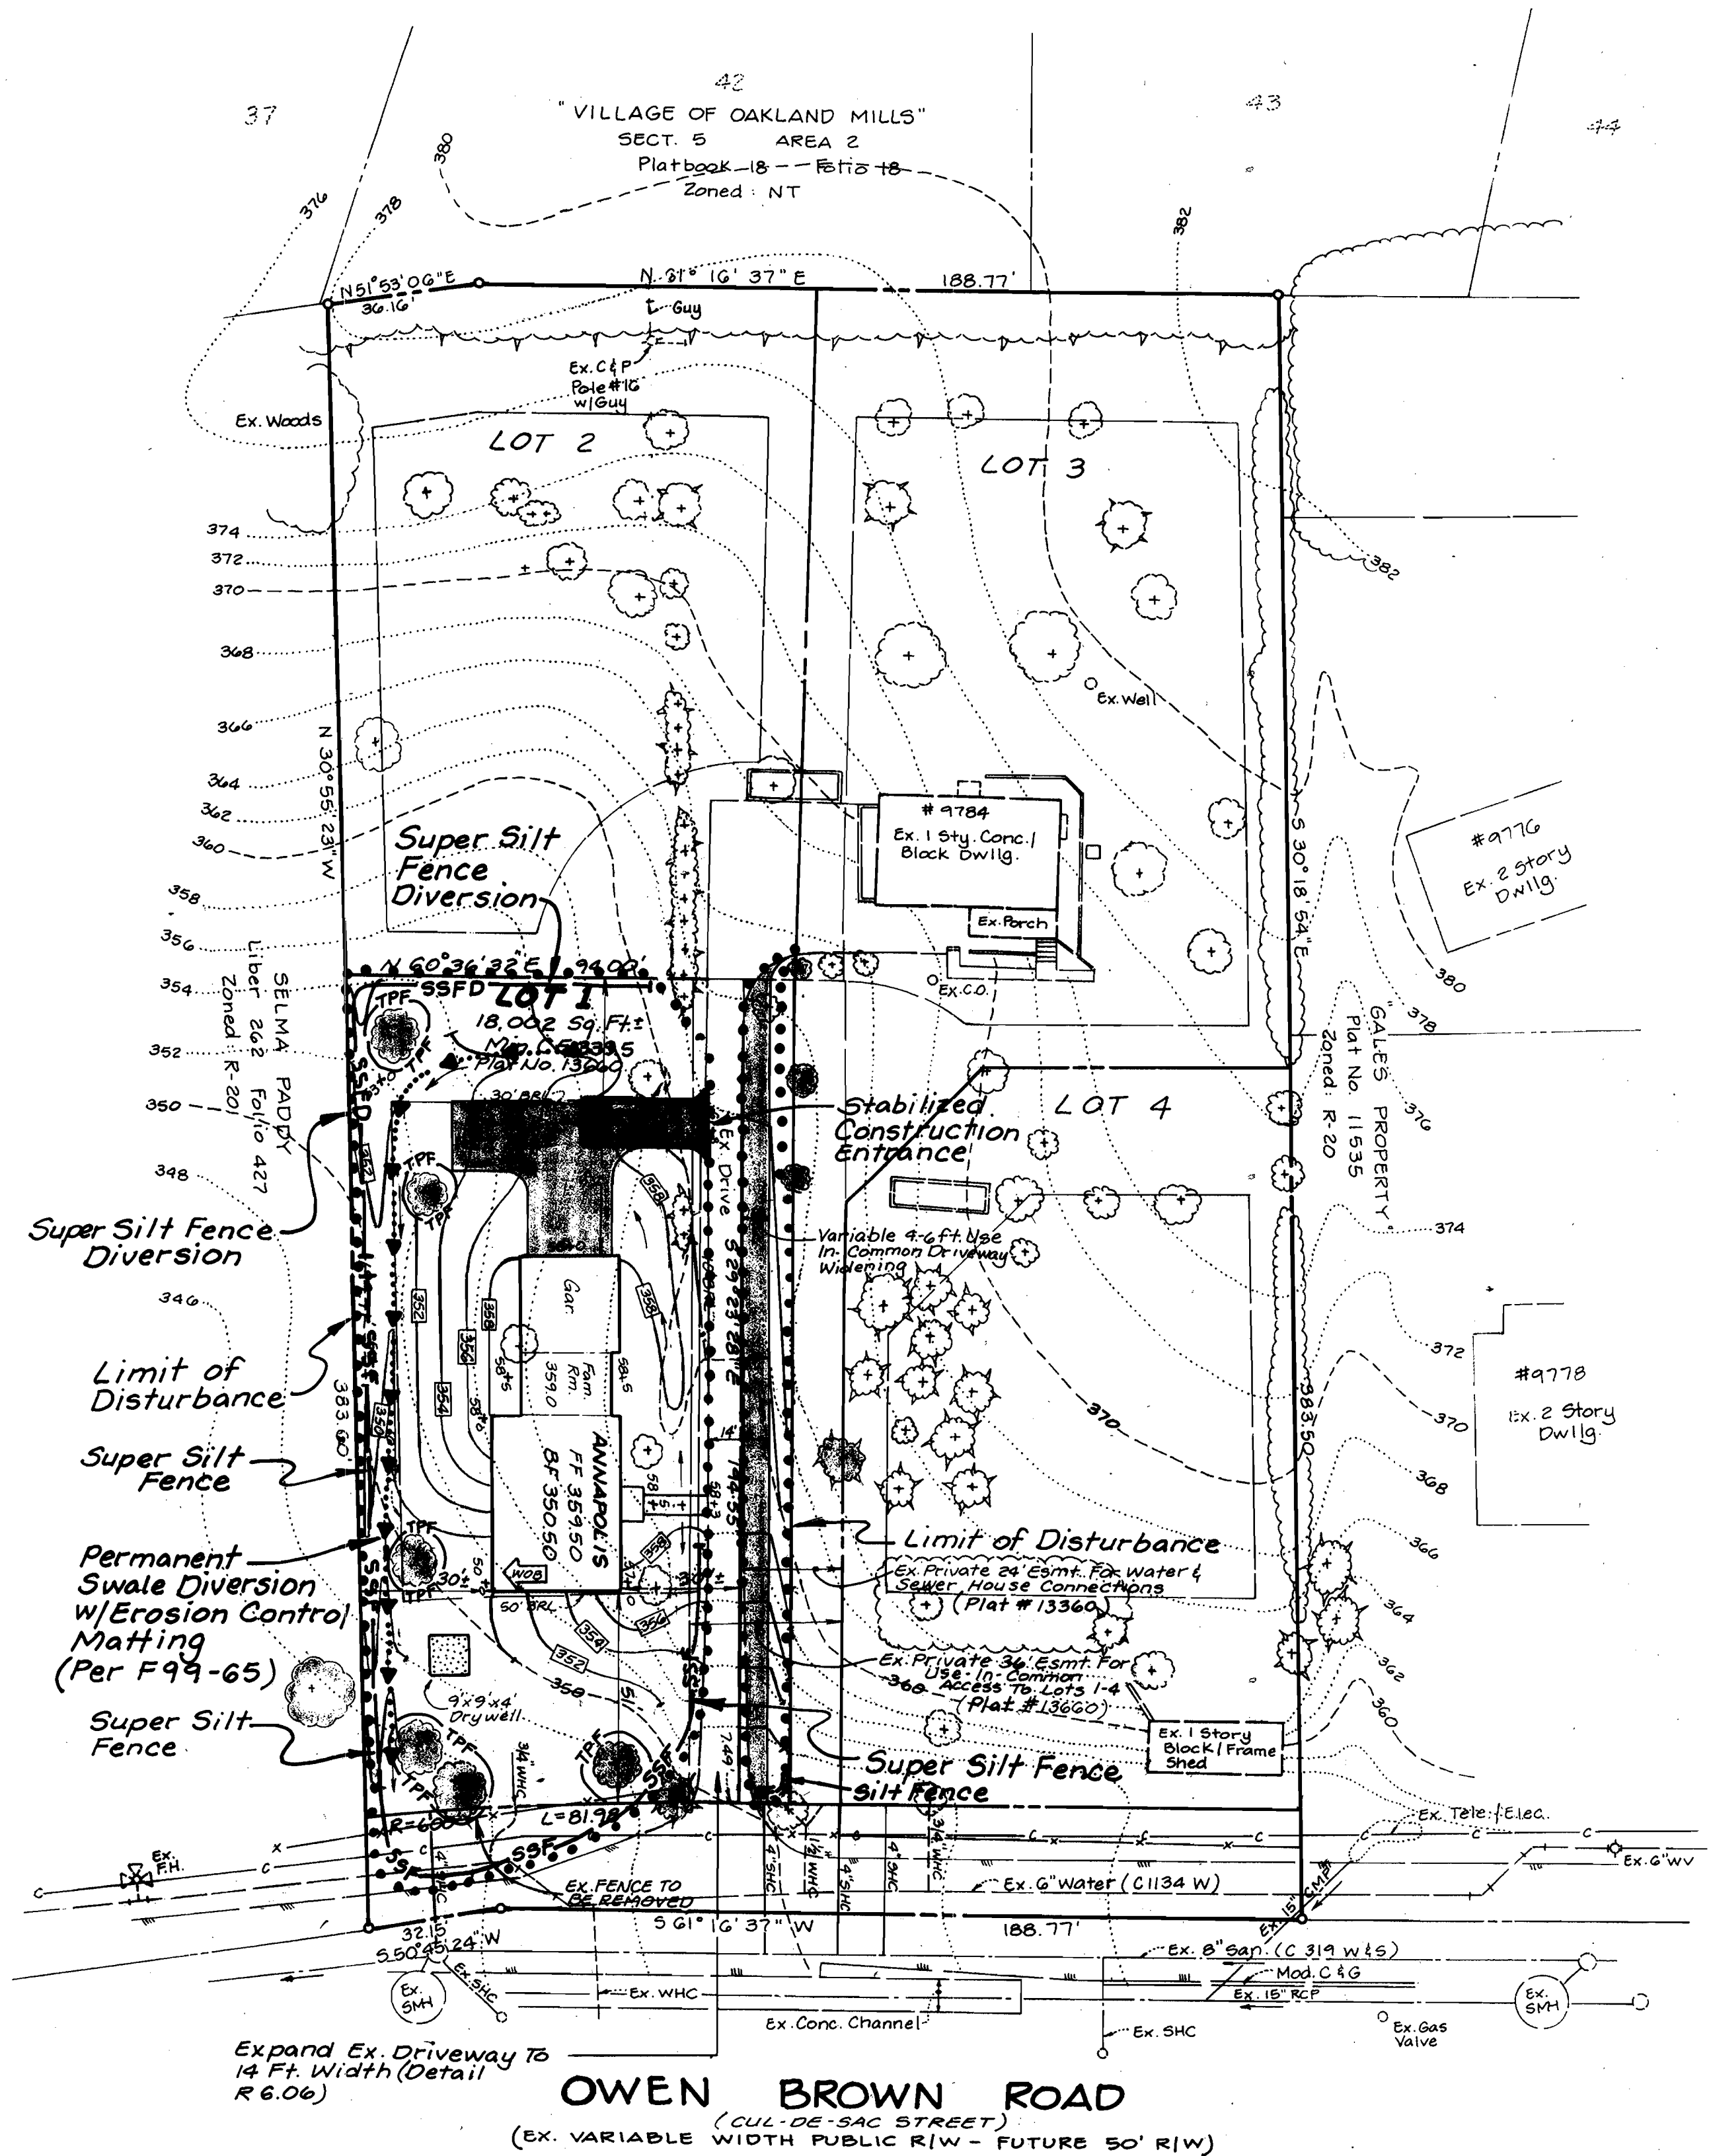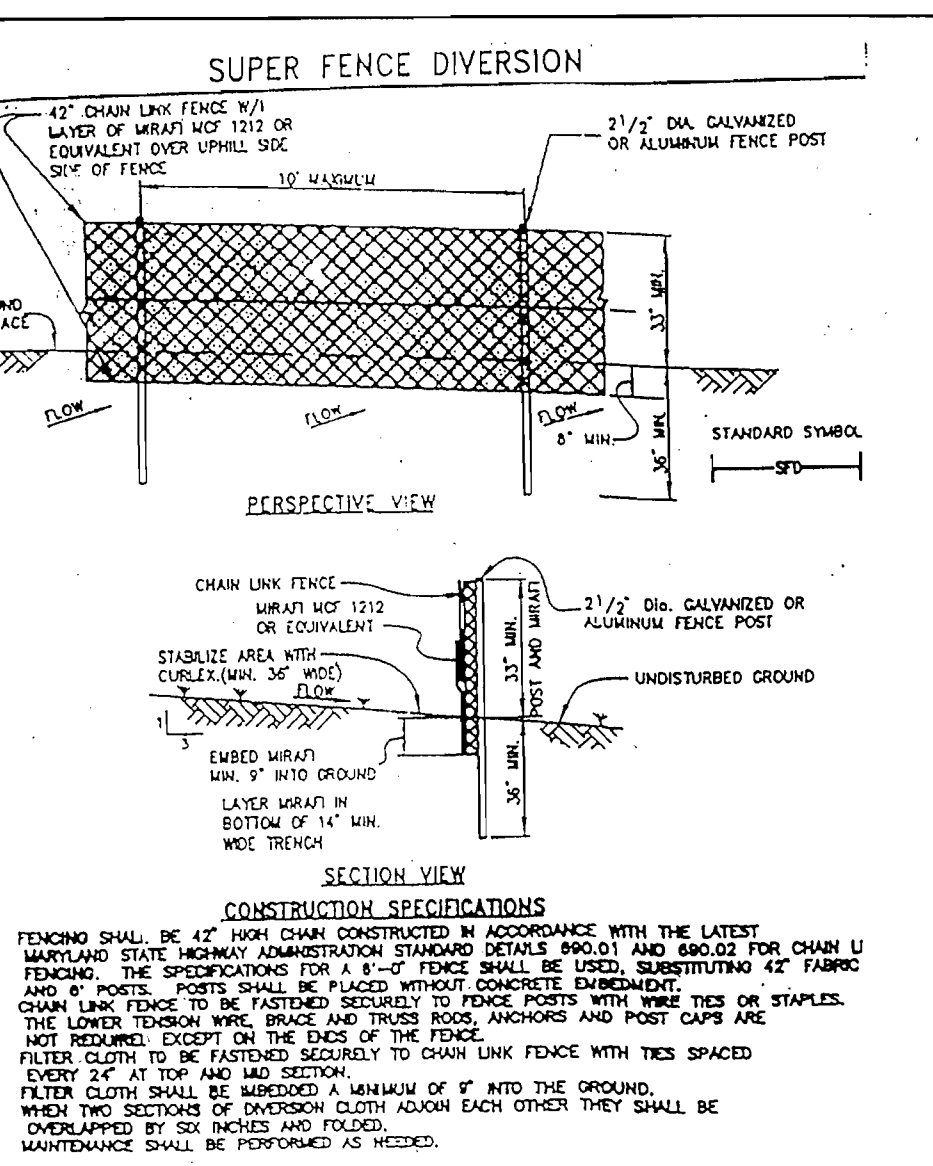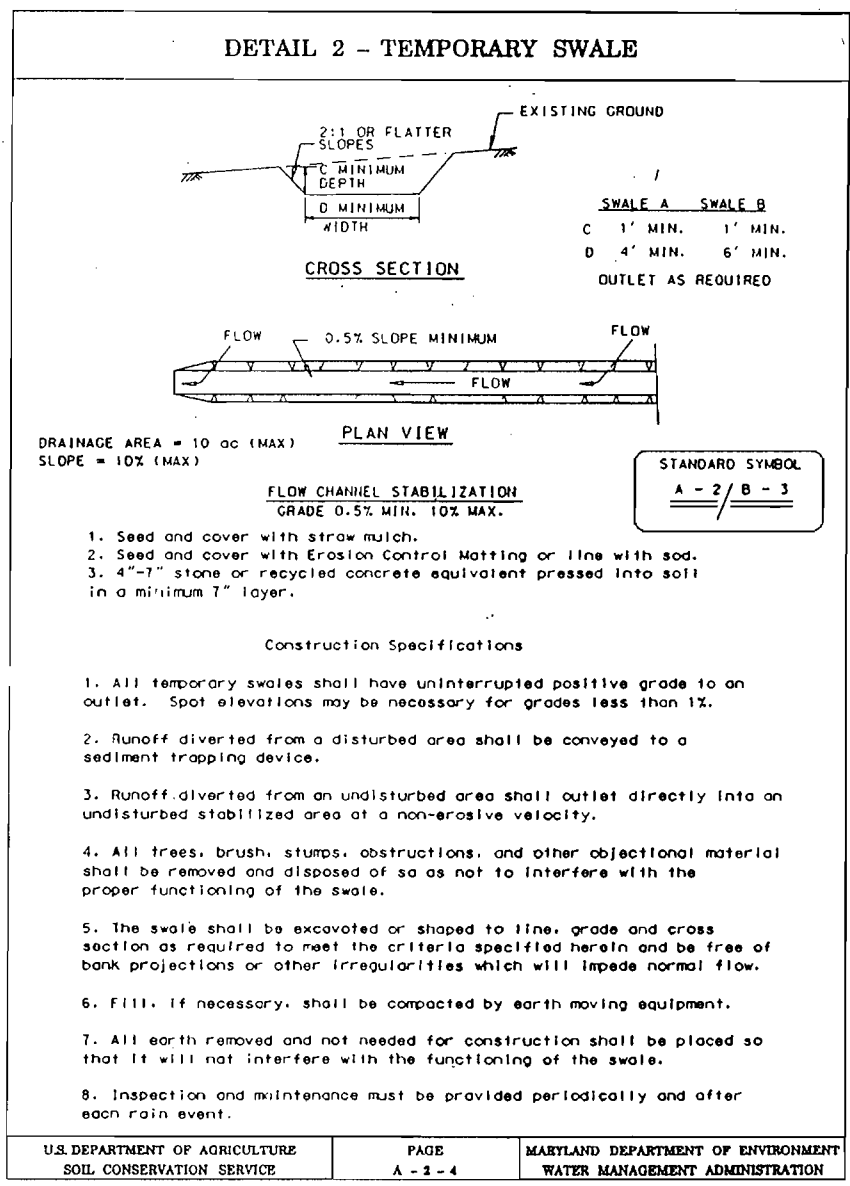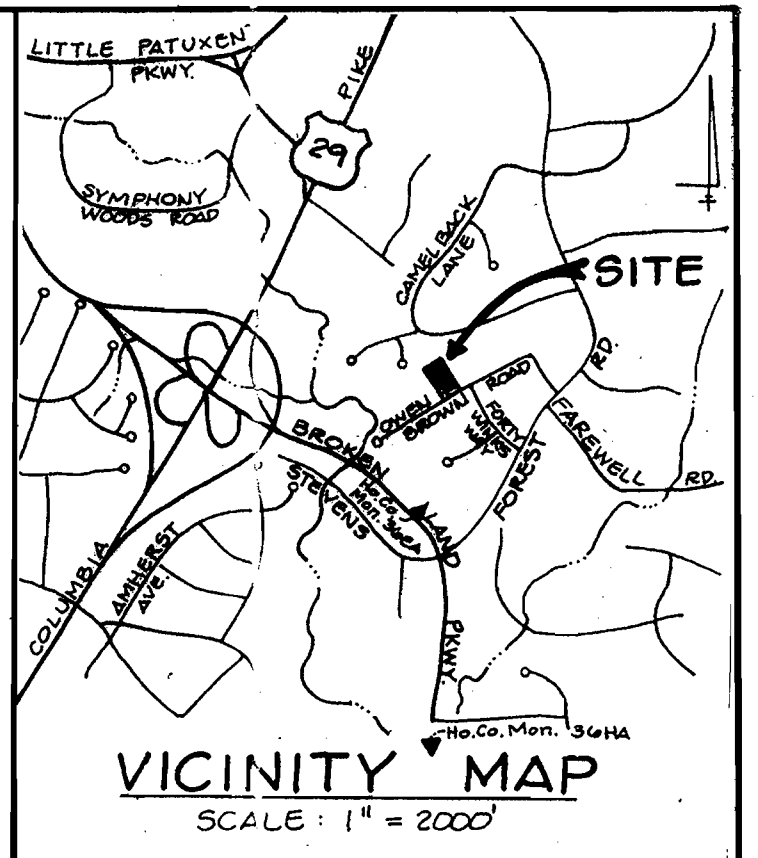

**CONSTRUCTION SEQUENCE**

1. OBTAIN GRADING PERMIT. (1 DAY)
  2. CONSTRUCT STABILIZED CONSTRUCTION ENTRANCE. INSTALL SUPER SILT FENCE DIVERSION ALONG NORTH AND WEST PROPERTY LINE (2 DAYS)
  3. INSTALL SUPER SILT FENCE AND TREE PROTECTION FENCE AS SHOWN (2 DAYS)
  4. CONSTRUCT PERMANENT SWALE ALONG NORTH AND WEST PROPERTY LINES. INSTALL EROSION CONTROL MATTING (2 DAYS)
  5. CLEAR AND GRUB SITE TO SUBGRADE (2 DAYS)
  6. BEGIN EXCAVATION FOR HOUSE FOUNDATION AND BEGIN HOUSE CONSTRUCTION (60 DAYS)
  7. THE CONTRACTOR SHALL INSPECT AND PROVIDE NECESSARY MAINTENANCE ON THE SEDIMENT CONTROL DEVICES SHOWN ON THIS PLAN AFTER EACH RAINFALL AND ON A DAILY BASIS. (DAILY)
  8. REMOVE SEDIMENT FROM OWEN BROWN ROAD, THE PRIVATE USE-IN-COMMON DRIVEWAY AND DRESS STABILIZED CONSTRUCTION ENTRANCES AS REQUIRED (DAILY)
  9. FINE GRADE ALL DISTURBED AREAS AND STABILIZE. INSTALL DRYWELL (1 DAY)
  10. AFTER PERMISSION HAS BEEN GIVEN BY THE SEDIMENT CONTROL INSPECTOR, REMOVE SEDIMENT CONTROL DEVICES. GRADE AND STABILIZE ALL REMAINING DISTURBED AREAS. (1 DAY)
- TOTAL TIME : 70 DAYS

**ENGINEER'S CERTIFICATE**  
 I HEREBY CERTIFY THAT THIS PLAN FOR EROSION AND SEDIMENT CONTROL REPRESENTS A PRACTICAL AND WORKABLE DESIGN AND THAT MY PERSONAL KNOWLEDGE OF THE SITE CONDITIONS AND MY OWN PROFESSIONAL EXPERIENCE IN ACCORDANCE WITH REQUIREMENTS OF THE BOARD OF PROFESSIONAL ENGINEERS DISTRICT 23.  
 Bruce D. Burton  
 SIGNATURE OF ENGINEER  
 10/18/99  
 DATE

THESE PLANS HAVE BEEN REVIEWED FOR THE HOWARD SOIL CONSERVATION DISTRICT AND MEET THE TECHNICAL REQUIREMENTS.  
 Cheryl Simmons  
 NATURAL RESOURCE CONSERVATION SERVICE  
 10/18/99  
 DATE

APPROVED: DEPARTMENT OF PLANNING & ZONING  
 [Signature]  
 Chief, Development Engineering Division  
 10/22/99  
 DATE

THE DEVELOPMENT PLAN IS APPROVED FOR SOIL EROSION AND SEDIMENT CONTROL BY THE HOWARD SOIL CONSERVATION DISTRICT.  
 [Signature]  
 Chief, Division of Land Development  
 10/29/99  
 DATE

**DEVELOPER'S CERTIFICATE**  
 I HEREBY CERTIFY THAT ALL DEVELOPMENT AND/OR CONSTRUCTION WILL BE DONE ACCORDING TO THESE PLANS AND THAT ANY RESPONSIBLE PERSONNEL INVOLVED IN THE CONSTRUCTION PROJECT WILL HAVE A CERTIFICATE OF ATTENDANCE AT A DEPARTMENT OF THE ENVIRONMENT APPROVED TRAINING PROGRAM FOR THE CONTROL OF SEDIMENT AND EROSION BEFORE BEGINNING THE PROJECT. I ALSO AUTHORIZE PERIODIC ON-SITE INSPECTION BY THE HOWARD SOIL CONSERVATION DISTRICT OR THEIR AUTHORIZED AGENTS, AS ARE DEEMED NECESSARY.  
 [Signature]  
 SIGNATURE OF DEVELOPER  
 10/14/99  
 DATE

[Professional Engineer Seal]  
 Bruce D. Burton  
 10/28/99

<b>LDE, INC.</b>			
9250 Rumsey Road, Suite 106, Columbia, MD. 21045 (410) 715-1070 (301) 596-3424 (410) 715-9540 (Fax)			
DESIGNED: B.D.B.	SEDIMENT CONTROL PLAN	SCALE: 1" = 30'	
DRAWN: K.B.W.	<b>WESS HAVEN</b> Lot 1	DRAWING: 2 OF 3	
CHECKED: B.D.B.	TAX MAP No. 36 BLOCK 9 PARCEL No. 36 6th ELECTION DISTRICT HOWARD COUNTY, MARYLAND	JOB No. 99-033	
DATE: 8/99	Previous Submittal: F99-65	FILE No. SDP00-23	
Drawn by: JAMES P. HANSON 9843 Rainleaf Court Columbia, MD. 21046 (301) 716-0118		By: lde: HAL C. MARKER CO., INC 10524 Hunters Way Laurel, Maryland 20723 (301) 716-8288	

HOWARD SOIL CONSERVATION DISTRICT  
STANDARD SEDIMENT CONTROL NOTES

- A minimum of 48 hours notice must be given to the Howard County Department of Inspections, Licenses and Permits, Sediment Control Division prior to the start of any construction, (313-1855).
- All vegetative and structural practices are to be installed according to the provisions of these plans and are to be in accordance with the most current "MARYLAND STANDARDS AND SPECIFICATIONS FOR SOIL EROSION AND SEDIMENT CONTROL", and revisions thereto.
- Following initial soil disturbance or redistribution, permanent or temporary stabilization shall be completed within: a) 7 calendar days for all perimeter sediment control structures, dikes, perimeter slopes and all slopes greater than 3:1, b) 14 days as to all other disturbed or graded areas on the project site.
- All sediment traps/basins shown must be fenced and warning signs posted around their perimeter in accordance with Vol. 1, Chapter 7, of the HOWARD COUNTY DESIGN MANUAL, Storm Drainage.
- All disturbed areas must be stabilized within the time period specified above in accordance with the 1994 MARYLAND STANDARDS AND SPECIFICATIONS FOR SOIL EROSION AND SEDIMENT CONTROL (Section G) for permanent seeding, soil, temporary seeding, and mulching. Temporary stabilization with mulch alone can only be done when recommended seeding dates do not allow for proper germination and establishment of grasses.
- All sediment control structures are to remain in place and are to be maintained in operative condition until permission for their removal has been obtained from the Howard County Sediment Control Inspector.
- Site Analysis:
 

Total Area of Site	0.41 Acres
Area Disturbed	0.48 Acres
Area to be roofed or paved	0.11 Acres
Area to be vegetatively stabilized	0.37 Acres
Total Cut	270 Cu. Yds.
Total Fill	270 Cu. Yds.
Off-site waste/borrow area location	0.24 Acres
- Any sediment control practice which is disturbed by grading activity for placement of utilities must be repaired on the same day of disturbance.
- Additional sediment control structures must be provided, if deemed necessary by the Howard County Sediment Control Inspector.
- On all sites with disturbed areas in excess of 2 acres, approval of the inspection agency shall be requested upon completion of installation of perimeter erosion and sediment controls, but before proceeding with any other earth disturbance or grading. Other building or grading inspection approvals may not be authorized until this initial approval by the inspection agency is received.
- Trenches for the construction of utilities is limited to three pipe lengths or that which can be back filled and stabilized within one working day, whichever is shorter.

HOWARD SOIL CONSERVATION DISTRICT  
PERMANENT SEEDING NOTES

Apply to graded or cleared areas not subject to immediate further disturbance where a permanent long-lived vegetative cover is needed.

**SEEDBED PREPARATION:** Loosen upper three inches of soil by raking, disking, or other acceptable means before seeding, if not previously loosened.

**SOIL AMENDMENTS:** In lieu of soil test recommendations, use one of the following schedules:

- PREFERRED** — Apply 2 tons per acre dolomitic limestone (92 lbs/1000sq. ft.) and 600 lbs per acre 0-10-10 fertilizer (14 lbs/1000sq. ft.) before seeding. Harrow or disk into upper three inches of soil, at time of seeding, apply 400 lbs per acre 30-0-0 ureaform fertilizer (9 lbs/1000sq. ft.)
- ACCEPTABLE** — Apply 2 tons per acre dolomitic limestone (92 lbs/1000sq. ft.) and 1000 lbs per acre 10-10-10 fertilizer (23 lbs/1000sq. ft.) before seeding. Harrow or disk into upper three inches of soil.

**SEEDING** — For the periods March 1 thru April 30, and August 1 thru October 15, seed with 60 lbs per acre (1.4 lbs/1000sq. ft.) of Kentucky 31 Tall Fescue. For the period May 1 thru July 31, seed with 60 lbs per acre (1.4 lbs/1000sq. ft.) of Kentucky 31 Tall Fescue and 2 lbs. per acre (.05 lbs/1000sq. ft.) of weeping lovegrass. During the period of October 16 thru February 28, protect site by: Option (1) — 2 tons per acre of well anchored straw mulch and seed as soon as possible in the spring. Option (2) — Use sod. Option (3) — Seed with 60 lbs per acre Kentucky 31 Tall Fescue and mulch 2 tons / acre well anchored straw.

**MULCHING** — Apply 1-1/2 to 2 tons per acre (70 to 90 lbs/1000sq. ft.) of unrotted small grain straw immediately after seeding. Anchor mulch immediately after application using mulch anchoring tool or 218 gallons per acre (5 gal/1000sq. ft.) of unacidified asphalt on flat areas. On slopes 8 feet or higher, use 348 gallons per acre (8 gal/1000sq. ft.) for anchoring.

**MAINTENANCE** — Inspect all seeding areas and make needed repairs, replacements and reseeding.

TEMPORARY SEEDING NOTES

Apply to graded or cleared areas likely to be redistributed where a short-term vegetative cover is needed.



**SEEDBED PREPARATION:** — Loosen upper three inches of soil by raking, disking, or other acceptable means before seeding, if not previously loosened.

**SOIL AMENDMENTS:** — Apply 600 lbs per acre 10-10-10 fertilizer (14 lbs/1000sq. ft.).

**SEEDING** — For periods March 1 thru April 30, and from August 15 thru October 15 seed with 2-12 bushels per acre of annual rye (3.2 lbs/1000sq. ft.). For the period May 1 thru August 14, seed with 3 lbs per acre of weeping lovegrass (0.7 lbs/1000sq. ft.). For the period November 16 thru February 28, protect site by applying 2 tons per acre of well anchored straw mulch and seed as soon as possible in the spring, or use sod.

**MULCHING** — Apply 1-1/2 to 2 tons per acre (70 to 90 lbs/1000sq. ft.) of unrotted weed free small grain straw immediately after seeding. Anchor mulch immediately after application using mulch anchoring tool or 218 gallons per acre (5 gal/1000sq. ft.) of unacidified asphalt on flat areas. On slopes 8 feet or higher, use 348 gallons per acre (8 gal/1000sq. ft.) for anchoring.

Refer to the 1994 MARYLAND STANDARDS AND SPECIFICATIONS FOR SOIL EROSION AND SEDIMENT CONTROL for additional rates and methods not covered.

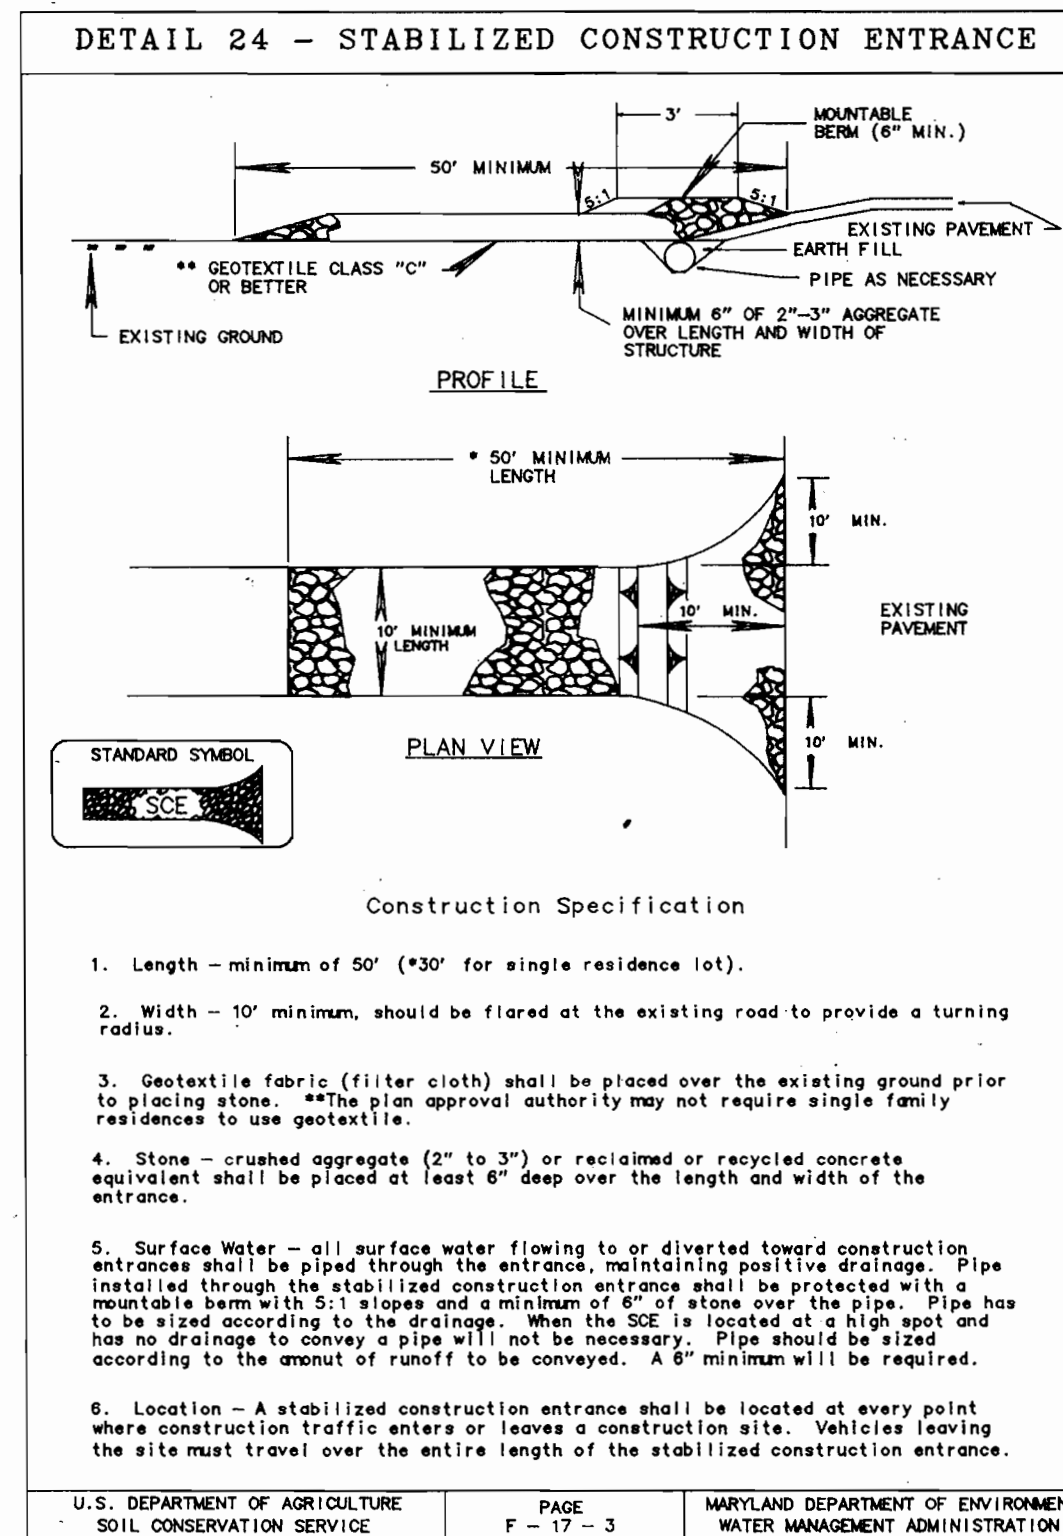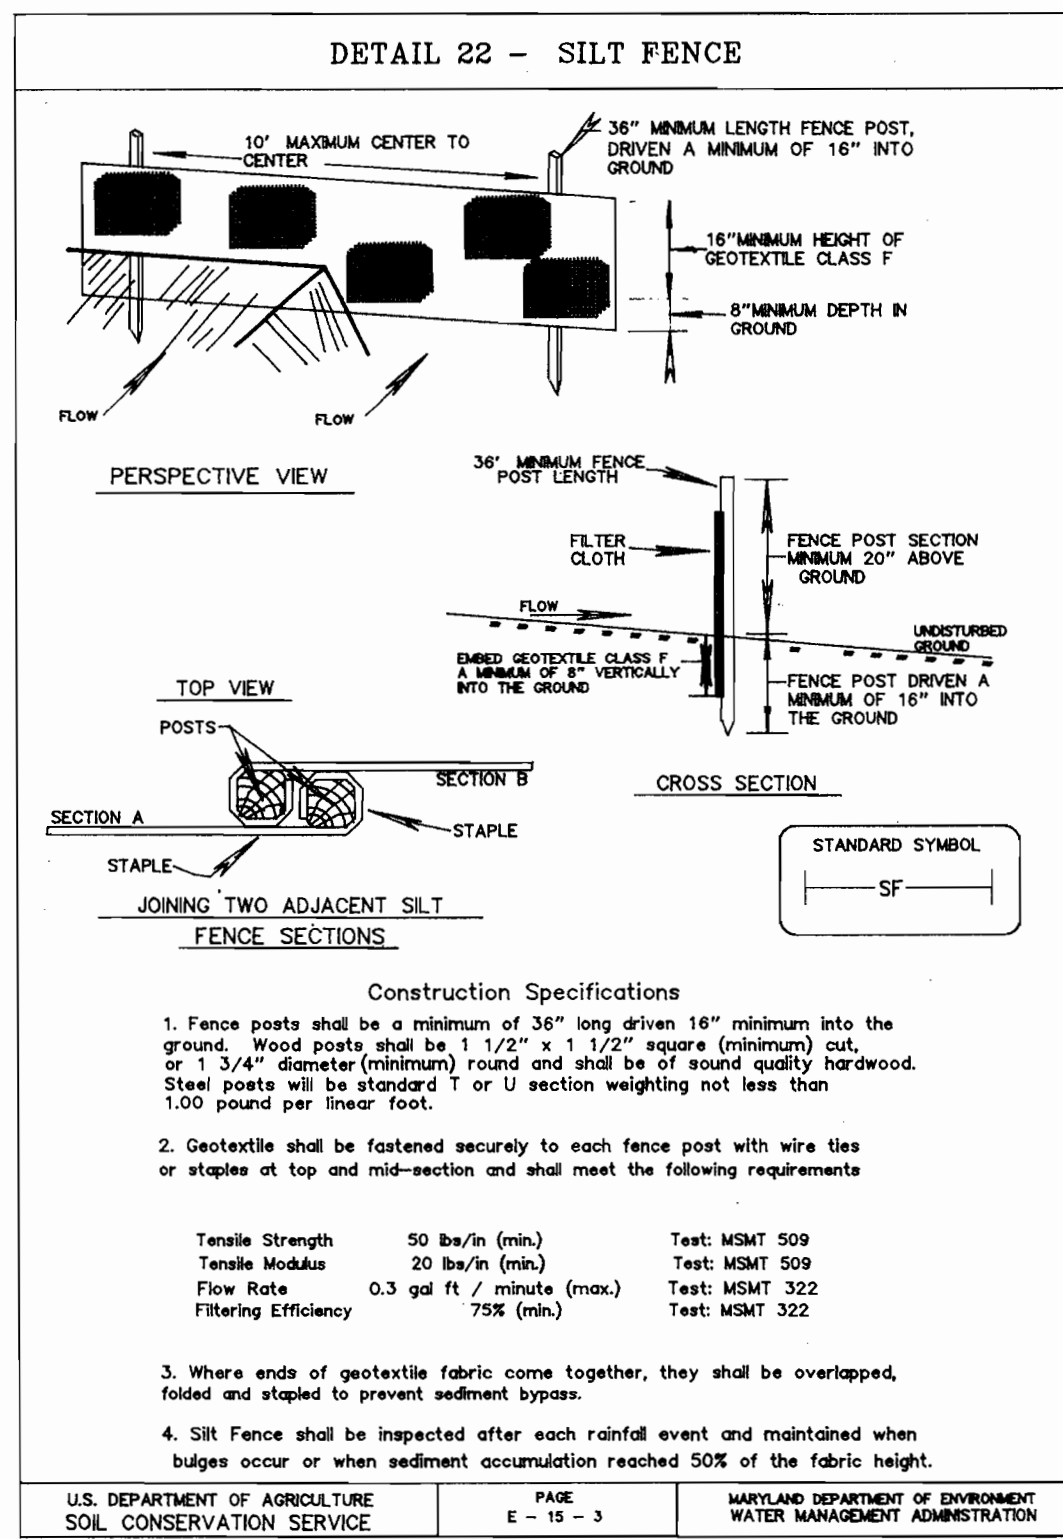

21.0 STANDARD AND SPECIFICATIONS FOR TOPSOIL

**Definition**  
Placement of topsoil over a prepared subsoil prior to establishment of permanent vegetation.



**Purpose**  
To provide a suitable soil medium for vegetative growth. Soils of concern have low moisture content, low nutrient levels, low pH, materials toxic to plants, and/or unacceptable soil gradation.

**Conditions Where Practice Applies**



- This practice is limited to areas having 2:1 or flatter slopes where:
  - The texture of the exposed subsoil/parent material is not adequate to produce vegetative growth.
  - The soil material is so shallow that the rooting zone is not deep enough to support plants or furnish continuing supplies of moisture and plant nutrients.
  - The original soil to be vegetated contains material toxic to plant growth.
  - The soil is so acidic that treatment with limestone is not feasible.
- For the purpose of these Standards and Specifications, areas having slopes steeper than 2:1 require special consideration and design for adequate stabilization. Areas having slopes steeper than 2:1 shall have the appropriate stabilization shown on the plans.

**Construction and Material Specifications**

- Topsoil salvaged from the existing site may be used provided that it meets the standards as set forth in these specifications. Typically, the depth of topsoil to be salvaged for a given soil type can be found in the representative soil profile section in the Soil Survey published by USDA-SCS in cooperation with Maryland Agricultural Experimental Station.
- Topsoil Specifications - Soil to be used as topsoil must meet the following:
  - Topsoil shall be a loam, sandy loam, clay loam, silt loam, sandy clay loam, loamy sand. Other soils may be used if recommended by an agronomist or soil scientist and approved by the appropriate approval authority. Regardless, topsoil shall not be a mixture of contrasting textured subsoils and shall contain less than 5% by volume of cinders, stones, slag, coarse fragments, gravel, sticks, roots, trash, or other materials larger than 1 1/2" in diameter.
  - Topsoil must be free of plants or plant parts such as bermuda grass, quackgrass, johnsongrass, nutsedge, poison ivy, thistle, or others as specified.
  - Where the subsoil is either highly acidic or composed of heavy clays, ground limestone shall be spread at the rate of 4-8 tons/acre (200-400 pounds per 1,000 square feet) prior to the placement of topsoil. Lime shall be distributed uniformly over designated areas and worked into the soil in conjunction with tillage operations as described in the following procedures.
- For sites having disturbed areas under 5 acres:
  - Place topsoil (if required) and apply soil amendments as specified in 20.0 Vegetative Stabilization - Section 1 - Vegetative Stabilization Methods and Materials.
- For sites having disturbed areas over 5 acres:
  - On soil meeting Topsoil specifications, obtain test results indicating fertilizer and lime amendments required to bring the soil into compliance with the following:
    - pH for topsoil shall be between 6.0 and 7.5. If the tested soil demonstrates a pH of less than 6.0, sufficient lime shall be prescribed to raise the pH to 6.5 or higher.
    - Organic content of topsoil shall be not less than 1.5 percent by weight.
    - Topsoil having soluble salt content greater than 500 parts per million shall not be used.
    - No soil shall be placed on a soil which has been treated with soil sterilants or chemicals used for weed control until sufficient time has elapsed (14 days min.) to permit dissipation of phytotoxic materials.
  - Note: Topsoil substitutes or amendments, as recommended by a qualified agronomist or soil scientist and approved by the appropriate approval authority, may be used in lieu of natural topsoil.
  - Place topsoil (if required) and apply soil amendments as specified in 20.0 Vegetative Stabilization - Section 1 - Vegetative Stabilization Methods and Materials.

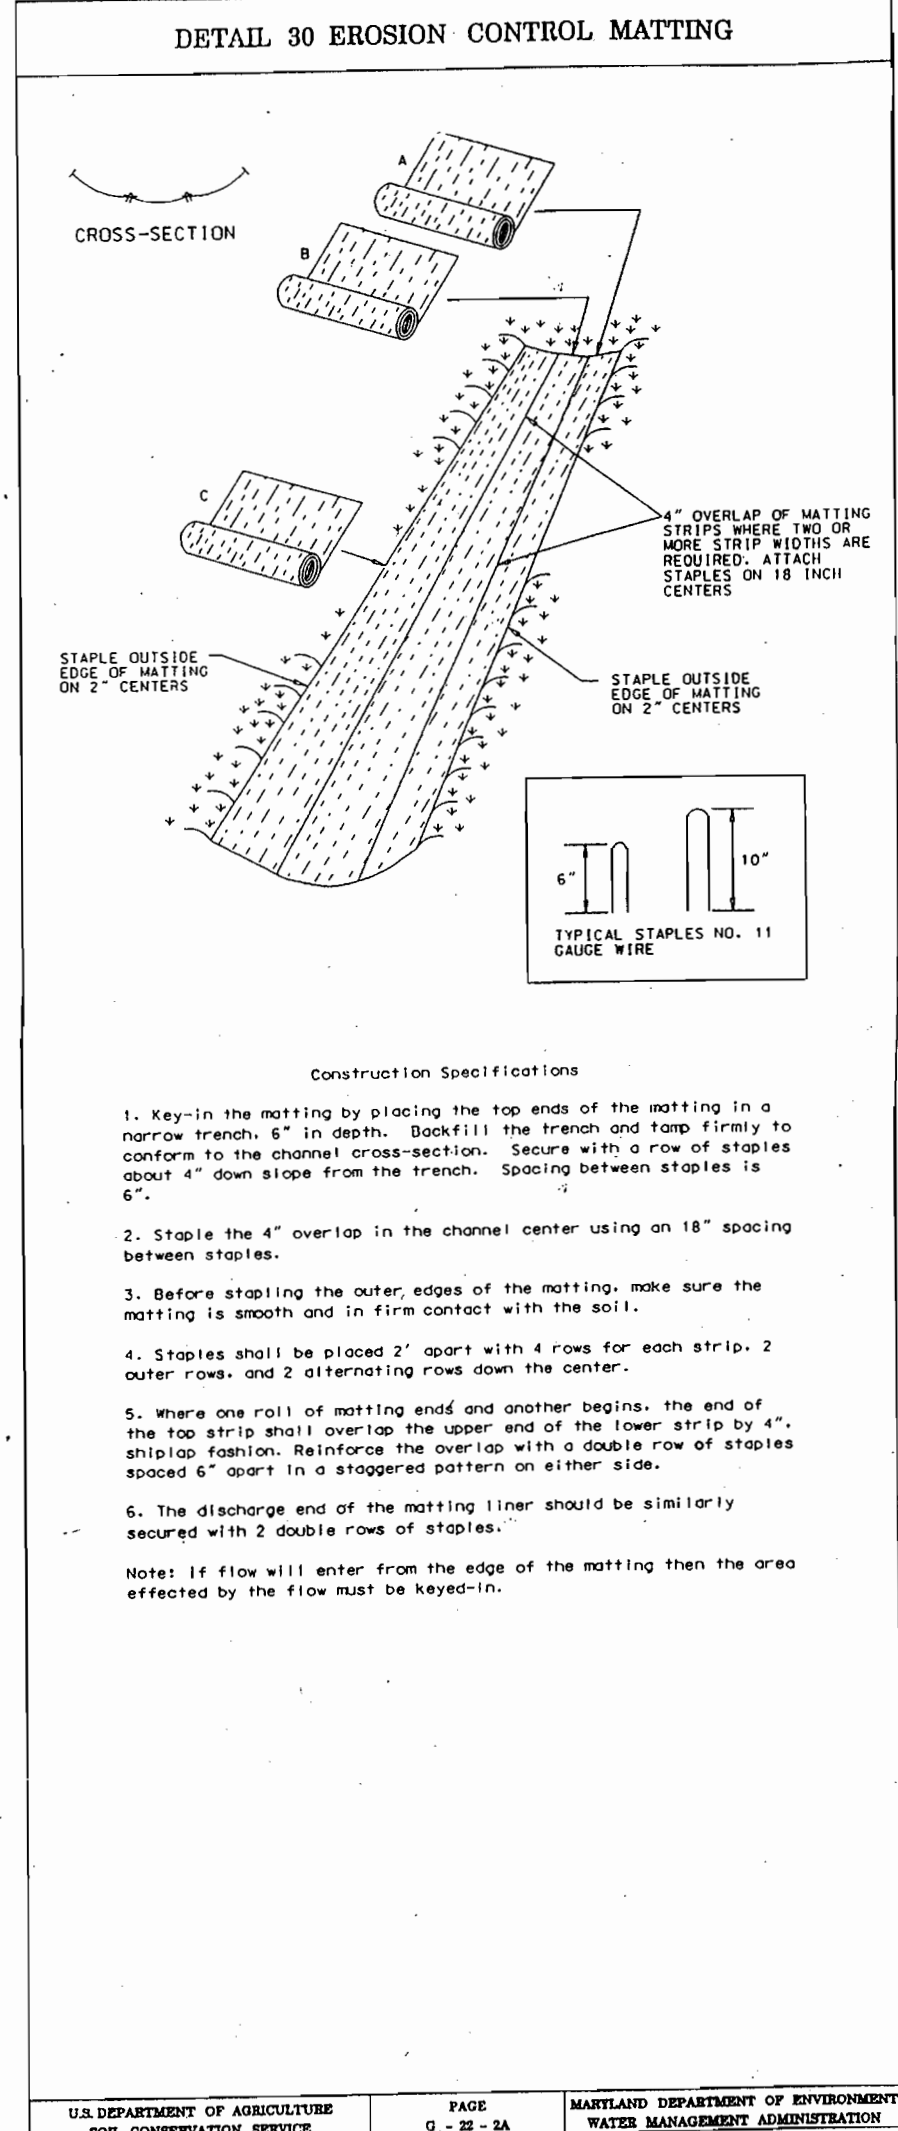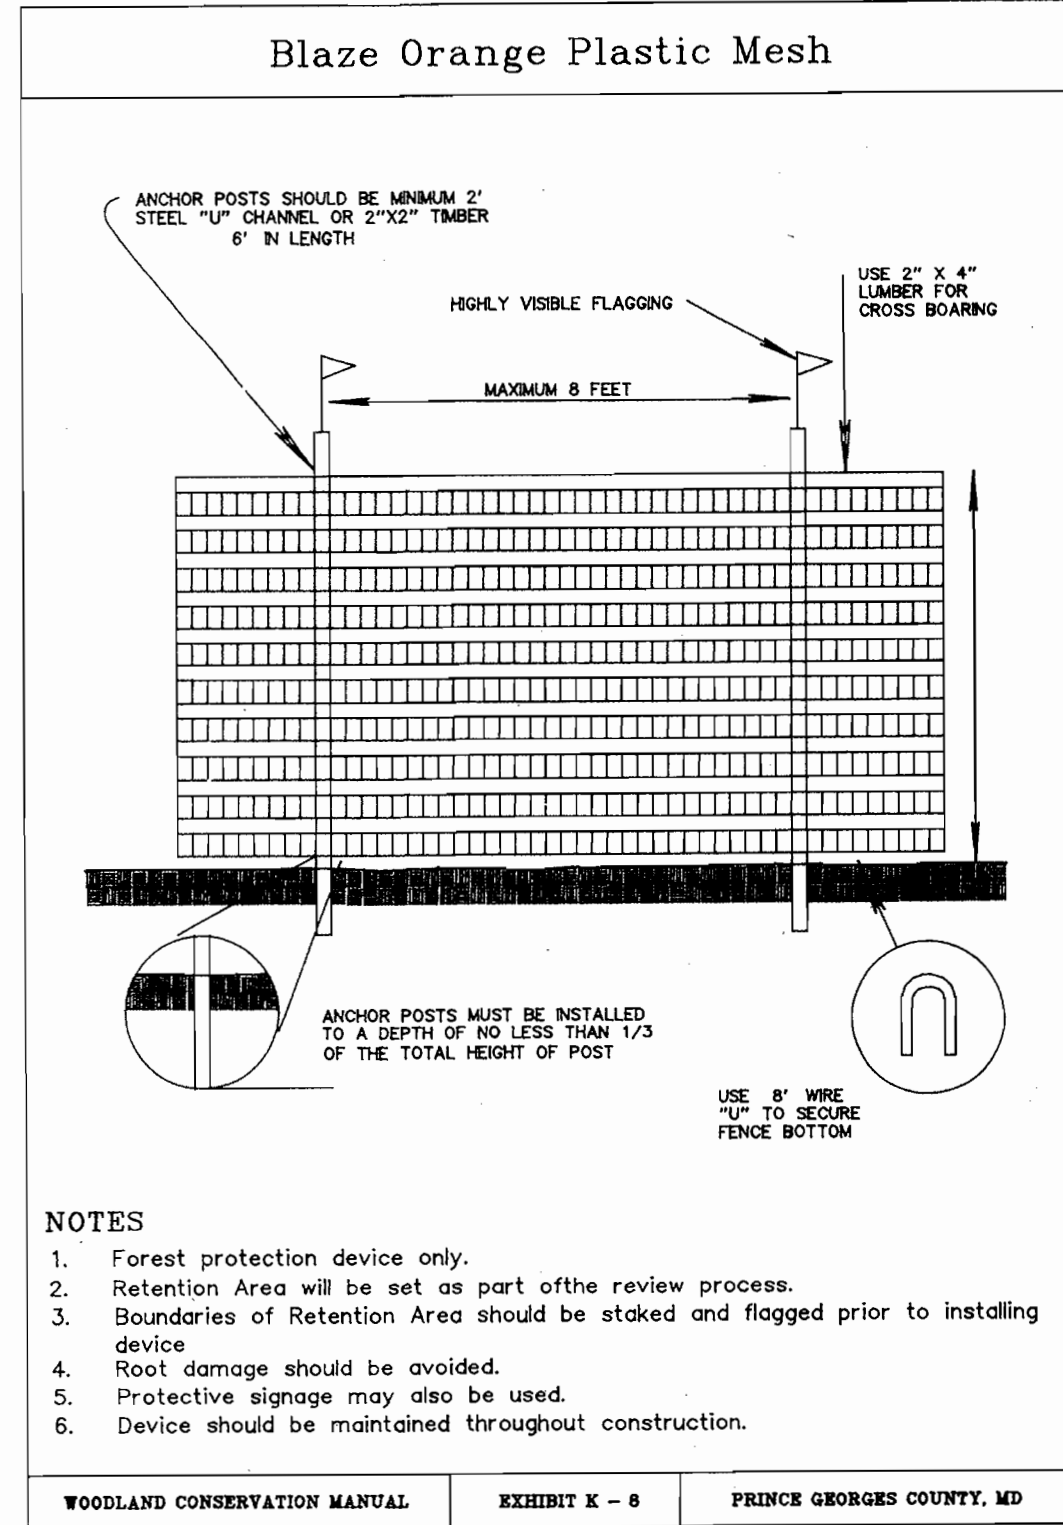

DRYWELL DETAIL

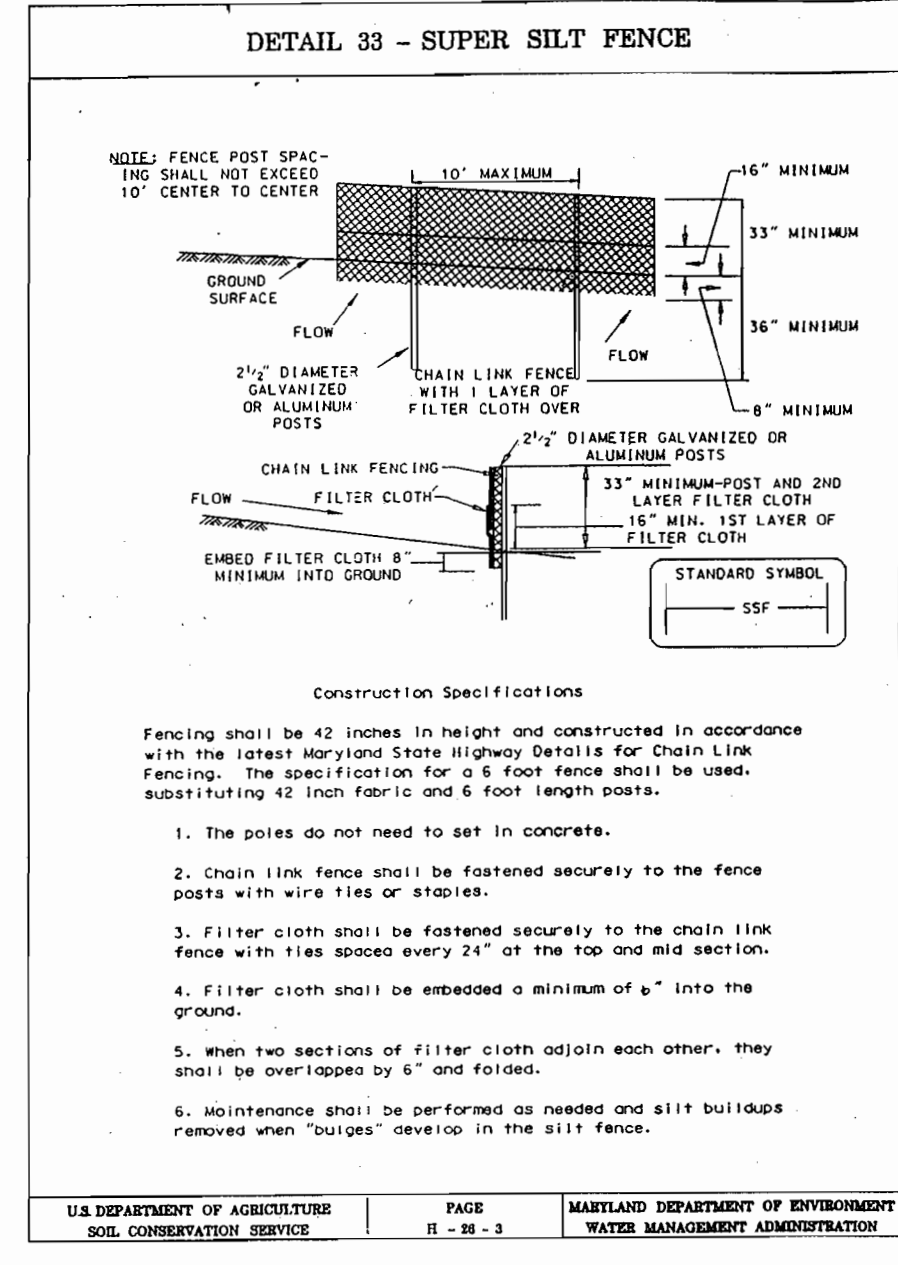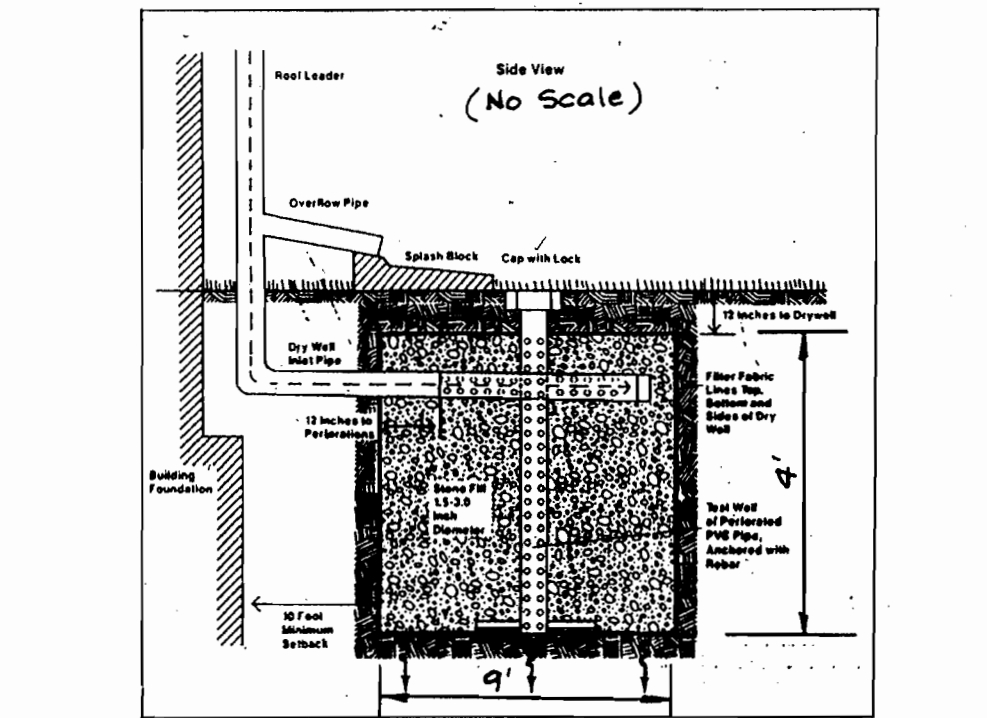

**ENGINEER'S CERTIFICATE**  
I HEREBY CERTIFY THAT THIS PLAN FOR EROSION AND SEDIMENT CONTROL REPRESENTS A PRACTICAL AND WORKABLE PERMANENT SEDIMENT CONTROL KNOWLEDGE OF THE SITE CONDITIONS AND THAT THE SAME WERE PREPARED IN ACCORDANCE WITH REQUIREMENTS OF THE HOWARD COUNTY DEPARTMENT OF INSPECTIONS, LICENSING AND PERMITS, SEDIMENT CONTROL DIVISION.

*Eric D. Burton* 10/18/99  
SIGNATURE OF ENGINEER DATE

**DEVELOPER'S CERTIFICATE**  
I HEREBY CERTIFY THAT ALL DEVELOPMENT AND/OR CONSTRUCTION WILL BE DONE ACCORDING TO THESE PLANS AND THAT ANY RESPONSIBLE PERSONNEL INVOLVED IN THE CONSTRUCTION PROJECT WILL HAVE A CERTIFICATE OF ATTENDANCE AT A DEPARTMENT OF THE ENVIRONMENT APPROVED TRAINING PROGRAM FOR THE CONTROL OF SEDIMENT AND EROSION BEFORE BEGINNING THE PROJECT. I ALSO AUTHORIZE PERIODIC ON-SITE INSPECTIONS BY THE HOWARD SOIL CONSERVATION DISTRICT OR THEIR AUTHORIZED AGENTS, AS ARE DEEMED NECESSARY.

*Hal A. Masten* 10/18/99  
SIGNATURE OF DEVELOPER DATE

THESE PLANS HAVE BEEN REVIEWED FOR THE HOWARD SOIL CONSERVATION DISTRICT AND MEET THE TECHNICAL REQUIREMENTS.

*Chief Simmons* 10/18/99  
NATURAL RESOURCE CONSERVATION SERVICE DATE

THIS DEVELOPMENT PLAN IS APPROVED FOR SOIL EROSION AND SEDIMENT CONTROL BY THE HOWARD SOIL CONSERVATION DISTRICT.

*John P. Robinson* 10/18/99  
HOWARD SOIL CONSERVATION DISTRICT DATE

APPROVED: DEPARTMENT OF PLANNING & ZONING

*Chief, Development Engineering Division* 10/22/99  
DATE

*Chief, Division of Land Development* 10/25/99  
DATE

*Chief, Planning & Zoning* 10/26/99  
DATE

STATE OF MARYLAND PROFESSIONAL ENGINEER

*Eric D. Burton* 10/22/99  
DATE

*Eric D. Burton* 10/22/99  
DATE

*Eric D. Burton* 10/22/99  
DATE

**LDE, INC.**  
9250 Rumsey Road, Suite 106, Columbia, MD 21045  
(410) 715-1070 (301) 596-3424 (410) 715-9540 (Fax)

DESIGNED: BDB SCALE: N/A  
DRAWN: KBW DRAWING: 3 OF 3  
CHECKED: BDB JOB NO.: 99-033  
DATE: 8/99

**WESS HAVEN**  
Lot 1  
TAX MAP No. 36 BLOCK 9 PARCEL No. 36  
6th ELECTION DISTRICT  
HOWARD COUNTY, MARYLAND  
Previous Submittal: F99-65

OWNER: JAMES P. HANSON 9843 Rainleaf Court Columbia, MD 21046 (301) 716-0118  
BUILDER: HAL C. MARKER CO., INC 10524 Hunters Way Laurel, Maryland 20723 (301) 716-8888

FILE NO.: SDP00-23