SHEET NO. DESCRIPTION 1 TITLE SHEET	SHEET INDEX						
	SHEET NO.	DESCRIPTION					
	1	TITLE SHEET					
2 ENVIRONMENTAL CONCEPT PLAN	2	ENVIRONMENTAL CONCEPT PLAN					

	SOILS LEGEND		
SOIL	NAME	CLASS	'K'VALUE
GbC	Gladstone loam, 8 to 15 percent slopes	В	0.32
GfB	Gladstone-Urban land complex, 0 to 8 percent slopes	В	0.32
	501L5 MAP 17; 0	LARKSVILLE N	e quadrangl

STORMWATER MANAGEMENT SUMMARY ESDV ESDV PROVIDED REQUIRED AREA ID. REMARKS CU.FT. CU.FT. roof 204 2 DRYWELLS (M-5) 160 (1,250 SaFt.) DRIVEWAY 528 & ROOF (STORÁGE) (STORAGE) MICRO-BIORETENTION FACILITY (M-6) (4,181 SaFt

SWM NARRATIVE

635

INTRODUCTION:

TOTAL

5ITE

THIS REPORT WILL DEMONSTRATE HOW THE CRITERIA SET FORTH IN THE MARYLAND STORMWATER DESIGN MANUAL, VOLUMES I AND II (EFFECTIVE OCTOBER 2000, REVISED MAY 2009) WILL BE SATISFIED ON THIS PROJECT. THE GOAL OF CREATING HYDROLOGY SIMILAR TO THAT OF "WOODS IN GOOD CONDITION" WILL BE ACCOMPLISHED THROUGH THE USE OF THE PRACTICES CONTAINED WITHIN CHAPTER 5 OF SAID MANUAL.

732

GENERAL SITE CONDITIONS:

5972 TROTTER ROAD IS A ONE ACRE LOT CONSISTING ON ONE SINGLE FAMILY HOME. THE PROPERTY IS JONED R-20 AND LOCATED ON TAX MAP 35 IN THE CLARKSVILLE AREA OF HOWARD COUNTY. THE SITE SLOPES FROM SOUTH TO NORTH AND DRAINS TO BROAD SWALE IN THE REAR OF THE ADJOINING LOT. PUBLIC WATER AND SEWER WILL BE UTILIZED FOR THIS PROJECT. THE SOILS ON SITE ARE CLASS 'B' SOILS, GLC GLADSTONE LOAM AND GFB GLADSTONE-URBAN LAND COMPLEX. THE SITE IS RECTANGULAR IN SHAPE AND CONTAINS BOTH SMALL AND MATURE TREES INCLUDING 5 SPECIMEN TREES. THIS SITE IS IN THE MIDDLE PATUXENT RIVER WATERSHED (02131106). THE RUNOFF FROM A PORTION OF THE ROOF OF THE PROPOSED HOUSE WILL BE TREATED BY 2 DRYWELLS (M-5) AND RUNOFF THE REMAINING ROOFTOP AND DRIVEWAY WILL BE TREATED BY A MICRO-BIORETENTION (M-6) FACILITY.

- NATURAL RESOURCE PROTECTION: EXCLUDING 5 SPECIMEN TREES, THERE ARE NO ENVIRONMENTALLY SENSITIVE AREAS EXIST ON-SITE. DUE TO THE LARGE CRITICAL ROOT ZONES LOCATED ON-SITE. 3 SPECIMEN TREES WILL #2 STONE-BE REMOVED TO ALLOW CONSTRUCTION OF THE PROPOSED BUILDING. PLEASE NOTE AN ALTERNATIVE COMPLIANCE WILL BE SUBMITTED AT THE FINAL PLAN STAGE OF THIS PROJECT FOR THE REMOVAL OF SPECIMEN TREES.
- MAINTENANCE OF NATURAL FLOW PATTERNS:

IT IS THE INTENT OF THE PROPOSED DESIGN TO DISCHARGE RUNOFF SIMILAR TO THE CHARACTERISTICS AND DIRECTION OF THIS SITE PRIOR TO ANY OF THE PROPOSED IMPROVEMENT THE EXISTING DISCHARGE POINT FOR THIS PROJECT IS LOCATED AT THE BEGINNING OF A BROAD SWALE TO THE NORTH OF THE PROPERTY, WHICH BECOMES NARROWER WHEN ENTERING THE YALL LI PROPERTY. ALTHOUGH THE PROPOSED SWM DESIGN CREATES A CONCENTRATED POINT OF DISCHARGE AT THE LOW FLOW UNDERDRAIN, BOTH THIS UNDERDRAIN AND LARGER STORM EVENTS WILL ENTER THE NORTHERN PORTION OF THE SWALE SIMILAR TO EXISTING CONDITIONS, WHERE THE NARROWER SWALE PREVIOUSLY RESIDED.

- II. REDUCTION OF IMPERVIOUS AREAS THROUGH BETTER SITE DESIGN. ALTERNATIVE SURFACES AND NONSTRUCTURAL PRACTICES TO MINIMIZE IMPERVIOUS AREA, THIS PROJECT PROPOSES THE EXPANSION OF THE EXISTING DRIVEWAY TO BE UTILIZED AS A USE-IN-COMMON DRIVEWAY FOR ACCESS TO THE PROPOSED HOUSE, ALL NEW IMPERVIOUS AREA WILL RECEIVE FULL EDSV.
- . INTEGRATION OF EROSION AND SEDIMENT CONTROLS INTO STORMWATER STRATEGY: DUE TO THE MINOR NATURE OF THIS PROJECT NO LARGE SCALE SEDIMENT CONTROL. PRACTICES HAVE BEEN PROPOSED. HOWEVER, IT IS ANTICIPATED TO UTILIZE THE INTERIM
- CONDITION BIO-RETENTION DESIGN THAT WILL PROVIDE MINOR SEDIMENT TRAPPING. IMPLEMENTATION OF ESD PLANNING TECHNIQUES AND PRACTICES TO THE MAXIMUM EXTENT PRACTICABLE (MEP)
- THIS SUBMISSION PROPOSES SEVERAL MARYLAND STORMWATER DESIGN MANUAL, CHAPTER 5 DEVICES TO MEET AND EXCEED THE REQUIRED ENVIRONMENTAL SITE DESIGN TO THE MAXIMUM EXTENT PRACTICABLE (ESD TO THE MEP).
- VI. REQUEST FOR DESIGN MANUAL WAIVER: NO WAIVERS RELATED TO STORMWATER MANAGEMENT ARE BEING REQUESTED AT THIS TIME. HOWEVER, THIS SITE IS SUBJECT TO APPROVAL OF AN ALTERNATIVE COMPLIANCE APPLICATION TO SECTION 16.120 (C)(2)(I) OF THE HOWARD COUNTY SUBDIVISION AND LAND DEVELOPMENT REGULATIONS FOR MINIMUM FRONTAGES AND SECTION 16.1205(A)(3) OF THE SAME REGULATIONS FOR REMOVAL OF THREE SPECIMEN TREES.

OPERATION & MAINTENANCE SCHEDULE FOR PRIVATELY

- OWNED AND MAINTAINED DRY WELLS (M-5) A. THE OWNER SHALL INSPECT THE MONITORING WELLS AND STRUCTURES ON A QUARTERLY BASIS
- AND AFTER EVERY HEAVY STORM EVENT.
- B. THE OWNER SHALL RECORD THE WATER LEVELS AND SEDIMENT BUILD UP IN THE MONITORING
- WELLS OVER A PERIOD OF SEVERAL DAYS TO ENSURE TRENCH DRAINAGE. C. THE OWNER SHALL MAINTAIN A LOG BOOK TO DETERMINE THE RATE AT WHICH THE FACILITY


FISHER, COLLINS & CARTER, INC.


IL ENGINEERING CONSULTANTS & LAND SURVEYORS

ELLICOTT CITY, MARYLAND 21042 (410) 461 - 2855

UARE OFFICE PARK - 10272 BALTIMORE NATIONAL PIKE

- D. WHEN THE FACILITY BECOMES CLOGGED SO THAT IT DOES NOT DRAIN DOWN WITHIN A SEVENTY-TWO (72) HOUR TIME PERIOD, CORRECTIVE ACTION SHALL BE TAKEN.
- E. THE MAINTENANCE LOG BOOK SHALL BE AVAILABLE TO HOWARD COUNTY FOR INSPECTION TO
- INSURE COMPLIANCE WITH OPERATION AND MAINTENANCE CRITERIA. F. ONCE THE PERFORMANCE CHARACTERISTICS OF THE INFILTRATION FACILITY HAVE BEEN VERIFIED. THE MONITORING SCHEDULE CAN BE REDUCED TO AN ANNUAL BASIS UNLESS THE PERFORMANCE DATA INDICATES THAT A MORE FREQUENT SCHEDULE IS REQUIRED.

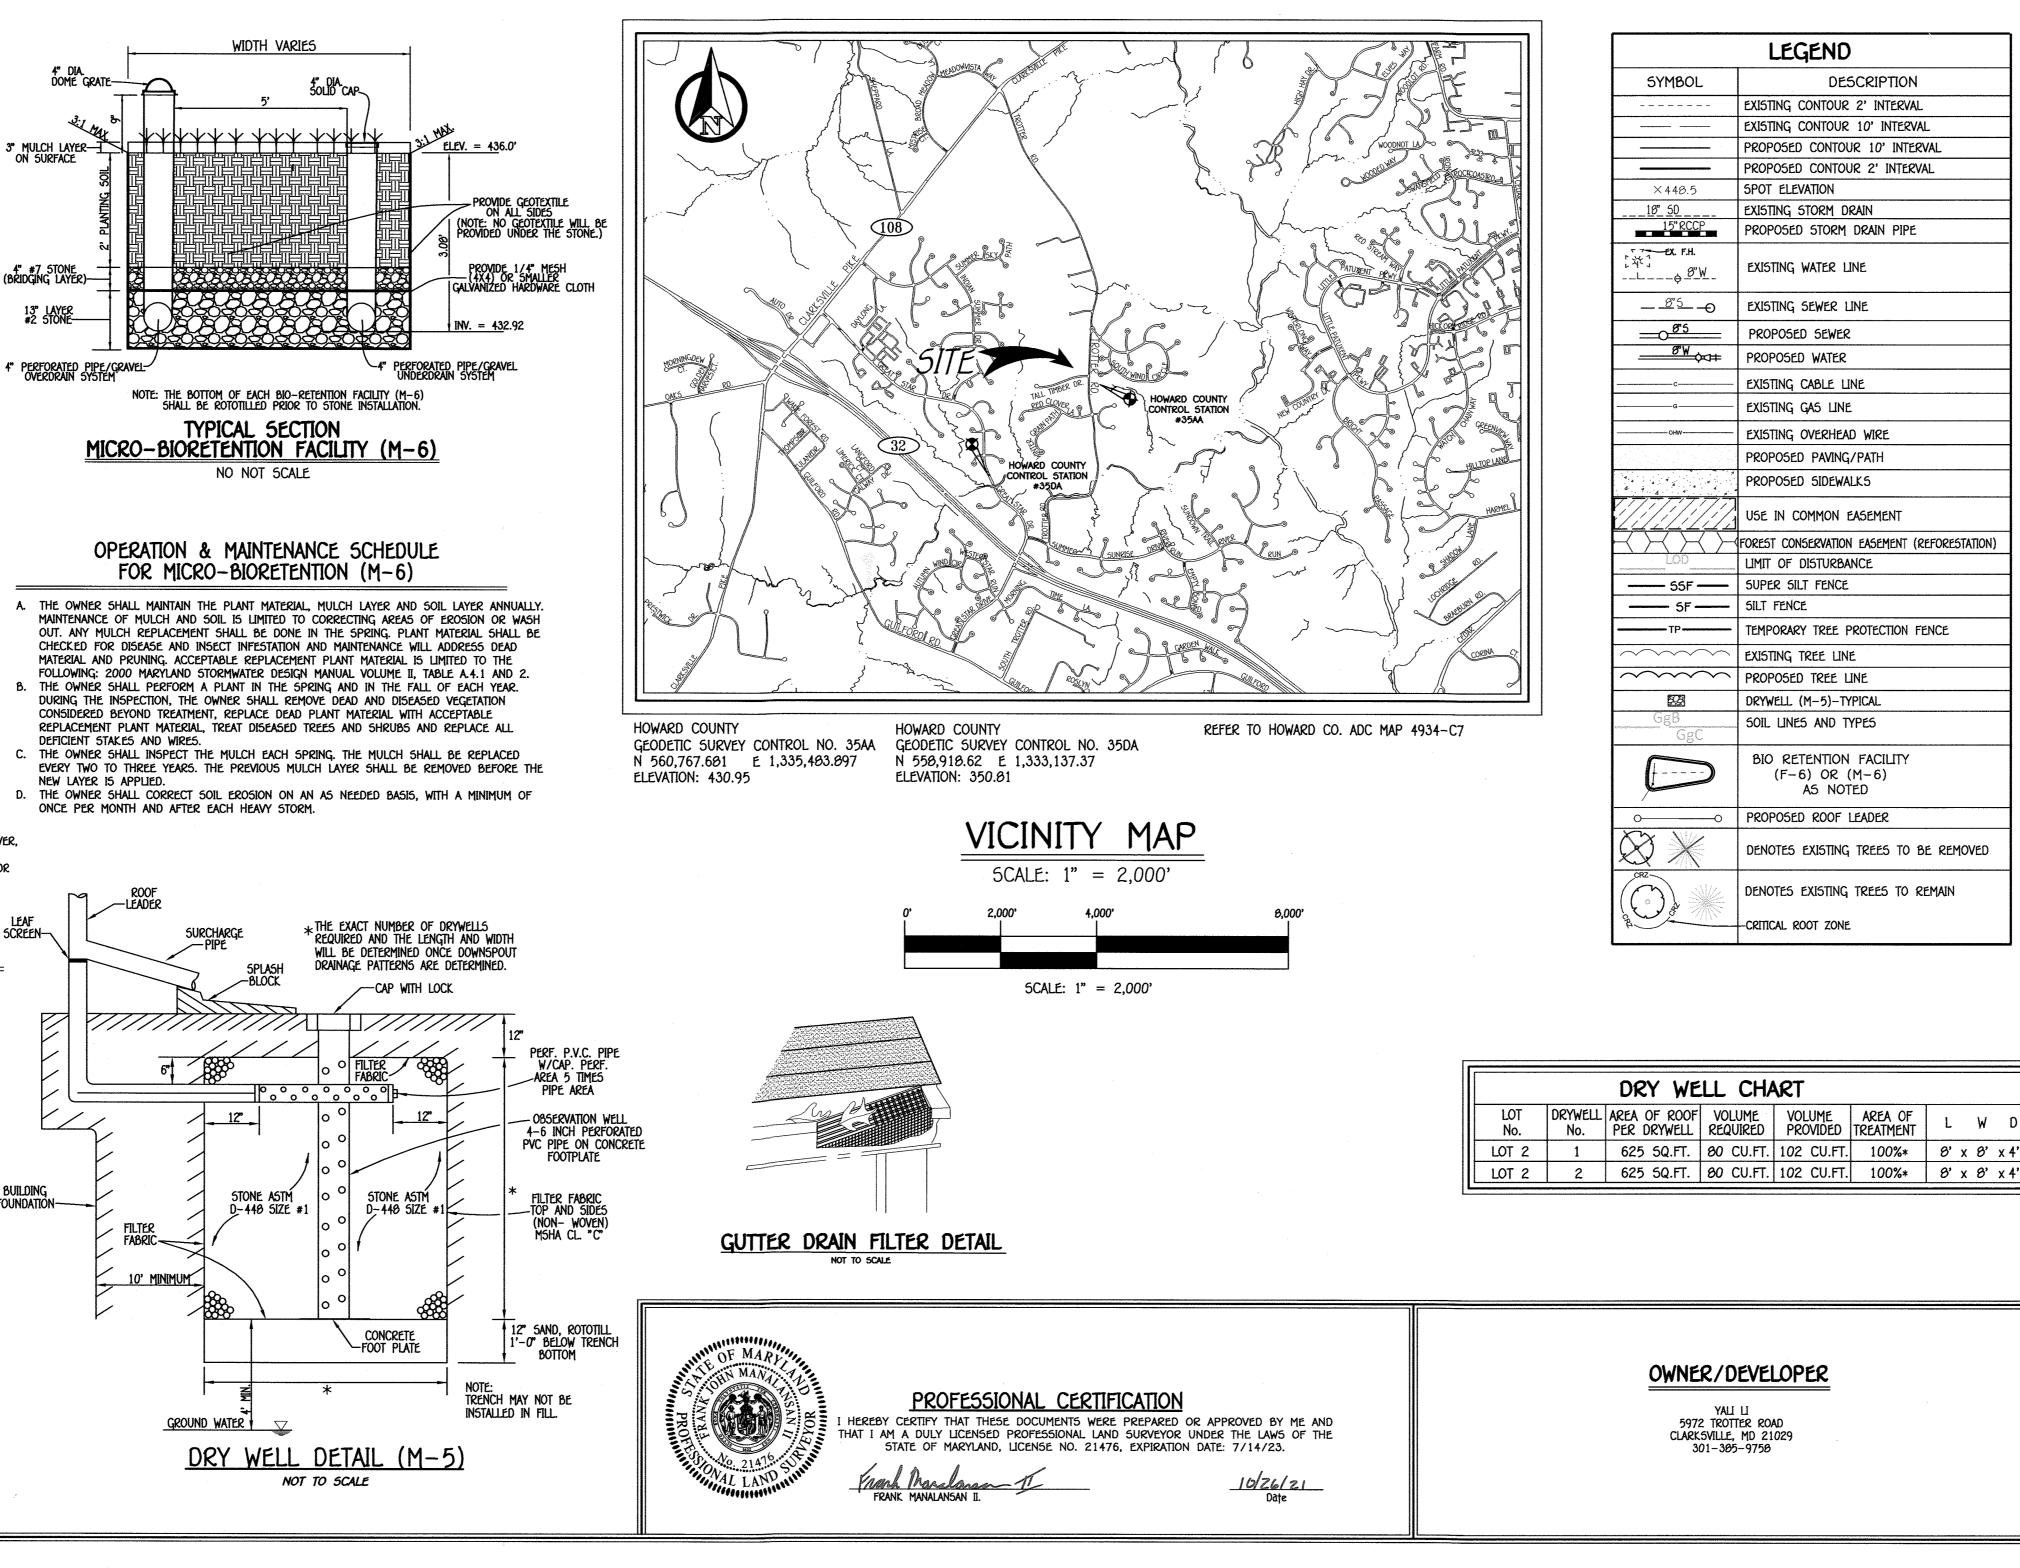


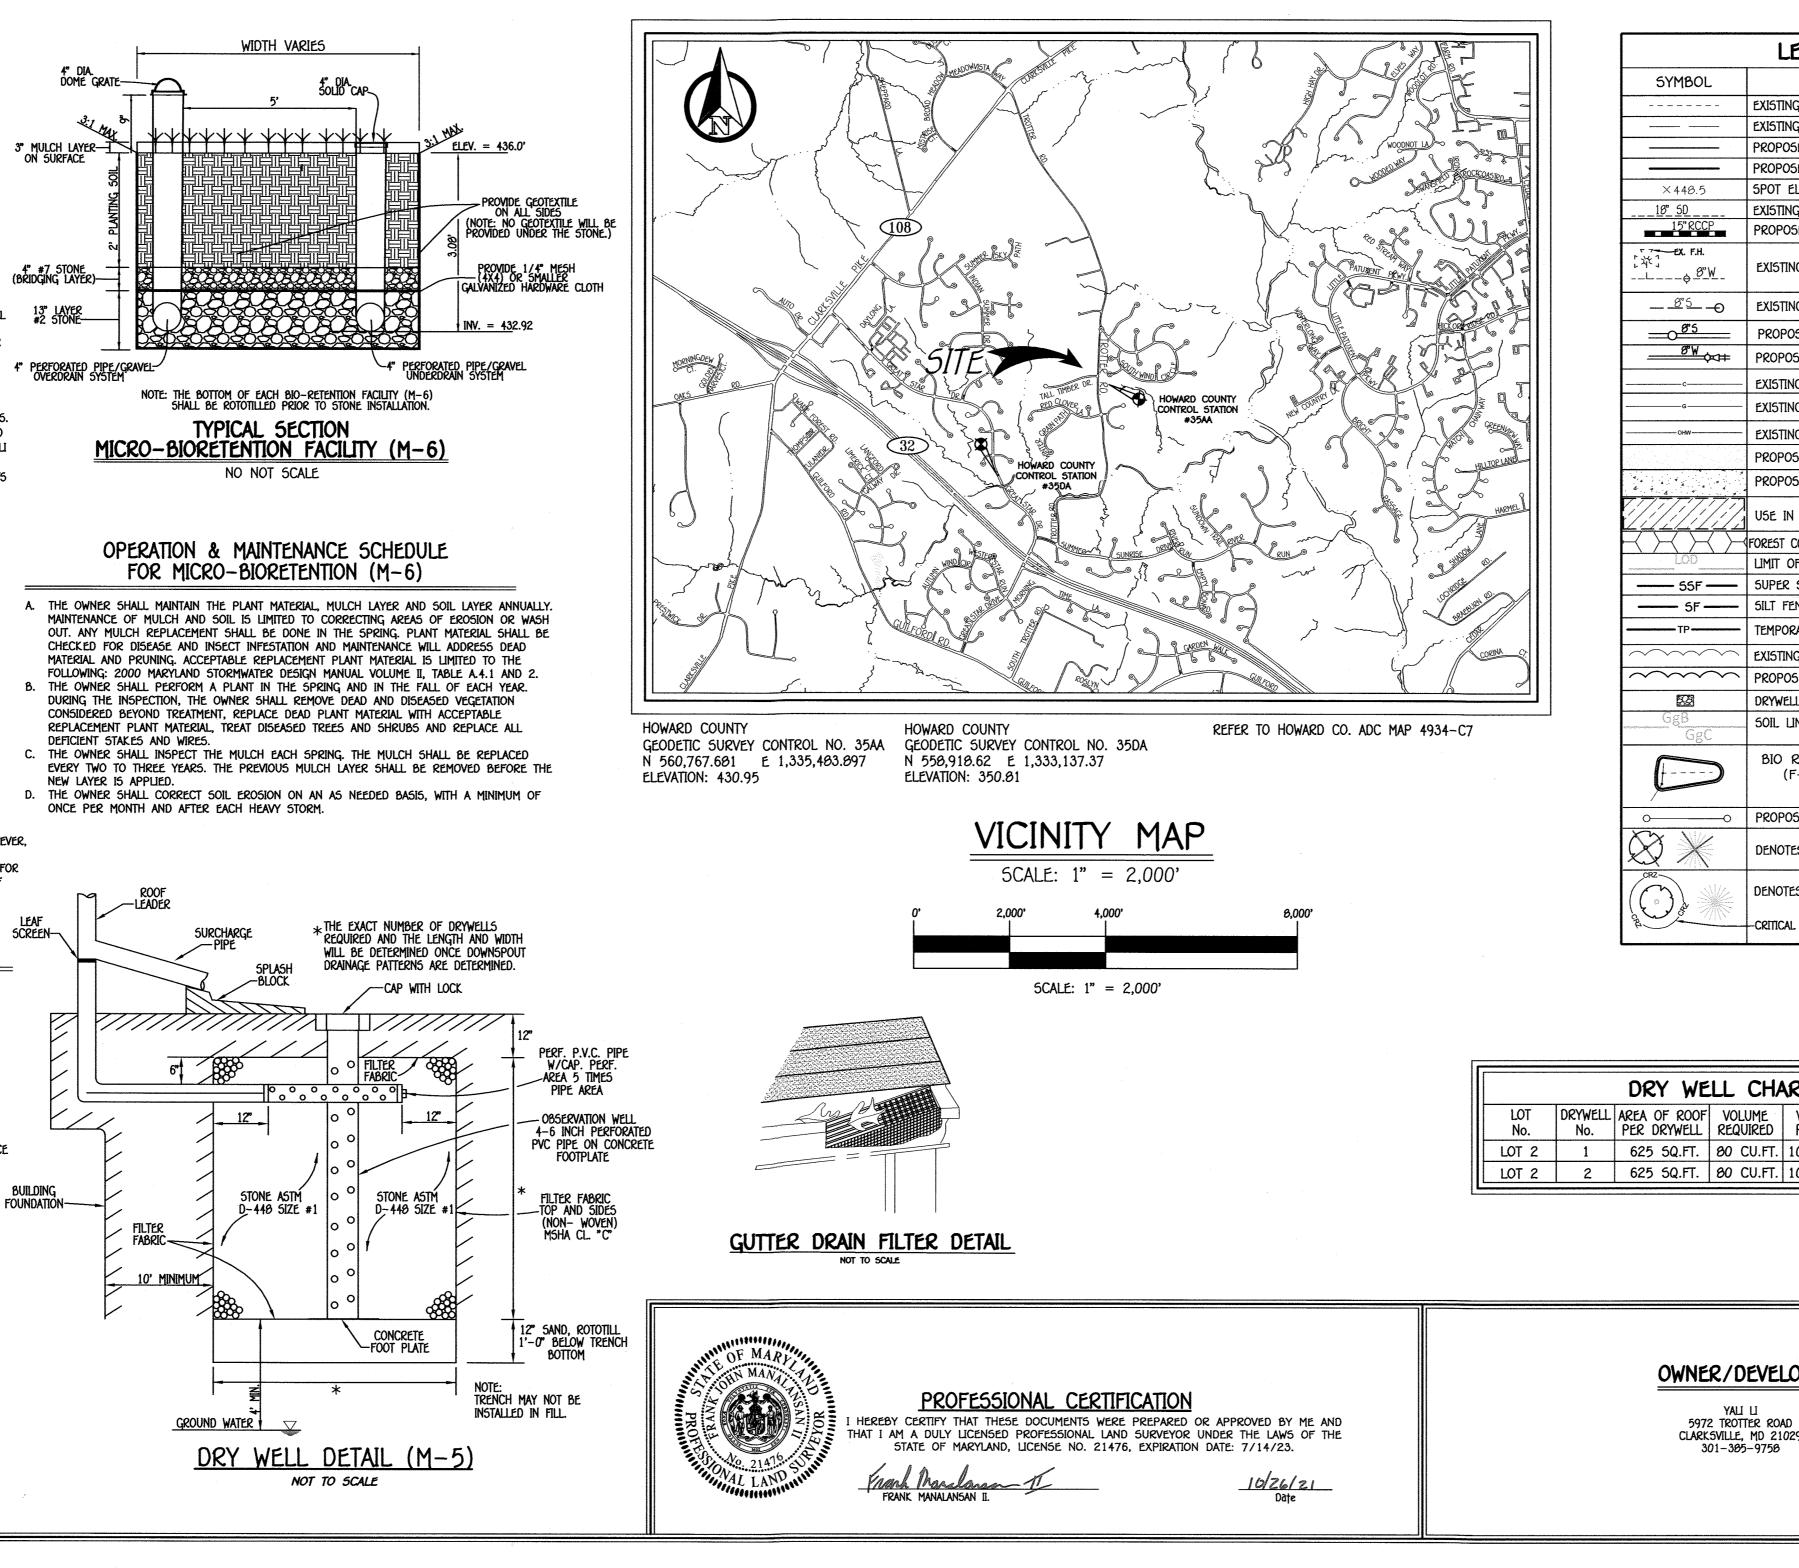


ENVIRONMENTAL CONCEPT PLAN YALI LI PROPERTY

5972 TROTTER ROAD

A RE-SUBDIVISION OF FOREST HILLS, LOT 4 **ZONING: R-20 (RESIDENTIAL: SINGLE DISTRICT)** TAX MAP No. 35 GRID No. 08 PARCEL No. 19 FIFTH ELECTION DISTRICT HOWARD COUNTY, MARYLAND

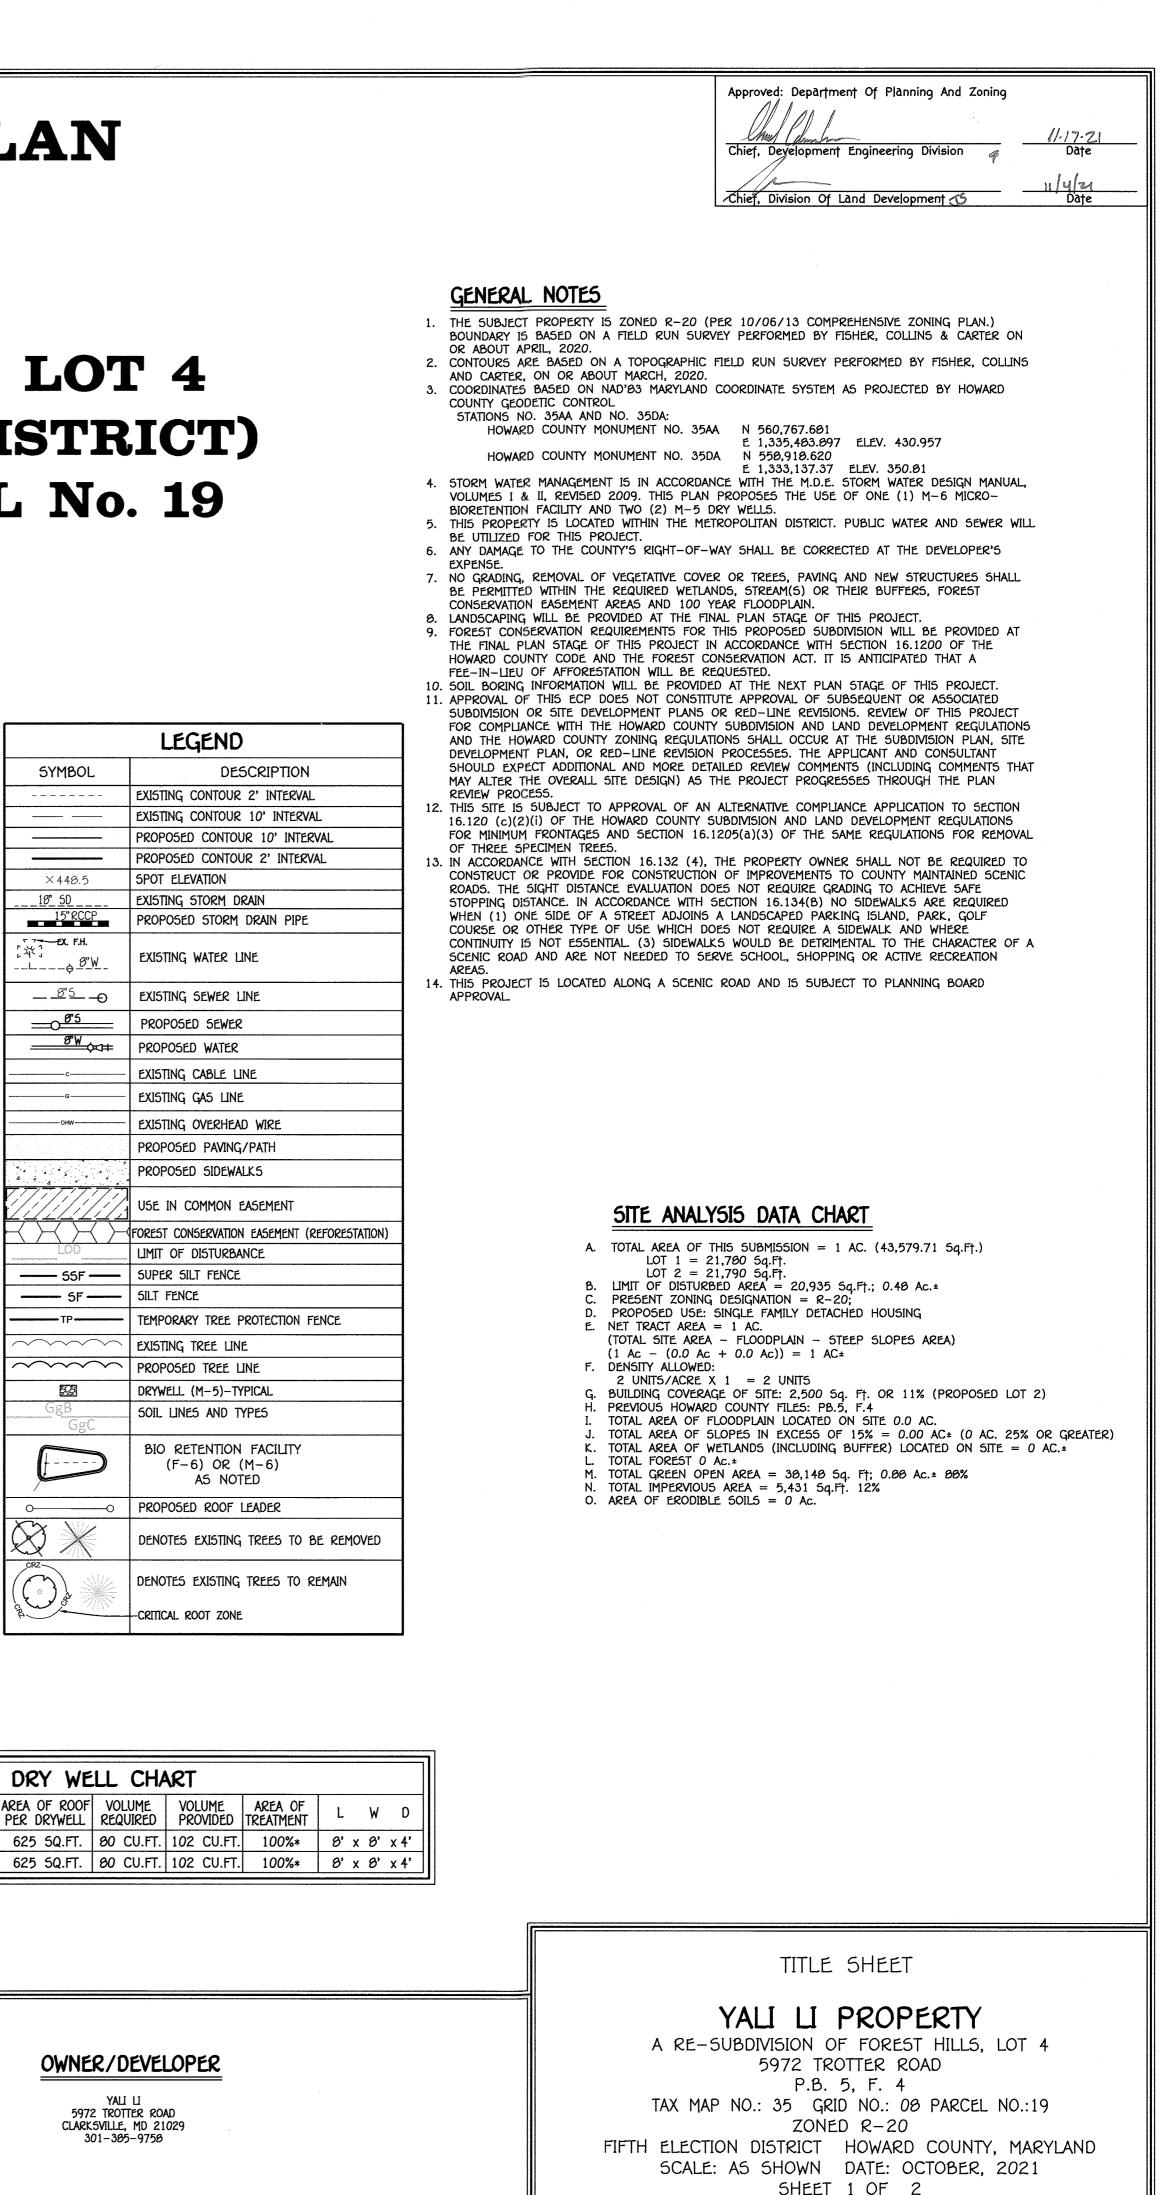

ECP-21-034

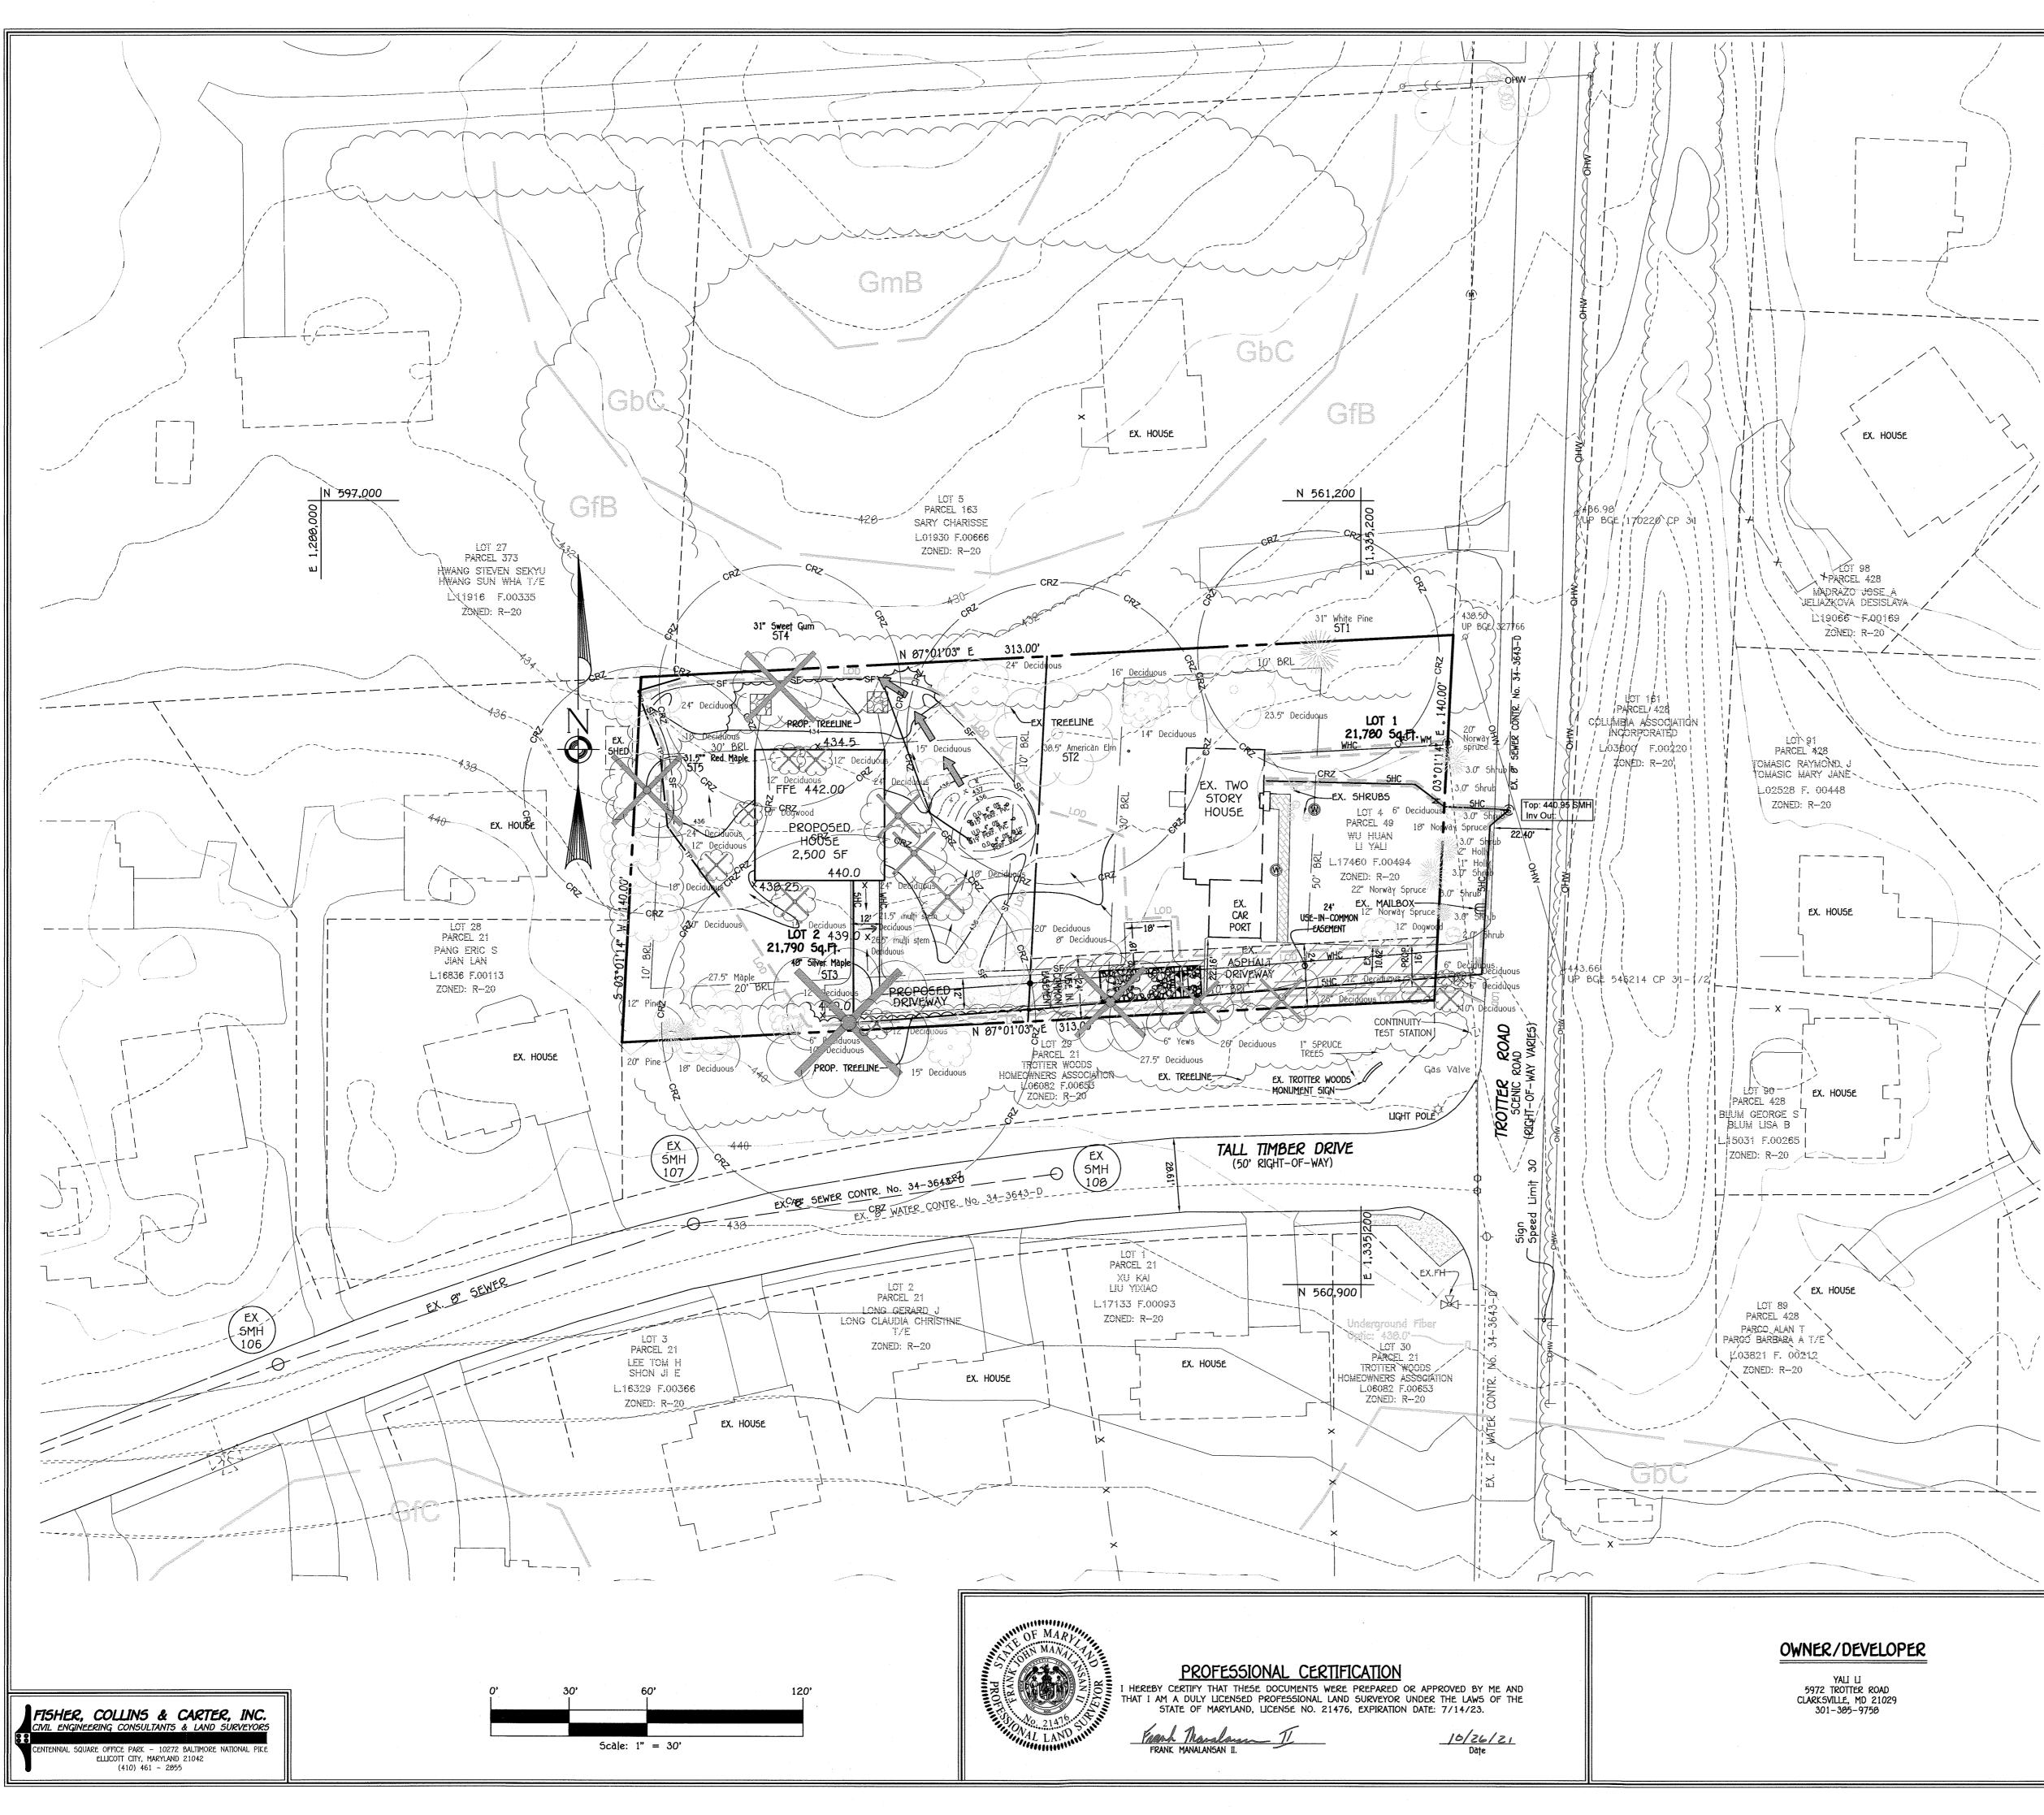

	LEGEND				
SYMBOL	DESCRIPTION				
	EXISTING CONTOUR 2' INTERVAL				
	EXISTING CONTOUR 10' INTERVAL				
	PROPOSED CONTOUR 10' INTERVAL				
	PROPOSED CONTOUR 2' INTERVAL				
×448.5	SPOT ELEVATION				
<u>18" 50</u>	EXISTING STORM DRAIN				
15" RCCP	PROPOSED STORM DRAIN PIPE				
· · · · · · · · · · · · · · · · · · ·	EXISTING WATER LINE				
<u>8"5</u> _O	EXISTING SEWER LINE				
<u>8°5</u>	PROPOSED SEWER				
\$7¥	PROPOSED WATER				
C	EXISTING CABLE LINE				
6	EXISTING GAS LINE				
OHW	EXISTING OVERHEAD WIRE				
	PROPOSED PAVING/PATH				
4	PROPOSED SIDEWALKS				
	USE IN COMMON EASEMENT				
$\prec \succ \prec \succ$	FOREST CONSERVATION EASEMENT (REFORESTATION)				
	LIMIT OF DISTURBANCE				
55F	SUPER SILT FENCE				
5F	SILT FENCE				
TP	TEMPORARY TREE PROTECTION FENCE				
~~~~~	EXISTING TREE LINE				
~~~~~	PROPOSED TREE LINE				
	DRYWELL (M-5)-TYPICAL				
GgB GgC	SOIL LINES AND TYPES				
	BIO RETENTION FACILITY (F-6) OR (M-6) A5 NOTED				
00	PROPOSED ROOF LEADER				
	······································				
\bigotimes \times	DENOTES EXISTING TREES TO BE REMOVED				
	DENOTES EXISTING TREES TO BE REMOVED DENOTES EXISTING TREES TO REMAIN				

Specimen Tree Chart

Key (X#)	Species	Size (in.dbh)	CRZ (feet radius)	Comments	Status	CRZ DISTURBANCE
1	White pine	31	46.5	Fair condition, leaning	to be retained	0%
2	American Elm	38.5	57.75	Fair condition, some dieback	to be retained	20.5%
3	Silver maple	48	72	Fair condition, multi-stem, some dieback	to be removed	39%
4	Sweet gum	31	46.5	Fair condition, heavy vine cover	to be removed	53%
5	Red maple	31.5	47.25	Fair condition, dieback in canopy	to be removed	35%

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A RE-SUBDIVISION OF FOREST HILLS, LOT 4 5972 TROTTER ROAD P.B. 5, F. 4 TAX MAP NO.: 35 GRID NO.: 08 PARCEL NO.:19 ZONED R-20 FIFTH ELECTION DISTRICT HOWARD COUNTY, MARYLAND

ENVIRONMENTAL CONCEPT PLAN AND

CONCEPTUAL SEDIMENT & EROSION CONTROL PLAN

YALI LI PROPERTY

SCALE: AS SHOWN DATE: OCTOBER, 2021 SHEET 2 OF 2 ECP-21-034

Approved: Department Of Planning And Zoning

Chief, Development Engineering Divisio

Chief, Division Of Land Development 5

1.17.21

Date