

J:\2799 Foxs Farm and Carroll Mill Farm\dwg\1024_1_1_2038.dwg, 2/21/2019 2:07:38 PM, jcarney

SWM DESIGN NARRATIVE:

FOR THESE DRAINAGE AREAS.

NATURAL RESOURCES SHALL BE PRESERVED, THERE ARE NO ENVIRONMENTALLY SENSITIVE AREAS (STEEP SLOPES, SPECIMEN TREES, WETLANDS, STREAMS AND THÈIR BUFFERS) WITHIN THE AFFECTED AREA. THE IMPERVIOUS AREA OF THE SITE IS MINIMIZED. SITING THE SWM PRACTICE NEAR THE DRIVEWAY, SHOWING A MINIMUM SIZE HOUSE BOX, UTILIZING A SHARED DRIVEWAY, AND KEEPING THE DRIVEWAY LENGTH AS MINIMAL AS POSSIBLE ARE ALL ARE CONDITIONS THAT REDUCE THE IMPERVIOUS ARFAS.

EXISTING FLOW PATTERNS SHALL BE MAINTAINED. UNDER ULTIMATE CONDITIONS MOST DRAINAGE FLOW SHALL EXIT THE PROPERTY AT THE SAME GENERAL LOCATION AS IT DOES UNDER EXISTING CONDITIONS. THERE ARE NO EXISTING POINT DISCHARGE LOCATIONS

IMPERVIOUS AREA IS BEING HELD TO A MINIMUM BY LOCATING THE PROPOSED LOT CLOSE TO PUBLIC ROAD ACCESS POINT AND UTILIZING THE MINIMUM WIDTH FOR DRIVEWAY.

THE TARGET Pe IS 1.0"; THE TARGET ESDV IS 1,505 CF; THE PROVIDED ESDV IS 1,308 CF.

SOME AREA OF SLOPES BETWEEN 15% AND 24.99% ARE BEING DISTURBED. THESE AREAS ARE ALONG THE UN-STABILIZED FARM TRAIL. THESE AREAS WILL BE REPLACED WITH DRIVEWAY, 5% OR FLATTER DISCONNECTION, AND SHORT 3:1 SLOPES. THE USE OF 3:1 SLOPES MINIMIZES THE FOOTPRINT OF THE DISTURBANCE AND THE USE OF PAVEMENT AND SWM DISCONNECT WILL STABILIZE THE FLAT AREAS. THE LOT RELOCATION ALSO MOVES THE HOUSE FROM AN AREA OF 15% TO 24.99% SLOPES TO AN AREA WITHOUT THOSE SLOPES.

THE FOREST CONSERVATION EASEMENTS WERE ESTABLISHED UNDER F-08-140 (CARROLL-ZIEGLER PROPERTY) AND UNDER F-94-107 (FOX'S FARM) TO FULFILL THE REQUIREMENTS OF SECTION 16.1200 THE HOWARD COUNTY CODE AND FOREST CONSERVATION ACT. ADDITIONAL EASEMENT AREA WAS CREATED UNDER F-11-060 (MARY CARTER CARROLL ET AL TO HOWARD COUNTY, MARYLAND) UNDER CAPITAL PROJECT NO. N-3971-6. ONE FOREST CONSERVATION EASEMENT IS BEING CREATED UNDER THE PLAT FOR THIS PLAN TO ADDRESS A SMALL AREA OF ABANDONMENT PER A REDLINE REVISION TO CARROLL-ZIEGLER PROPERTY, F-08-140. THE FOREST EASEMENT REMOVAL AND THE FOREST EASEMENT CREATION ARE TO BE SHOWN ON A REDLINE REVISION TO F-08-140 FINAL CONSTRUCTION PLANS. NO CLEARING, GRADING OR CONSTRUCTION IS PERMITTED WITHIN THE FOREST CONSERVATION EASEMENTS; HOWEVER, FOREST MANAGEMENT PRACTICES, AS DEFINED IN THE DEED OF FOREST CONSERVATION EASEMENT, ARE ALLOWED. FOX'S FARM RESUBDIVISION IS A RESUBDIVISION THAT DOES NOT CREATE ADDITIONAL LOTS; THEREFORE, IT IS EXEMPT FOR THE FOREST CONSERVATION ACT, SECTION 16.1202(b)(1)(vii)THE FOREST CONSERVATION ACT REQUIREMENTS ARE MET FOR THIS PROJECT. FOXES FARM SUBDIVISION, PLAT NUMBER 11379, PROVIDED 21,614 SF OF FOREST CONSERVATION TO SUPPORT THE ORIGINAL DEVELOPMENT NONE OF THAT FOREST CONSERVATION IS BEING BEING REMOVED UNDER THIS PROPOSED PROPERTY LINE REVISION. CARROLL ZIEGLER PROPERTY, PLAT NUMBERS 19354-19356, PROVIDED 6.42 ACRES OF FOREST CONSERVATION TO SUPPORT THE FUTURE DEVELOPMENT OF BULK PARCEL "F". CARROLL ZIEGLER PROPERTY PLAT NUMBER 21055-21059, PROVIDED 8.15 ACRES OF FOREST CONSERVATION TO SUPPORT THE DEVELOPMENT OF BULK PARCEL " INTO LOTS 2-7 AND PRESERVATION PARCELS. THE FOREST EASEMENT ON FOXES FARM IS NOT BEING DISTURBED. THE FOREST CONSERVATION EASEMENT CARROLL-ZIEGLER PROPERTY CREATED BY PLAT NUMBERS 19354-19356 IS NOT BEING DISTURBED. THE FOREST CONSERVATION EASEMENT ON CARROLL-ZEIGLER PROPERTY CREATED BY PLAT NUMBERS 21055-21059 IS BEING DISTURBED. AN AREA OF 0.02 ACRES OF THE AREA DESIGNATED AS FOREST CONSERVATION EASEMENT ON THE CONSTRUCTION PLAN, F-08-140, IS BEING DISTURBED AND IS

TO BE ABANDONED. MITIGATION WILL BE PROPOSED BY A REDLINE REVISION TO THOSE CONSTRUCTION PLANS. AN AREA OF 0.12 ACRES ON CARROLL-ZIEGLER PROPERTY IS TO BE CLEARED, THIS AREA WAS DESIGNATED AS "CLEARED" UNDER THE CONSTRUCTION PLAN FOR CARROLL-ZIEGLER PROPERTY, F-08-140, AND IS TO BE DISTURBED WITH THE FINAL CONSTRUCTION PLANS FOR THIS SINGLE LOT. THÉ DISTURBANCE TO THIS AREA CAN NOT BE AVOIDED DUE TO THE GRADING, DISCONNECTION CREDIT, DRIVEWAY WIDTH, SITE TOPOGRAPHY AND EASEMENT AREA FOR THESE IMPROVEMENTS.


SEDIMENT AND EROSION CONTROL SHALL BE PROVIDED. A SCHEMATIC CONCEPT IS SHOWN WITHIN THIS PLAN SET. IT IS ANTICIPATED THAT IT WILL CONSIST MAINLY OF SILT FENCE AND SUPER SILT FENCE ALONG THE PERIMETER. EROSION CONTROL MATTING SHALL BE USED FOR SWALES. THERE ARE NO IMPACTS TO SWM DESIGN BASED ON SEDIMENT AND EROSION CONTROL

THE PROPOSED MICRO-BIORETENTION FACILITY (M-6), THE DRY WELLS (M-5) AND NON-ROOFTOP DISCONNECTION (N-2) SHALL ADEQUATELY TREAT THE PROPOSED IMPERVIOUS AREAS. THE PRACTICES SHALL DISCHARGE AT LOCATIONS THAT ARE NOT DETRIMENTAL TO THE ADJACENT PROPERTIES, INLETS SHALL BE PLACED IN THE MICRO-BIORETENTION FACILITY SO HIGHER STORMS WILL FLOW TO THE UNDERDRAIN PIPE. FULL TREATMENT IS BEING PROVIDED THEREFORE THIS PROJECT CAN BE CONSIDERED TO BE TREATED TO THE MAXIMUM EXTENT PRACTICAL.

| Site Analysis Data Sheet | |
|---|---------|
| | |
| Gross Area | 8.69 ac |
| 100yr Floodplain | 0.00 ac |
| Steep Slopes 15% or greater | 0.49 ac |
| Steep Slopes 25% or greater | 0.20 ac |
| Wetlands (outside of floodplain) | 0.00 ac |
| Wetlands Buffer (outside of floodplain) | 0.00 ac |
| Stream | 0 lf |
| Stream Buffer (outside floodplain) | 2.43 ac |
| Forested Area | 0.41 ac |
| Erodable Soils | 0.68 ac |
| Limit of Disturbance | 1.35 ac |
| Impervious Area | 0.25 ac |

DESIGN: JC DRAWN: BEI

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NOTES: EXISTING ZONING: RR-DEO

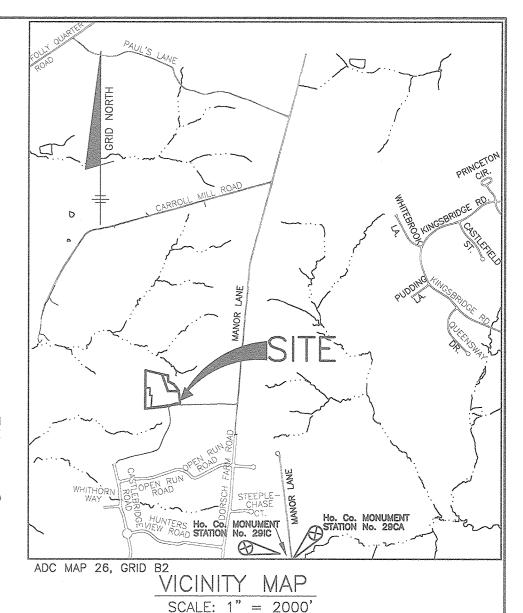- DEED REFERENCE: 3376/00496
- SITE ANALYSIS DATA: A. TOTAL AREA OF SITE (LOT 2 AND PARCEL A): 8.69 AC. • EXISTING IMPERVIOUS ÀREA: 0.32 AC. • EXISTING GREEN AREA: 8.69 AC.
- EXISTING FORESTED AREA: 0.41 AC.
- EXISTING SITE USE: FARM FIELD AREA OF PLAN SUBMISSION: 8.69 AC.
- LIMIT OF DISTURBANCE: 1.35 AC. CONSTRUCTION, 2.5 ACCESS AND CONSTRUCTION
- IMPERVIOUS AREA: 0.25 AC. • REVEGETATED AREA: 1.10 AC
- PROPOSED USE: 1 SINGLE FAMILY DETACHED RESIDENCE PREVIOUS SUBMITTAL: F-94-107, F-07-185, F-06-228, F-08-140, F-15-061, F-08-109, SP-07-005, SP-06-019, F-07-022, F-11-050, WP-17-125
- 4. THIS LOT WILL UTILIZE A CUSTOM SEDIMENT AND EROSION PLAN SINCE THE LIMIT OF DISTURBANCE EXCEEDS THE 30,000 SQUARE FEET THRESHOLD STORMWATER MANAGEMENT FOR THIS PROPOSAL IS PROVIDED
- WITH THE APPROVAL OF THE ENVIRONMENTAL CONCEPT PLAN AND MAY BE REVISED WITH THE FINAL PLANS & BUILDING
- THERE ARE NO EXISTING DWELLINGS ON SITE. THERE ARE TWO BARNS ON PARCEL A TO REMAIN. THERE IS ONE TRAILER ON PARCEL A THAT IS TO BE REMOVED.
- TO THE BEST OF OUR KNOWLEDGE AND BELIEF THERE ARE NO CEMETERIES OR HISTORIC STRUCTURES ONSITE.
- ON JUNE 15, 2017 THE DIRECTOR OF THE DEPARTMENT OF PLANNING AND ZONING REVIEWED A REQUEST FOR AN ALTERNATIVE COMPLIANCE (WP-17-125) OF SECTION 16.120(b)(4)(ii) AND SECTION 16.120(c)(2) AND REQUESTED
- ADDITIONAL INFORMATION. FOREST CONSERVATION IS NOT REQUIRED SINCE THIS IS A RE-SUBDIVISION THAT CREATES NO ADDITIONAL LOTS. SEE SECTION 16.1202(B)(1)(v
- 10. FOREST CONSERVATION ADDRESSED PREVIOUSLY UNDER F-94-107 AND F-08-140. APPROVAL OF THIS FCP DOFS NOT CONSTITUTE AN APPROVA
- OF ANY SUBSEQUENT AND ASSOCIATED SUBDIVISION PLAN/PLAT AND/OR SITE DEVELOPMENT PLAN AND/OR RED-LINE REVISION PLAN. REVIEW OF THIS PROJECT FOR COMPLIANCE WITH THE HOWARD COUNTY SUBDIVISION AND LAND DEVELOPMENT REGULATIONS SHALL OCCUR AT THE SUBDIVISION PLAN/PLAT AND/OR SITE DEVELOPMENT PLAN STAGES AND/OR RED-LINE REVISION PROCESS. THE APPLICANT AND CONSULTANT SHOULD EXPECT ADDITION AND MORE DETAILED REVIEW COMMENTS
- INCLUDING COMMENTS THAT MAY ALTER THE OVERALL SITE DESIGN) AS THIS PROJECT PROGRESSES THROUGH THE PLAN **REVIEW PROCESS** 12. FOX'S FARM, PRESERVATION PARCEL A IS ENCUMBERED WITH A PRESERVATION EASEMENT HELD BY HOWARD COUNTY, MARYLAND,
- AND HOWARD COUNTY CONSERVANCY. THE RESTRICTIONS AND PERMITTED USES ASSOCIATED WITH THIS EASEMENT ARE SPECIFIED WITHIN THE DEED OF PRESERVATION EASEMENT RECORDED AT LIBER 3379 AT FOLIO 591, DATED JULY 14, 1994. THE PRESERVATION EASEMENT IS SUBJECT TO TITLE 15, SUBTITLE 5 OF THE HOWARD COUNTY CODE, AND SECTION 106.0 OF THE HOWARD COUNTY ZONING REGULATIONS. THE DEVELOPER INTENDS TO REVISE THE EASEMENT LIMITS BY INCLUDING THE AREA THAT IS CURRENTLY LOT 2, THE AREA CLOSEST TO THE STREAM THAT INCLUDES STEEP SLOPES, AND BY REMOVING THE AREA JUST WEST OF DEVELOPED LOT 1. THE REVISION WILL BE IN ACCORDANCE WITH THE REQUIREMENTS OF ZONING REGULATIONS SECTIONS 104.0.G(1) 104.0.G(4) AND 106.1. THE CHANGE IN EASEMENT AREA WILL NOT RESULT IN ADDITIONAL UNITS OR USES THAT ARE NOT PERMITTED, IT WILL RESULT IN A BETTER EASEMENT CONFIGURATION AND BETTER PROTECTION FOR THE SLOPES AND STREAM AREAS. THE HOLDER OF THE EASEMENT, HOWARD COUNTY CONSERVANCY.
- INC., HAS PREVIOUSLY OFFERED A LETTER OF SUPPORT FOR RECONFIGURATION TO MOVE THE LOT AWAY FROM THE BARNS AND CLOSER TO EXISTING HOMES.

| | NO. | DATE | | | REVISION | | | |
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| | | engin E 8480 Baltimore | NGINEERI NATIONAL PIKE & SUITE 31 | ING, INC. 15 A ELLICOTT CITY, MARYLAND 21043 F) 410-465-6644 | | | I am a duly licensed e State of Maryland, | |
| | OWNE | DEVELOPER CARROLL-ZIEC NATALIE 4888 CASTL ELLICOTT CIT | AND OWNER GLER PARCEL Q: C. ZIEGLER EBRIDGE ROAD Y, MD. 21042 40-6880 | PLAT No. 1 | IVISON OF LOT 2 AN 1379 INTO LOT 3 AI CARROLL-ZIEGLER P | ND PRES | FARM SERVATION PARCEL 'A' AS SERVATION PARCEL 'A-1 Y PARCEL Q AS SHOWN 3192-23195 | ', REVISION TO |
| | | 2 AND NATALIE C. JOHN H. | FARM LOTS 1, PARCEL A: ZIEGLER AND ZIRSCHKY E ROADELLICOTT CITY, | TAX MAP: 23, GRID: 10, P/O PARCELS: 130 & 131, ZONED: RC-DEO ELECTION DISTRICT NO. 3 HOWARD COUNTY, MARYLAND | | | | D: RC-DEO |
| D SOILS MAP | | MD. WNER CARROLL | -ZIEGLER LOT 5 & CEL P: | COVER | | | L CONCEPT PLAN DITIONS PLAN AND | SOILS MAP |
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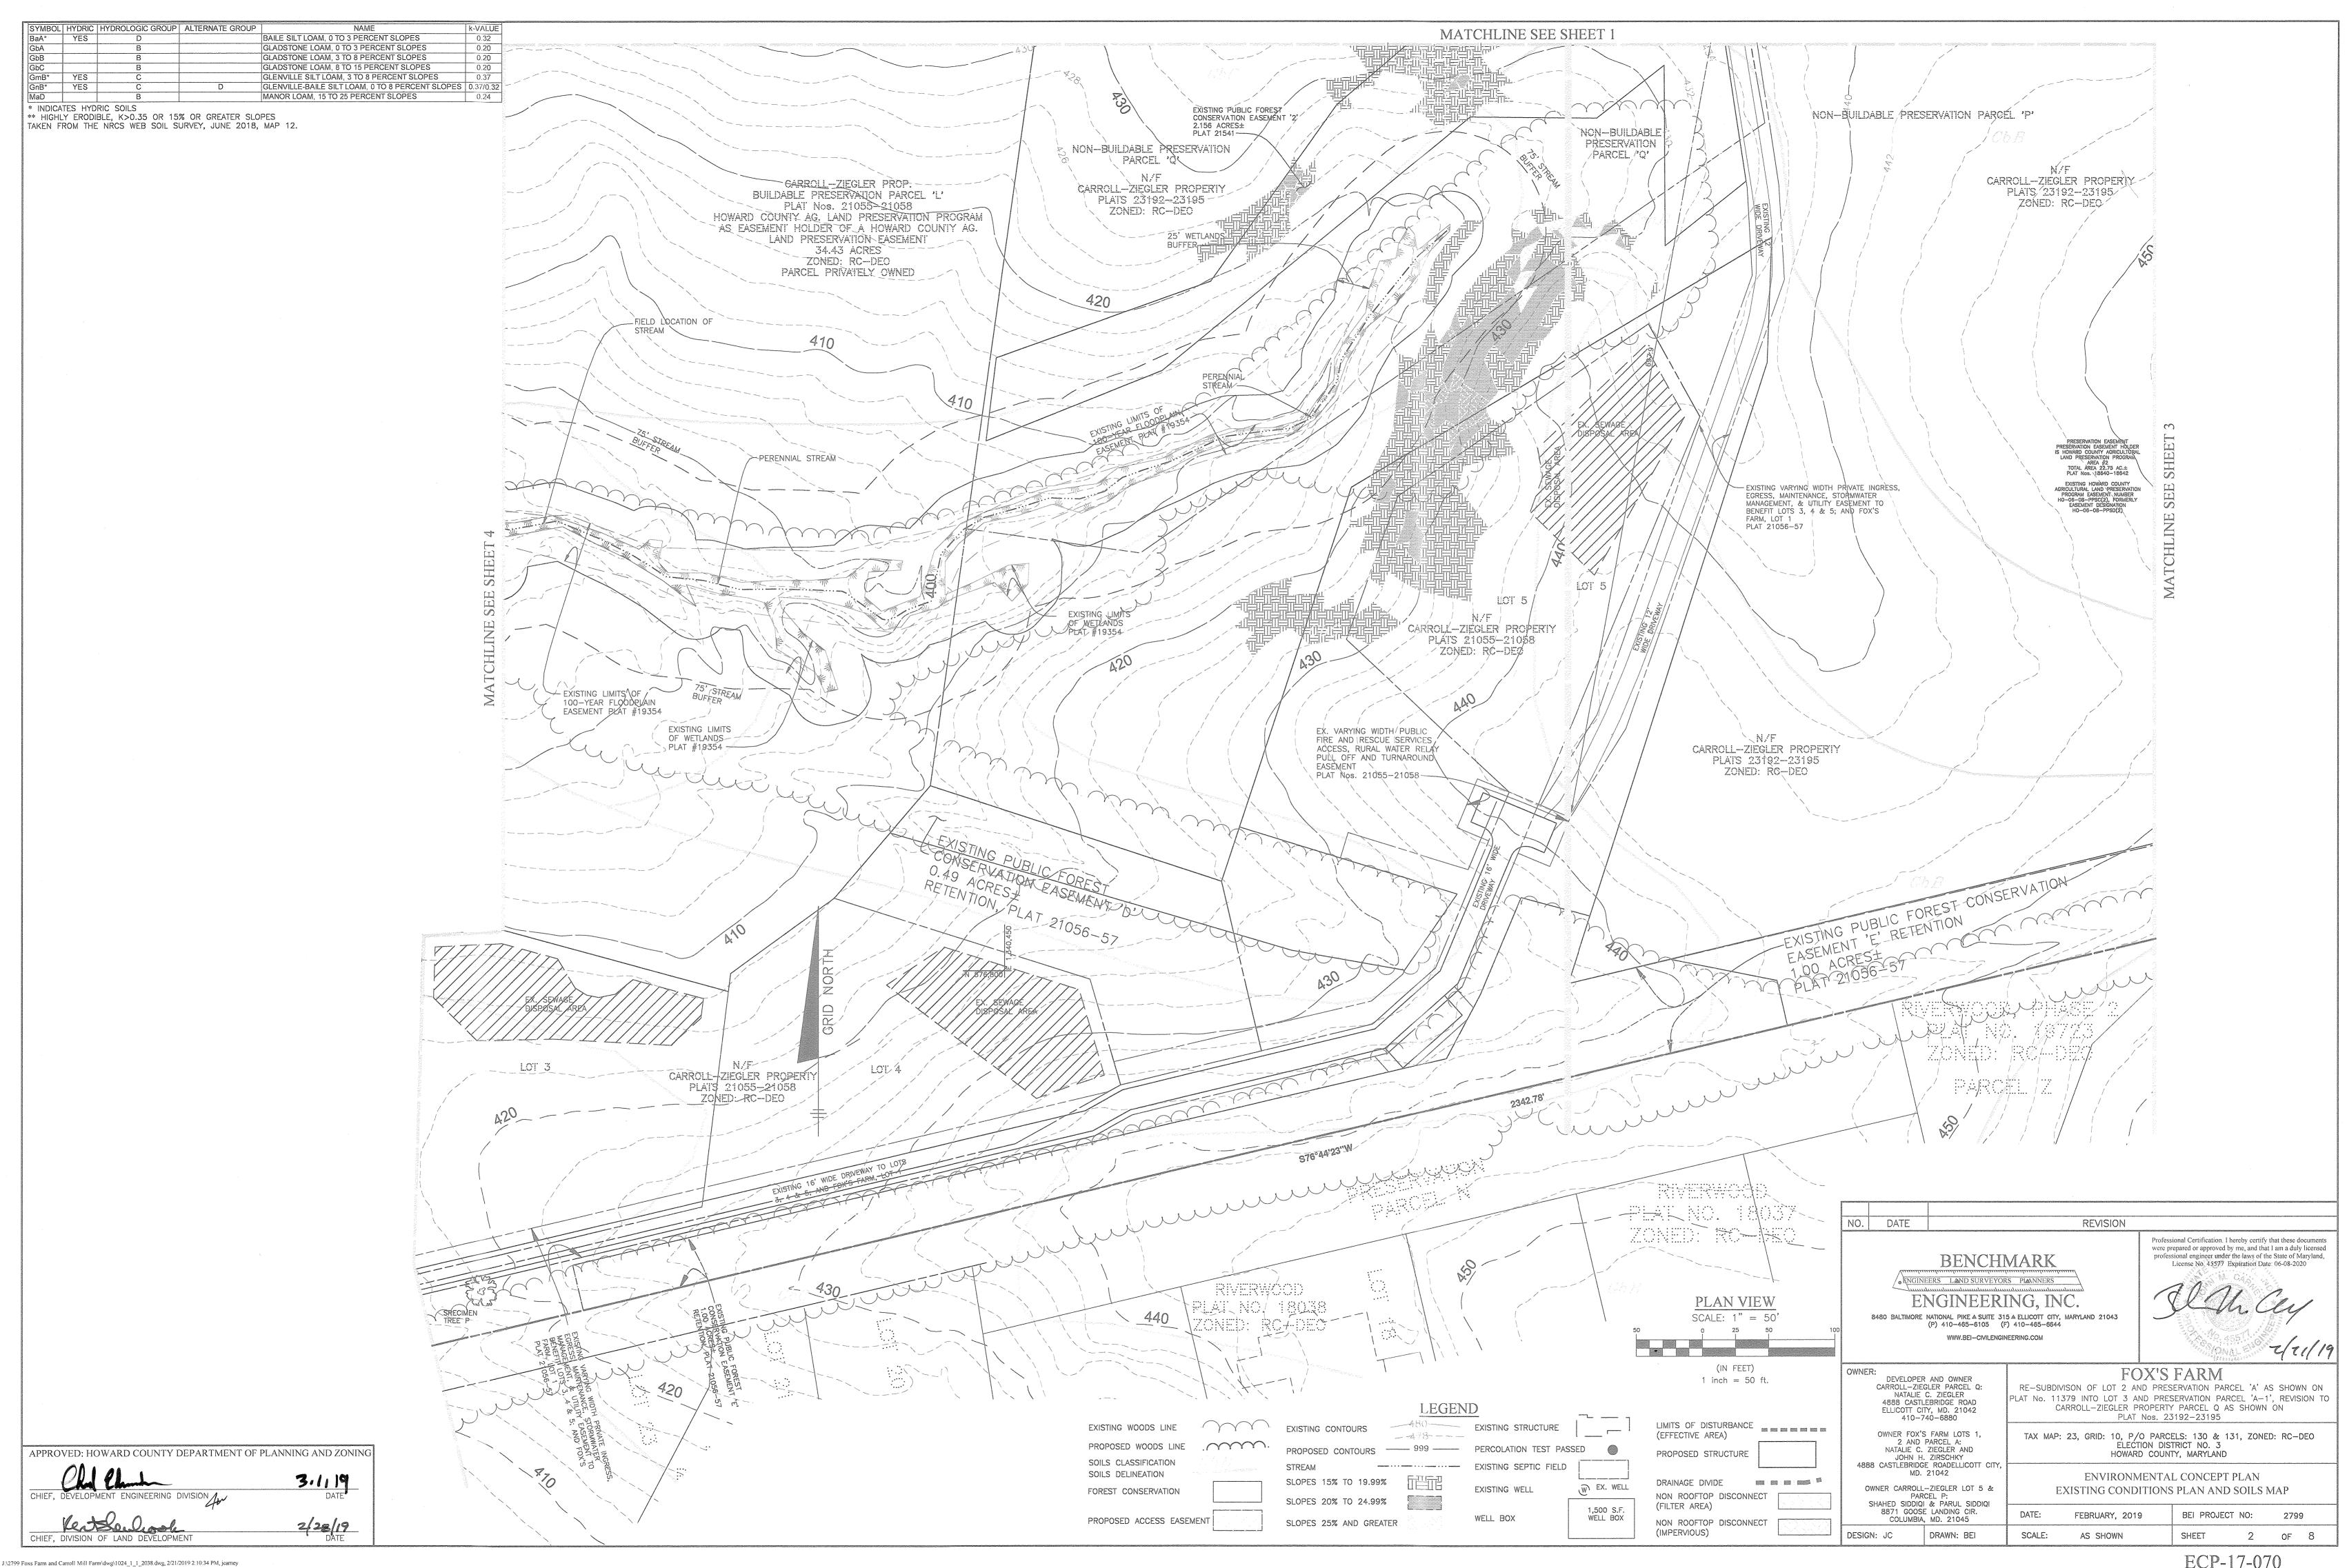
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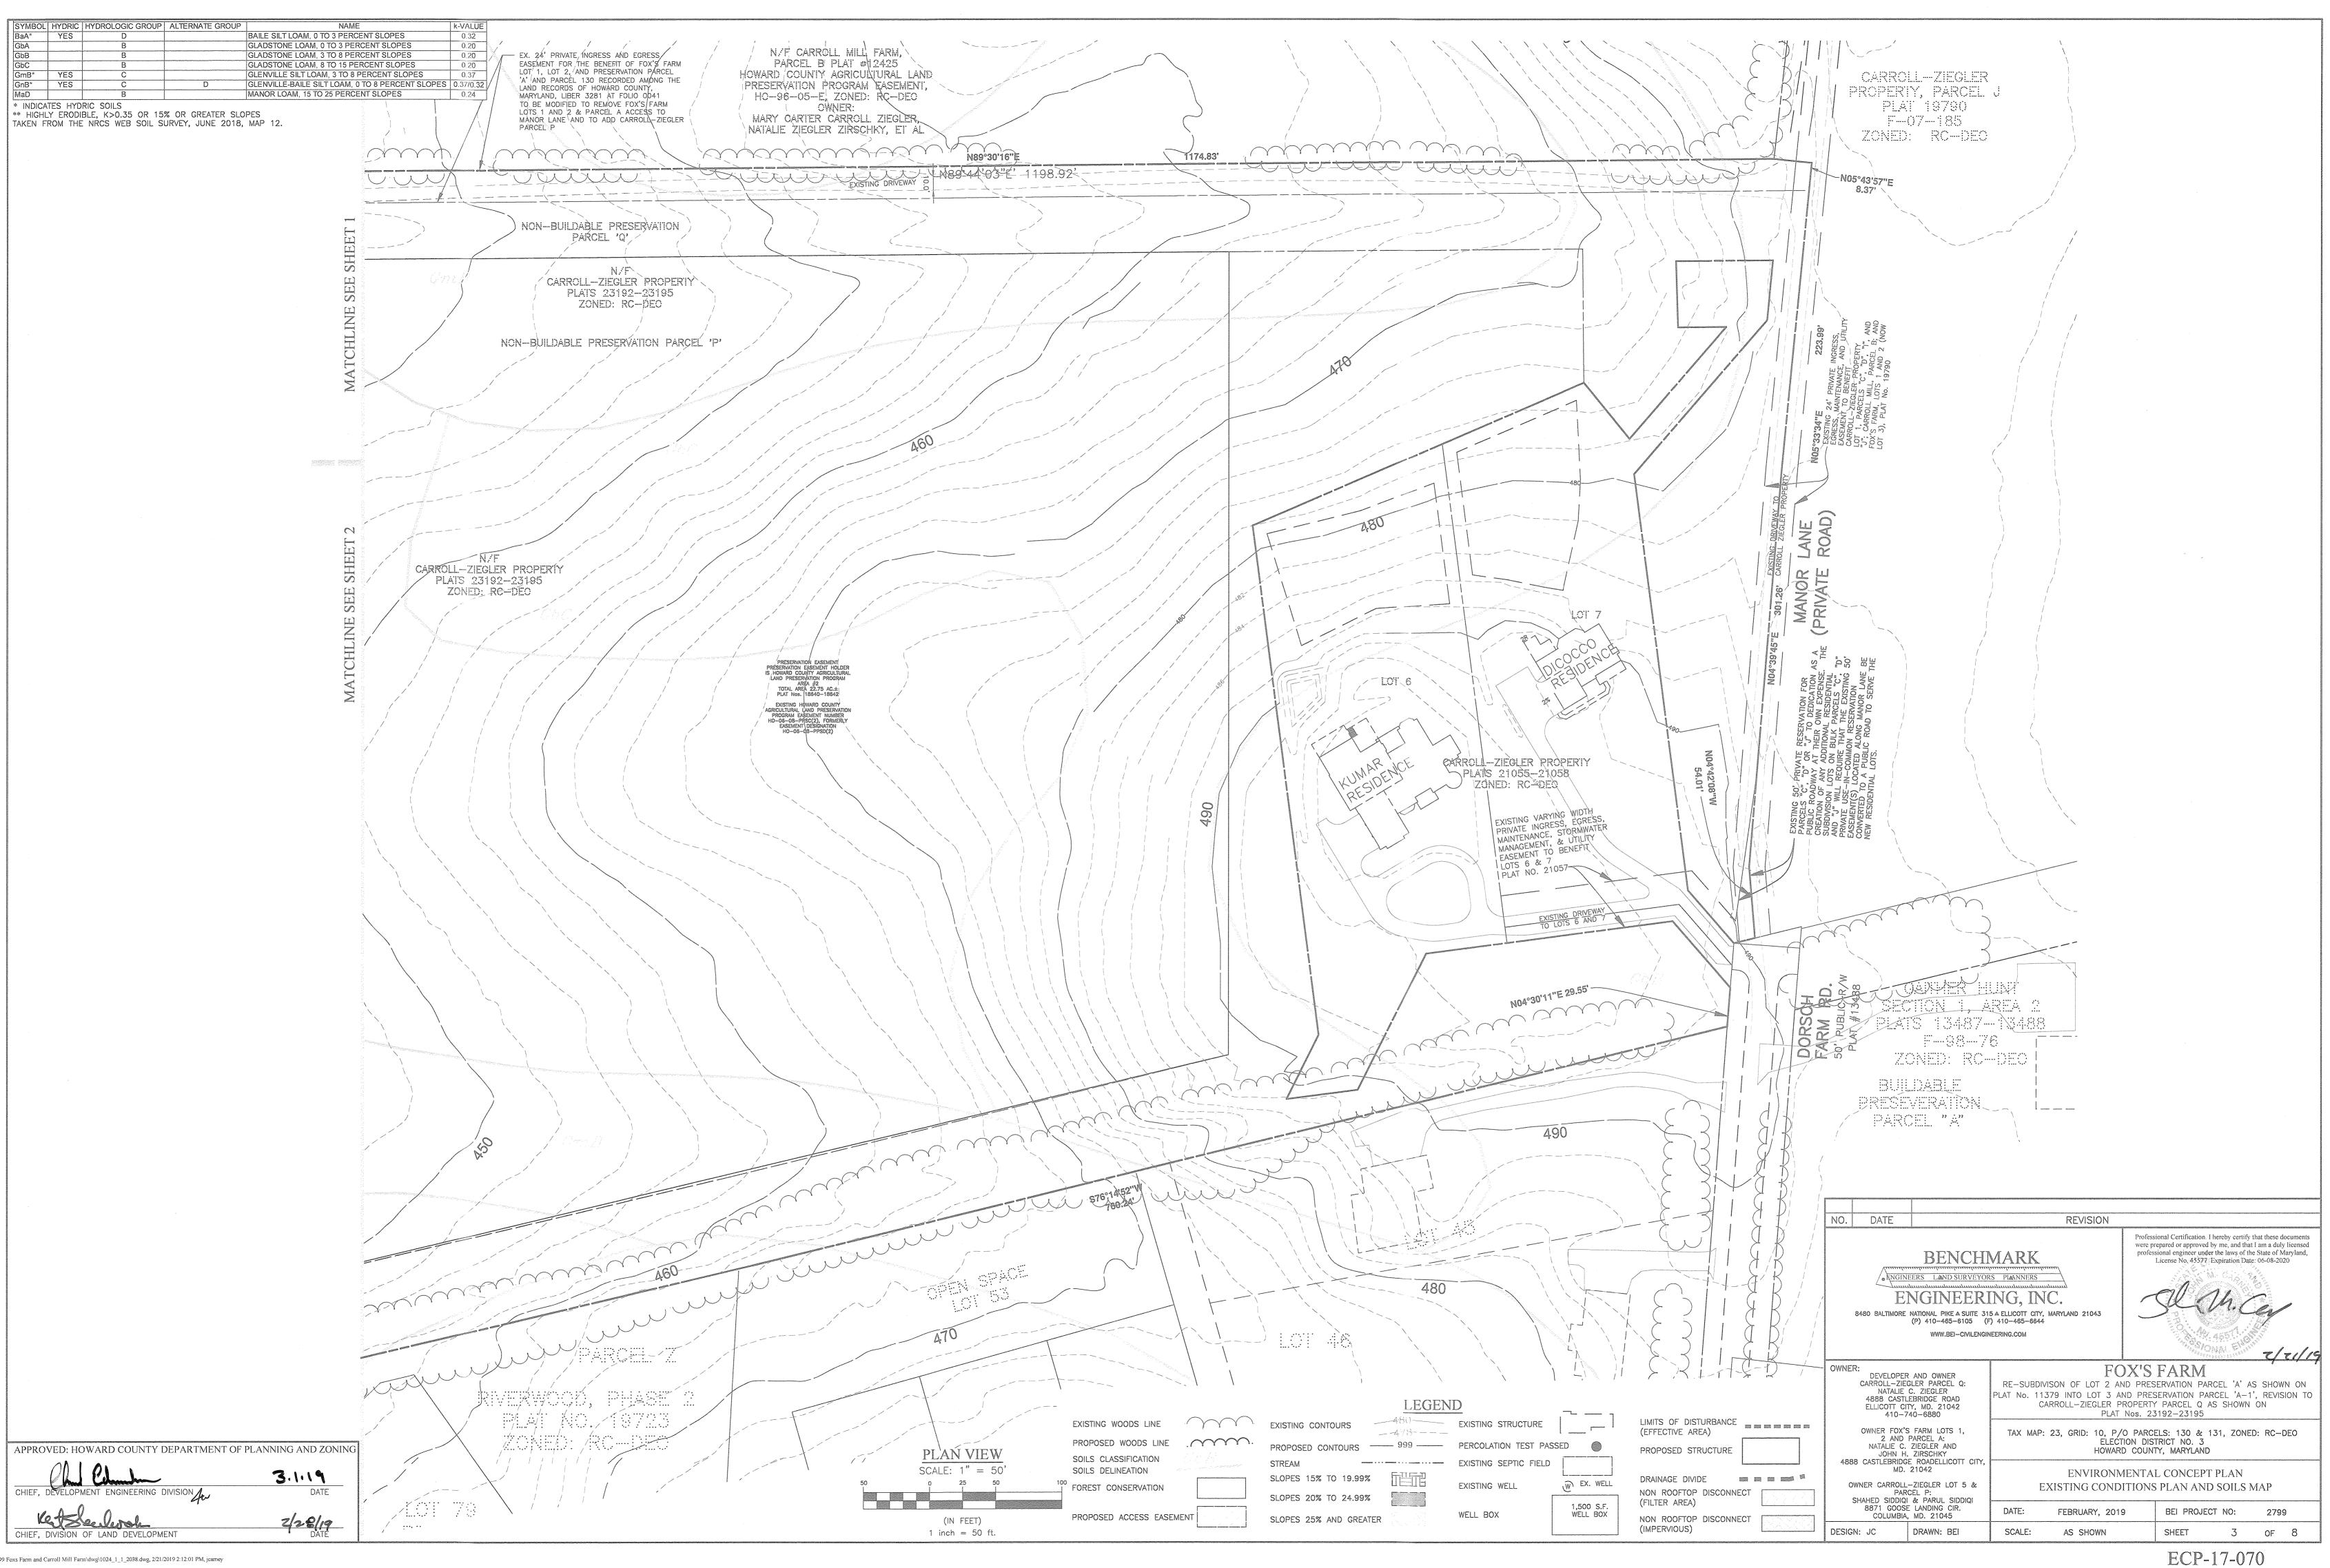
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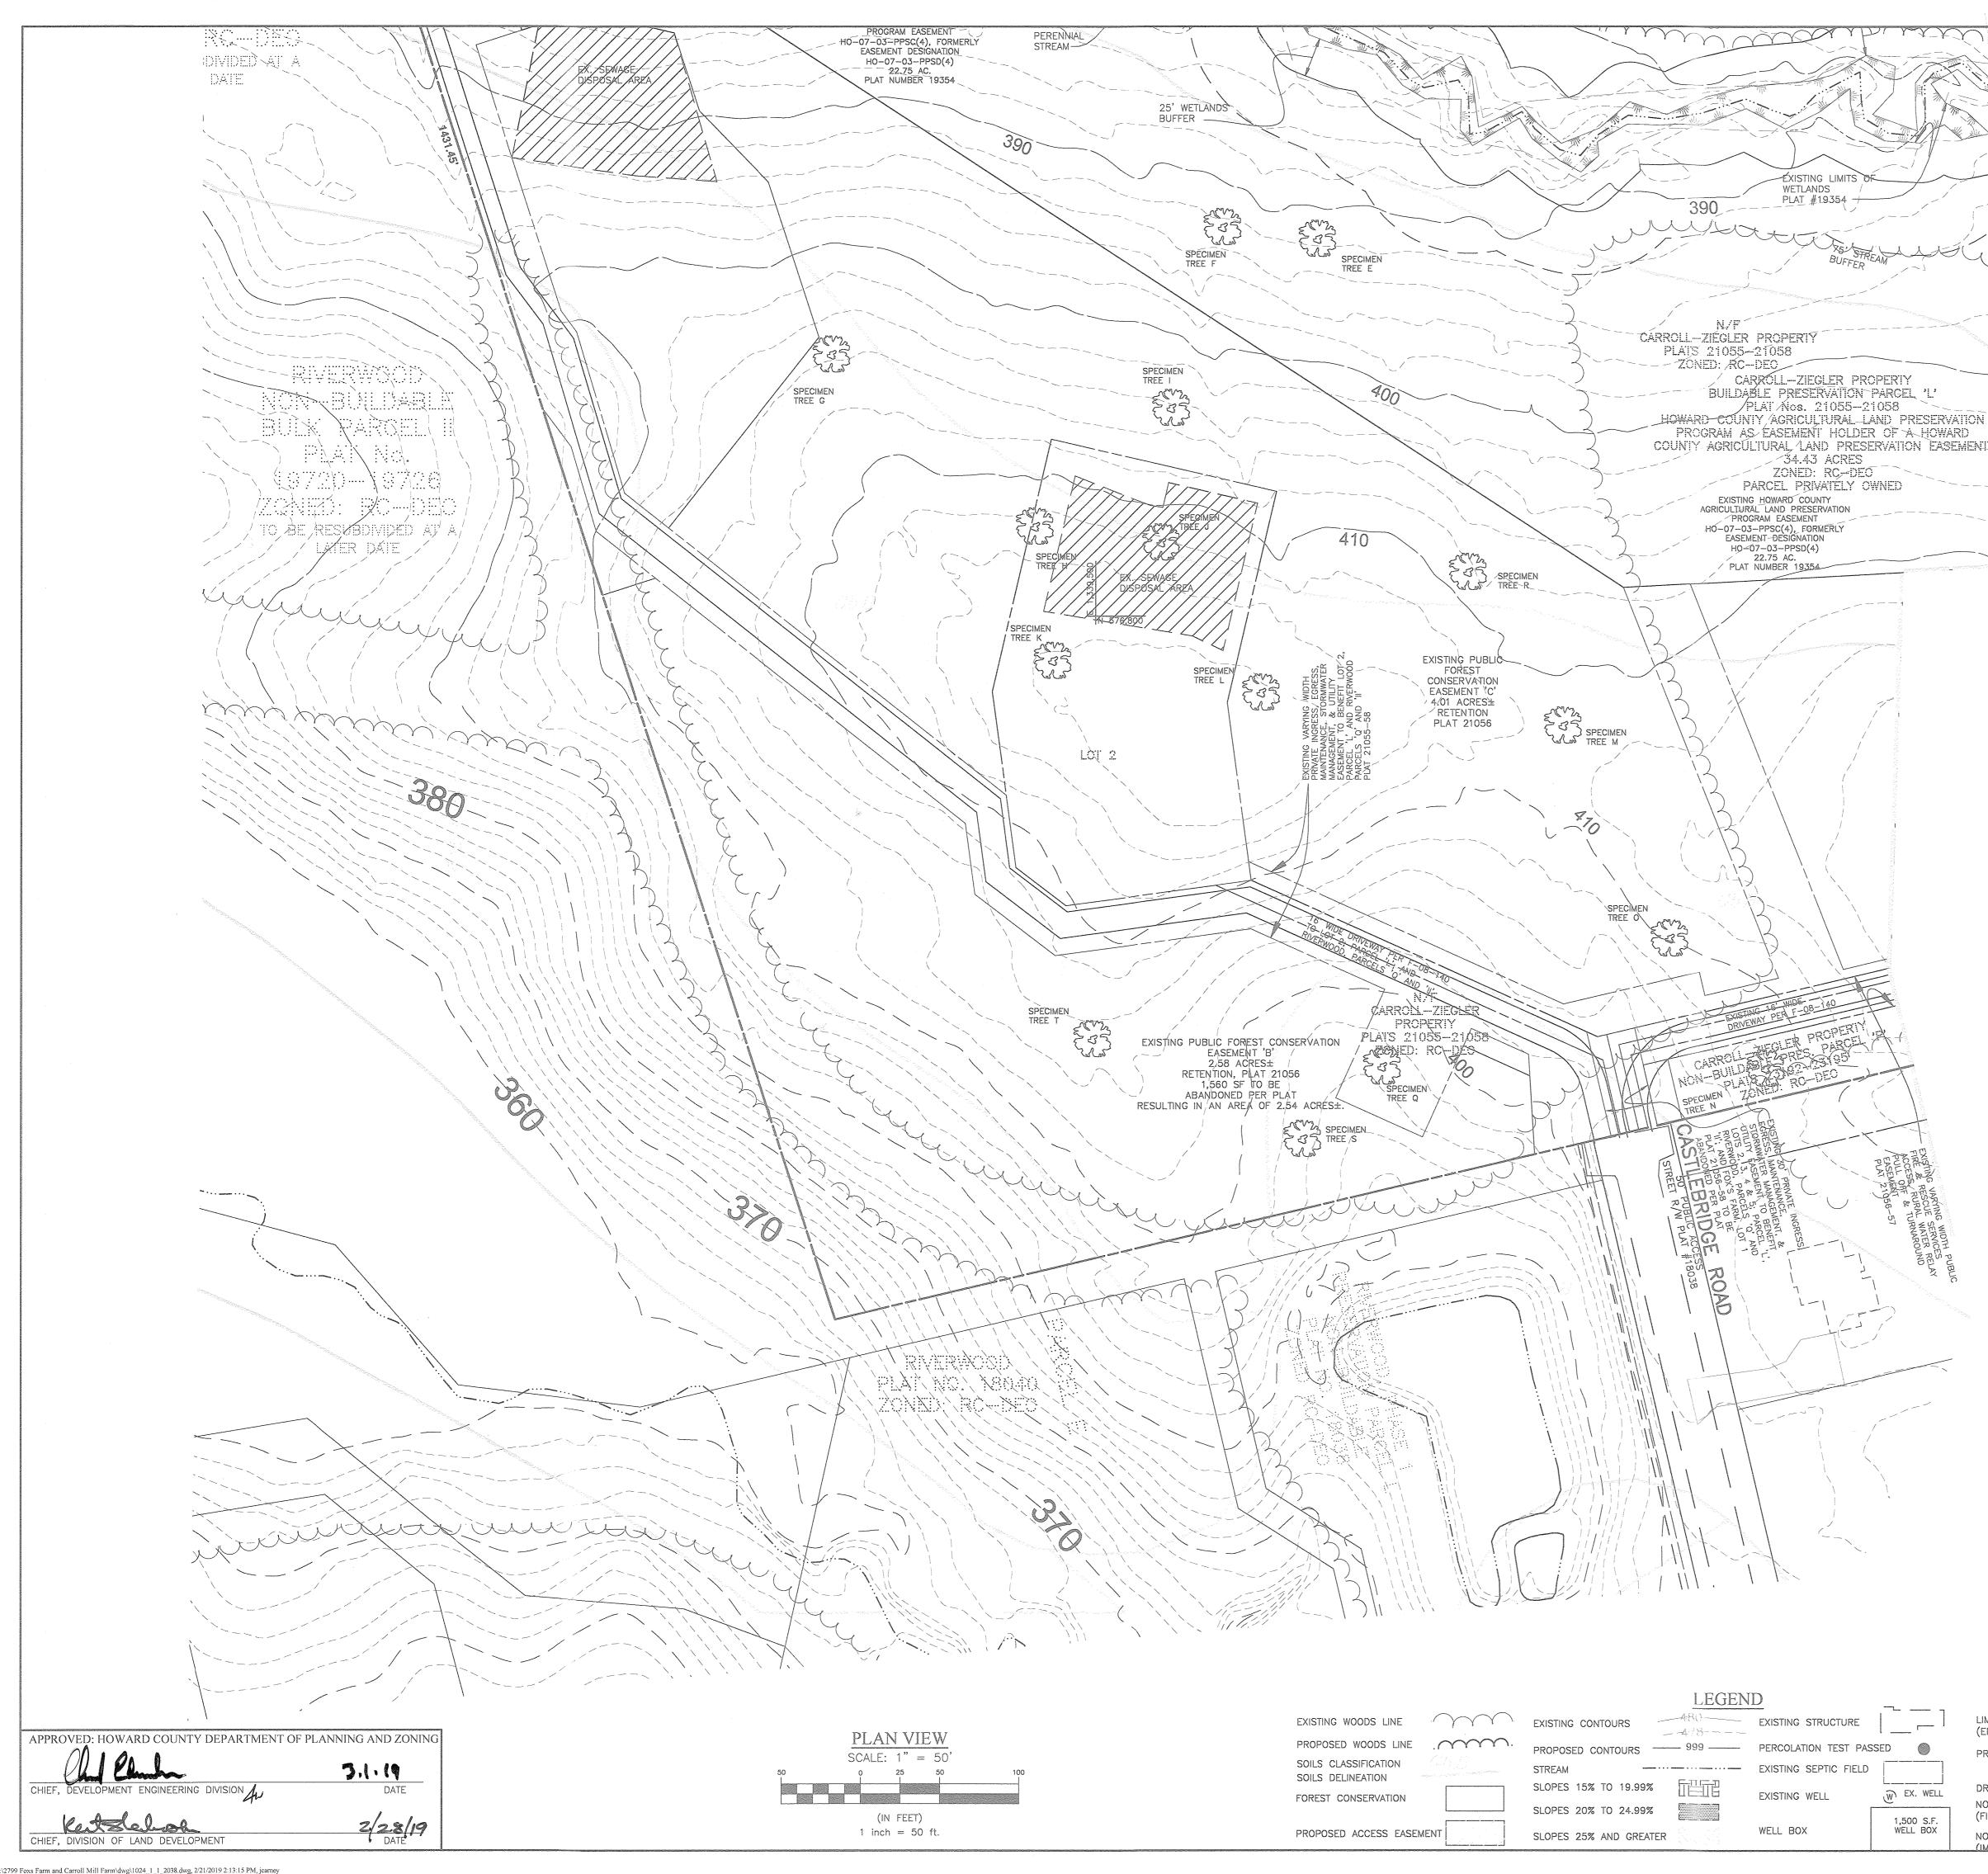
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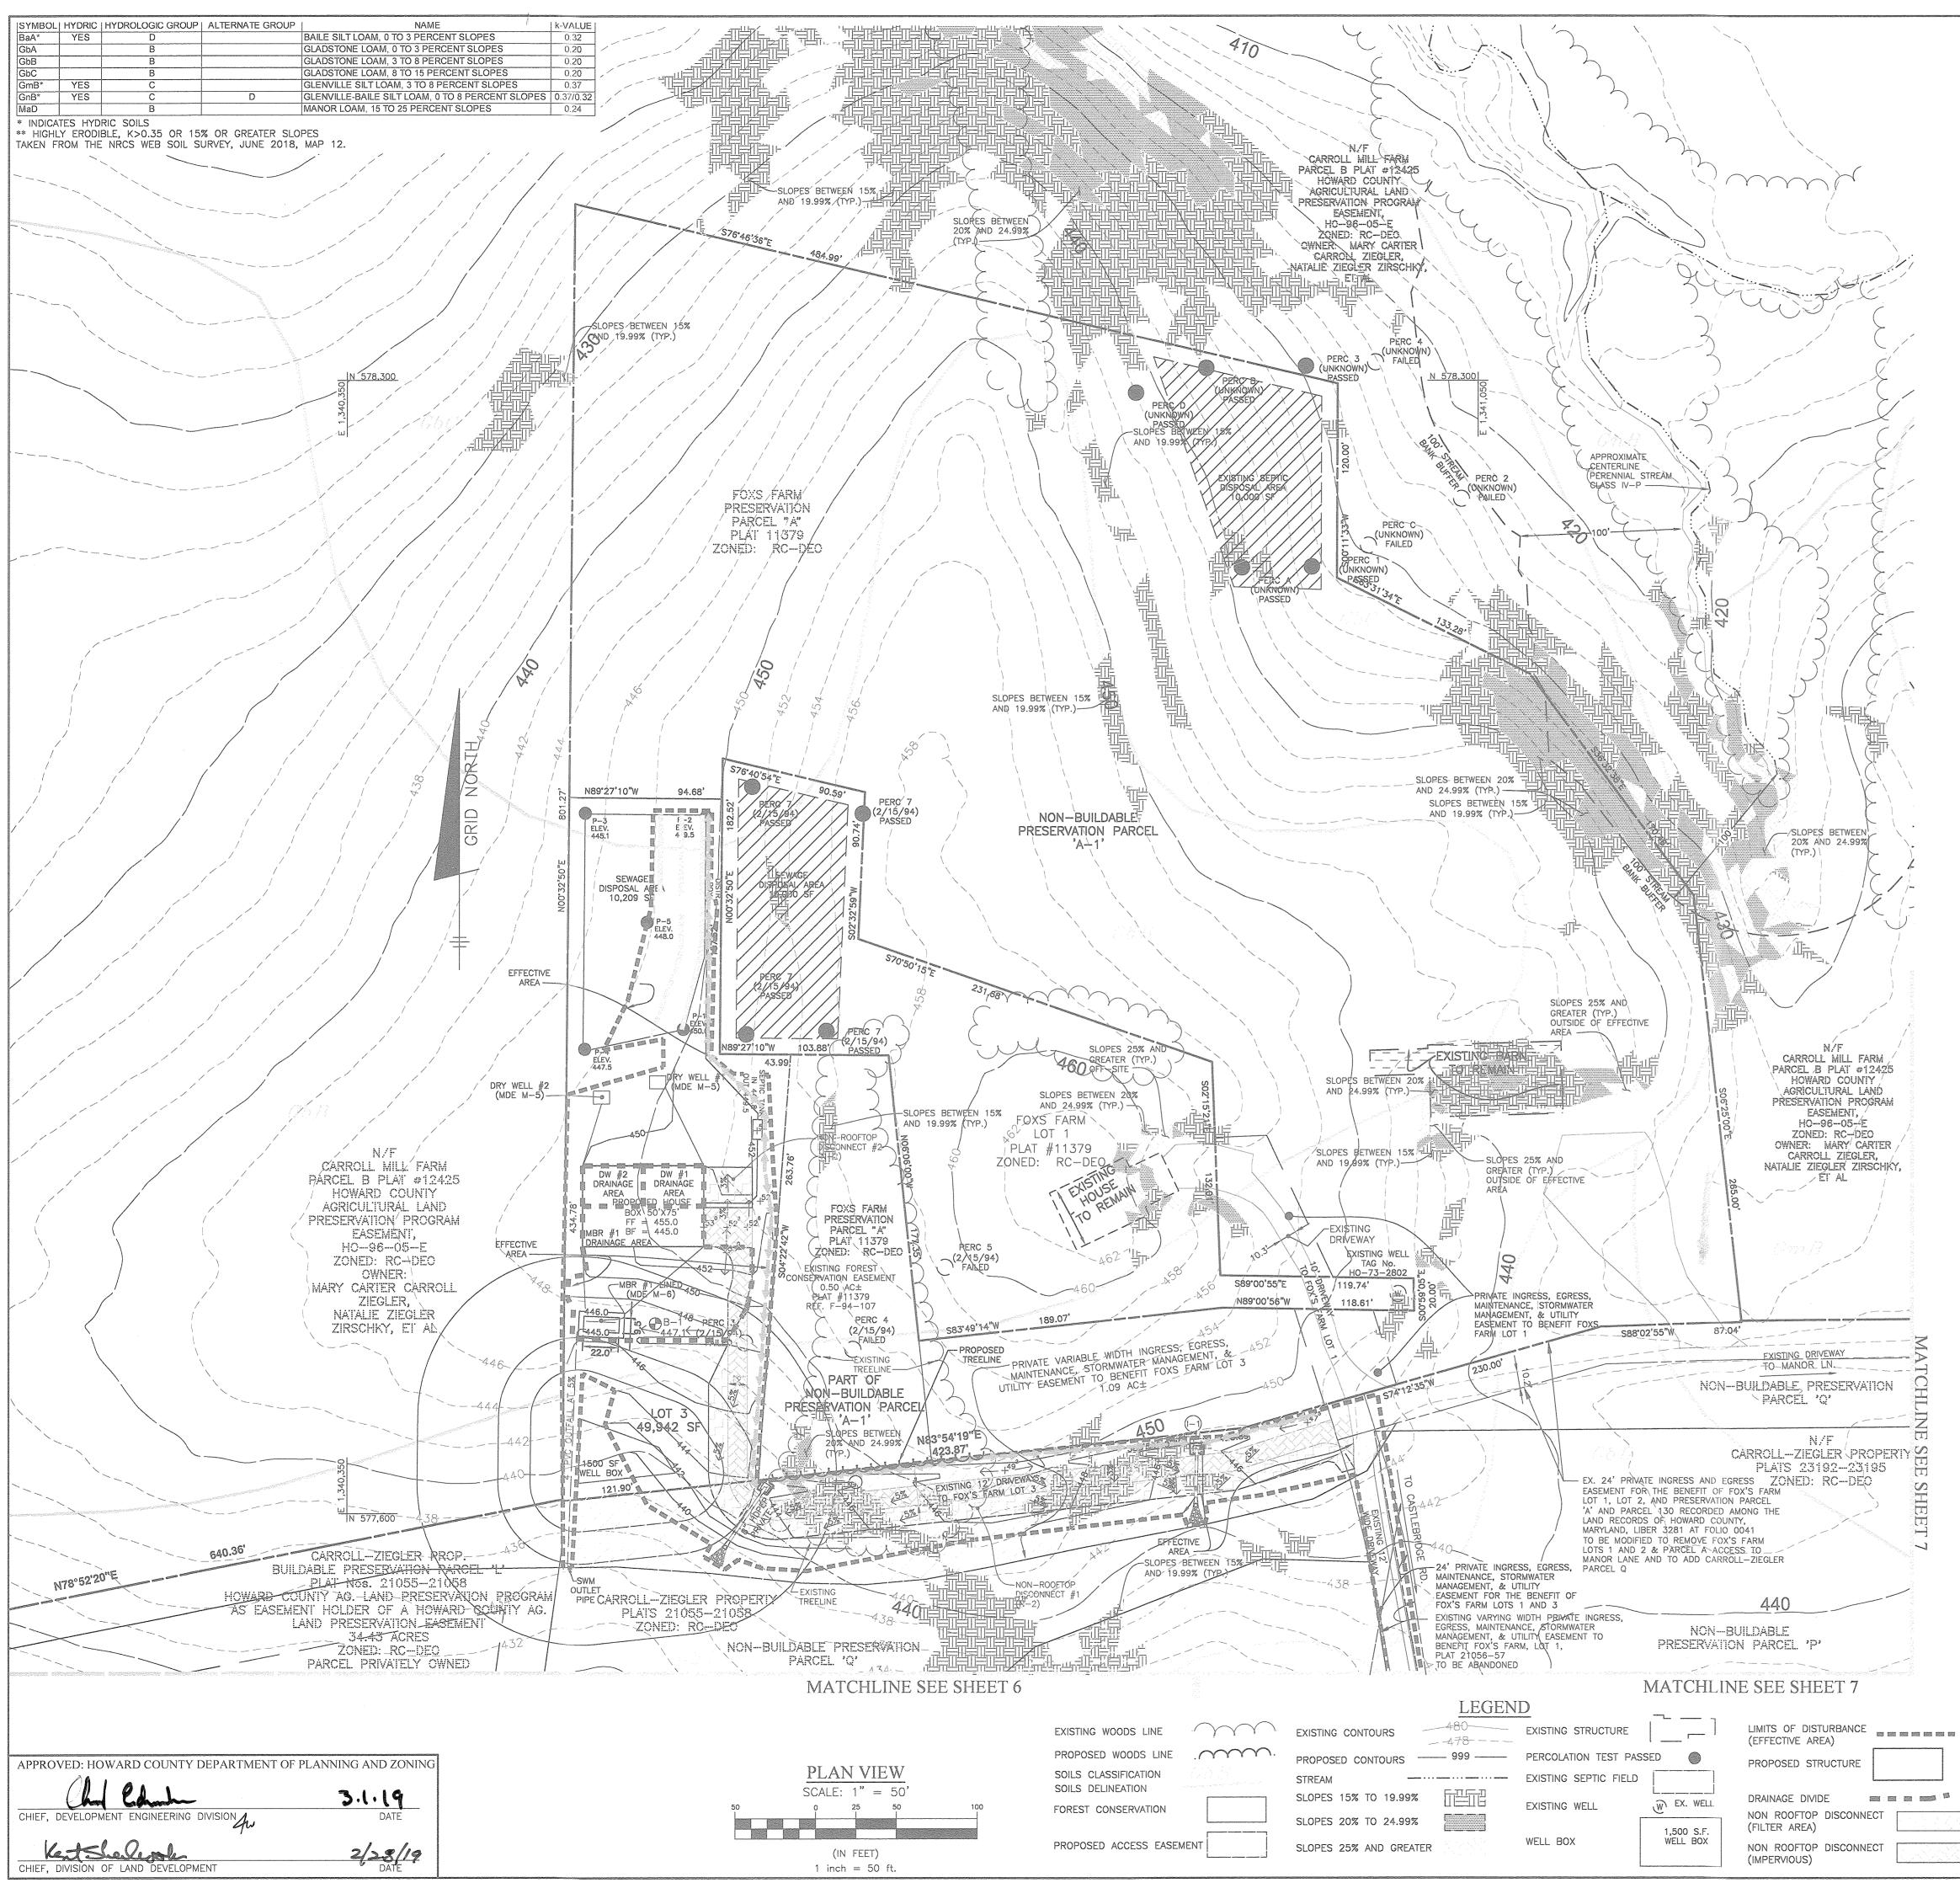
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| SYMBOL | HYDRIC | HYDROLOGIC GROUP | ALTERNATE GROUP | NAME | k-VALU | | | | |
| BaA* | YES | D | | BAILE SILT LOAM, 0 TO 3 PERCENT SLOPES | | | | | |
| GbA | | В | | GLADSTONE LOAM, 0 TO 3 PERCENT SLOPES | 0.20 | | | | |
| GbB | | В | | GLADSTONE LOAM, 3 TO 8 PERCENT SLOPES | 0.20 | | | | |
| GbC | | В | | GLADSTONE LOAM, 8 TO 15 PERCENT SLOPES | 0.20 | | | | |
| GmB* | YES | С | | GLENVILLE SILT LOAM, 3 TO 8 PERCENT SLOPES | 0.37 | | | | |
| GnB* | YES | С | D | GLENVILLE-BAILE SILT LOAM, 0 TO 8 PERCENT SLOPES | 0.37/0.3 | | | | |
| MaD | | В | | MANOR LOAM, 15 TO 25 PERCENT SLOPES | 0.24 | | | | |
| | | | | | | | | | |
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vere prepared or approved by me, and that I am a duly license professional engineer under the laws of the State of Maryland, License No. 45577 Expiration Date: 06-08-2020 BENCHMARK ANGINEERS LAND SURVEYORS PLANNERS ENGINEERING, INC. 8480 BALTIMORE NATIONAL PIKE & SUITE 315 & ELLICOTT CITY, MARYLAND 21043 (P) 410-465-6105 (F) 410-465-6644 WWW.BEI-CIVILENGINEERING.COM 2/24/19 FOX'S FARM OWNER: DEVELOPER AND OWNER CARROLL-ZIEGLER PARCEL Q: NATALIE C. ZIEGLER 4888 CASTLEBRIDGE ROAD ELLICOTT CITY, MD. 21042 410-740-6880 RE-SUBDIVISON OF LOT 2 AND PRESERVATION PARCEL 'A' AS SHOWN ON AT No. 11379 INTO LOT 3 AND PRESERVATION PARCEL 'A-1', REVISION TO CARROLL-ZIEGLER PROPERTY PARCEL Q AS SHOWN ON PLAT Nos. 23192-23195 OWNER FOX'S FARM LOTS 1, 2 AND PARCEL A: NATALIE C. ZIEGLER AND JOHN H. ZIRSCHKY 4888 CASTLEBRIDGE ROADELLICOTT CITY, TAX MAP: 23, GRID: 10, P/O PARCELS: 130 & 131, ZONED: RC-DEO ELECTION DISTRICT NO. 3 HOWARD COUNTY, MARYLAND (EFFECTIVE AREA) PROPOSED STRUCTURE MD. 21042 ENVIRONMENTAL CONCEPT PLAN OWNER CARROLL-ZIEGLER LOT 5 & PARCEL P: SHAHED SIDDIQI & PARUL SIDDIQI 8871 GOOSE LANDING CIR. COLUMBIA, MD. 21045 EXISTING CONDITIONS PLAN AND SOILS MAP DRAINAGE DIVIDE NON ROOFTOP DISCONNECT BEI PROJECT NO: 2799 DATE: FEBRUARY, 2019 (FILTER AREA) NON ROOFTOP DISCONNECT DESIGN: JC SHEET DRAWN: BEI SCALE: AS SHOWN 4 OF 8 IMPERVIOUS)

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| | - | DA | Imp Area | % | Rv | | Af (sf) | | ES | Dv | Pe | Rev (a | :-ft) | |
|---------------------------|-------------|--------|----------|------|------|----------|----------|--------|----------|----------|----------|----------------------------|----------|-----------|
| Practice | teantrology | (sf) | (sf) | Imp | i.v | Required | Provided | 2% DA? | Required | Provided | Provided | Required | Provided | Ownershij |
| (M-6) Micro Bio-Retention | 5986 | 11,802 | 2,476 | 21% | 0.24 | 120 | 209 | FAIL | 211 | 429 | 1.83 | | 0.0023 | Private |
| (M-5) Drywell | #1 | 938 | 938 | 100% | 0.95 | NA | NA | NA | 74 | 160 | 2.15 | 0 101 | 0.0037 | Private |
| (M-5) Drywell | #2 | 938 | 938 | 100% | 0.95 | NA | NA | NA | 74 | 160 | 2.15 | Overall Site Obligation | 0.0037 | Private |
| Non-Rooftop Discon. | NR-1 | 11,802 | 5,986 | 51% | 0.51 | NA | NA | NA | 498 | 498 | 1.00 | | 0.0114 | Private |
| Non-Rooftop Discon. | NR-2 | 1,482 | 732 | 49% | 0.49 | NA | NA | NA | 61 | 61 | 1.00 | | 0.0014 | Private |

918 1308 1.39 0.0061 0.0225 Totals per Whole Site 1505 1308 221

> OPERATION AND MAINTENANCE SCHEDULE FOR MICRO-BIORETENTION (M-6)

- 1. THE OWNER SHALL MAINTAIN THE PLANT MATERIAL, MULCH LAYER AND SOIL LAYER ANNUALLY. MAINTENANCE OF MULCH AND SOIL IS LIMITED TO CORRECTING AREAS OF EROSION OR WASH OUT. ANY MULCH REPLACEMENT SHALL BE DONE IN THE SPRING. PLANT MATERIAL SHALL BE CHECKED FOR DISEASE AND INSECT
- SPRING. PLANT MATERIAL SHALL BE CHECKED FOR DISEASE AND INSECT INFESTATION AND MAINTENANCE WILL ADDRESS DEAD MATERIAL AND PRUNING. ACCEPTABLE REPLACEMENT PLANT MATERIAL IS LIMITED TO THE FOLLOWING: 2000 MARYLAND STORMWATER DESIGN MANUAL VOLUME II, TABLE A.4.1 AND 2.
 2. THE OWNER SHALL PERFORM A PLANT IN THE SPRING AND IN THE FALL OF EACH YEAR. DURING THE INSPECTION, THE OWNER SHALL REMOVE DEAD AND DISEASED VEGETATION CONSIDERED BEYOND TREATMENT, REPLACE DEAD PLANT MATERIAL WITH ACCEPTABLE REPLACEMENT PLANT MATERIAL, TREAT DISEASED TREES AND SHRUBS, AND REDLACE ALL DEFICIENT STATES AND WIRES AND REPLACE ALL DEFICIENT STAKES AND WIRES.
- 3. THE OWNER SHALL INSPECT THE MULCH EACH SPRING. THE MULCH SHALL BE REPLACED EVERY TWO TO THREE YEARS. THE PREVIOUS MULCH LAYER SHALL BE REMOVED BEFORE THE NEW LAYER IS APPLIED.
 4. THE OWNER SHALL CORRECT SOIL EROSION ON AN AS NEEDED BASIS, WITH A MINIMUM OF ONCE PER MONTH AND AFTER EACH HEAVY STORM.
- OPERATION AND MAINTENANCE SCHEDULE FOR PRIVATELY OWNED AND MAINTAINED STORMWATER DRY WELLS (M-5)
- 1. THE MONITORING WELLS AND STRUCTURES SHALL BE INSPECTED ON A QUARTERLY BASIS AND AFTER EVERY LARGE STORM EVENT.
- 2. WATER LEVELS AND SEDIMENT BUILD UP IN THE MONITORING WELLS SHALL BE RECORDED OVER A PERIOD OF SEVERAL DAYS TO INSURE TRENCH DRAINAGE. 3. A LOG BOOK SHALL BE MAINTAINED TO DETERMINE THE RATE AT WHICH THE
- FACILITY DRAINS.
- 4. WHEN THE FACILITY BECOMES CLOGGED SO THAT IT DOES NOT DRAIN DOWN WITHIN A. Determine Pre-Developed Conditions THE 72 HOUR TIME PERIOD, CORRECTIVE ACTION SHALL BE TAKEN.
 THE MAINTENANCE LOG BOOK SHALL BE AVAILABLE TO HOWARD COUNTY FOR INSPECTION TO INSURE COMPLIANCE WITH OPERATION AND MAINTENANCE CRITERIA.
- 6. ONCE THE PERFORMANCE CHARACTERISTICS OF THE INFILTRATION FACILITY HAVE BEEN VERIFIED, THE MONITORING SCHEDULE CAN BE REDUCED TO AN ANNUAL BASIS UNLESS THE PERFORMANCE DATA INDICATES THAT A MORE FREQUENT

OPERATION AND MAINTENANCE SCHEDULE FOR PRIVATELY OWNED AND MAINTAINED DISCONNECTION OF ROOFTOP RUNOFF (N-1), DISCONNECTION OF NON-ROOFTOP RUNOFF (N-2)

A. MAINTENANCE OF AREAS RECEIVING DISCONNECTED RUNOFF IS GENERALLY NO DIFFERENT THAN THAT REQUIRED FOR OTHER LAWN OR LANDSCAPED AREAS. THE OWNER SHALL ENSURE THE AREAS RECEIVING RUNOFF ARE PROTECTED FROM COMPACTION OR DEVELOPMENT OF IMPERVIOUS AREA. IN COMMERCIAL AREAS, FOOT **B. Determine Initial Target Pe Using Table 5.3** TRAFFIC SHOULD BE DISCOURAGED AS WELL.

| ESD/Site Data Summary | | | | | | | | | | |
|------------------------|-------------------|-------------|-------------|------|--|--|--|--|--|--|
| Name of Development: | | Fox's | Farm (2799) | SWM | | | | | | |
| Watershed: | rshed: Fox's Farm | | | | | | | | | |
| Watershed Designation: | 2-13-11-06 | Class: | IV-P | | | | | | | |
| Area of Site: | 106,863 | 5986 | 11802 | | | | | | | |
| Impervious Cover: | 14,124 | square feet | Percent: | 13% | | | | | | |
| Area of A soils: | 0 | square feet | Percent: | 0% | | | | | | |
| Area of B soils: | 106,863 | square feet | Percent: | 100% | | | | | | |
| Area of C Soils: | 0 | square feet | Percent: | 0% | | | | | | |
| Area of D Soils | 0 | square feet | Percent: | 0% | | | | | | |
| Target RCN: | 55 | | | | | | | | | |
| Target Pe: | 1.00 | inches | | | | | | | | |
| Achieved Pe: | 1.39 | inches | pass | 139% | | | | | | |
| Target ESDv. | 1505 | cubic feet | | | | | | | | |
| Achieved ESDv. | 1308 | cubic feet | - | 87% | | | | | | |
| Target Rev. | 0.0061 | ac-ft | | | | | | | | |
| Achieved Rev. | 0.0225 | ac-ft | pass | 371% | | | | | | |
| Required Qf: | 0 | cubic feet | | | | | | | | |
| Provided Qf: | 0 | cubic feet | N/A | N/A | | | | | | |

Total Site Step 1: Determine ESD Implementation Goals

Soil Conditions for "Woods in Good Condition"


| HSG | RCN | *Area (ft2) | Percent |
|------------|-----|-------------|---------|
| Ą | 38 | 0 | 0% |
| В | 55 | 106863 | 100% |
| C | 70 | 0 | 0% |
| D | 77 | 0 | 0% |
| Target RCN | 55 | 106863 | |

| ESD - SWM PRACTICES | | | | | | | | |
|---------------------|--|--------------------------------|--|---|--|--|--|--|
| · LOT NUMBER | ADDRESS | DRY WELLS (M-5) QUANTITY | NON-ROOFTOP DISC. (N-2) QUANTITY | | | | | |
| 3 | CASTLEBRIDGE ROAD ELLICOTT CITY MD, 21042 | 1 | 2 | 2 | | | | |

| Soil Conditions Developed Condition | | | | | | | | | | | |
|-------------------------------------|---------------|----------------|---------------|---------------|--|--|--|--|--|--|--|
| HSG | *Area (ft2) | *Impervious | Percent** | Target Pe | | | | | | | |
| A | | | | | | | | | | | |
| В | 106863 | 14,124 | 15% | 1.0 | | | | | | | |
| С | | | | | | | | | | | |
| D | | | | | | | | | | | |
| Weighted Pe | 106863 | 14124 | 15% | 1.0 | | | | | | | |
| * Percent Imper | vious is rour | nded to the ne | ext higher in | crement of 5% | | | | | | | |

D. Compute Qe

Qe = Runoff depth used to size ESD practices Qe = Pe * Rv

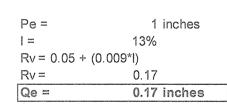


1 inches Target Pe = Qe =


0.17 inches ESDv = 1505 cubic feet


| Total S | ite Rech | arge Vo | lume | Calcul | ations | |
|----------|--------------|--|----------|---|--------------|-----------------|
| Recharge | Volume | #10.12712/04.42012.00.0092134810************************************ | | | | |
| Drainage | Area = m | ain site | | | | |
| A = | 2.45 A | rea in Acres | | | | |
| | | | | | % Of | Soil Specific |
| = | 13% Ir | npervious | | HSG | Site | Recharge Factor |
| | | | | A | 0% | 0.38 |
| S = | 17.53 % | 1 | | В | 37% | 0.26 |
| | | | | С | 59% | 0.13 |
| Rv = | 0.17 | | | D | 4% | 0.06 |
| Recharge | Using Perce | nt Volume | Method | Barron karpangang berbuaryan perakan palah karpana dang | | |
| Rev = | 0.0061 ad | c-ft OR | 264 | Cf | | |
| Recharge | Using Perce | nt Area Me | thod | | | |
| Rev = | 0.06 ad | cres | | | | |
| Requirem | ent may be r | net by eith | er | | | |
| | a) treating | 264 cf | using st | ructural met | thods, | |
| | b) treating | 0.06 ac | res usin | g non-struci | tural method | ds, or |
| | c) a combina | tion of both | | | | |

| (| | | | | | | | | |
|-------|--|---|--|---|--|--------------|-----------|----------|---|
| NO. | DATE | | | REVISION | | | | | |
| | erngin E 8480 Baltimore | NGINEERI NATIONAL PIKE & SUITE 31 | ING, IP 5 • ELLICOTT CIT 7) 410-465-664 | NC. 1, maryland 21043 | Professional Certification. I hereby certify that these documents were prepared or approved by me, and that I am a duly licensed professional engineer under the laws of the State of Maryland, License No. 45577 Expiration Date: 06-08-2020 | | | | |
| OWNE | DEVELOPER CARROLL-ZIE NATALIE 4888 CASTL ELLICOTT CI | R AND OWNER GLER PARCEL Q: C. ZIEGLER LEBRIDGE ROAD TY, MD. 21042 740-6880 | PLAT No. 1 | IVISON OF LOT 2 AN 1379 INTO LOT 3 AI CARROLL-ZIEGLER P | ND PRES ND PRES ROPERTY | ERVATION PAR | RCEL 'A-1 | ', REVIS | |
| | 2 AND NATALIE C. JOHN H | S FARM LOTS 1, PARCEL A: ZIEGLER AND . ZIRSCHKY | TAX MAP: 23, GRID: 10, P/O PARCELS: 130 & 131, ZONED: RC-DEO ELECTION DISTRICT NO. 3 HOWARD COUNTY, MARYLAND | | | | | DEO | |
| 0 | MD. WNER CARROLL PAR | E ROADELLICOTT CITY, 21042 | ENVIRONMENTAL CONCEPT PLAN STORMWATER MANAGEMENT PLAN | | | | | | |
| | 8871 GOOS | I & PARUL SIDDIQI E LANDING CIR. , MD. 21045 | DATE: | FEBRUARY, 201 | 9 | BEI PROJEC | T NO: | 2799 |) |
| DESIG | N: JC | DRAWN: BEI | SCALE: | AS SHOWN | | SHEET | 5 | OF | 8 |

ECP-17-070

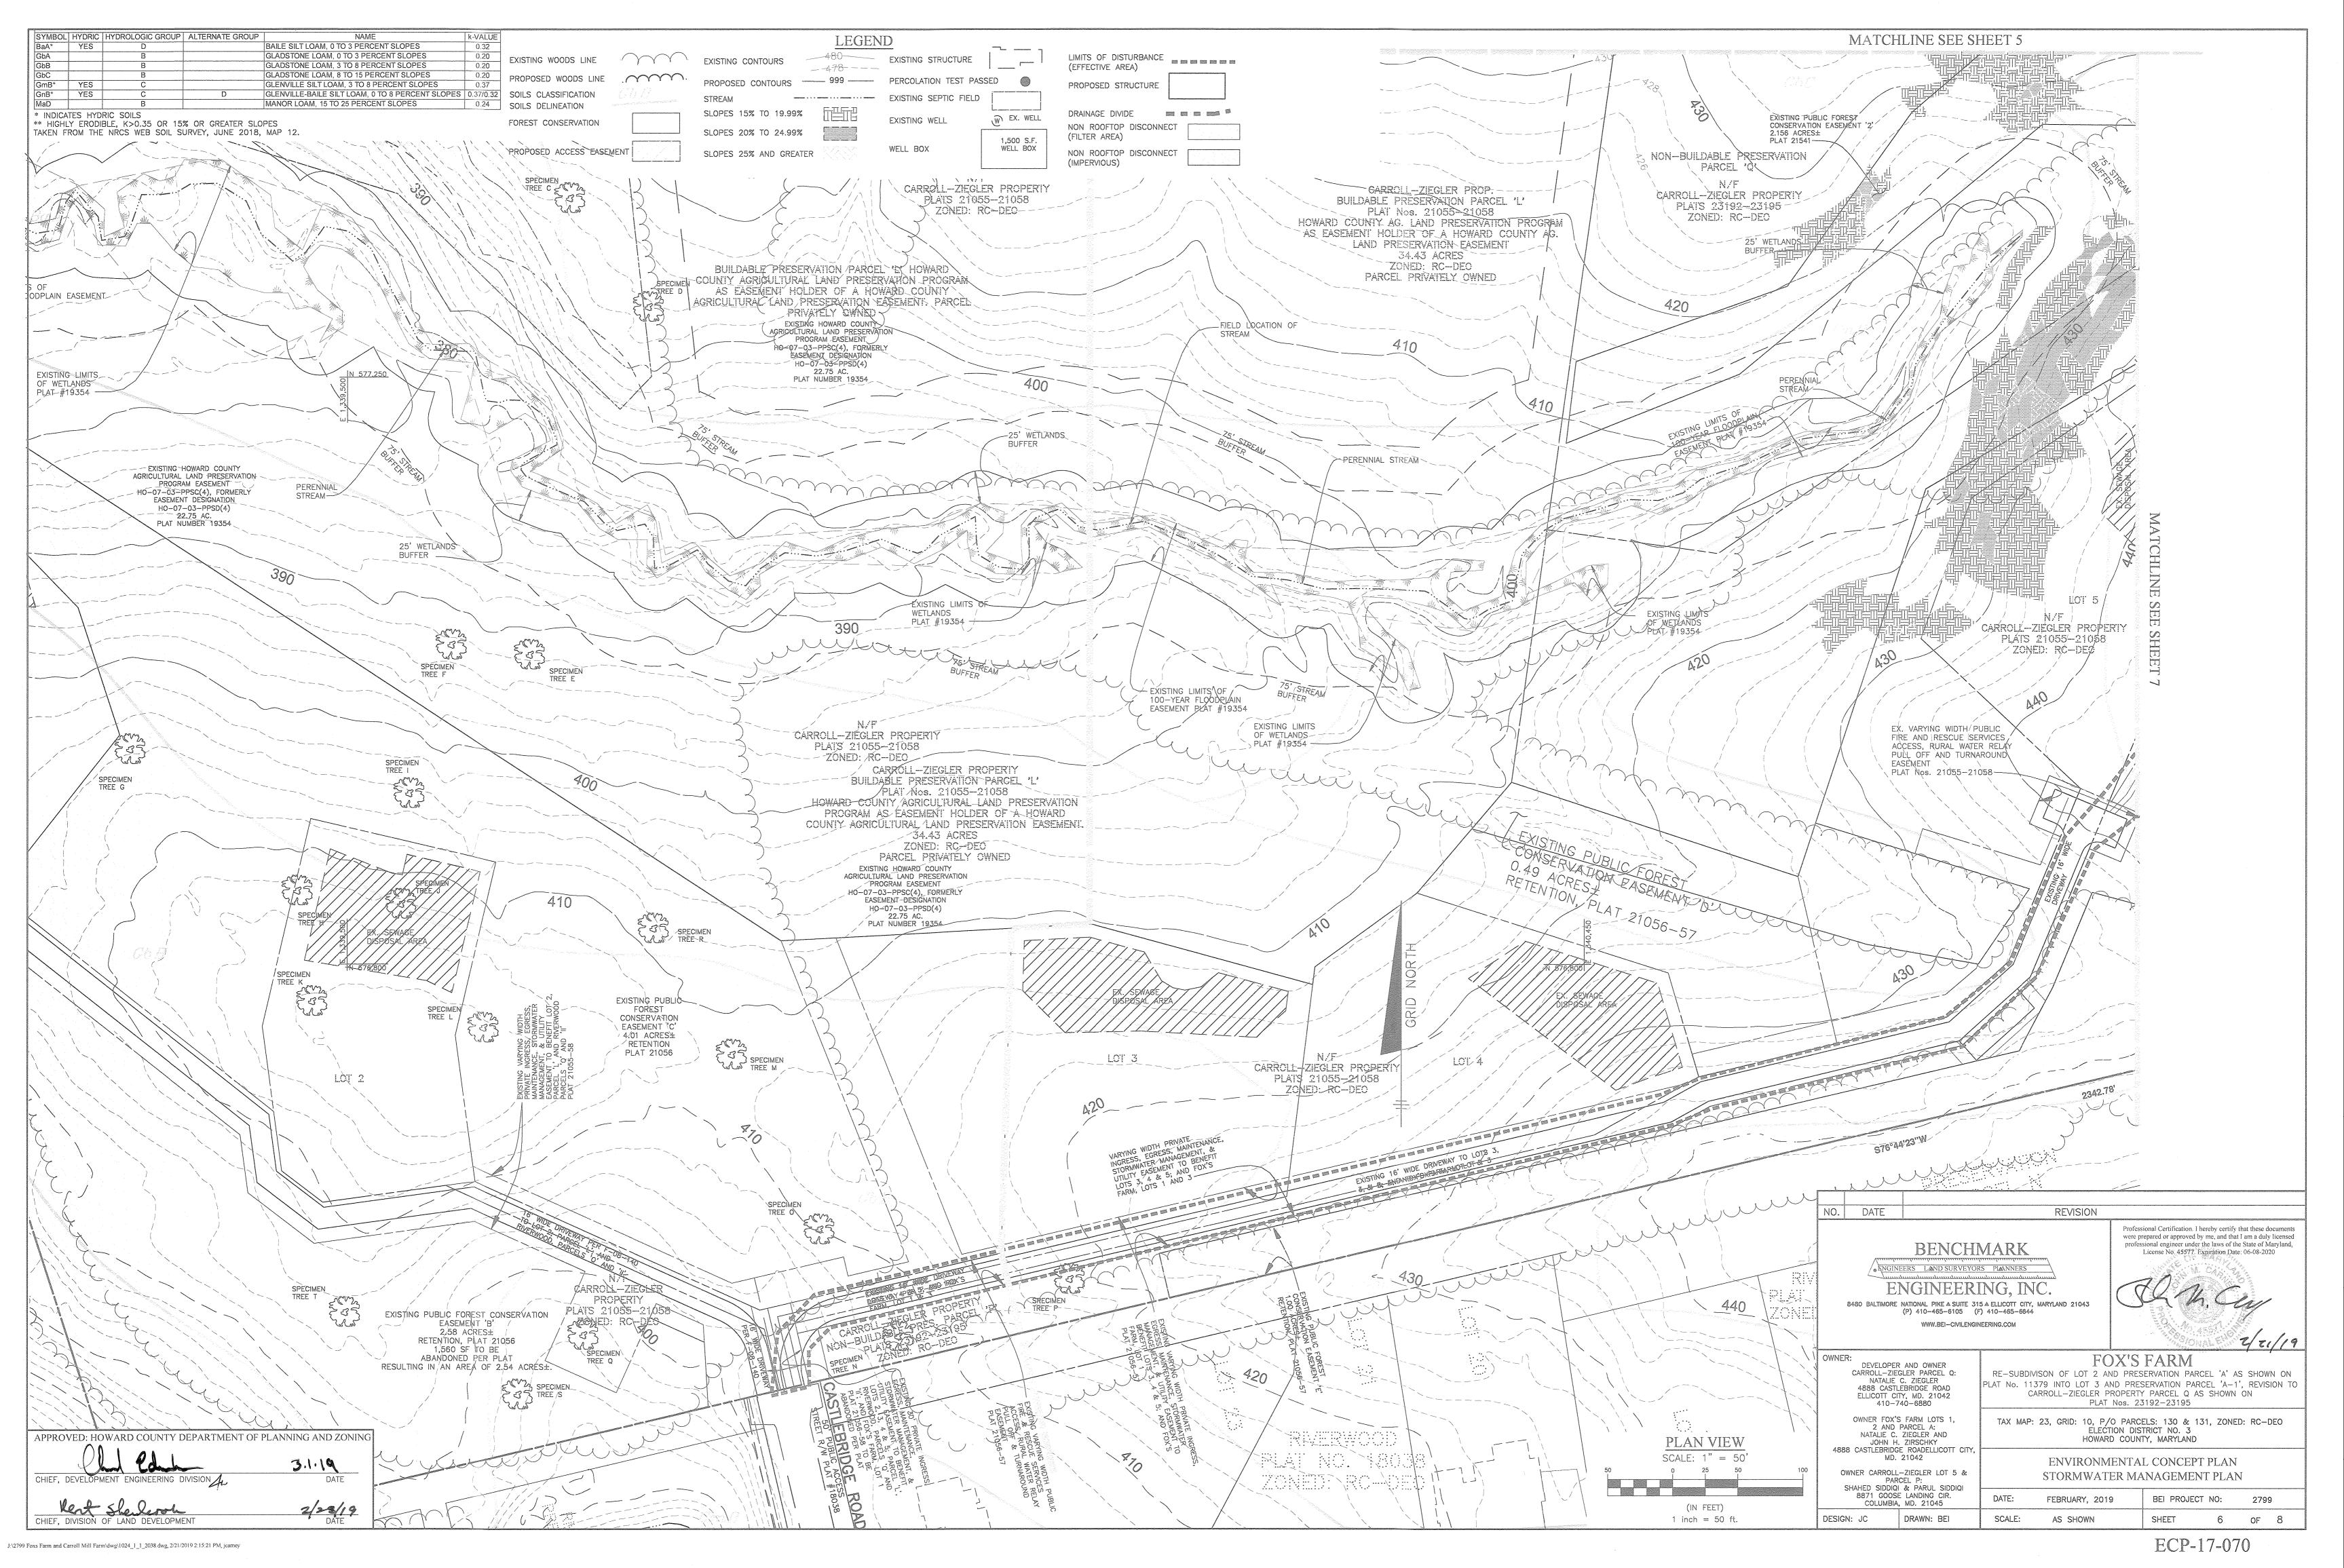

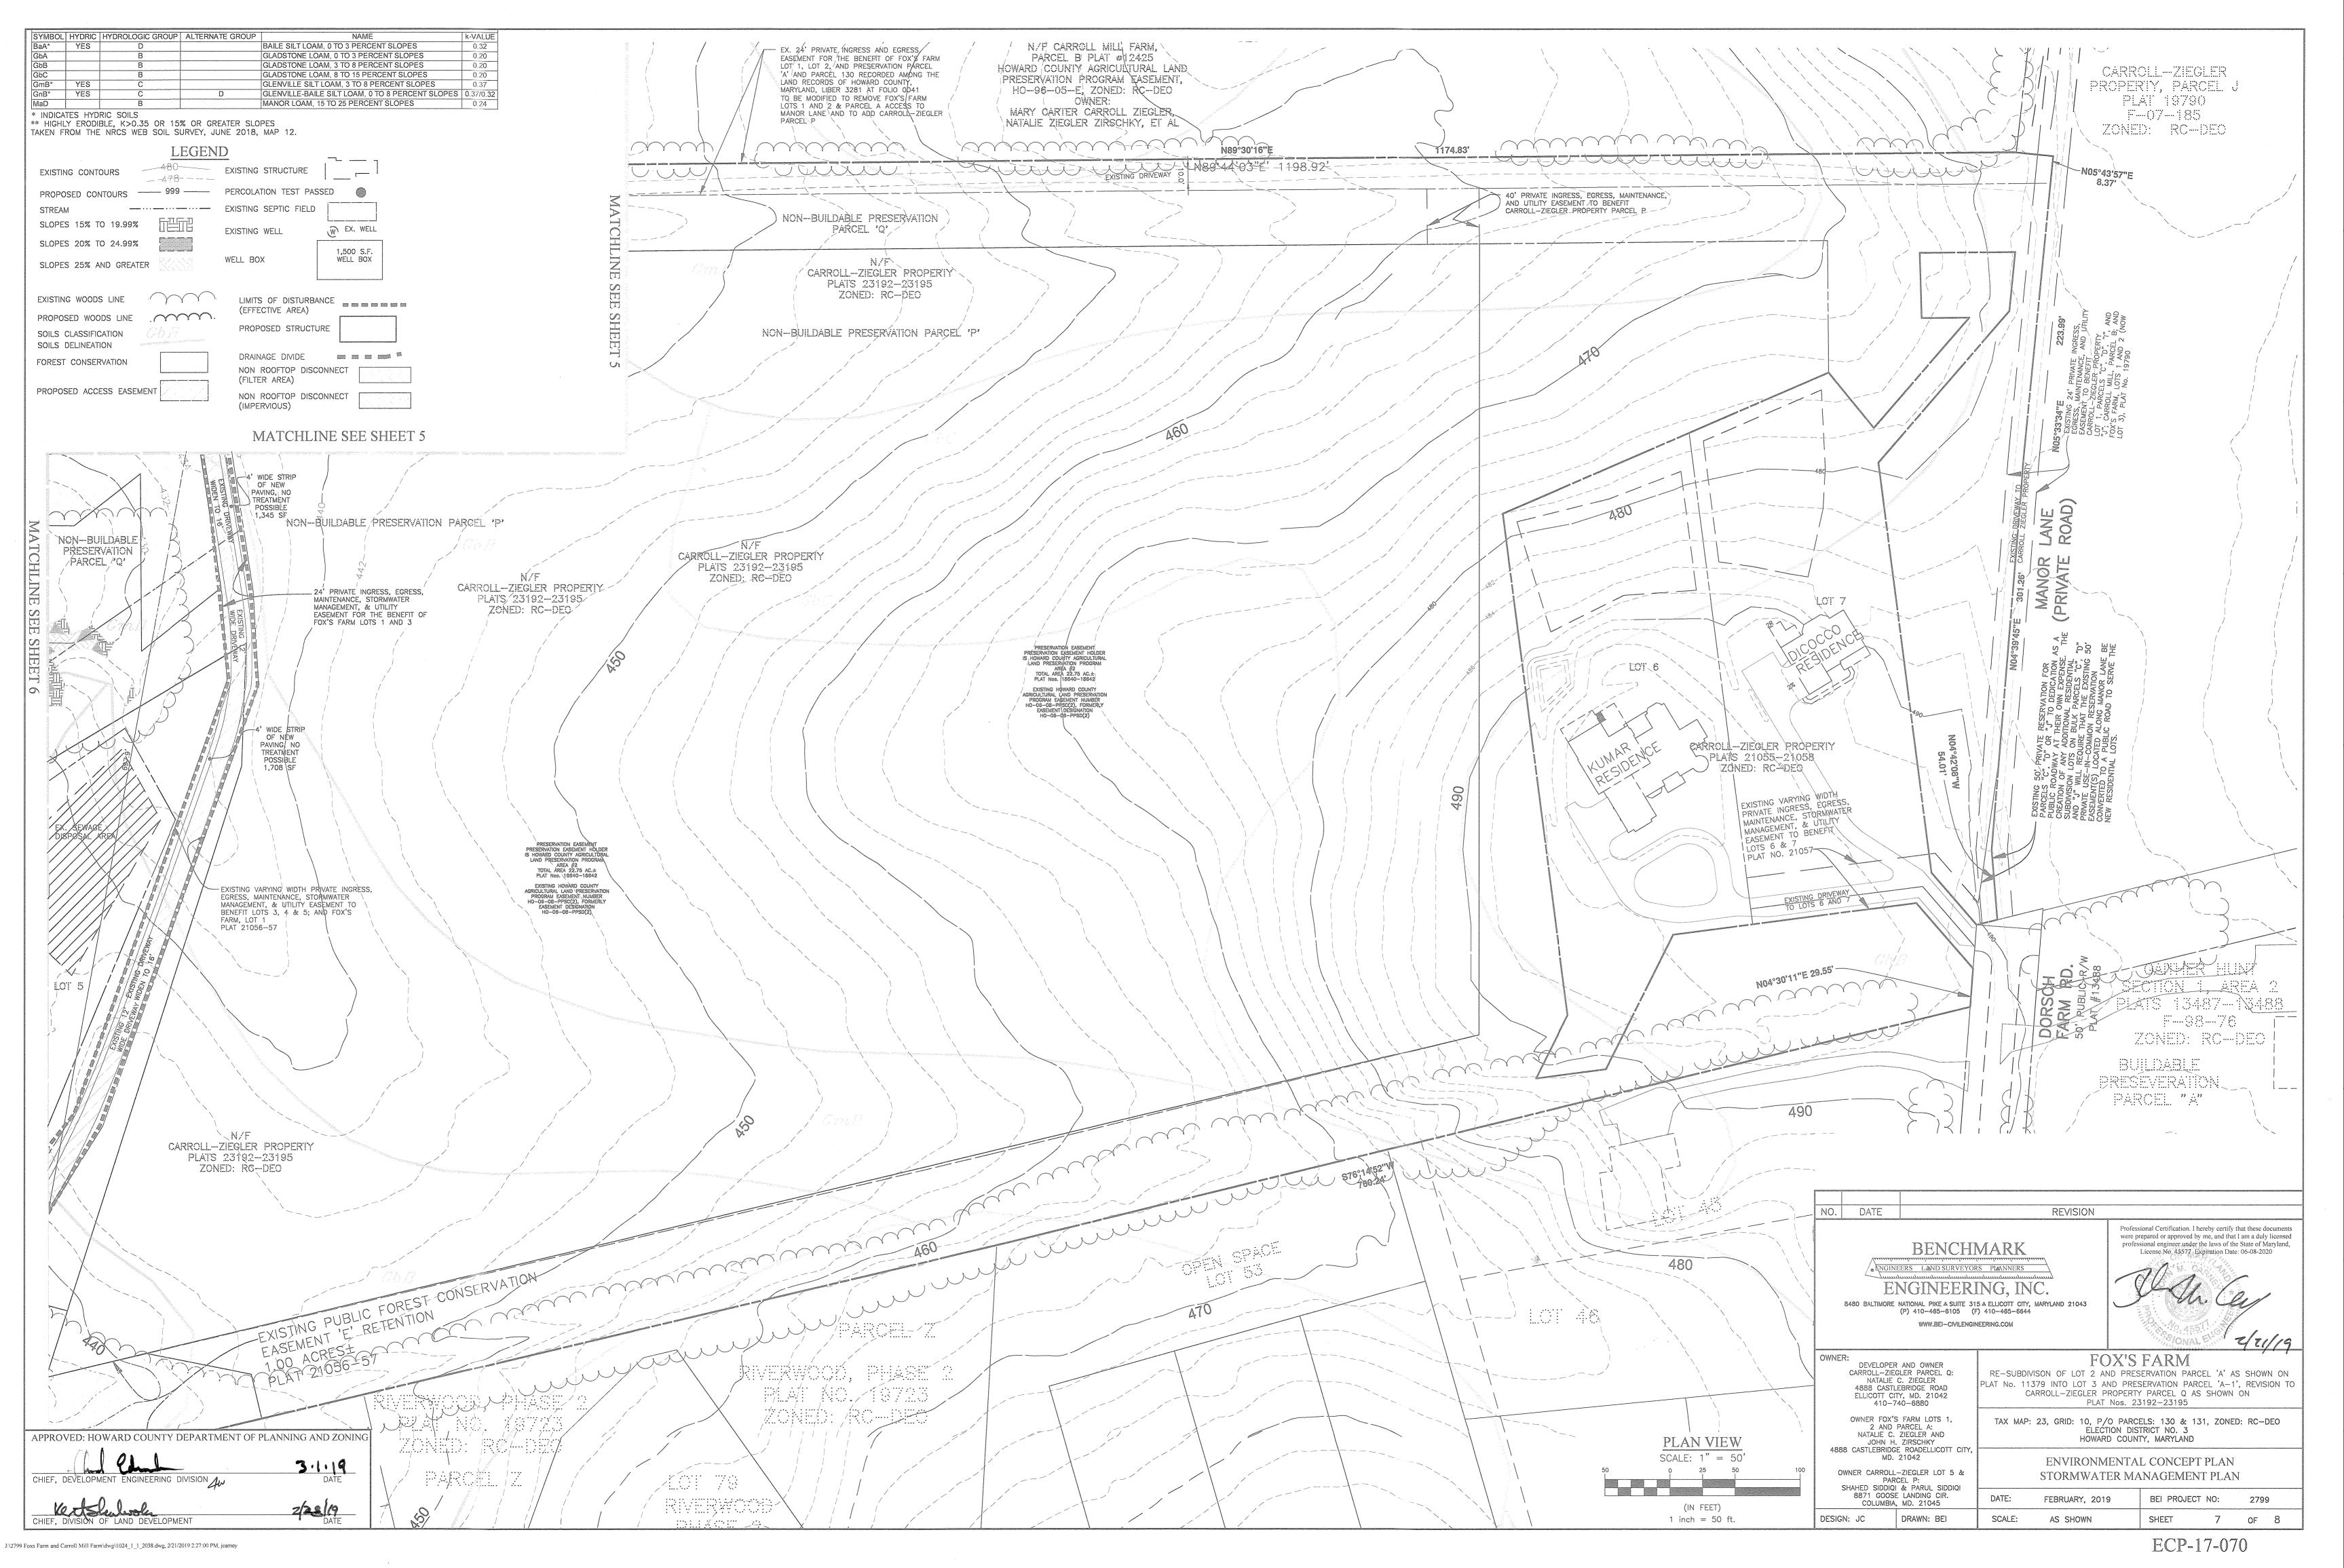

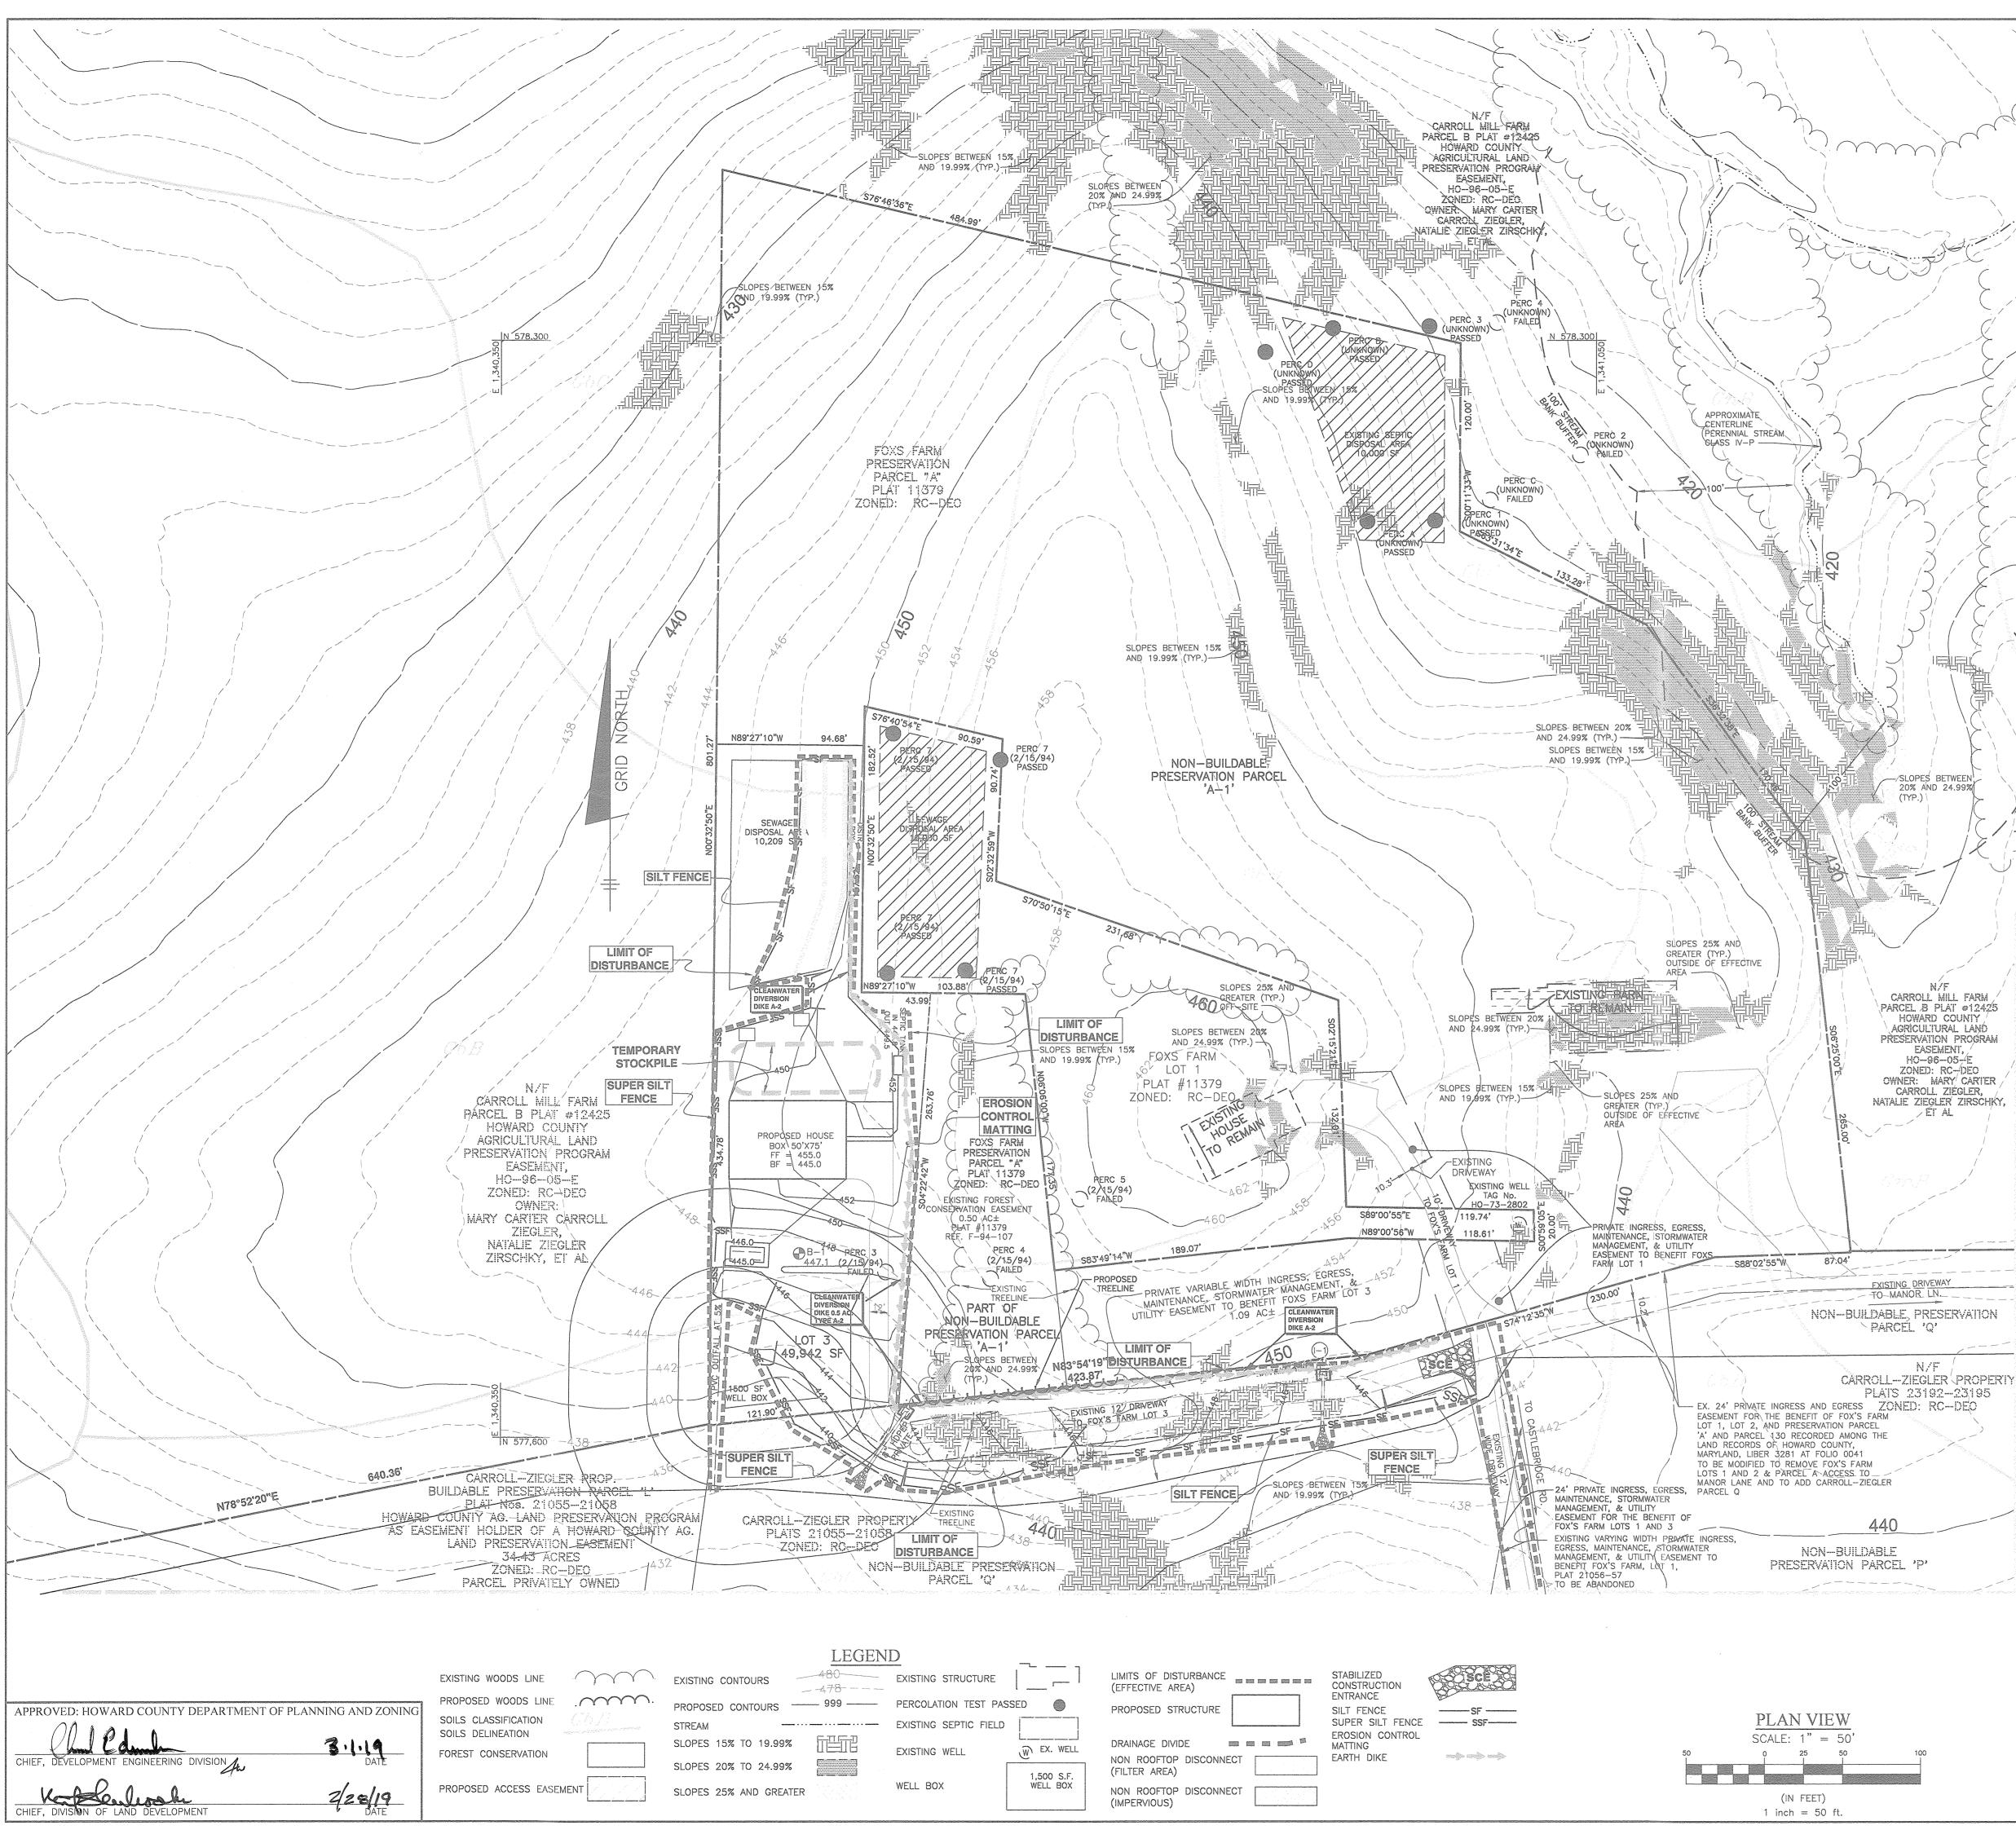

J:\2799 Foxs Farm and Carroll Mill Farm\dwg\1024_1_1_2038.dwg, 2/21/2019 2:24:49 PM, jcarney

| | (IN | FEET) | | | | |
|---|------|-------|--|--|--|--|
| 1 | inch | = 50 | | | | |

- Names Address Managers and Street

* INDICATES HYDRIC SOILS ** HIGHLY ERODIBLE, K>0.35 OR 15% OR GREATER SLOPES TAKEN FROM THE NRCS WEB SOIL SURVEY, JUNE 2018, MAP 12.

SEQUENCE OF CONSTRUCTION

- NOTIFY SEDIMENT CONTROL DIVISION 48 HOURS PRIOR TO START OF WORK 1. OBTAIN GRADING PERMIT. (DAY 1)
- 2. HOLD ON-SITE PRE-CONSTRUCTION MEETING. (DAY 2) 3. CLEAR AND GRUB AS NECESSARY TO INSTALL STABILIZED CONSTRUCTION ENTRANCE AND PERIMETER CONTROLS (I.E. EARTH DIKES, TEMP. PIPE, SILT FENCE, SUPER SILT FENCES, ETC.) (DAY 3-4)
- 4. UPON APPROVAL FROM THE HOWARD COUNTY SEDIMENT CONTROL INSPECTOR, PRÓCEED TO CLEAR AND GRUB WITHIN THE PERIMETER. (DAY 5-6)
- 5. EXCAVATE FOR HOUSE FOUNDATION, POUR AND BACKFILL. (DAY 7-14) 6. BRING DRIVEWAY TO SUBGRADE. DO NOT INSTALL SWALES AT THIS TIME. (DAY 15)
- 7. FINISH HOUSE CONSTRUCTION. (DAY 16-90) 8. CONSTRUCT MICRO-BIORETENTION #1 & DRY WELLS #1 AND #2. DO NOT INSTALL MULCH OR PLANTINGS AT THIS TIME. INSTALL SILT FENCE AROUND PERIMETER OF MICRO-BIORETENTION FACILITY. ONCE THE ROOF OF THE HOUSE IS COMPLETED, INSTALL THE ROOF DRAINS. (DAY 91-95)
- 9. PAVE THE DRIVEWAY. (DAY 96-100) INSTALL SEPTIC LINE, SEPTIC TANK AND TRENCHES. (DAY 101-108)
 FINAL GRADE THE LOT AND STABILIZE IN ACCORDANCE WITH THE PERMANENT SEEDBED NOTES INCLUDING EROSION CONTROL MATTING WITHIN ALL SWALES, IF APPLICABLE, AS SHOWN ON THE
- PLAN. AT THIS TIME, PROCEED TO INSTALL MULCH AND PLANTINGS OF MICRO-BIORETENTION #1. (DAY 109-110)
- 12. UPON APPROVAL FROM THE HOWARD COUNTY SEDIMENT CONTROL INSPECTOR, REMOVE SEDIMENT CONTROL DEVICES AND STABILIZE ANY REMAINING DISTURBED AREAS WITH THE PERMANENT SEEDBED NOTES. (DAY 111)

| | | n yer oofiny al good incorport yer operations of the second statements of | | | | | | | | |
|--|--|--|--|---------------|---|------------|--------|-------------------------|---|--|
| NO. | DATE | REVISION | | | | | | | | |
| Professional Certification. I hereby certify that these documents were prepared or approved by me, and that I am a duly licensed professional engineer under the laws of the State of Maryland, License No 45577 Expiration Date: 06-08-2020 MARINE NATIONAL PIKE A SUITE 315 A ELLICOTT CITY, MARYLAND 21043 (P) 410-465-6105 (F) 410-465-6644 WWW.BEI-CIVILENGINEERING.COM | | | | | | | | / licensed laryland, | | |
| OWNE | DEVELOPER CARROLL-ZIE NATALIE 4888 CASTL ELLICOTT CI | R AND OWNER GLER PARCEL Q: C. ZIEGLER EBRIDGE ROAD TY, MD. 21042 '40-6880 | FOX'S FARM RE-SUBDIVISON OF LOT 2 AND PRESERVATION PARCEL 'A' AS SHOWN ON PLAT No. 11379 INTO LOT 3 AND PRESERVATION PARCEL 'A-1', REVISION TO CARROLL-ZIEGLER PROPERTY PARCEL Q AS SHOWN ON PLAT Nos. 23192-23195 | | | | | | | |
| 488 | OWNER FOX'S FARM LOTS 1, 2 AND PARCEL A: NATALIE C. ZIEGLER AND JOHN H. ZIRSCHKY 4888 CASTLEBRIDGE ROADELLICOTT CITY, MD. 21042 OWNER CARROLL-ZIEGLER LOT 5 & PARCEL P: SHAHED SIDDIQI & PARUL SIDDIQI 8871 GOOSE LANDING CIR. COLUMBIA, MD. 21045 | | TAX MAP: 23, GRID: 10, P/O PARCELS: 130 & 131, ZONED: RC-DEO ELECTION DISTRICT NO. 3 HOWARD COUNTY, MARYLAND | | | | | | | |
| 200000000000000000000000000000000000000 | | | ENVIRONMENTAL CONCEPT PLAN SEDIMENT AND EROSION CONTROL PLAN | | | | | | | |
| | | | DATE: | FEBRUARY, 201 | 9 | BEI PROJEC | CT NO: | 2799 | 9 | |
| DESIG | N: JC | DRAWN: BEI | SCALE: | AS SHOWN | | SHEET | 8 | OF | 8 | |
| ECP-17-070 | | | | | | | | | | |