ROCKBURN HILL PUMP STATION

LIST OF DRAWINGS

SHEET NO.	DESCRIPTION
1	COVER SHEET
2	EXISTING CONDITIONS - PLAN
3	ENVIRONMENTAL SITE DESIGN CONCEPT - PLAN
4	SEDIMENT, EROSION, AND STORMWATER CONTROL - PLAN

LIST OF WAIVER REQUESTS

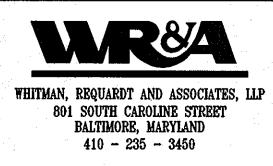
WAIVER TO SECTION *	WAIVER DESCRIPTION SUMMARY								
16.1205(a)	REMOVAL OF LARGE AND CHAMPION TREES								

* FROM HOWARD COUNTY SUBDIVISION AND LAND DEVELOPMENT REGULATIONS.

SITE ANALYSIS DATA CHART

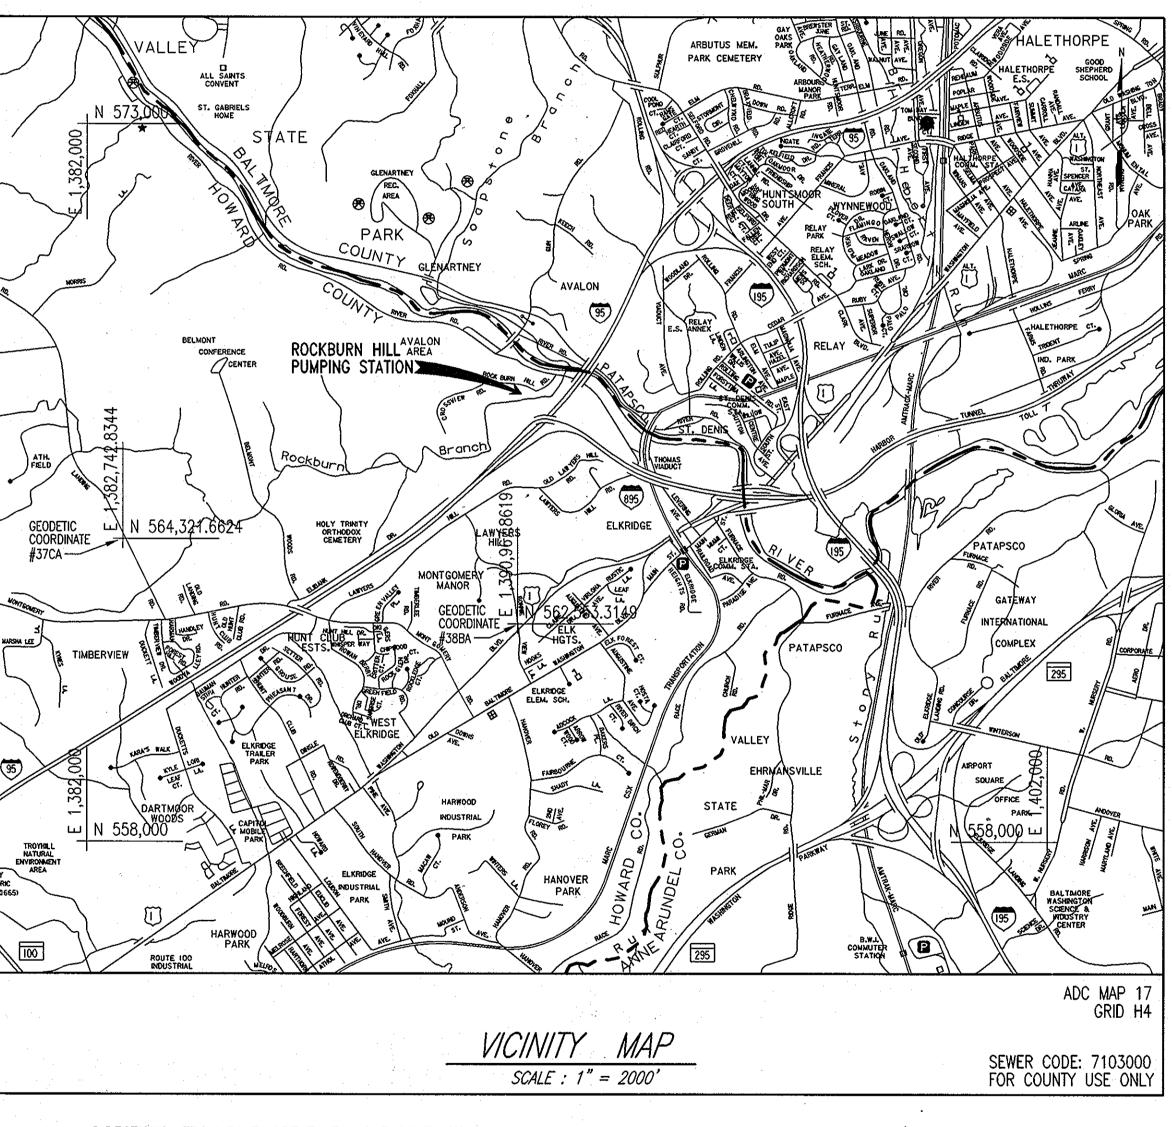
(i) A second provide the second se Second second se Second second sec	and the second
SITE AREA	0.25 AC.
VETLANDS	0 AC.
VETLAND BUFFER	0 AC.
OREST	0 AC.
SLOPES 15% TO <25%	586 SF.
SLOPES 25%>	981 SF.
PROPOSED SITE USE	PUMPING STATION
PROPOSED IMPERVIOUS AREA	0.06 AC.
LOOD PLAIN AND BUFFER	0.16 AC.
TOTAL PROJECT AREA (LOD)	0.25 AC.
GREEN AREA	
RODIBLE SOILS	0.03 AC.

DEVELOPMENT ENGINEERIN HOWARD COUNTY, MAR			OF LAND		
CHIEF, DEVELOPMENT ENGINEERING DIV		CHIEF, DIVISION	OF LAND DEV	ELOPMENT	6/07/12 DATE
PROFESSIONAL CERTIFICATION. I HE APPROVED BY ME, AND THAT I AM OF THE STATE OF MARYLAND. LICE	A DULY LICENSE	D PROFESSION	AL ENGINEER	UNDER TH	•
OWNER:		PERMIT	INFORMATION CHA	RT	
HOWARD COUNTY DEPARTMENT OF PUBLIC WORKS	WATER CODE: PUBLIC	SEWER CODE: PUBLIC	BUILDING N/A		ADDRESS LL RD/RIVER RD
9250 BENDIX ROAD COLUMBIA, MD 21045 ATTN: MR. BOB DIAZ	PROJECT N ROCKBURN HILL S STATION AND CRO WATER EXTE	SEWER/PUMP SSVIEW ROAD	TAX MAP/GRI 32/10		
VOICE 410-313-6153	L/F		TAX MAP BLOC		



CAPITAL PROJECT S-6260 CONTRACT NO. 14-4715 ECP-12-043

HOWARD COUNTY, MARYLAND



DIRECTIONS:

ROAD, JUST <u>IOTE:</u> HORIZON AS EST,	DRE TAKE I-895 PAST I-95 BRIDO	SOUTH TO EXI GE, TRAVEL WE INFORMATION PS SURVEY PI	ST/SOUTHWEST ON SHOWN HEREON B REFORMED BY WHITH		ONTINUE NORTH/NORTH EFORE ROCKBURN HILL UNTY GEODETIC CONTRASSOCIATES FROM THE	ROAD.	SLOPES 15% TO <25% SLOPES >25% CONTOUR SANITARY SEWER SANITARY SEWER MANHOLE STORM DRAIN TREE LINE TREE SPECIMEN TREE MARKED FOR REMOVAL TREES TO BE REMOVED STREAM BUFFER SILT FENCE SUPER SILT FENCE STABILIZED CONSTRUCTION ENTRANCE	EXISTING \swarrow	PROPOSED —145 — —SF —SSF [SSF]	$0 \frac{2000'}{\text{SCALE:}}$ 1" = 200	4000'
	HOWARD COUNTY HOWARD COUNTY	0	562,553.3149 564,321.6624	1,390,967.8619 1,382,742.8344	166.177 256.964		BIO-SWALE/PLANTING BED IMPERVIOUS AREA LIMIT OF DISTURBANCE		↓ ↓		ECP-1
	DES: F.B. DRN: F.B. CHK: W.H.					COVE	R SHEET	CAPITAL CONTI	N HILL PUMP ST PROJECT NO. S-6 RACT NO. 14-471	6260 5	SCALE AS SHOWN SHEET
1 EM 5 25 12	JAN. 2011	BY NO.	RE	VISION	DATE	600 SCALE MAP NO.	BLOCK NO.		ELECTION DISTRICT COUNTY, MARYLA	and the second se	OF

ENVIRONMENTAL DESIGN NARRATIVE

THE SITE WAS EVALUATED FOR STORMWATER MANAGEMENT, AS REQUIRED BY THE STORMWATER MANAGEMENT ACT OF 2007 AND THE HOWARD COUNTY DESIGN MANUAL VOLUME I. THESE REGULATIONS REQUIRE THAT THE ENVIRONMENTAL SITE DESIGN (ESD) BE IMPLEMENTED TO THE MAXIMUM EXTENT POSSIBLE FOR EVERY NEW PROJECT. BY IMPLEMENTING ESC, THE ULTIMATE GOAL IS TO MAINTAIN THE RUNOFF CHARACTERISTICS OF THE SITE TO MIMIC PREDEVELOPMENT WOODS IN GOOD CONDITION. ENVIRONMENTAL SITE DESIGN COMPONENTS AND HOW THEY WERE INCORPORATED FOR THE PROJECT INCLUDE:

- NATURAL RESOURCE PROTECTION AND ENHANCEMENT: A BIO-SWALE IS PROPOSED TO MORE EFFECTIVELY DETAIN AND TREAT THE STORMWATER RUNOFF ON THE SITE. THE TREE REMOVAL IS MINIMIZED AND THE ALIGNMENT OF THE PROPOSED ACCESS ROAD IS LOCATED TO MINIMIZE DISTURBANCE TO EXISTING NATURAL FEATURES.
- MAINTENANCE OF NATURAL FLOW PATTERNS: THE PROJECT UTILIZES THE NATURAL DRAINAGE PATTERNS WITH MINIMAL MODIFICATIONS IN ORDER TO MORE EFFECTIVELY DRAIN THE ACCESS ROAD TO THE LOCATION OF THE BIO-SWALE.
- REDUCTION OF IMPERVIOUS AREAS THROUGH BETTER SITE DESIGN, ALTERNATIVE SURFACES AND IN THIS PROJECT THE LIMIT OF DISTURBANCE WAS MINIMIZED BY ELIMINATING ANY ABOVE-GRADE BUILDING STRUCTURES AND PLACING ESD PRACTICES NEXT TO THE ROAD. THE ELIMINATION OF ABOVE GRADE BUILDINGS AND ANY PAVED PARKING AREAS GREATLY REDUCED THE IMPERVIOUS AREAS FOR THE PROJECT. ALTERNATIVE SURFACES WERE CONSIDERED, BUT DUE TO HEAVY DUTY TRAFFIC, PERVIOUS PAVEMENTS ARE NOT FEASIBLE. NON-ROOFTOP DISCONNECTION IS UTILIZED.

THE SITE WILL MAXIMIZE THE USE OF ESD PRACTICES BY INCORPORATING A BIO-SWALE WHERE ALLOWABLE. EROSION AND SEDIMENT CONTROLS WERE INTEGRATED INTO THE DESIGN.

TO SIZE THE ESD PRACTICES, RCN VALUES ARE DETERMINED BASED ON A SITE AREA'S LAND USE OF WOODS IN GOOD CONDITION. PE TARGETS ARE THEN ESTABLISHED FROM THE VALUES SET IN TABLE 5.3 OF THE ENVIRONMENTAL SITE DESIGN CRITERIA. A TARGET ESD VOLUME IS THEN CALCULATED FOR THE DRAINAGE AREA BASED ON THE PE AND THE PROPOSED SITE IMPERVIOUS AREA. NON-ROOFTOP DISCONNECTION IS UTILIZED WHERE POSSIBLE.

INDIVIDUAL ESD PRACTICES ARE THEN LOCATED WITHIN THE DRAINAGE AREA AND SIZED BASED ON THE DRAINAGE AREA AND IMPERVIOUS AREA FLOWING TO THE PRACTICE. THE TOTAL OF THE ESD VOLUMES CAPTURED BY EACH ESD PRACTICE WITHIN THE DRAINAGE AREA SHOULD MEET THE TARGET ESD VOLUME INITIALLY CALCULATED FOR THE ENTIRE DRAINAGE AREA.

BY MEETING ESD VOLUMES, WATER QUALITY VOLUME (WQV) AND RECHARGE VOLUME (REV) AND CHANNEL PROTECTION VOLUME (CPV) ARE SATISFIED.

FOR THIS PROJECT, ONE INDIVIDUAL ESD PRACTICE IS PROPOSED AND NON-ROOFTOP DISCONNECTION.

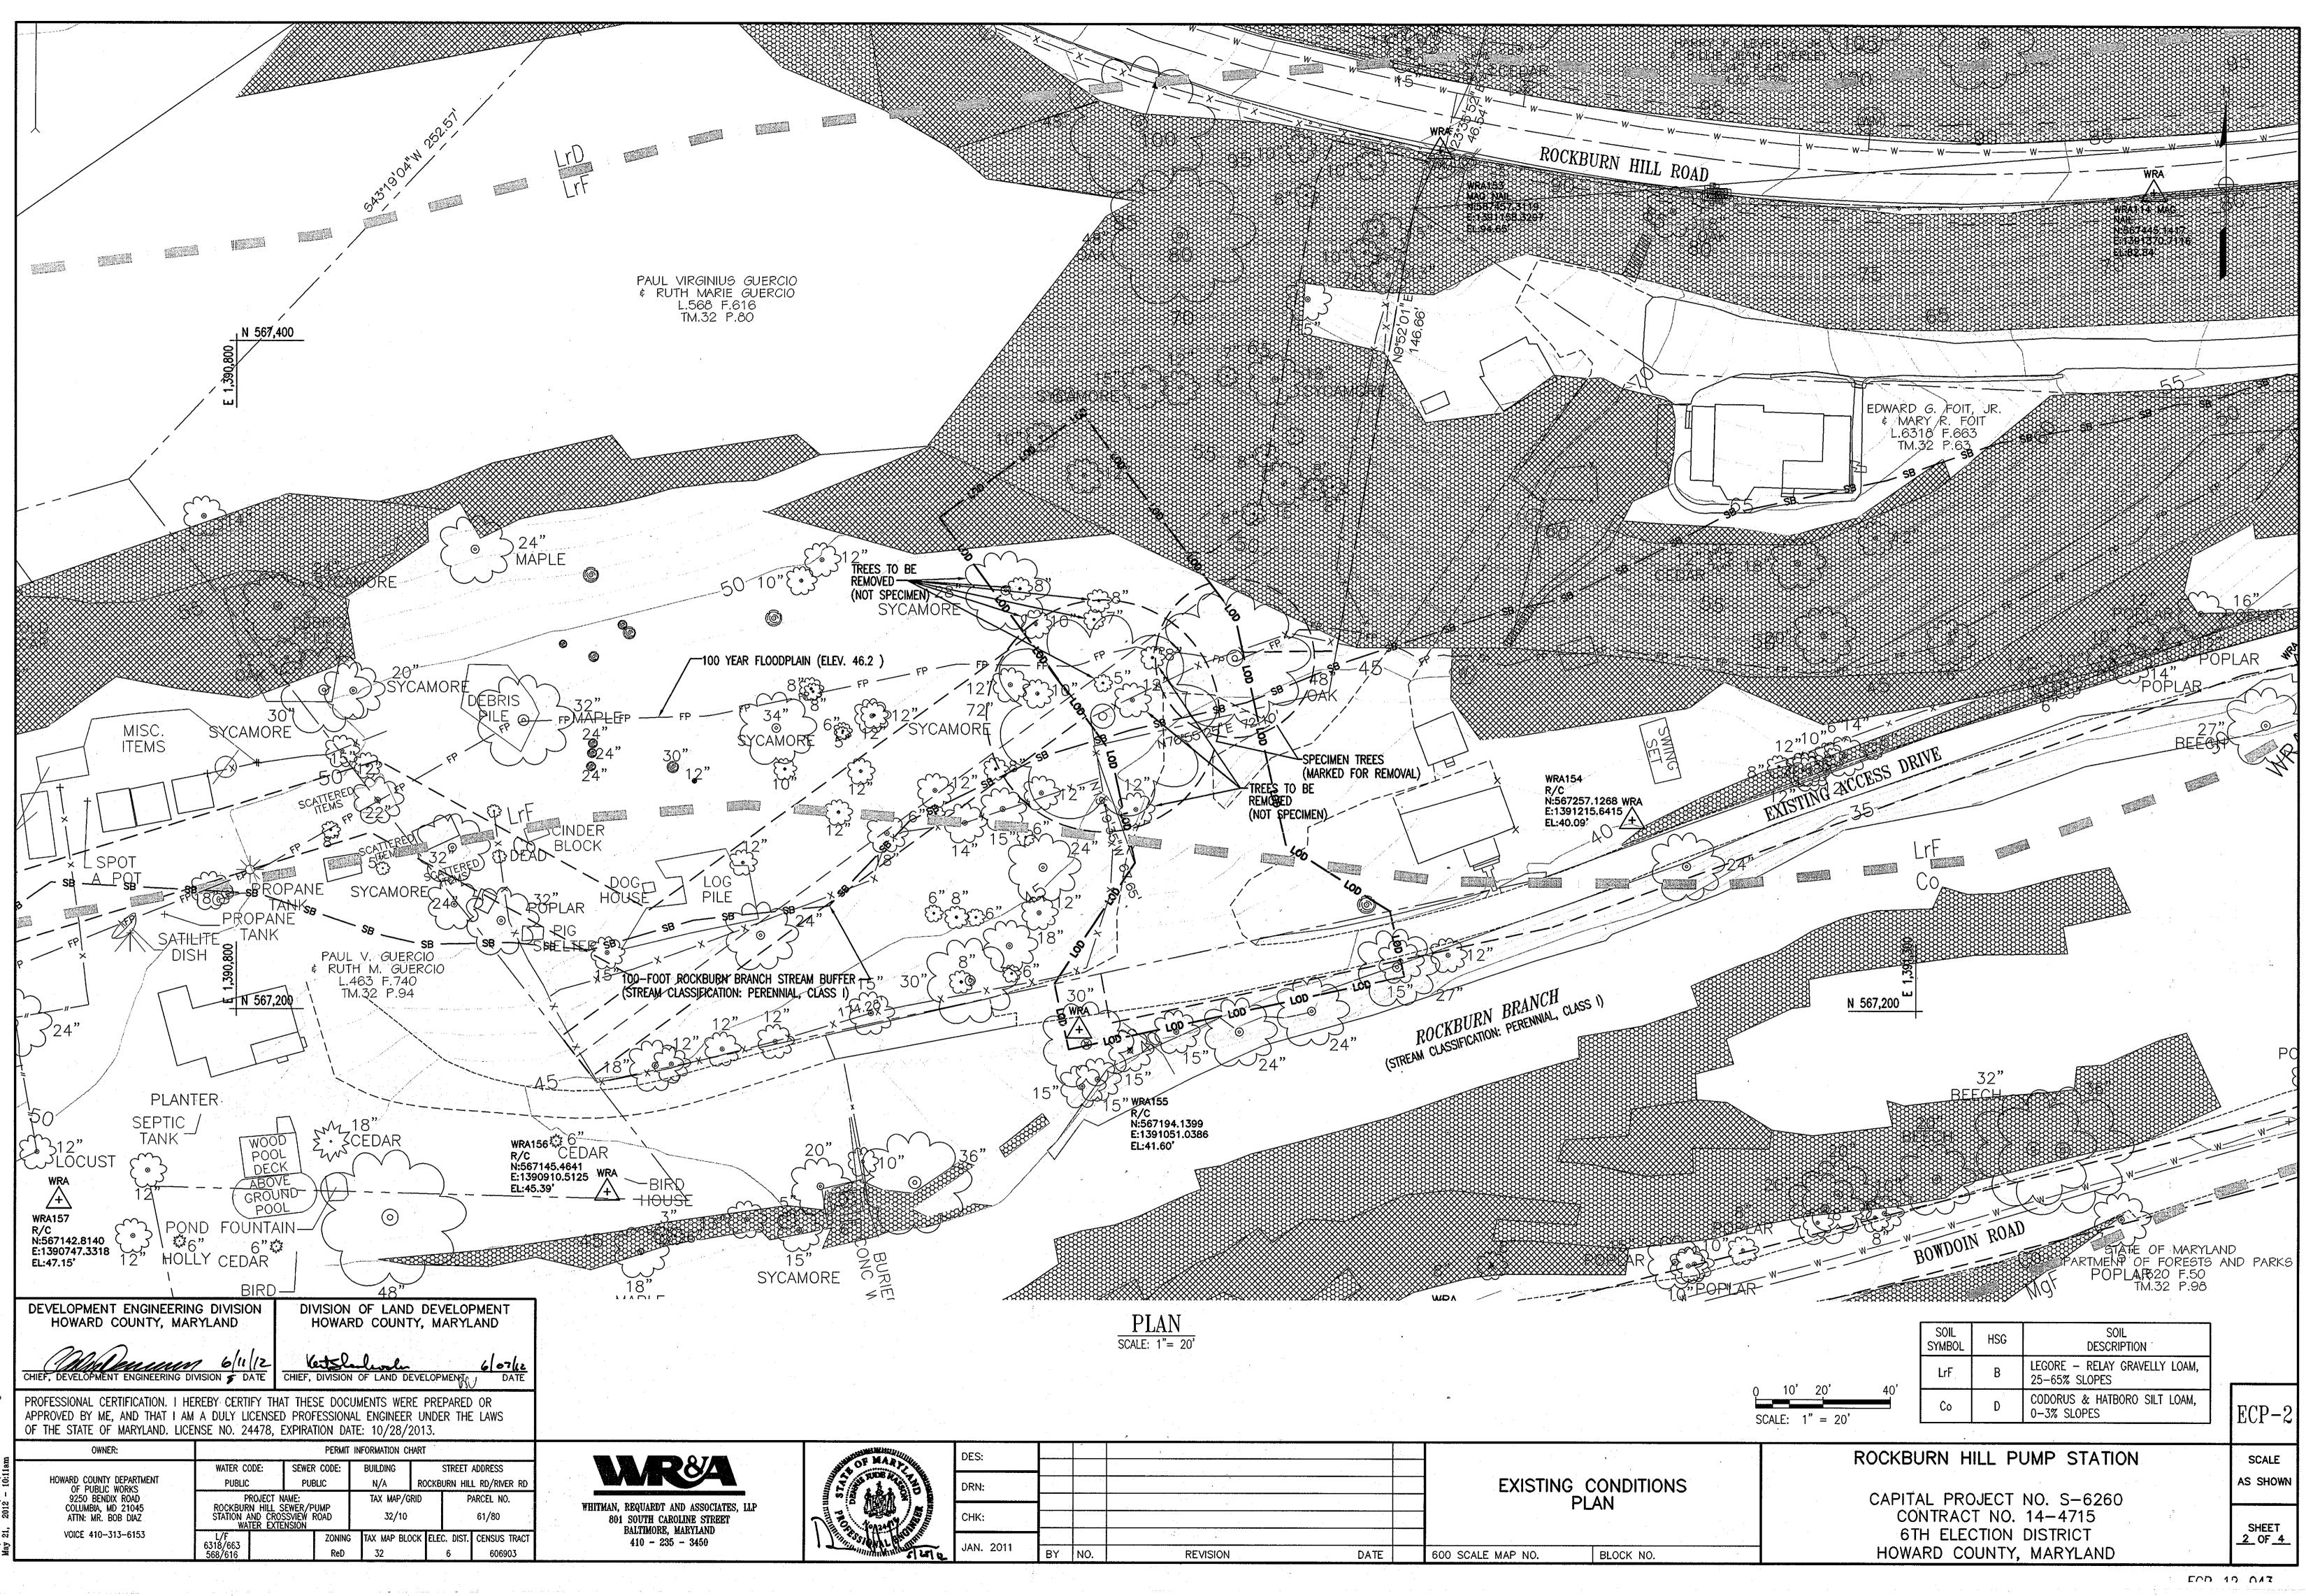
GENERAL NOTES

- APPROVAL OF THIS ENVIRONMENTAL CONCEPT PLAN DOES NOT CONSTITUTE APPROVAL OF ASSOCIATED SUBDIVISION OR SITE DEVELOPMENT PLANS. REVIEW OF THIS PROJECT FOR COMPLIANCE WITH THE HOWARD COUNTY SUBDIVISION AND LAND DEVELOPMENT REGULATIONS AND THE HOWARD COUNTY ZONING REGULATIONS SHALL OCCUR AT THE SUBDIVISION AND SITE PLAN STAGES
- THE DISTURBANCE TO THE 100-YR FLOODPLAIN AND STEEP SLOPES IS CONSIDERED ESSENTIAL DISTURBANCE AND NECESSARY FOR THE PROJECT AND TO INSTALL UTILITIES. 2.
- FOREST CONSERVATION OBLIGATION OF 1.75 ACRES OF REFORESTATION FOR THE PROJECT WILL BE FULFILLED BY THE PAYMENT OF FEE-IN-LIEU OF \$57,172.50.

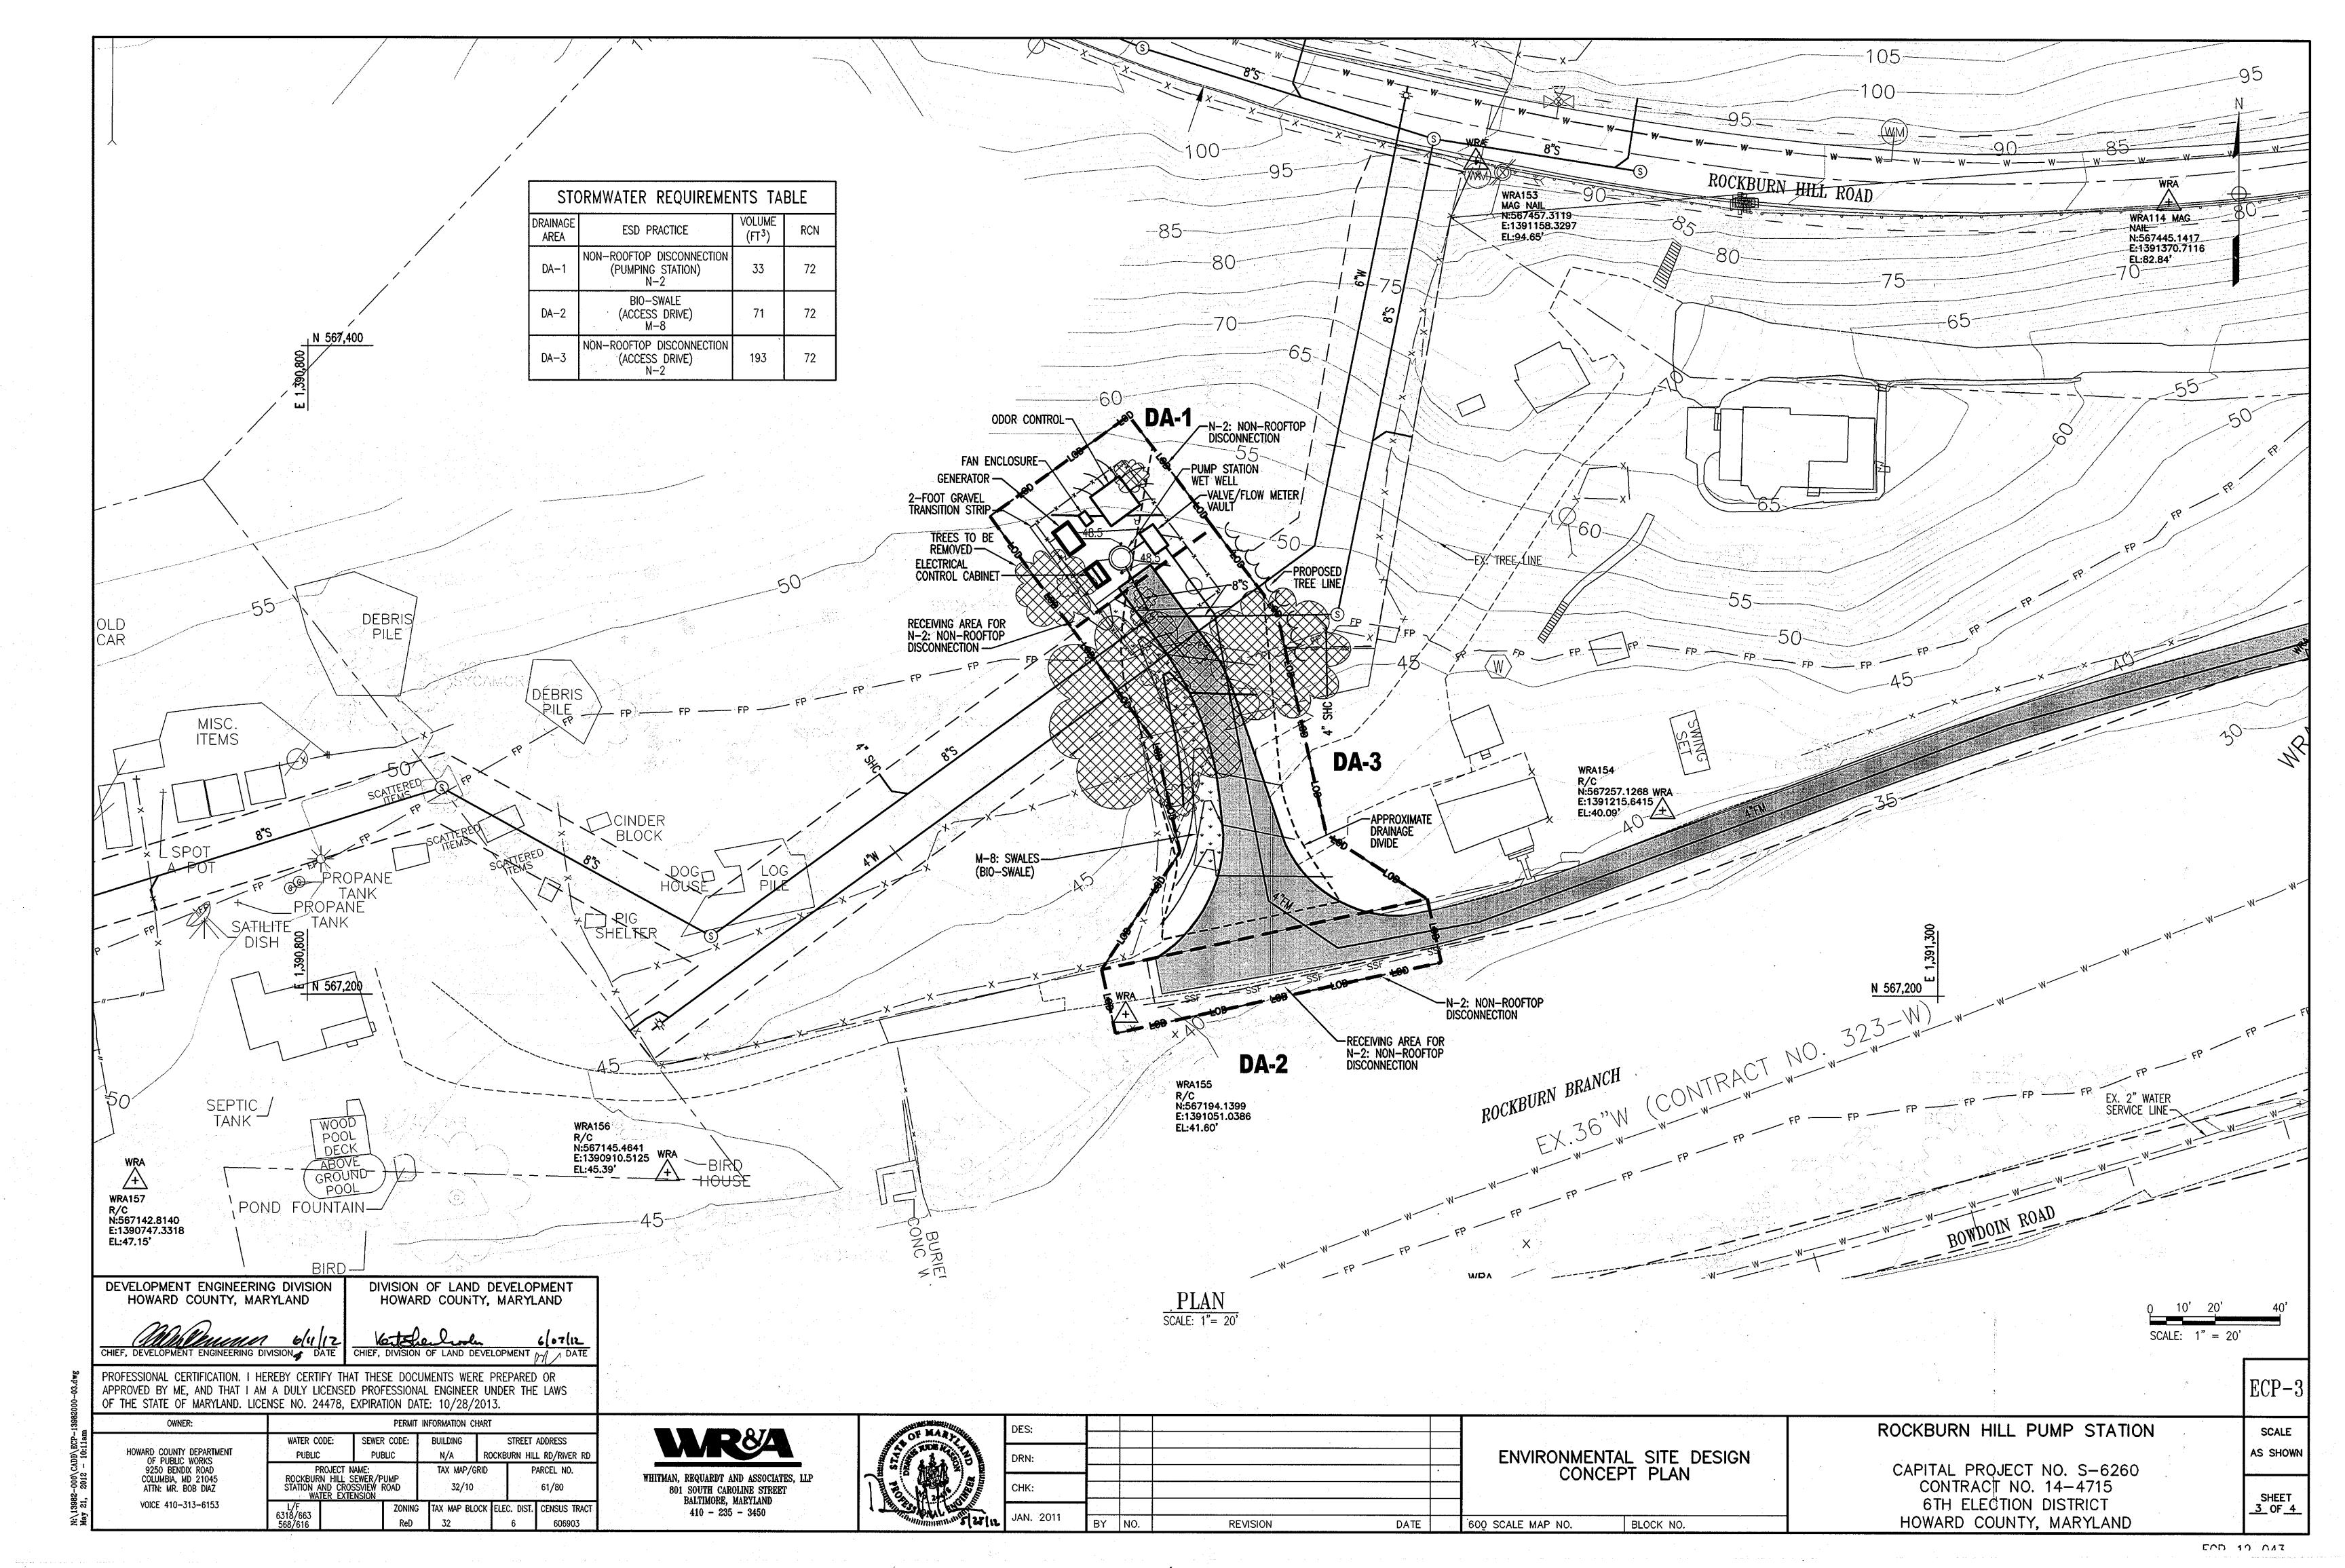
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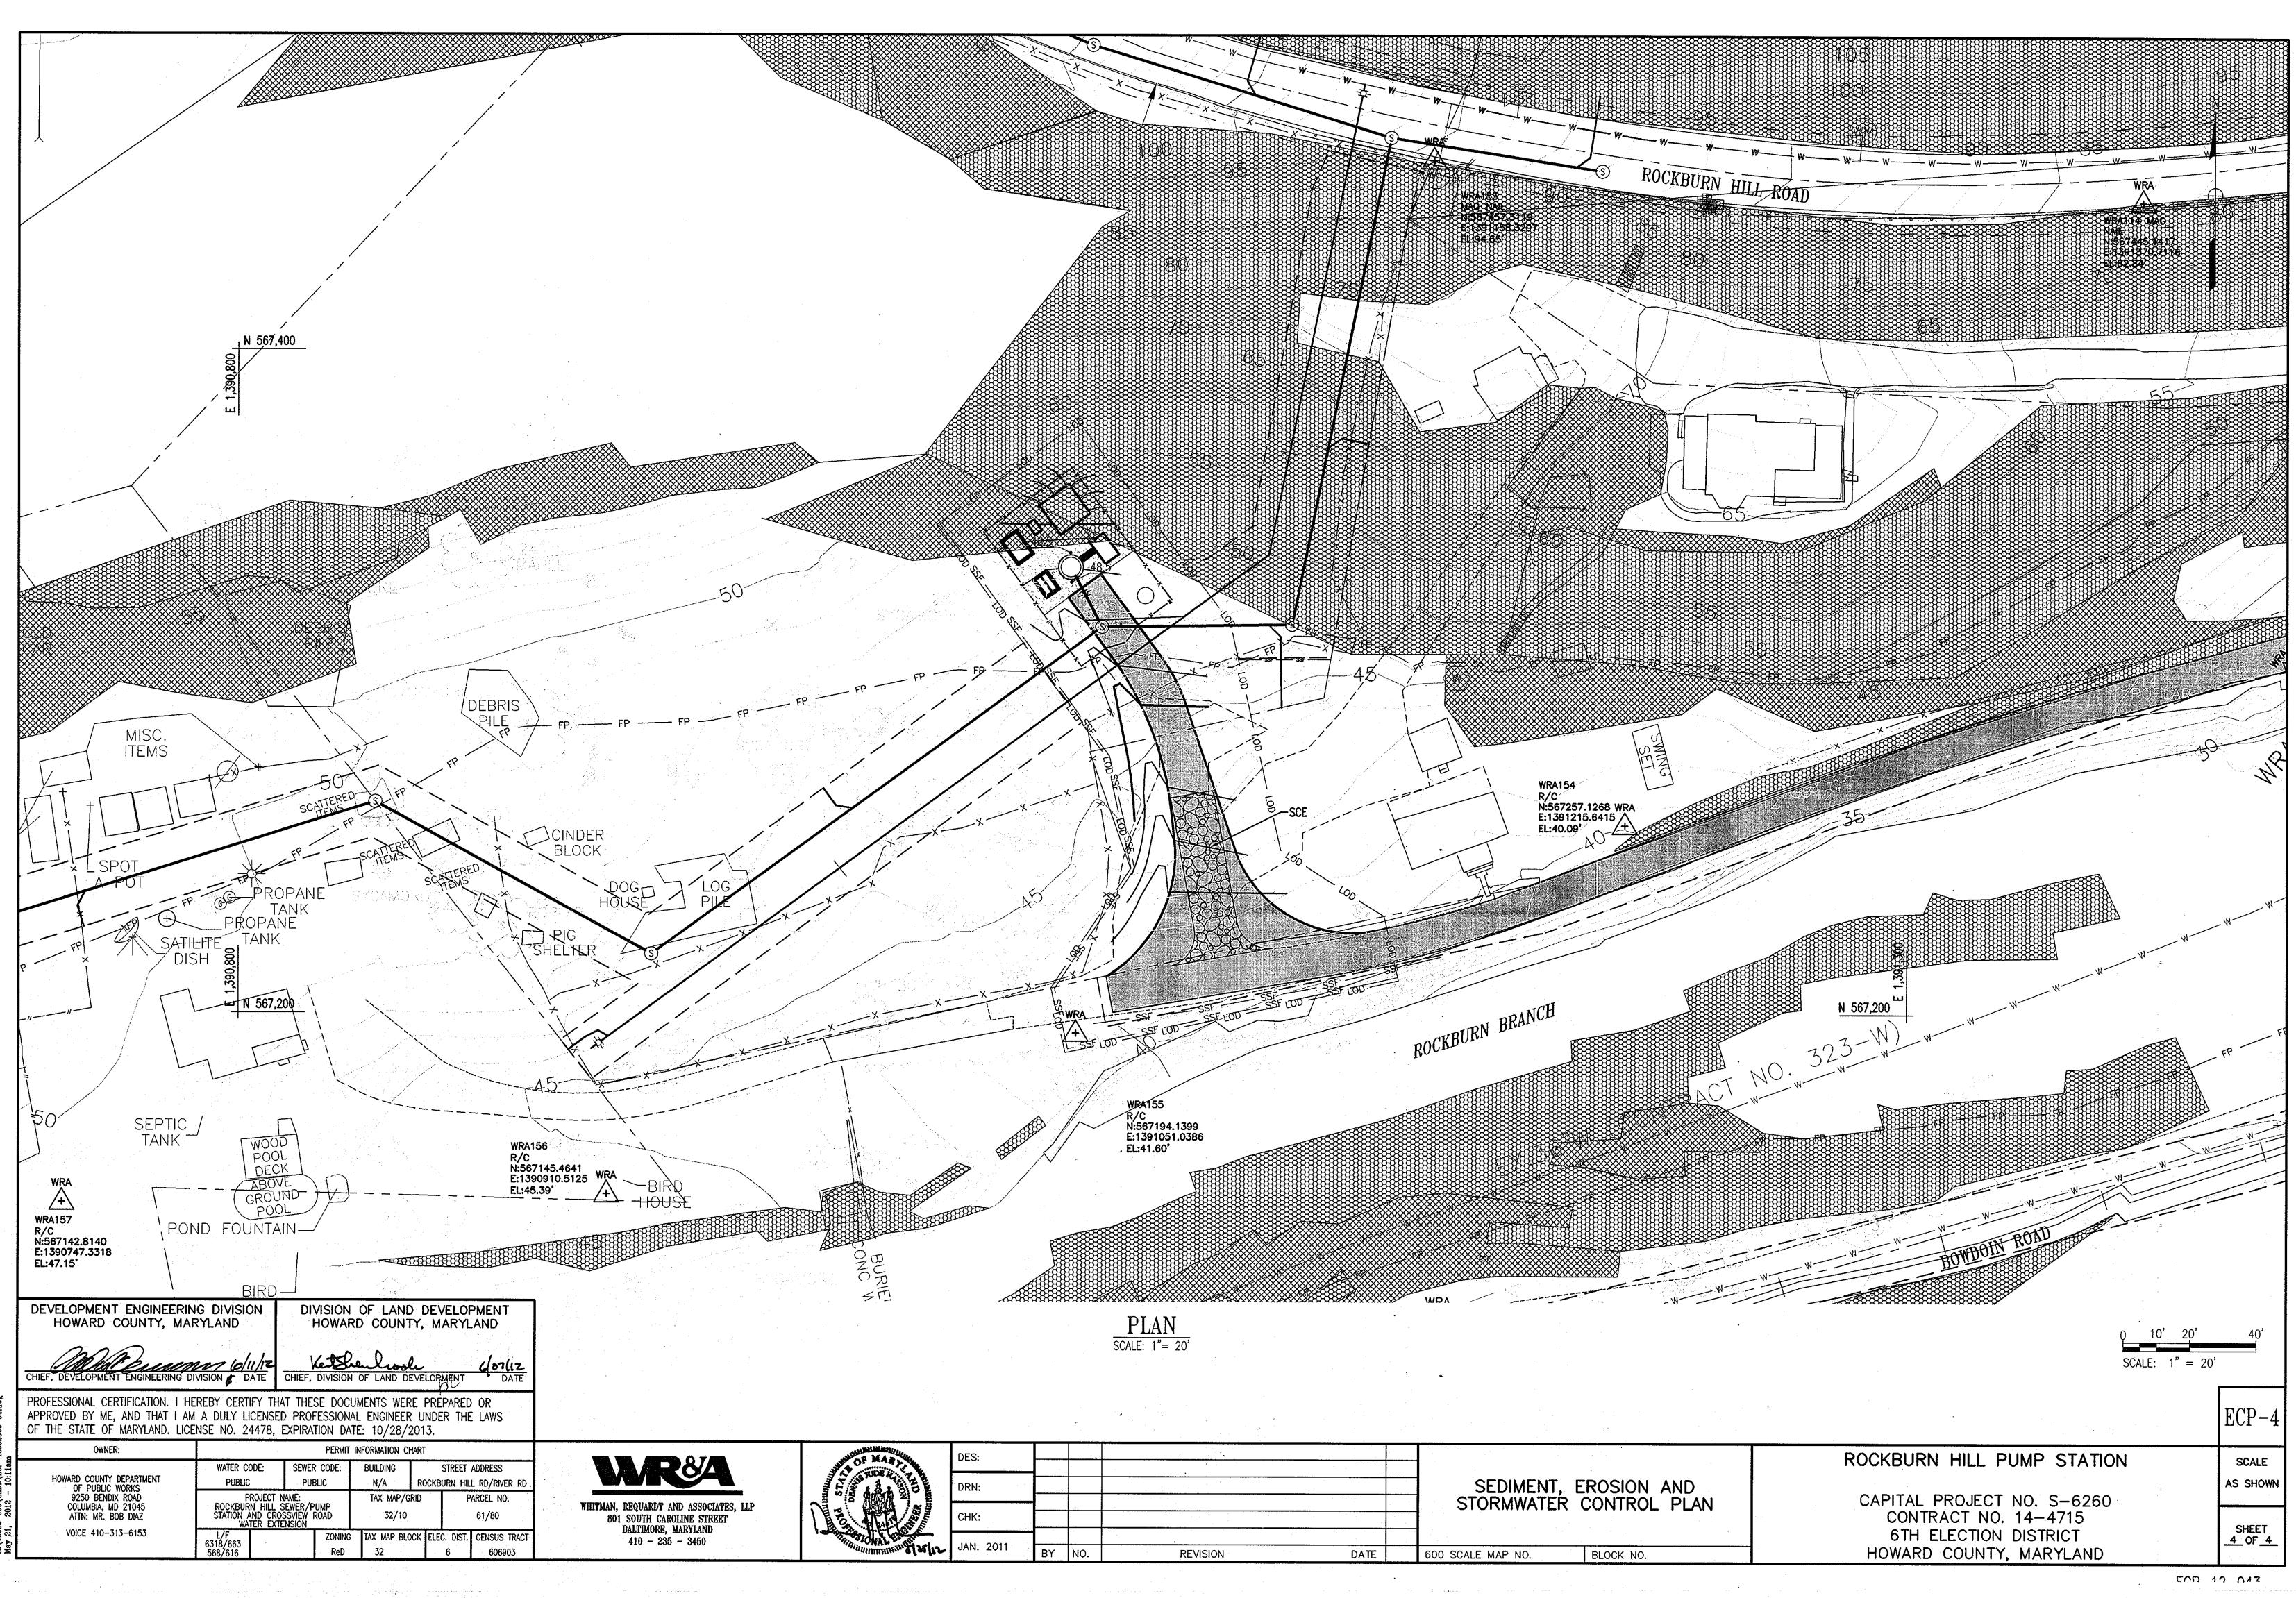
OTHER DPZ FILE REFERENCES RELATED TO THIS PROJECT: WP-12-144, PERTAINING TO SECTION 16.1205(a) OF THE REGULATIONS (REMOVAL OF SPECIMEN TREES). THIS WAIVER WAS APPROVED MARCH 23, 2012.

LEGEND



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