INDEX OF DRAWINGS

SHEET	DESCRIPTION
-234567891011213145-20	TITLE SHEET TYPICAL SECTIONS TYPICAL SECTIONS ROADWAY PLAN ROADWAY PLAN SEDIMENT AND EROSION CONTROL PLAN SEDIMENT AND EROSION CONTROL PLAN SEDIMENT AND EROSION CONTROL DETAILS ROADWAY PROFILES ROADWAY PROFILES ROADWAY PROFILES STORM DRAIN PROFILES GRADING\WATER QUALITY PLAN GRADING\WATER QUALITY PLAN CROSS SECTIONS

I. All construction shall be performed in accordance with the latest standards and

notify the engineer immediately if location of utilities is other than shown.

of Engineering/Construction Inspection Division at (410) 313-1880 at least five (5)

shall be repaired immediately at the contractor s expense.

signs be in place prior to the placement of any asphalt.

prepared by Daft McCune Walker Inc., dated October 1995.

prepared by Herbst & Associates, January 1996.

detremined and verified in accordance with AASHTO T-180.

14. All plan dimensions are to face of curb unless otherwise noted.

monument nos. 47E4 and 47EA were used for this project.

9. All hydraulic data is for the 10-year storm unless otherwise noted.

II. Gorman Road is a scenic road on the Howard County Scenic Road inventory.

working days prior to the start of work.

specifications of Howard County, plus MSHA standards and specifications if applicable

Approximate location of existing utilities are shown from best available information. The contractor shall take all necessary precautions to protect the existing utilities and maintain uninterrupted service. Any damage incurred due to contractor•s operation

4. The contractor shall notify •Miss Utility• at I-800-257-777 at least 48 hours prior to any excavation work being done, and shall notify the Department of Public Works/Bureau

5. Traffic controldevices, markings, and signing shallbe in accordance with the latest edition of the Manualon Uniform Traffic ControlDevices (MUTCD). All street and regulatory

7. The existing topography in the area of Road "B" is taken from a field run survey with two foot contour intervals prepared by Schmidt Pfetlz & McDonald, Inc., dated January 1995. The existing topography in the area of Road "A" is taken from field run survey with two foot contour intervals

6. Any damage caused by the Contractor to existing public right-of-way, existing paving, existing curb and gutter, existing utilities, etc. shallbe at the Contactors expense.

8. All inlets shall be constructed in accordance with Howard County Standards or MSHA Standards as specified on structure schedule.

10. Required soilerosion and sedimentation control measures shall be provided, installed and

12. The subsurface exploration and geotechnical engineering analysis for this project was

13. All fill areas shall be compacted to a minimum of 95% of the maximum dry density as

15. The coordinates shown hereon are based upon the Howard County geodetic control


which is based upon the Maryland State plane coordination system. Howard County

16. The Design Speed of Road "A" and Road "C" is 40 MPH. The Design Speed of Road "B" is 30 MPH.

The contractor shall test pit existing utilities at least—five (5) days before starting work shown on these drawings to verify their location and elevation. The contractor shall

HOWARD COUNTY, MARYLAND DEPARTMENT OF PUBLIC WORKS

GORMAN ROAD REALIGNMENT CAPITOL PROJECT E-0935

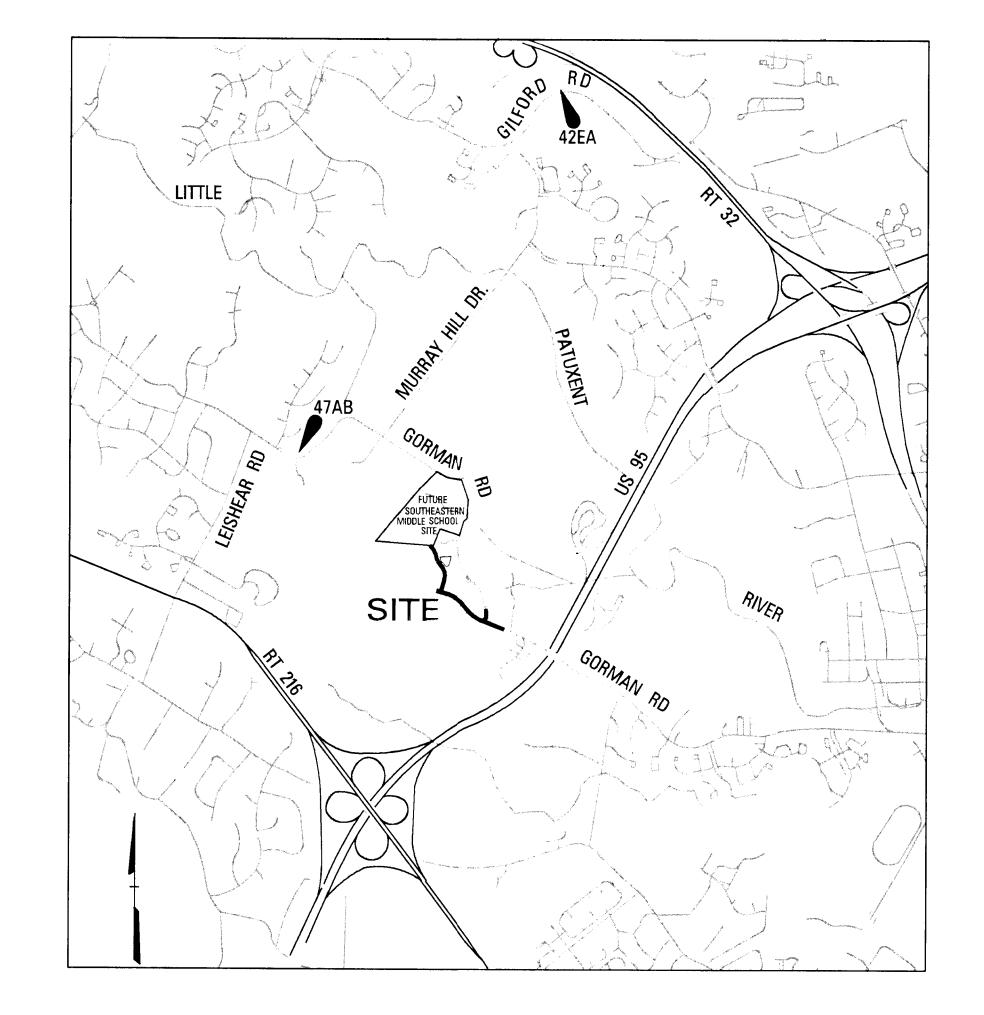

LOCATION MAP SCALE: 1" = 2000'

OWNER /DEVELOPERS CERTIFICATE:

I/WE CERTIFY THAT ALL DEVELOPMENT AND/OR CONSTRUCTION WILL BE DONE ACCORDING TO THESE PLANS AND THAT ANY RESPONSIBLE PERSONNEL INVOLVED IN THE CONSTRUCTION PROJECT WILL HAVE A CERTIFICATE OF ATTENDANCE AT A DEPARTMENT OF ENVIRONMENT APPROVED TRAINING PROGRAM FOR THE CONTROL OF SEDIMENT AND EROSION BEFORE BEGINNING THE PROJECT. LALSO AUTHORIZE PERIODIC ON-SITE INSPECTIONS BY THE HOWARD SOIL CONSERVATION DISTRICT.

SIGNATURE OF DEVELOPER PRINT NAME BELOW SIGNATURE DATE

ENGINEERS CERTIFICATE:

ICERTIFY THAT THIS PLAN FOR POND CONSTRUCTION, EROSION AND SEDIMENT CONTROL REPRESENTS A PRACTICAL AND WORKABLE PLAN BASED ON MY PERSONAL KNOWLEDGE OF THE SITE CONDITIONS. THIS PLAN WAS PREPARED IN ACCORDANCE WITH THE REQUIRMENTS OF THE HOWARD SOIL CONSERVATION DISTRICT.

SIGNATURE OF ENGINEER PRINT NAME BELOW SIGNATURE

DATE

THESE PLANS HAVE BEEN REVIEWED FOR THE HOWARD SOIL CONSERVATION DISTRICT AND MEET THE TECHNICAL REQUIREMENTS FOR SMALL POND CONSTRUCTION, SOIL EROSION AND SEDIMENT CONTROL.

U.S.D.A. NATURAL RESOURCES CONSERVATION SERVICE

DATE

THESE PLANS FOR SMALL POND CONSTRUCTION, SOIL EROSION AND SEDIMENT CONTROL MEET THE REQUIREMENTS OF HOWARD SOIL CONSERVATION DISTRICT.

APPROVE

__BLOCK NO. ____2

1/18/96

HOWARD SOIL CONSERVATION DISTRICT

DATE

PENDING COUNTY APPROVAL

BENCHMARK

maintained.

HOWARD COUNTY, MARYLAND

DIRECTOR OF PUBLIC WORKS

DATE

CHIEF, BUREAU OF ENGINEERING

CHIEF, DIVISION OF TRANSPORTATION PROJECTS AND WATERSHED MANAGEMENT

DEPARTMENT OF PUBLIC WORKS

HORIZONTAL (NAD 83) AND VERTICAL (NVD 29) CONTROL BASED UPON HOWARD COUNTY TRAVERSE POINTS 47AB, 42EA, AND 1941005

Daft · McCune · Walker, Inc.

A Team of Land Planners, Landscape Architects.

200 East Pennsylvania Avenue Towson, Maryland 21286

Ingineers.Surveyors &

Invironmental Professionals

DESIGN BY:

JWS
DRAWN BY:
JWS
CHECKED BY:

DATE:
JAN. 18, 1996 BY NO.

REVISION

DATE 600 SCALE MAP NO. 47


GORMAN ROAD REALIGNMENT CAPITAL PROJECT E-0935 ELECTION DISTRICT NO. 6

HOWARD COUNTY MARYLAND

SCALE AS SHOWN

SHEET

Tue Jan 16 20:54:57 1996 d:\94140d\94140dtsl

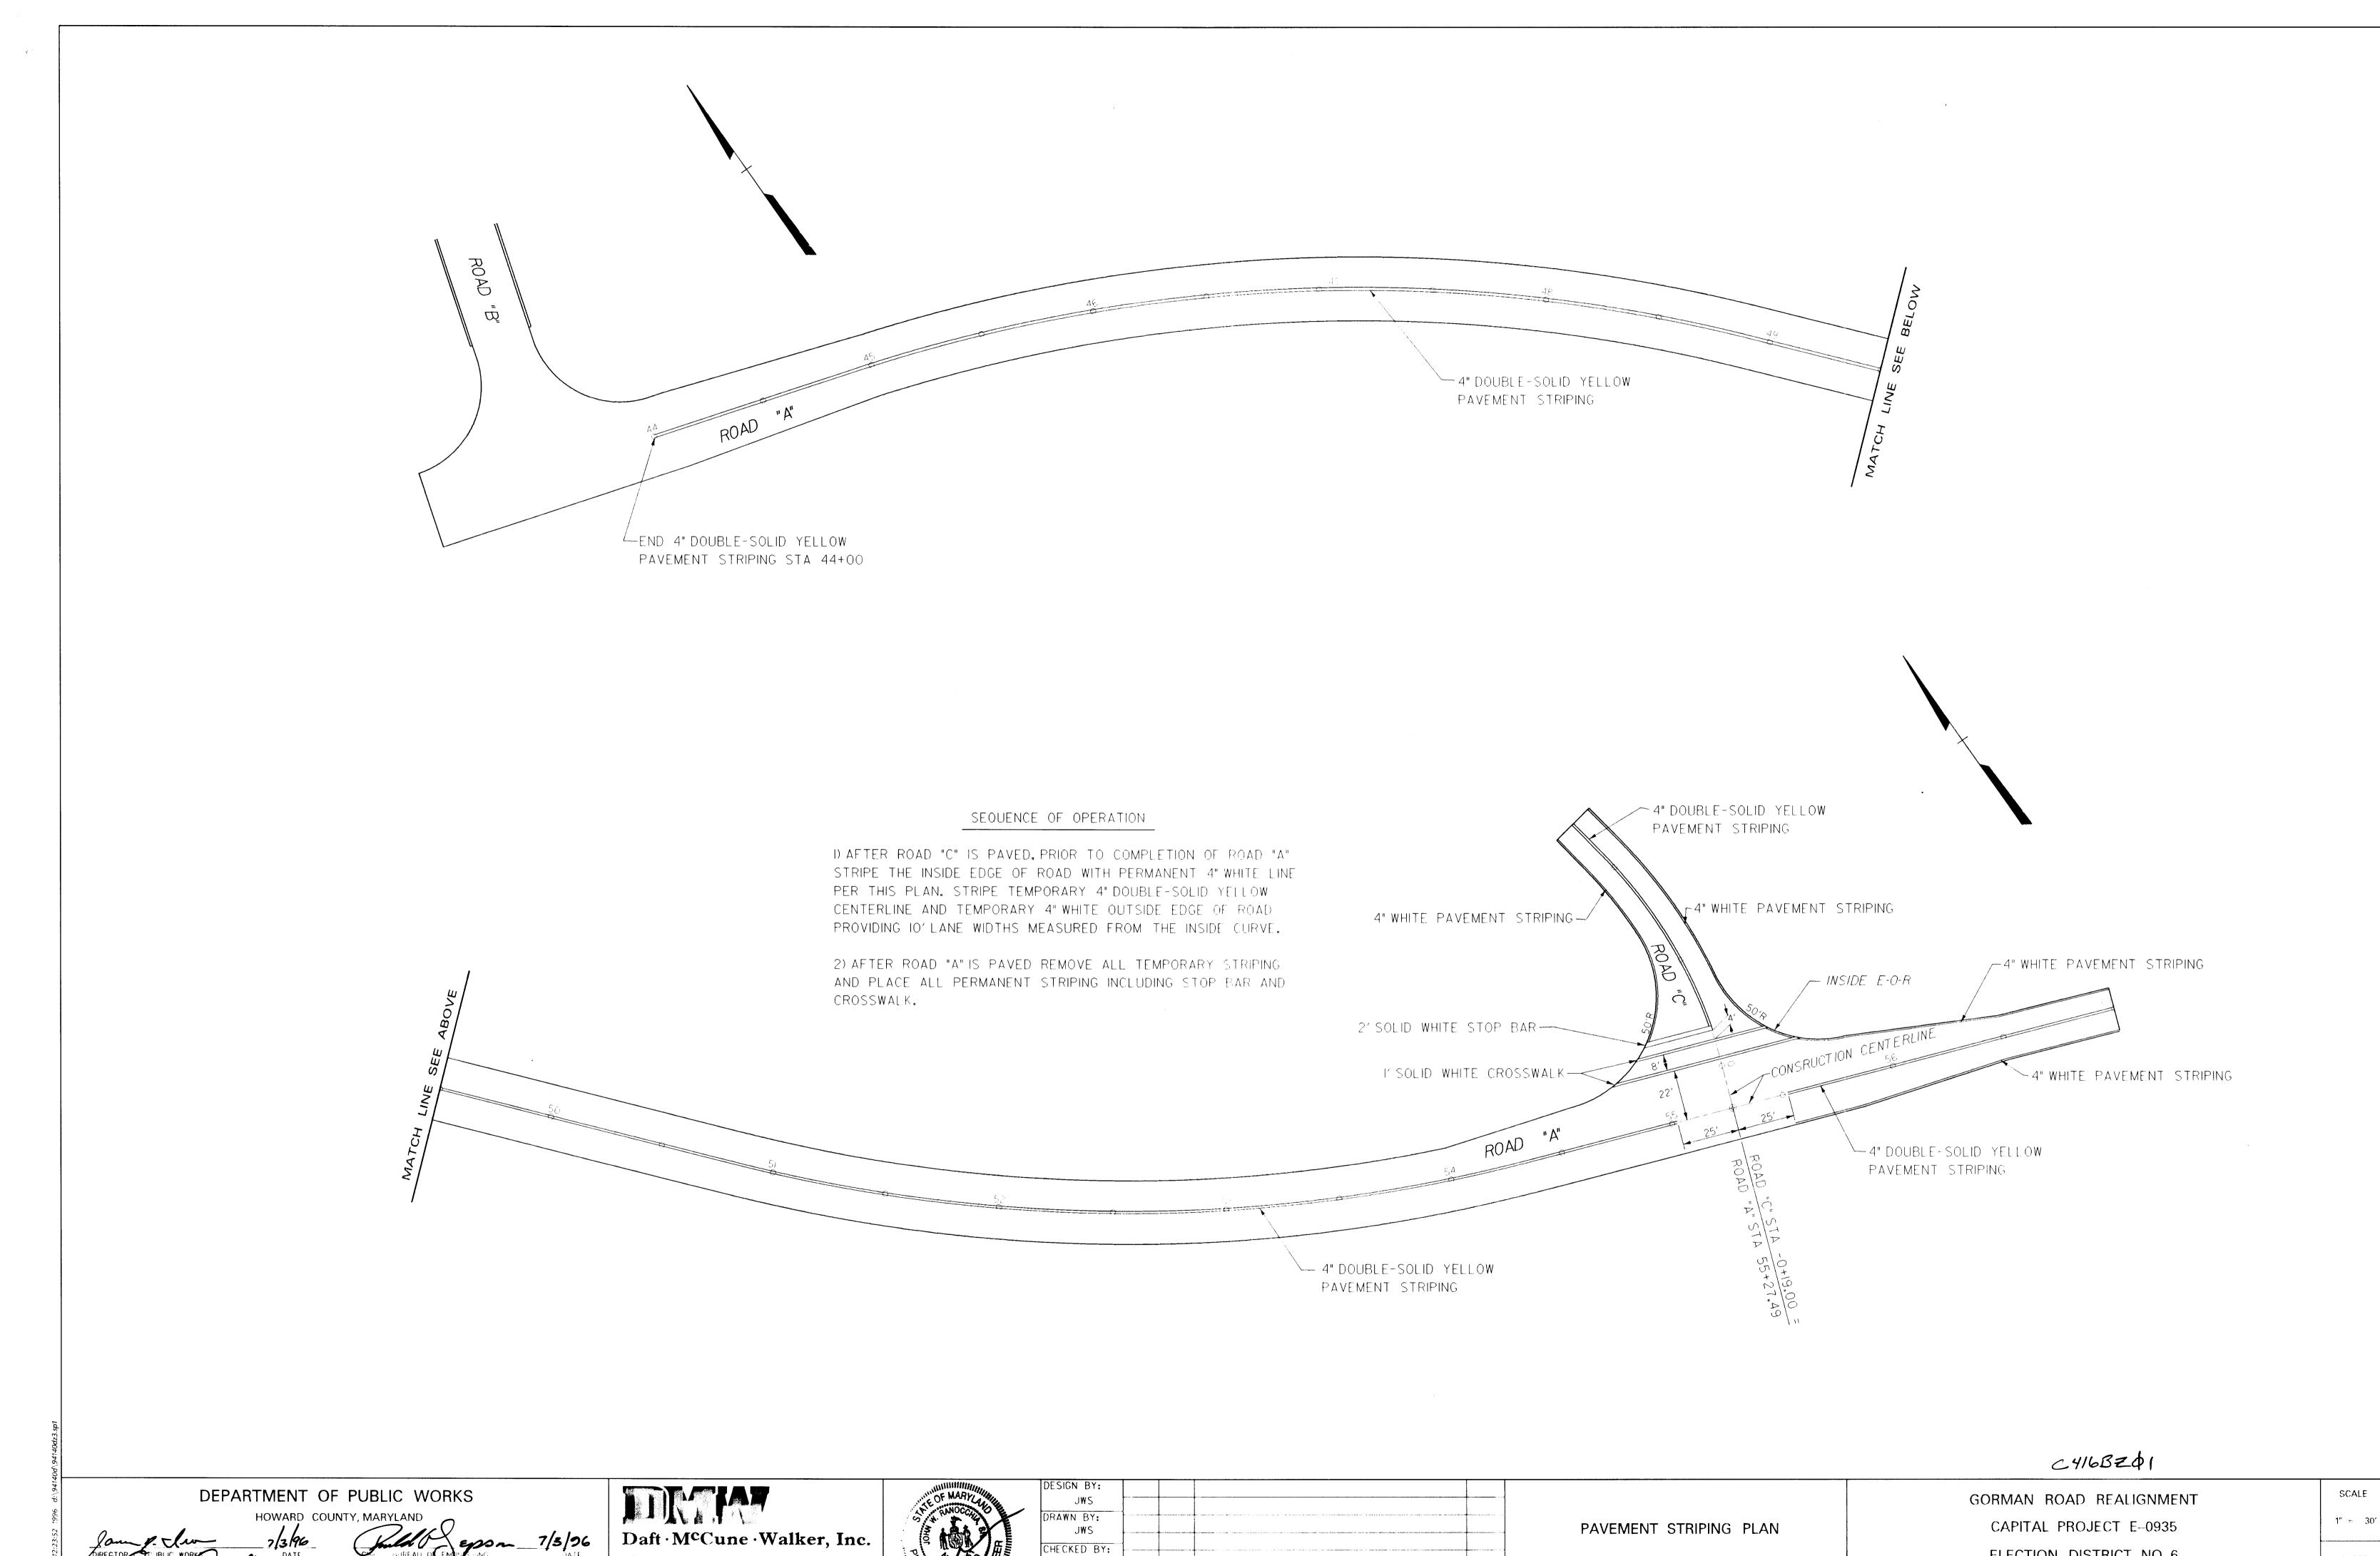

JWR

July 1, 1996 BY NO.

REVISION

DATE:

A Team of Land Flanners. 200 East Pennsylvania Avenue Landscape Architects. Towson Maryland 21286 Engineers Surveyors & 410-296-3333 Environmental Professionals Fax 296-4705

Landscape Architects, Engineers, Surveyors & Environmental Professionals

CHIEF, DIVISION OF TRANSPORTATION PROJECTS AND WATERSHED MANAGEMENT


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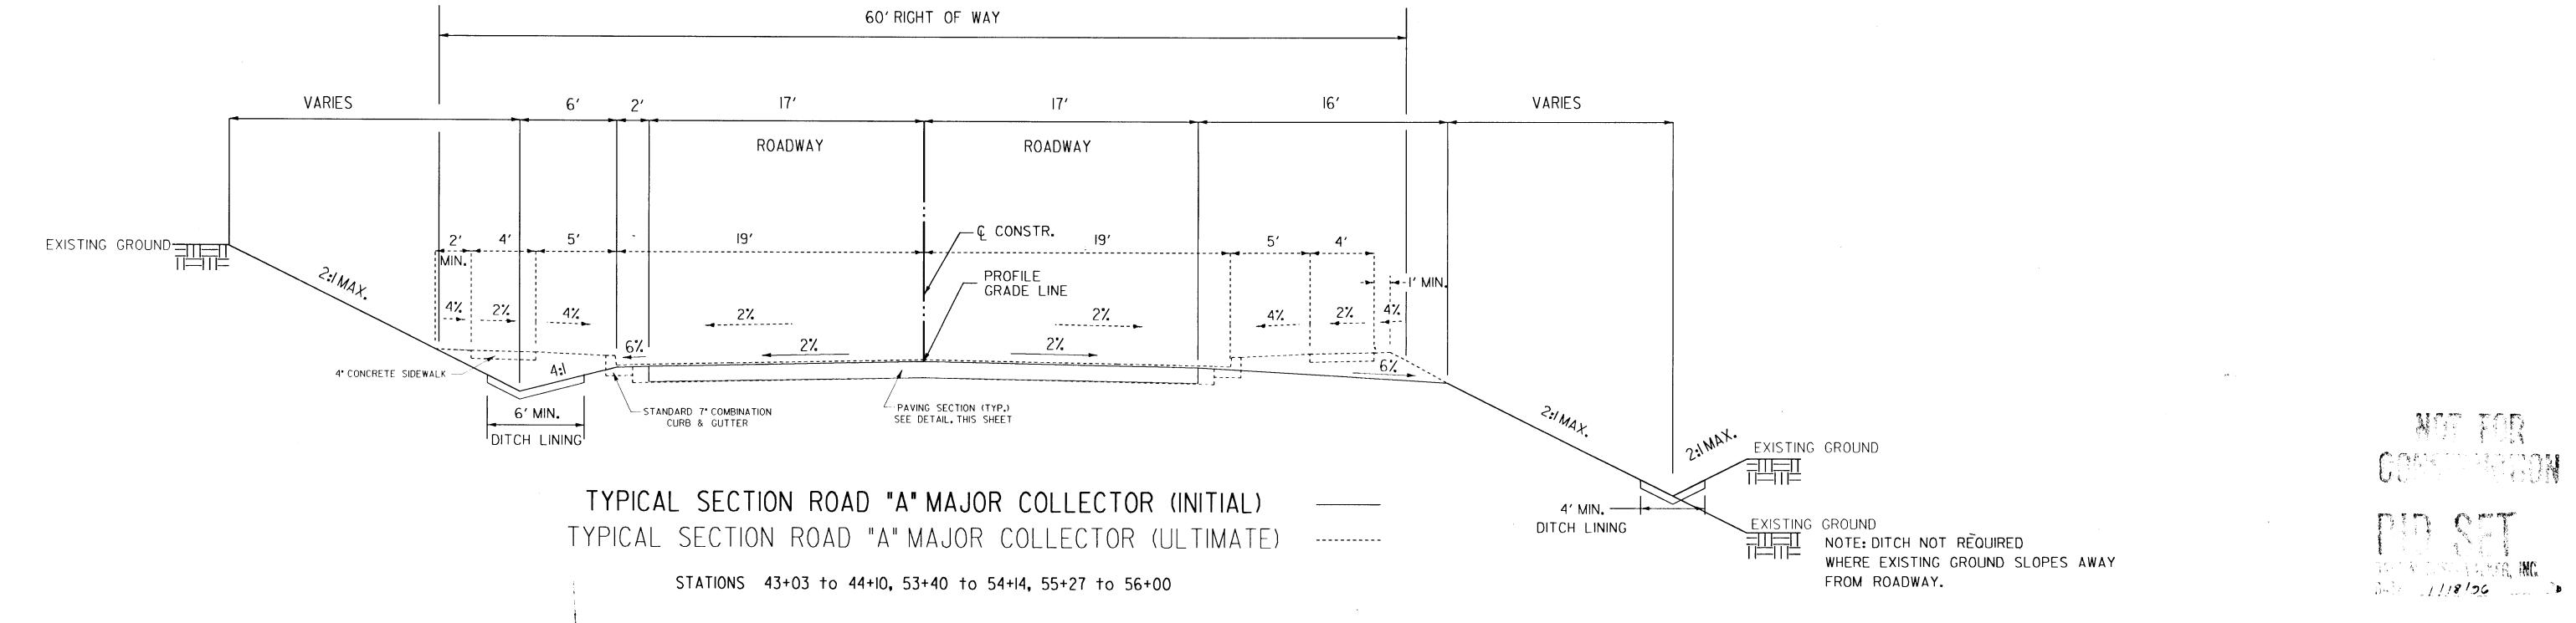
1 OF 1

ELECTION DISTRICT NO. 6

HOWARD COUNTY MARYLAND

DATE 600 SCALE MAP NO. 47 BLOCK NO. 2



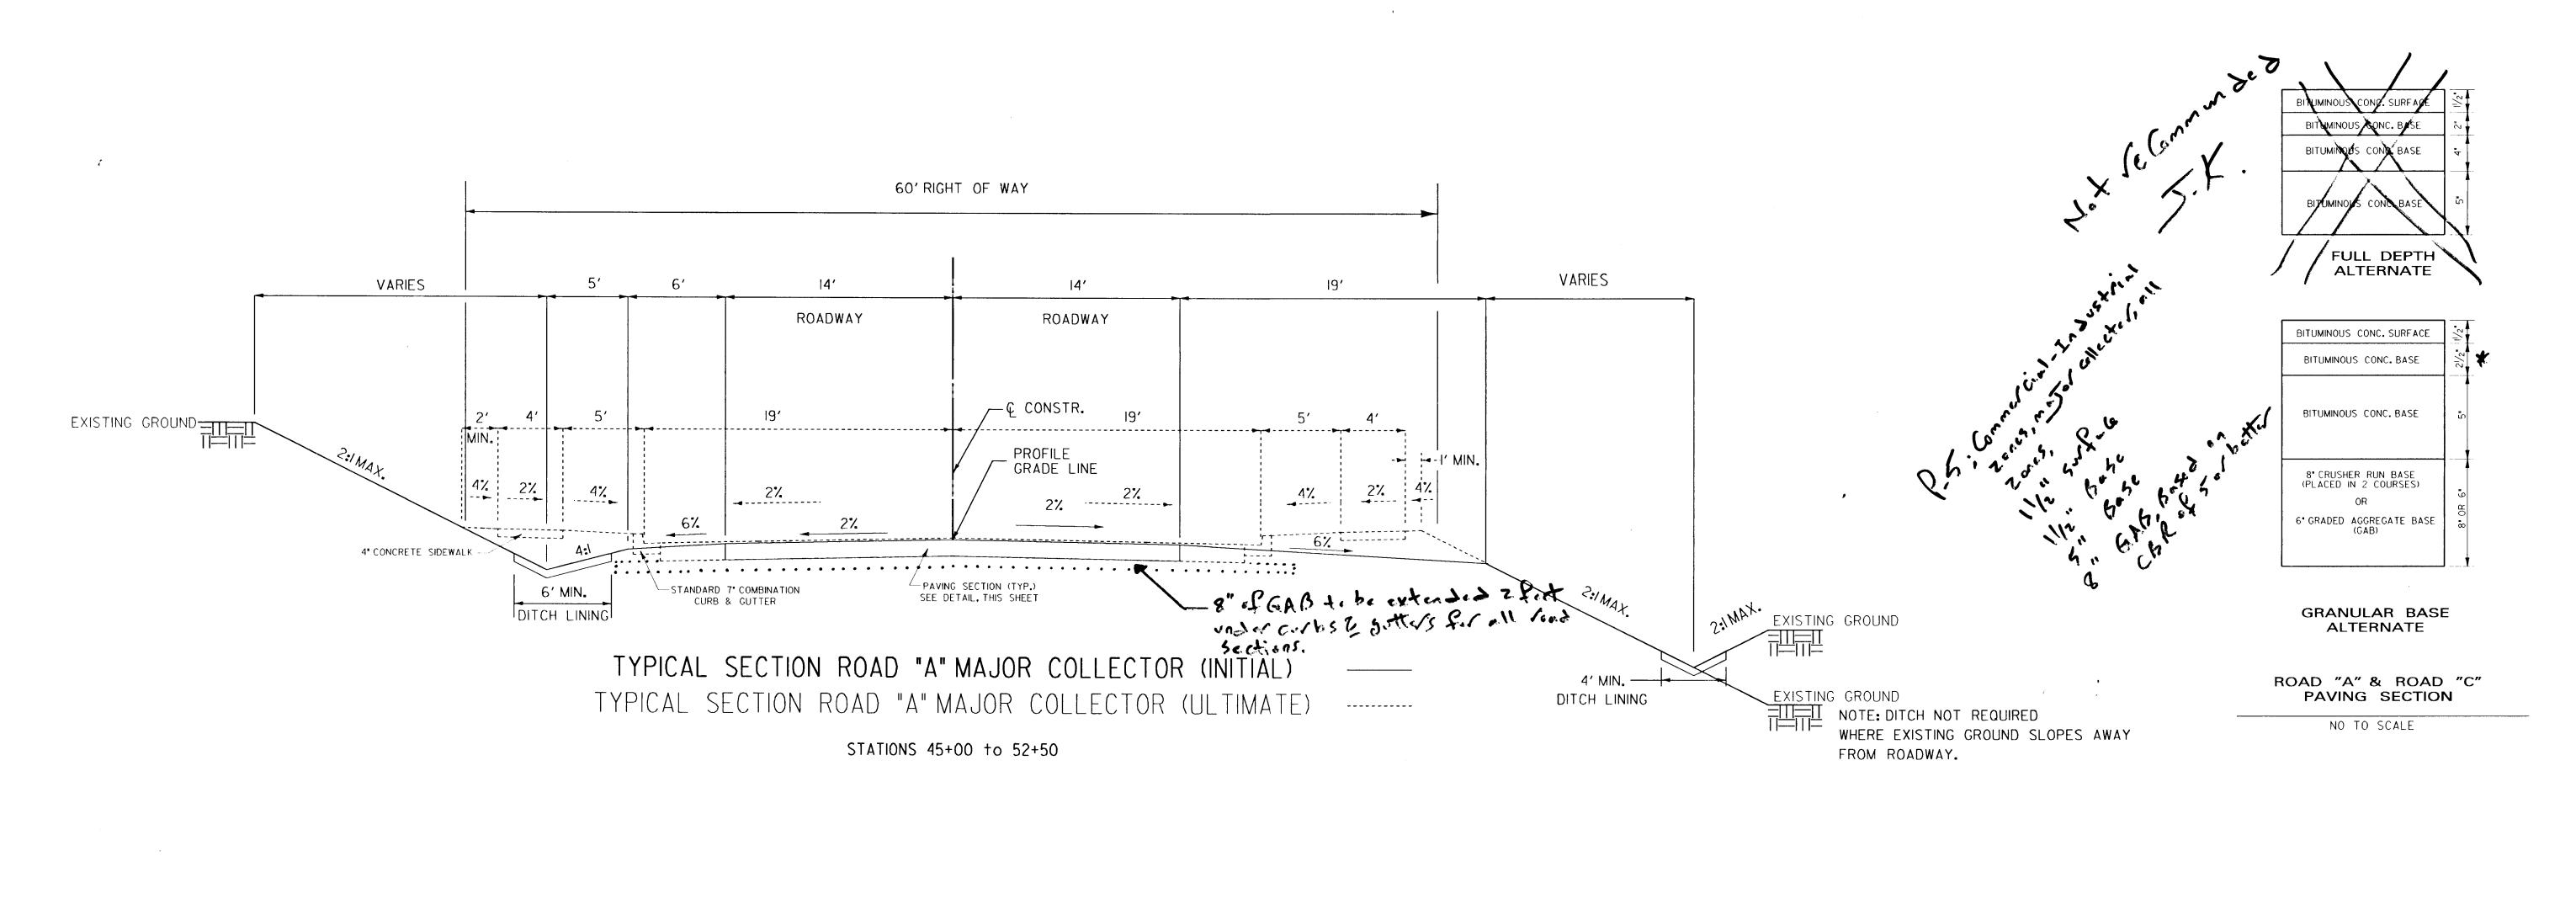

C416BZ02

	NOTE: SEE ROADWAY	PLAN, SHEET 5, FOR DITCH LOCATIONS.
DEPARTMENT OF PUBLIC WORKS		DESIGN BY: JWS
HOWARD COUNTY, MARYLAND		DRAWN BY:

DIRECTOR OF PUBLIC WORKS	DATE	CHIEF, BUREAU OF ENGINEERING	DATE
CHIEF, BUREAU OF HIGHWAYS	DATE	CHIEF, DIVISION OF TRANSPORTATION PROJECTS AND WATERSHED MANAGEMENT	DATE

Daft · M ^c Cun	e·Walker, Inc.
A Team of Land Planners,	200 East Pennsylvania Avenue
Landscape Architects,	Towson,Maryland 21286
Engineers, Surveyors &	410 296 3333
Environmental Professionals	Fax 296 4705

DESIGN BY:					
JWS					
DRAWN BY:	l				
JWS					TYPICAL SECTION
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DATE:					
JAN. 18, 1996	BY	NO.	REVISION	DATE	600 SCALE MAP NO 47 BLOCK NO 2


ORMAN ROAD REALIGNMENT
CAPITAL PROJECT E-0935
ELECTION DISTRICT NO. 6
OWARD COUNTY MARYLAND


SCALE

1" = 5'

SHEET


2 OF 20

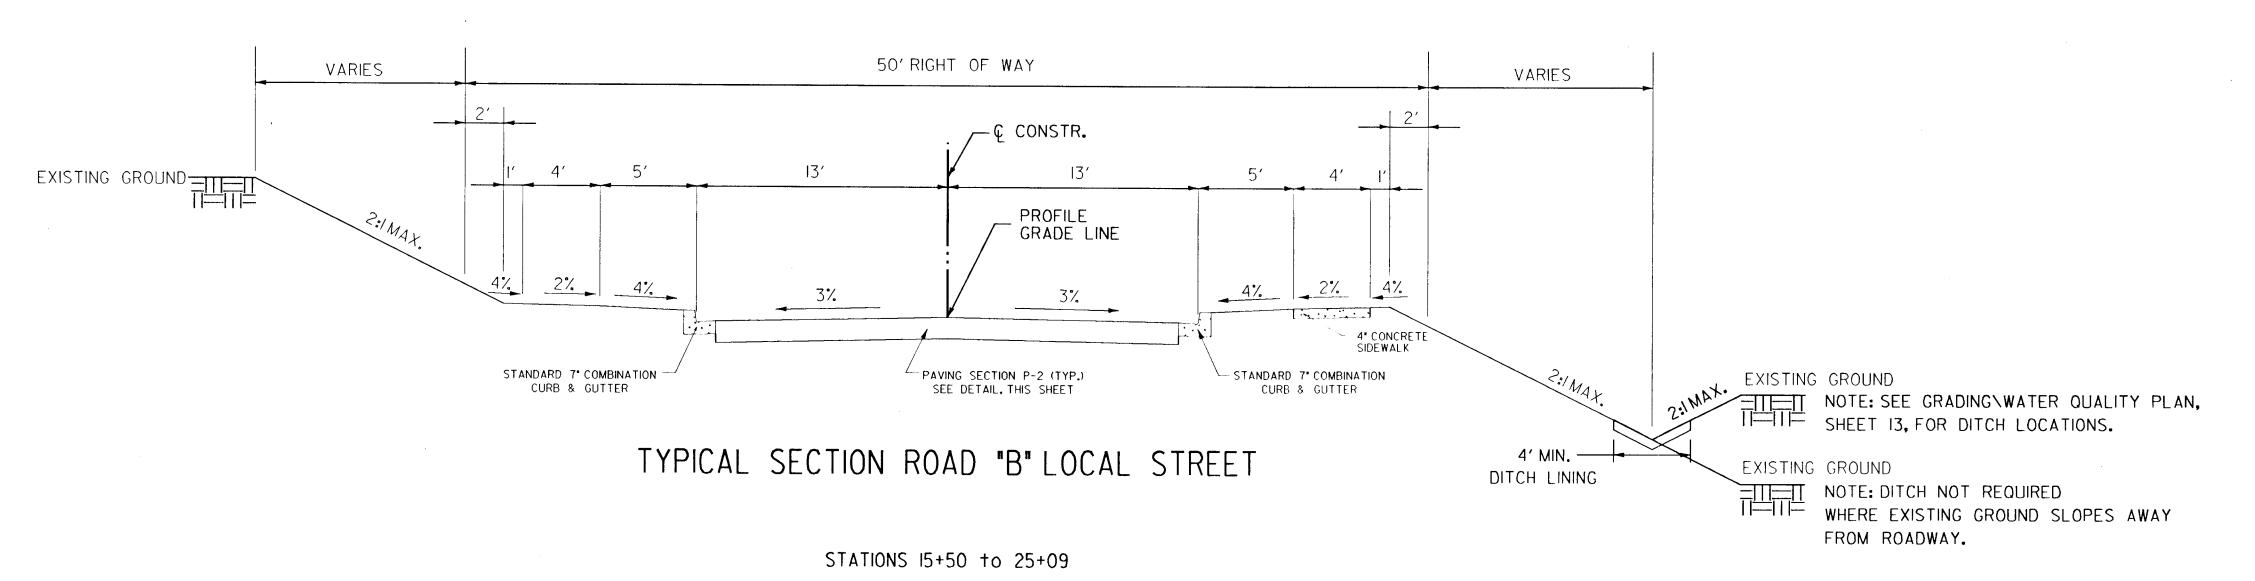

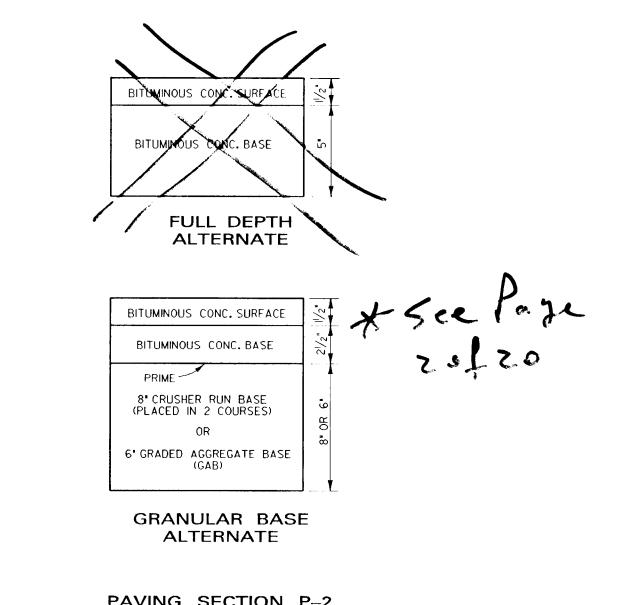

PAVING SECTION P-2 (ROAD "B" PAVING SECTION)

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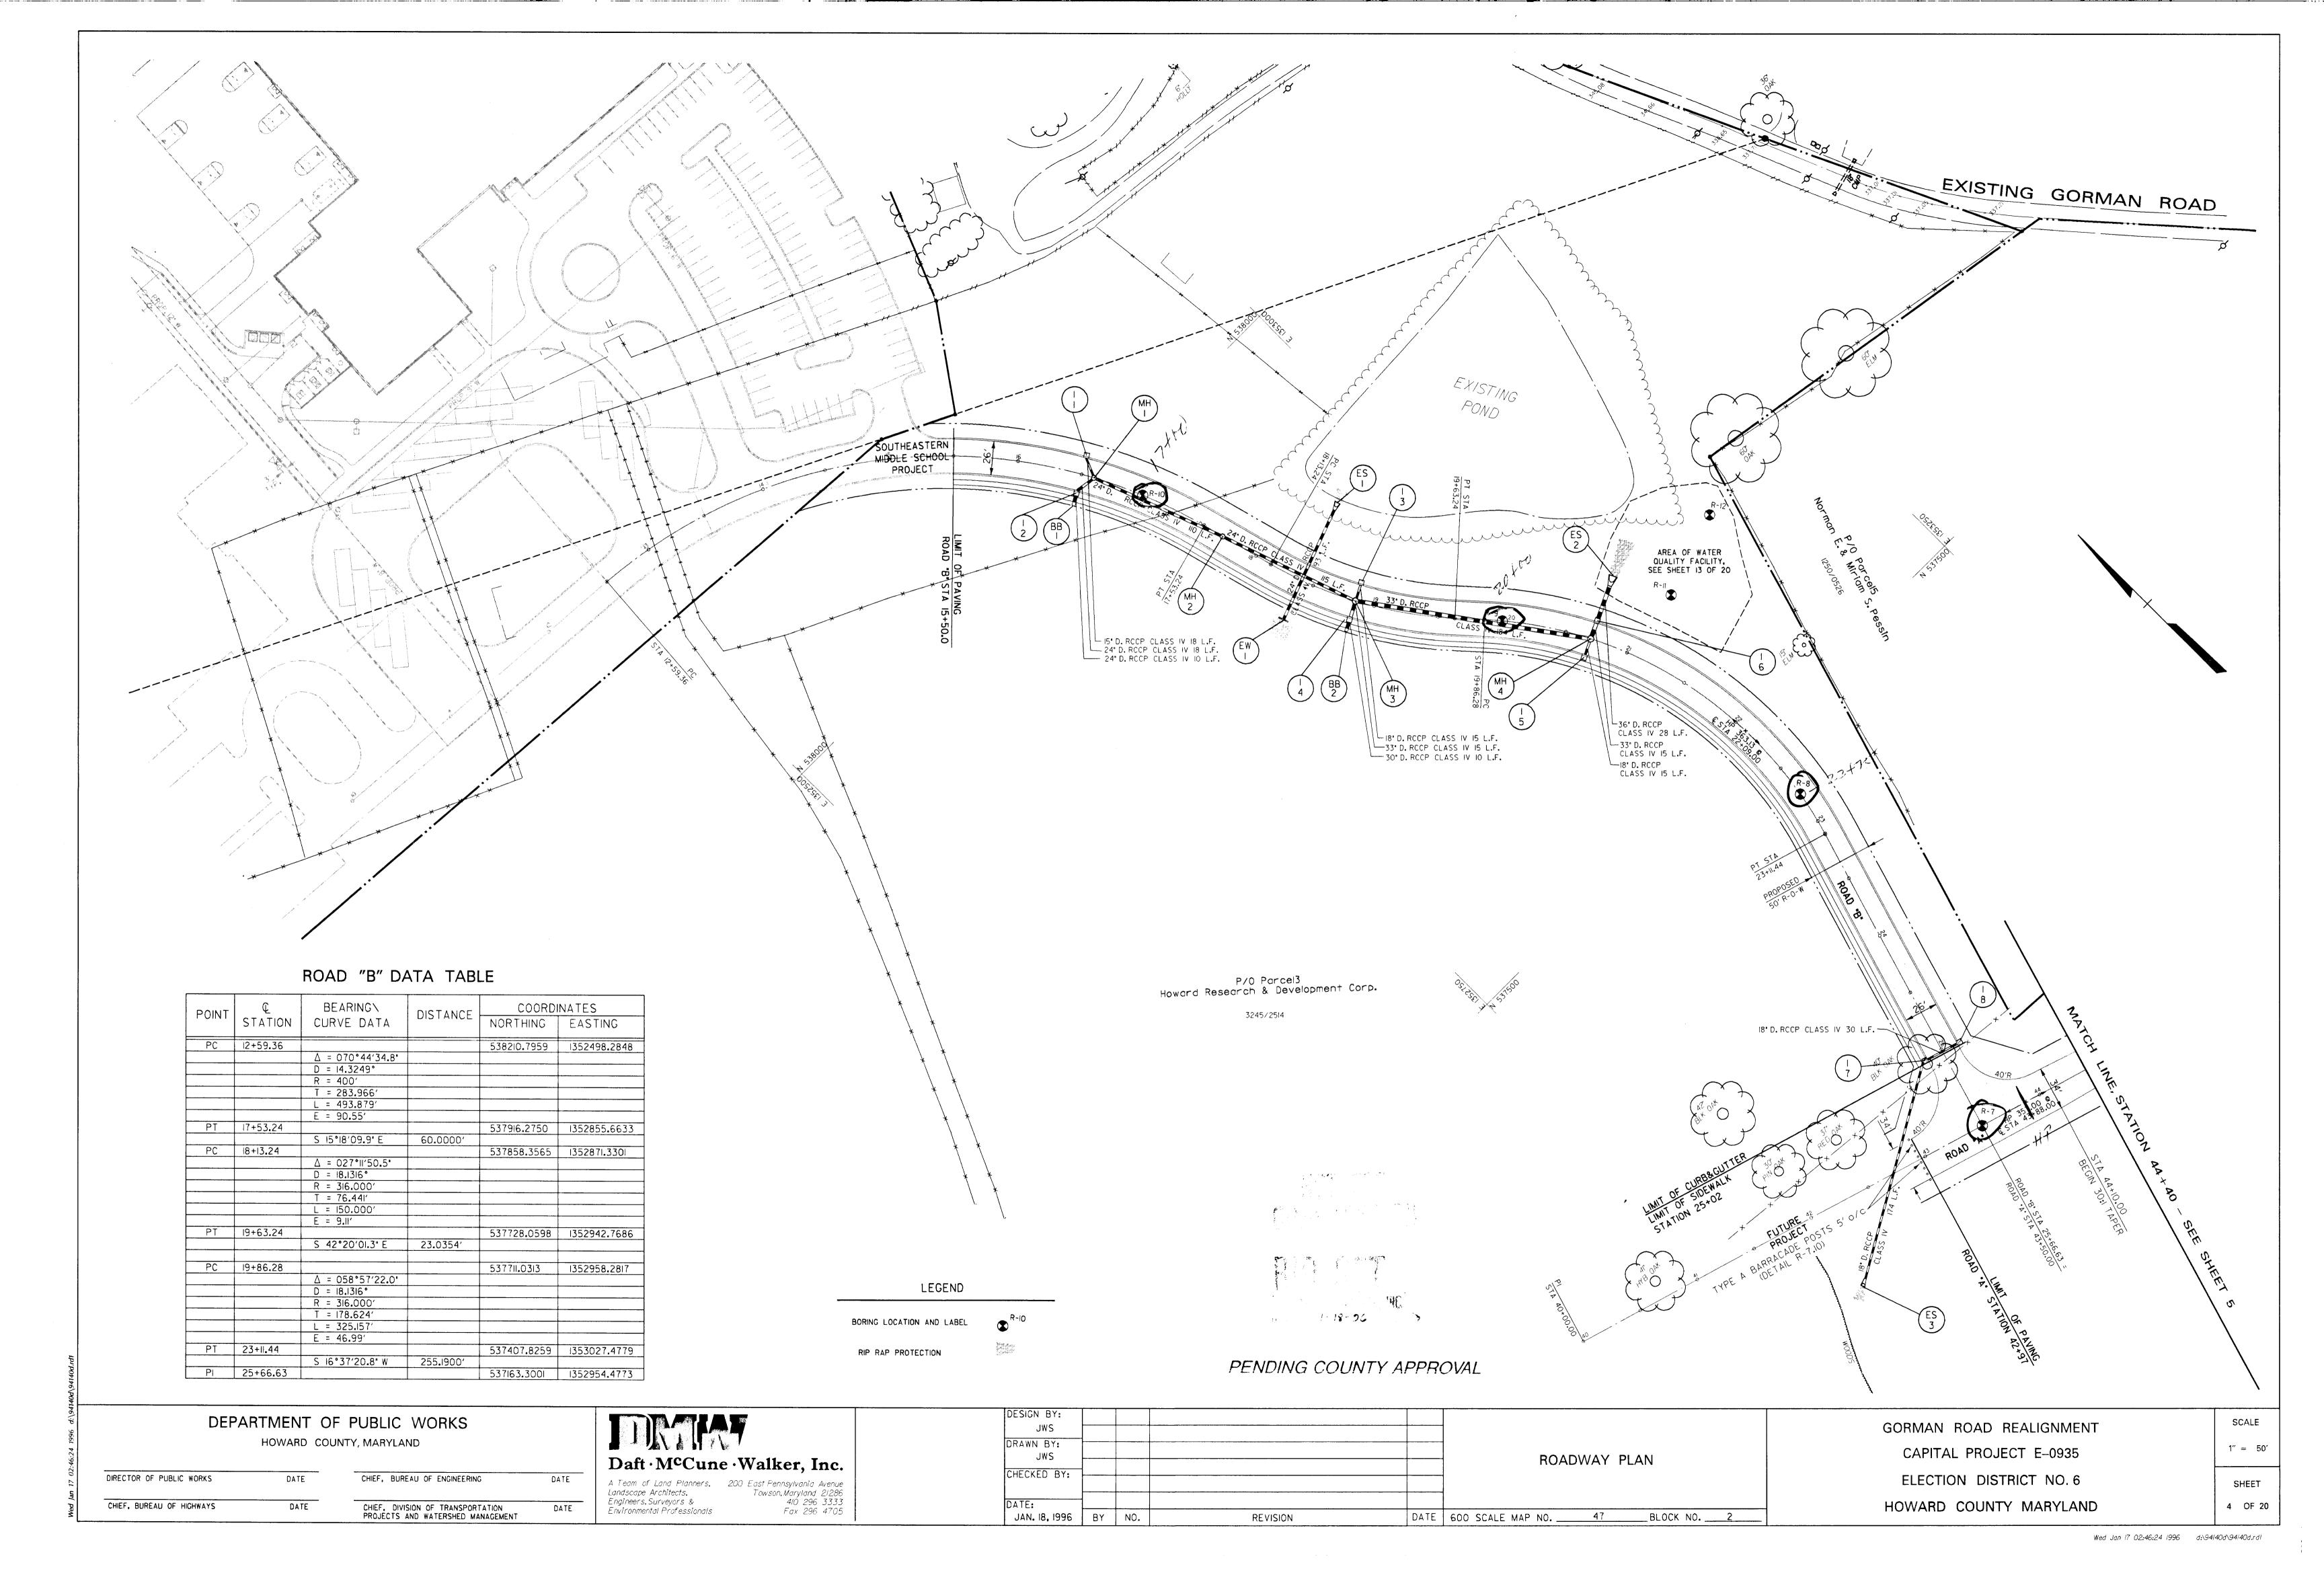


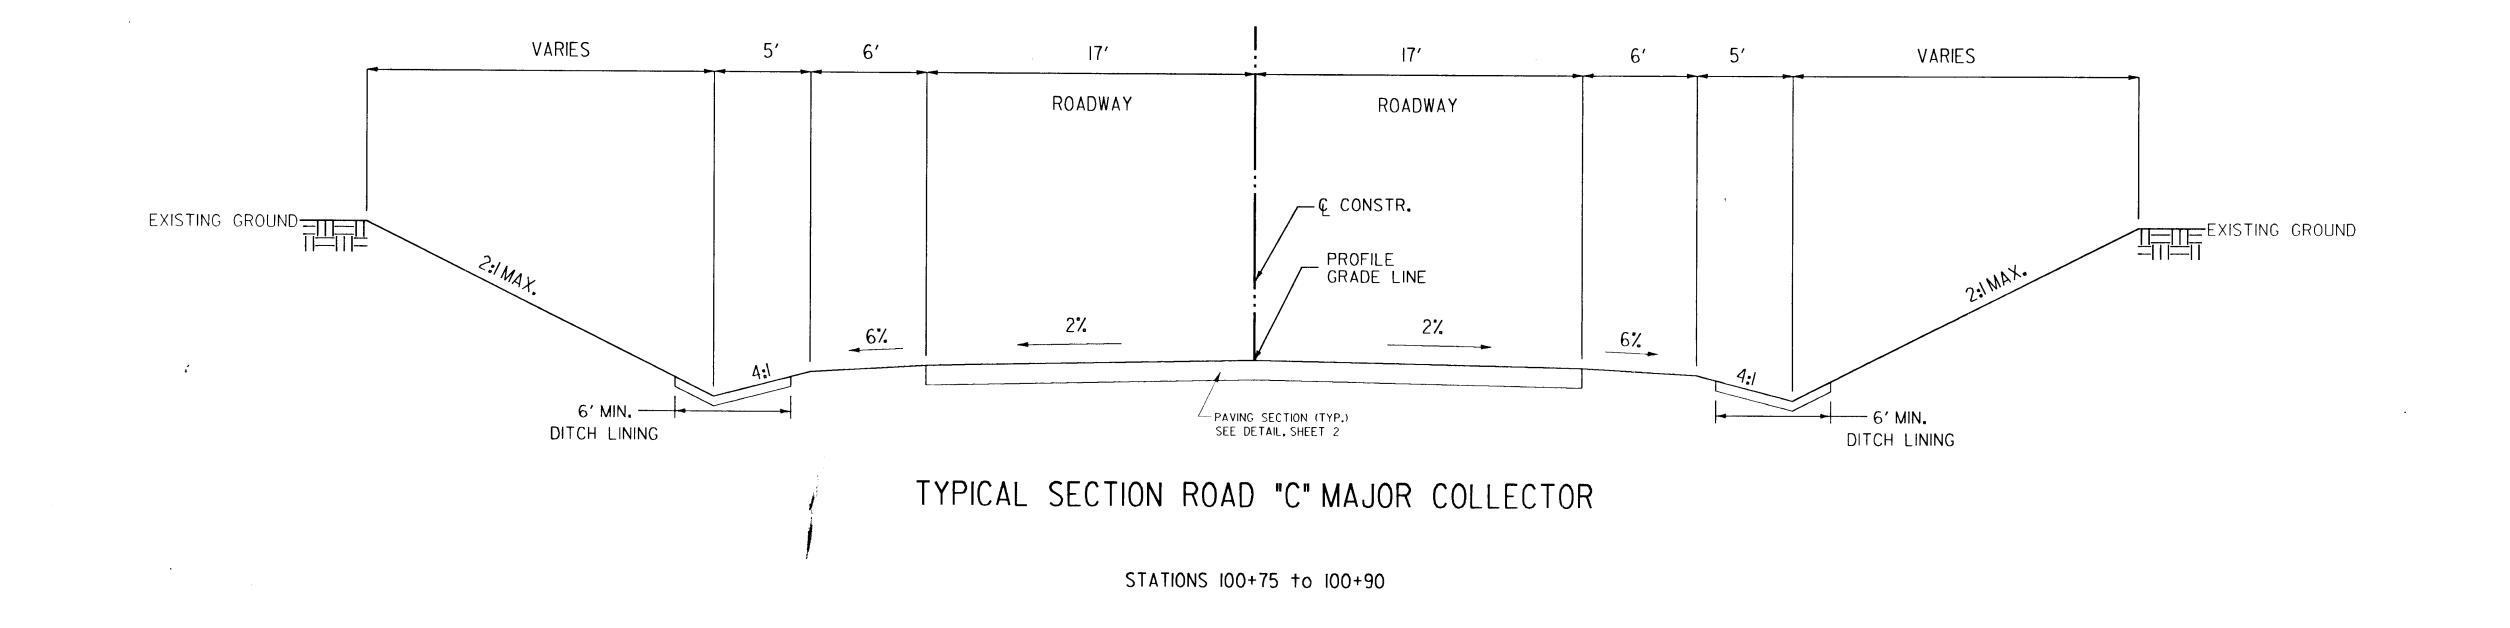
NOTE: SEE ROADWAY PLAN, SHEET 5, FOR DITCH LOCATIONS.


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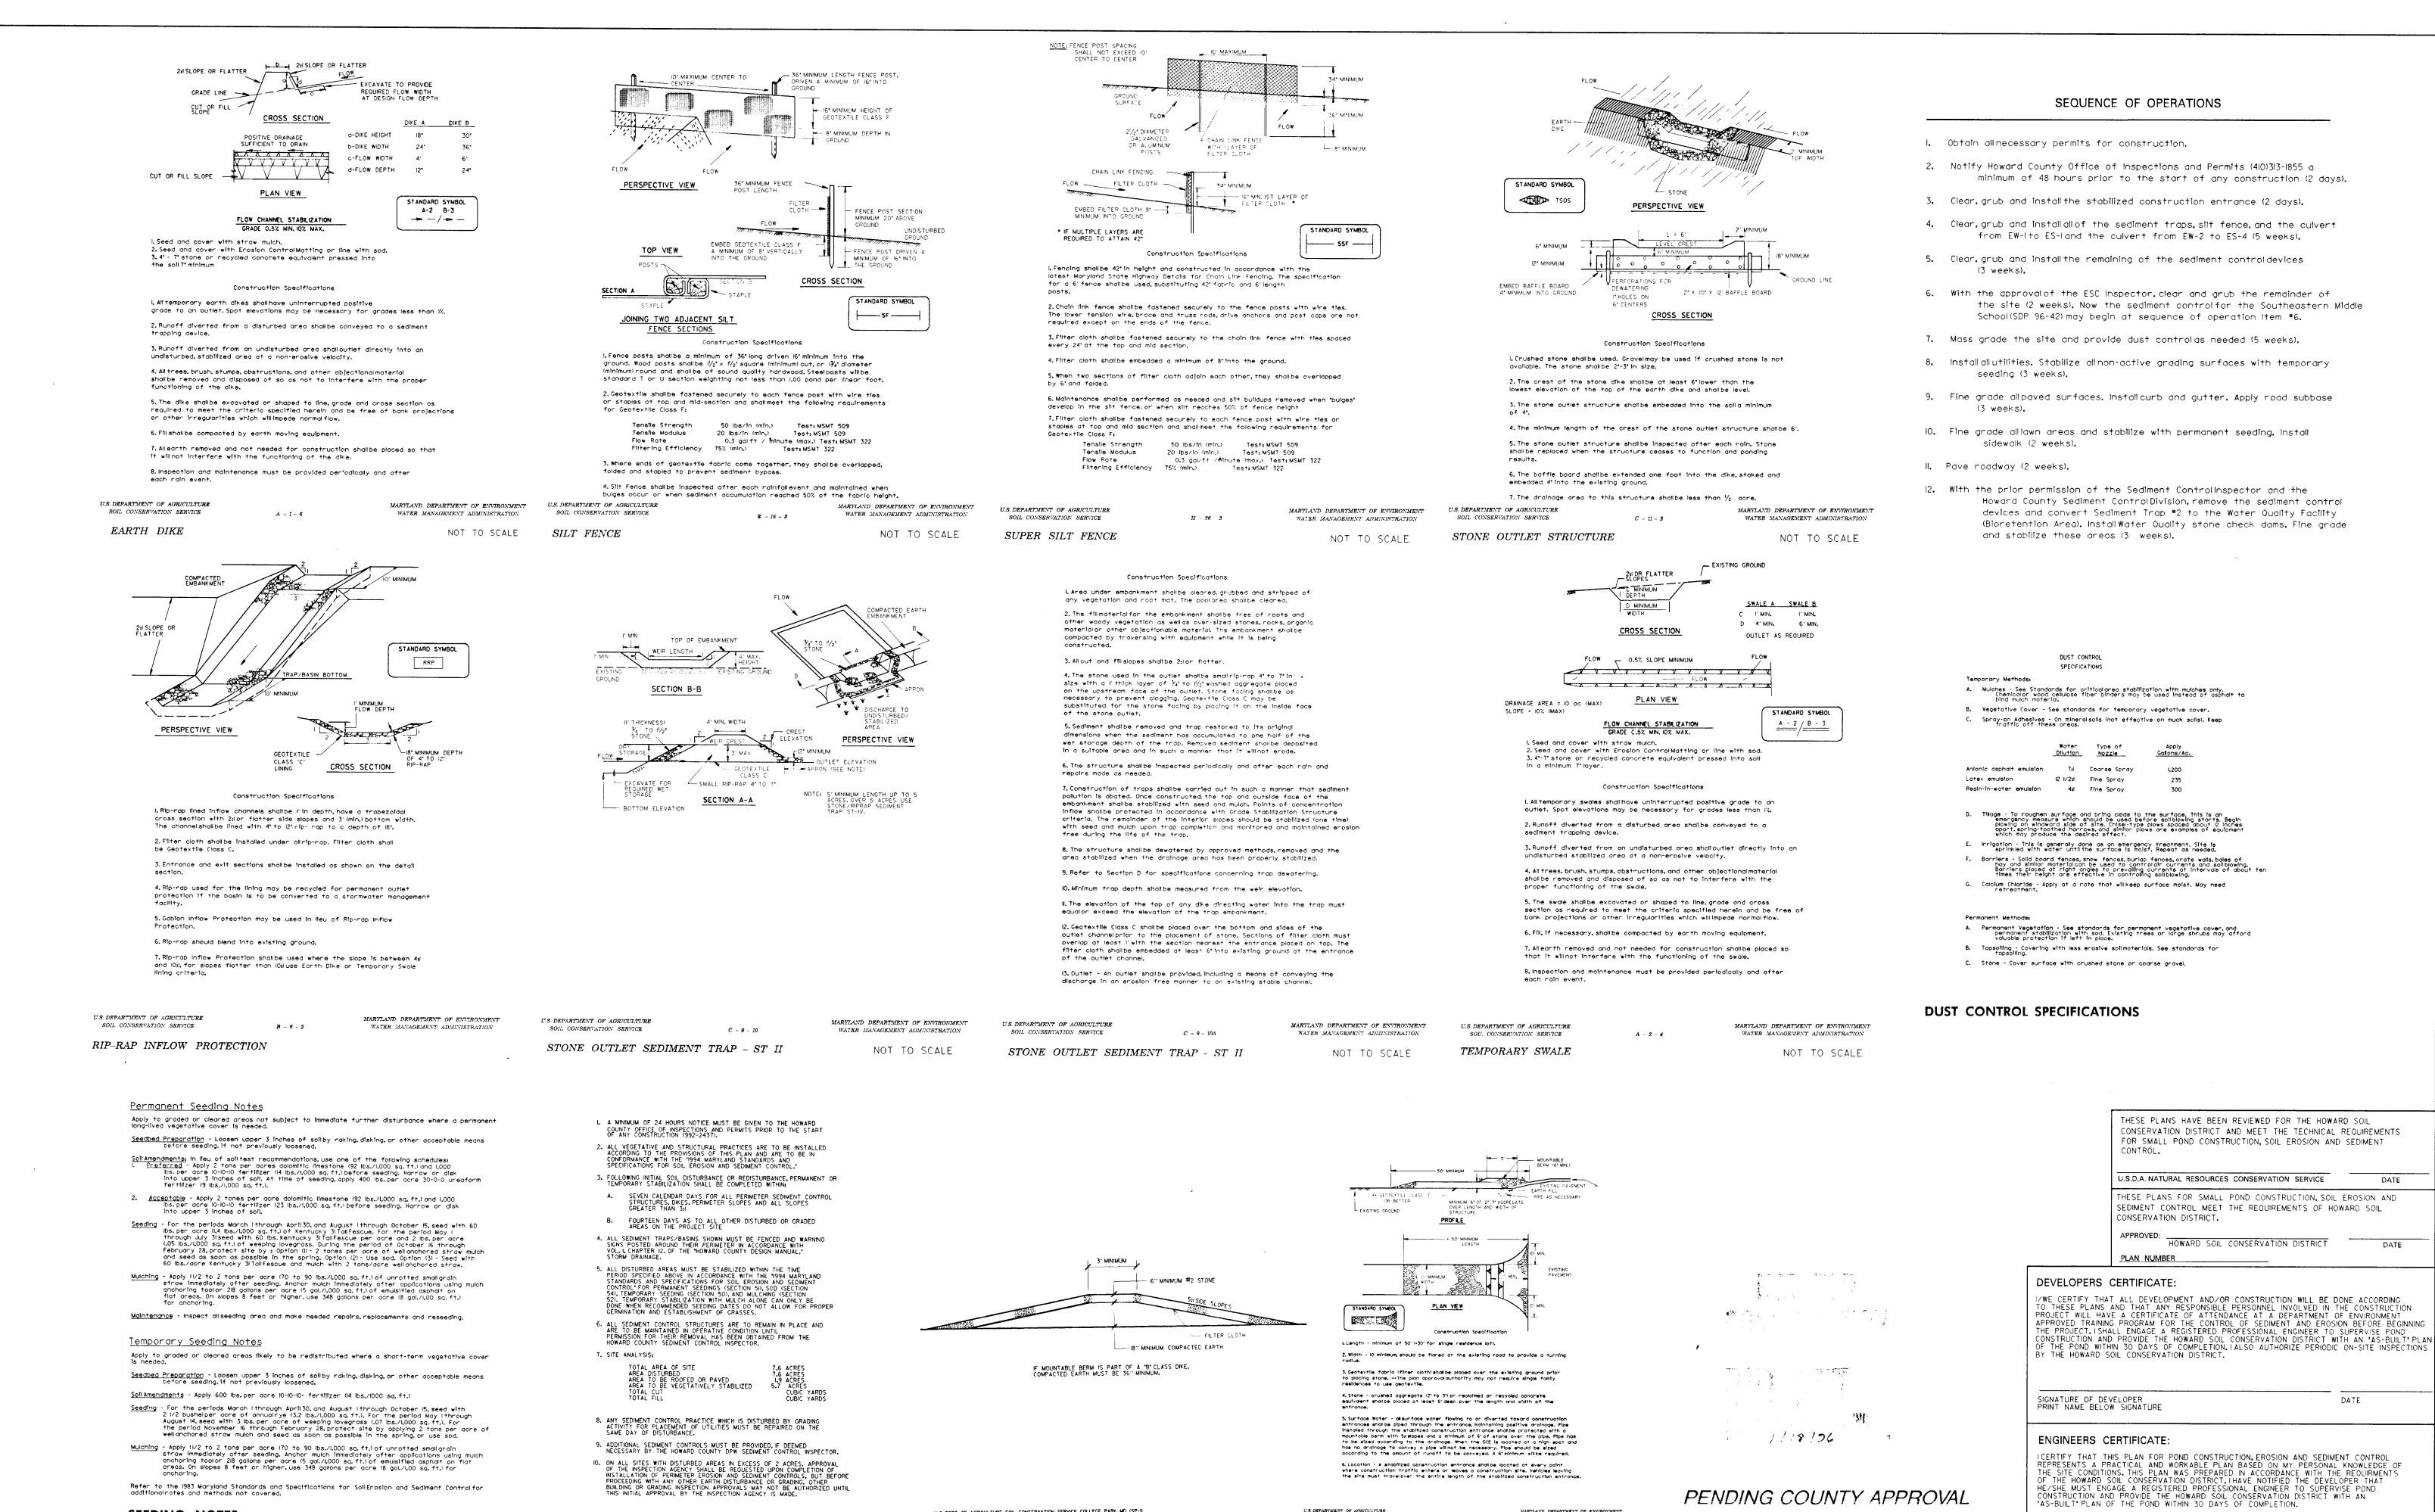
PENDING COUNTY APPROVAL

		PUBLIC WORKS		DESIGN BY: JWS				GORMAN ROAD REALIGNMENT	SCA
	HOWARD COU	NTY, MARYLAND	Daft McCune Walker, Inc.	DRAWN BY: JWS			TYPICAL SECTION	CAPITAL PROJECT E-0935	1″ =
DIRECTOR OF PUBLIC WORKS	DATE	CHIEF. BUREAU OF ENGINEERING DATE	A Team of Land Planners, 200 East Pennsylvania Avenue Landscape Architects, Towson, Maryland 21286	CHECKED BY:				ELECTION DISTRICT NO. 6	SH
CHIEF, BUREAU OF HIGHWAYS	DATE	CHIEF, DIVISION OF TRANSPORTATION DATE PROJECTS AND WATERSHED MANAGEMENT	Engineers, Surveyors & 410 296 3333 Environmental Professionals Fax 296 4705	DATE: JAN. 18, 1996	BY NO.	REVISION DATE 600	SCALE MAP NO. 47 BLOCK NO. 2	HOWARD COUNTY MARYLAND	3 C





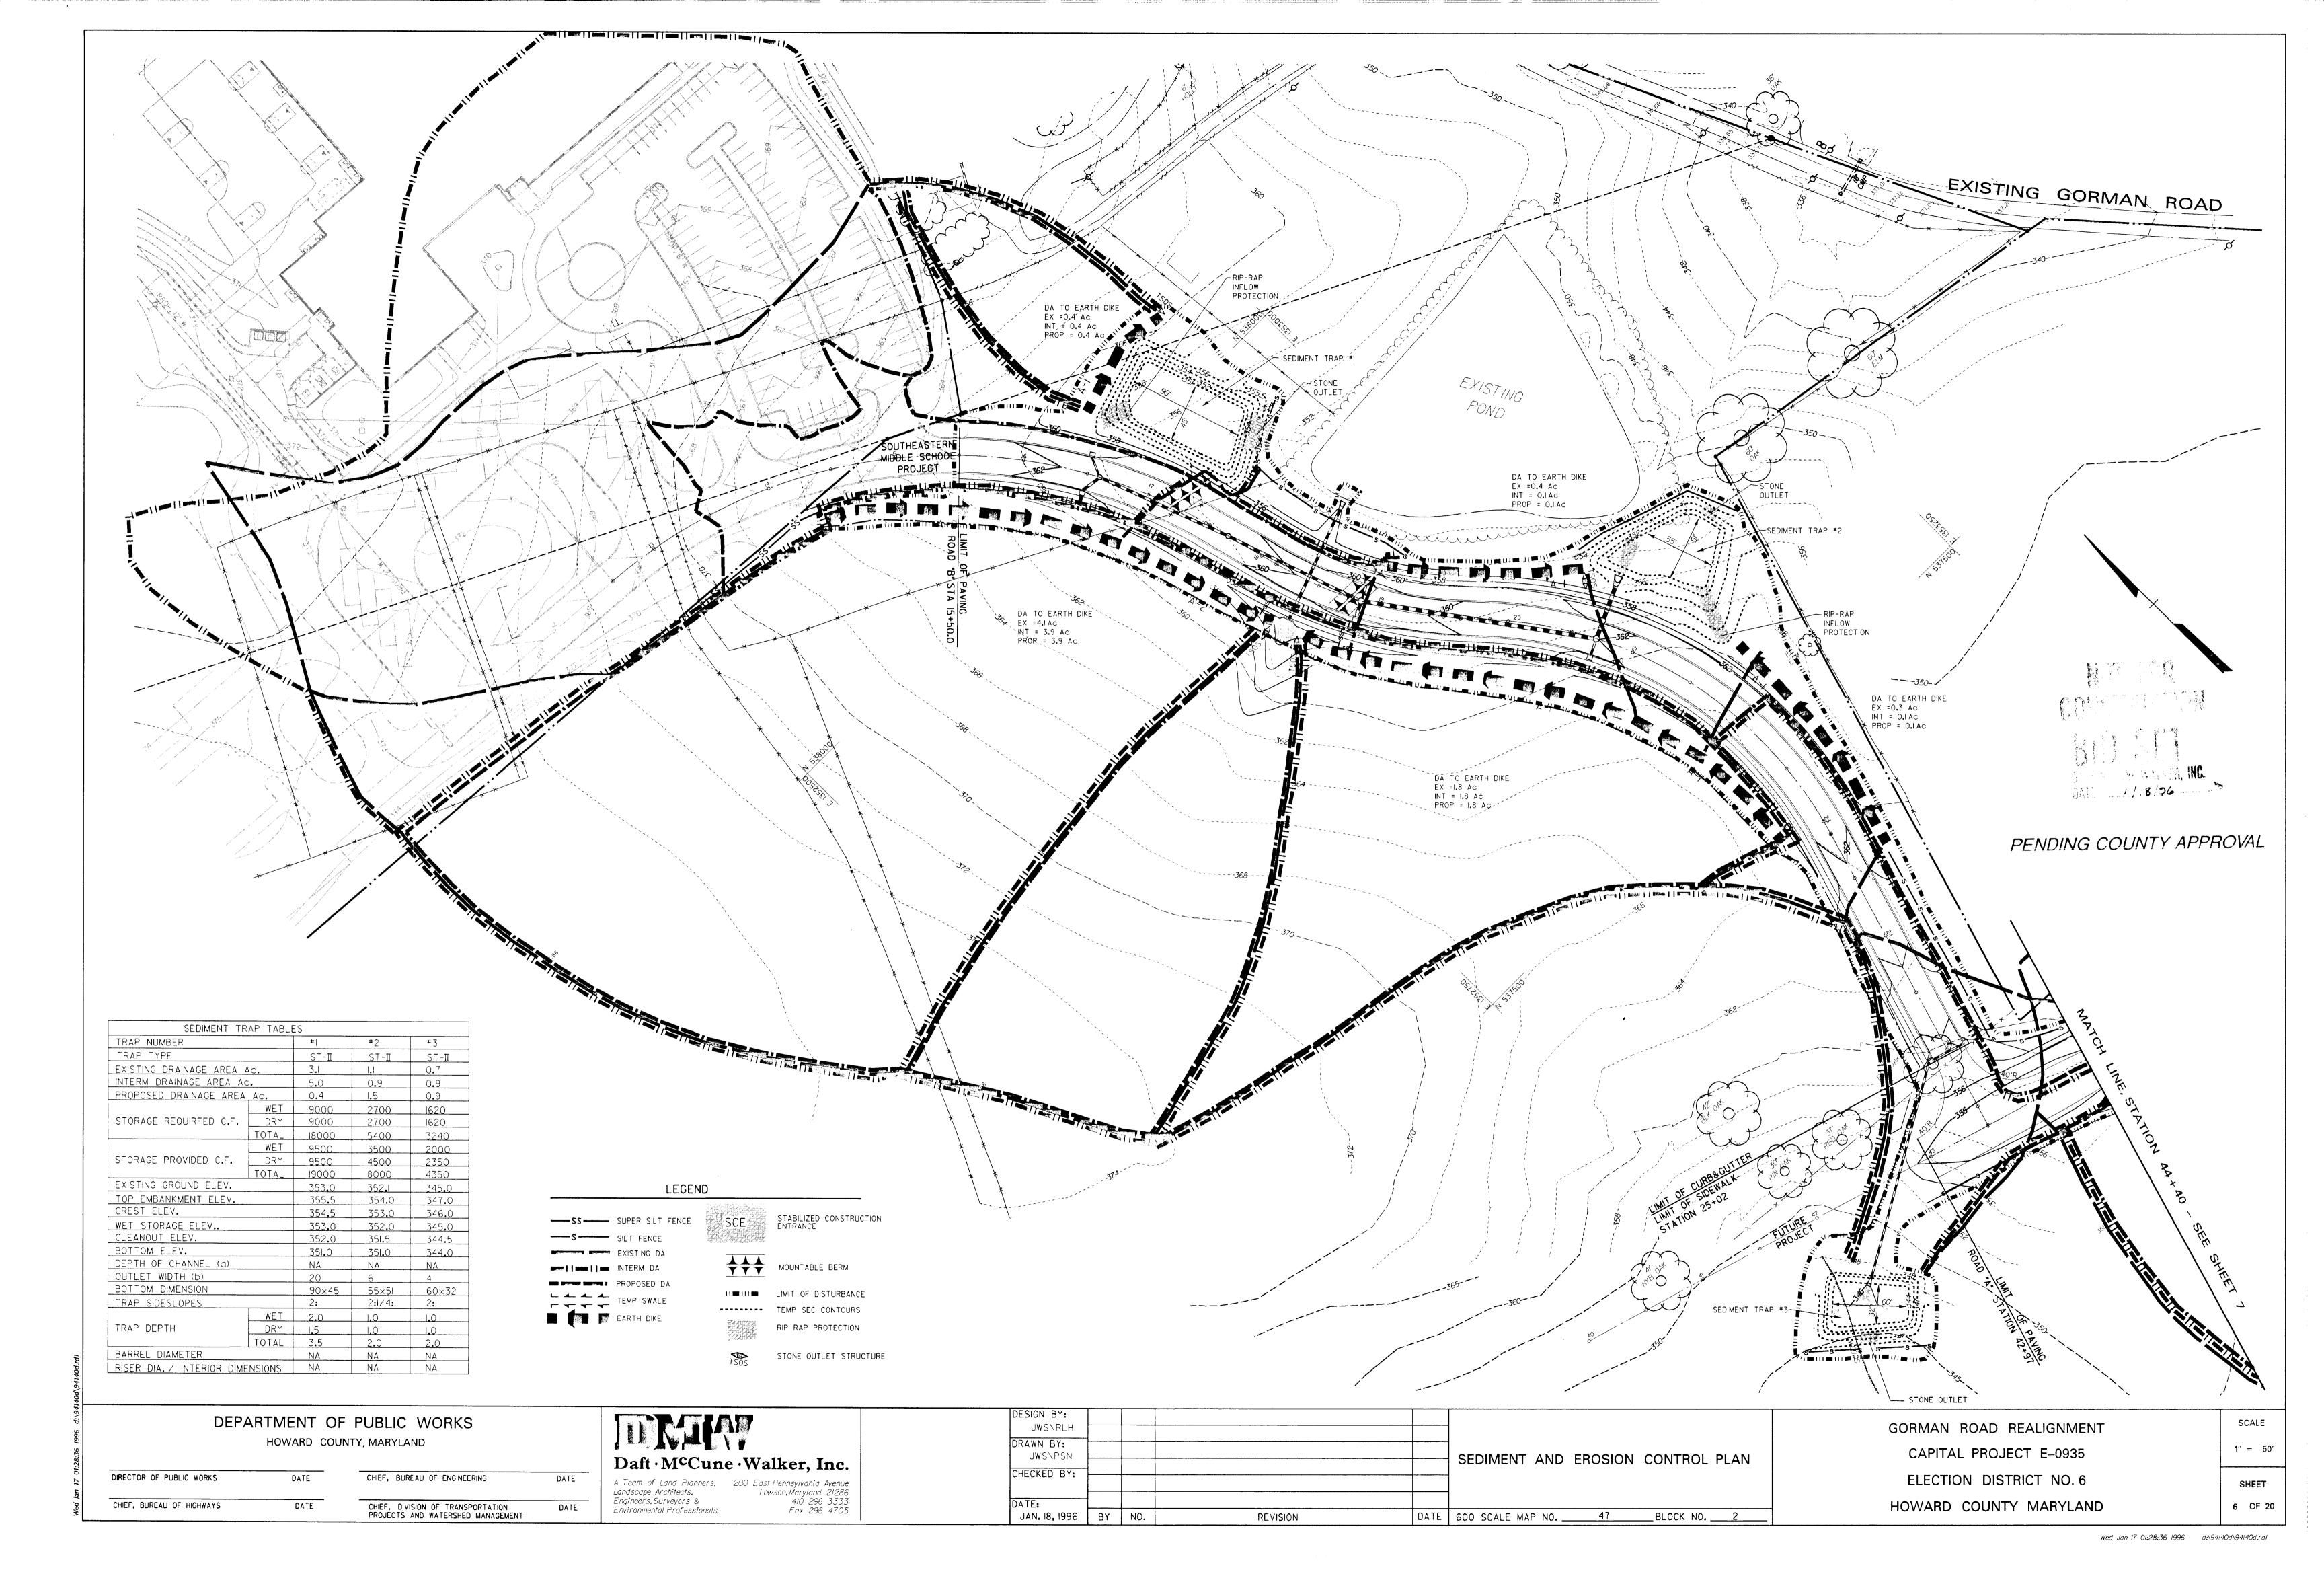

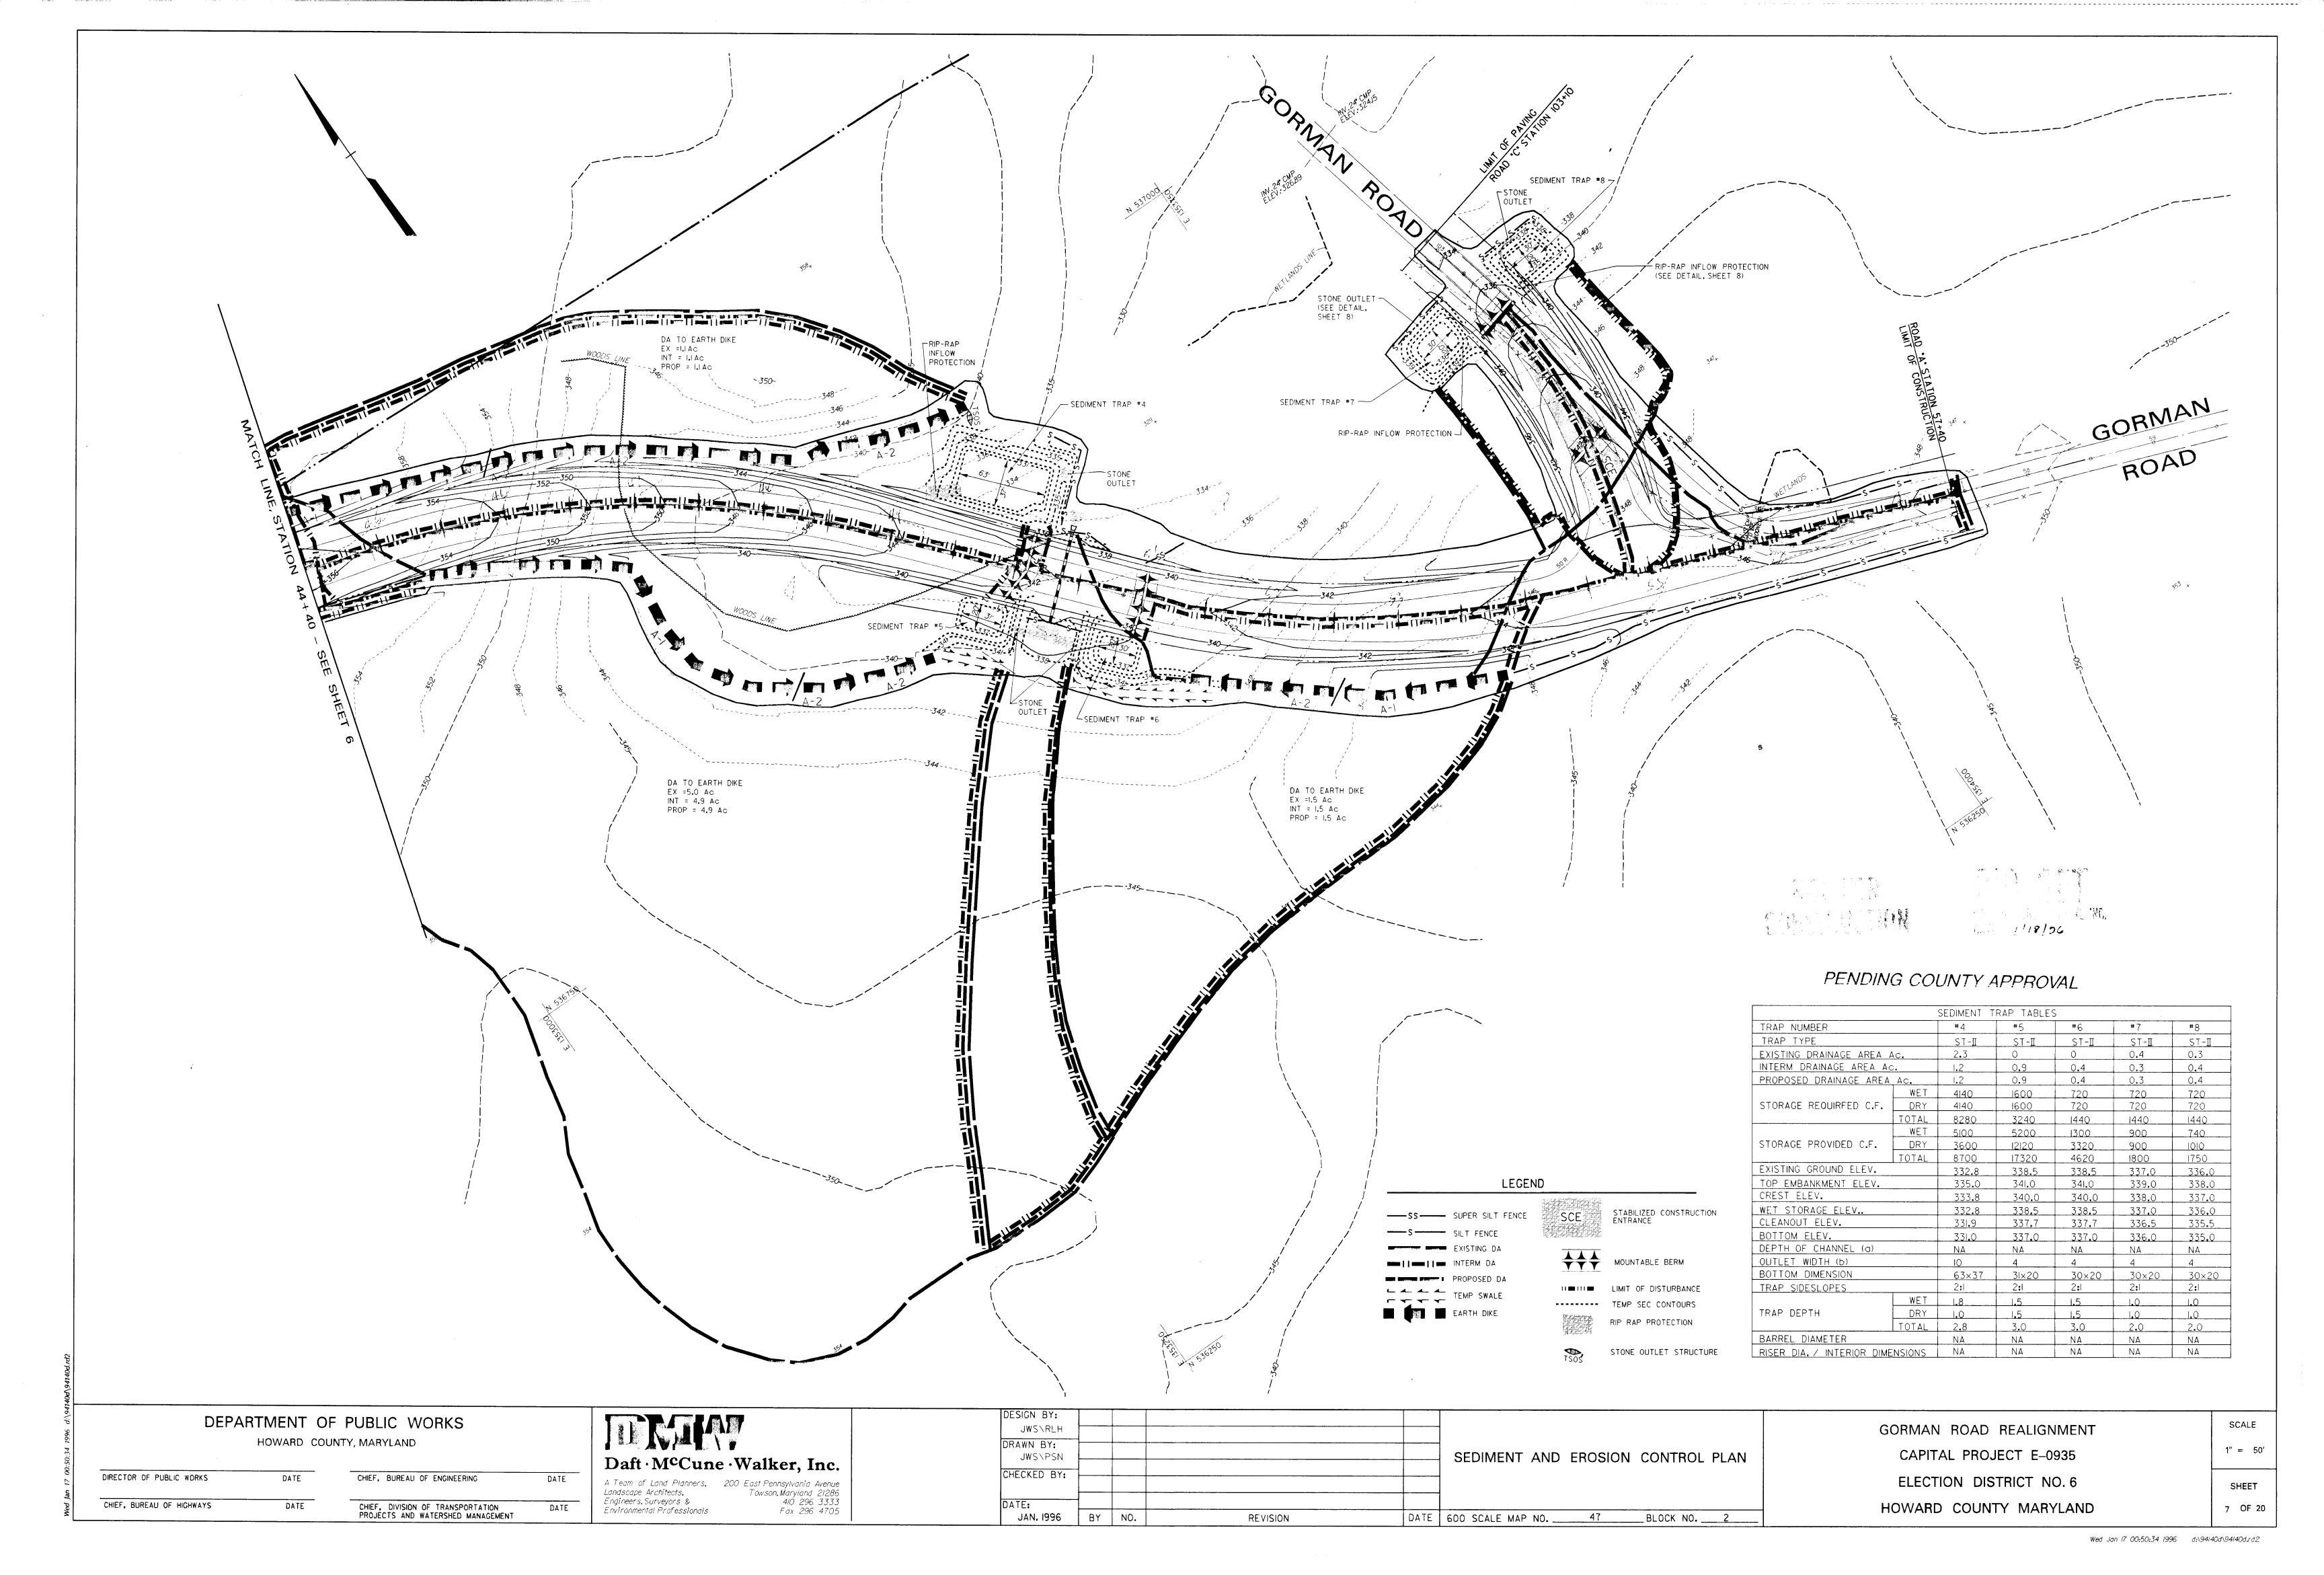

	F PUBLIC WORKS UNTY, MARYLAND	Daft · McCune · Walker, Inc.	DESIGN BY: RLH DRAWN BY: JWS	SEDIMENT & EROSION CONTROL DETAILS	GORMAN ROAD REALIGNMENT CAPITAL PROJECT E-0935	SCALE AS SHOWN
DIRECTOR OF PUBLIC WORKS DATE	CHIEF, BUREAU OF ENGINEERING	DATE A Team of Land Planners, 200 East Pennsylvania Avenue Landscapp Architecte Toward Manyland 2/286	CHECKED BY:	CONTROL DETAILS	ELECTION DISTRICT NO. 6	SHEET
CHIEF, BUREAU OF HIGHWAYS DATE	CHIEF, DIVISION OF TRANSPORTATION PROJECTS AND WATERSHED MANAGEMENT	DATE Engineers. Surveyors & 410 296 3333 Environmental Professionals Fax 296 4705	DATE: JAN. 18, 1996 BY NO.	REVISION DATE 600 SCALE MAP NOBLOCK NO	HOWARD COUNTY MARYLAND	8 OF 20
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U.S. DEPT. OF AGRICULTURE SOIL CONSERVATION SERVICE COLLEGE PARK, MD. (SP-D

MOUNTABLE BERM DETAIL

HOWARD COUNTY SEDIMENT CONTROL GENERAL NOTES

SEEDING NOTES

U.S. DEPARTMENT OF AGRICULTURE SOIL CONSERVATION SERVICE

STABILIZED CONSTRUCTION ENTRANCE

F - 17 - 3

NOT TO SCALE


SIGNATURE OF ENGINEER PRINT NAME BELOW SIGNATURE

PENDING COUNTY APPROVAL

DATE

DATE

DATE

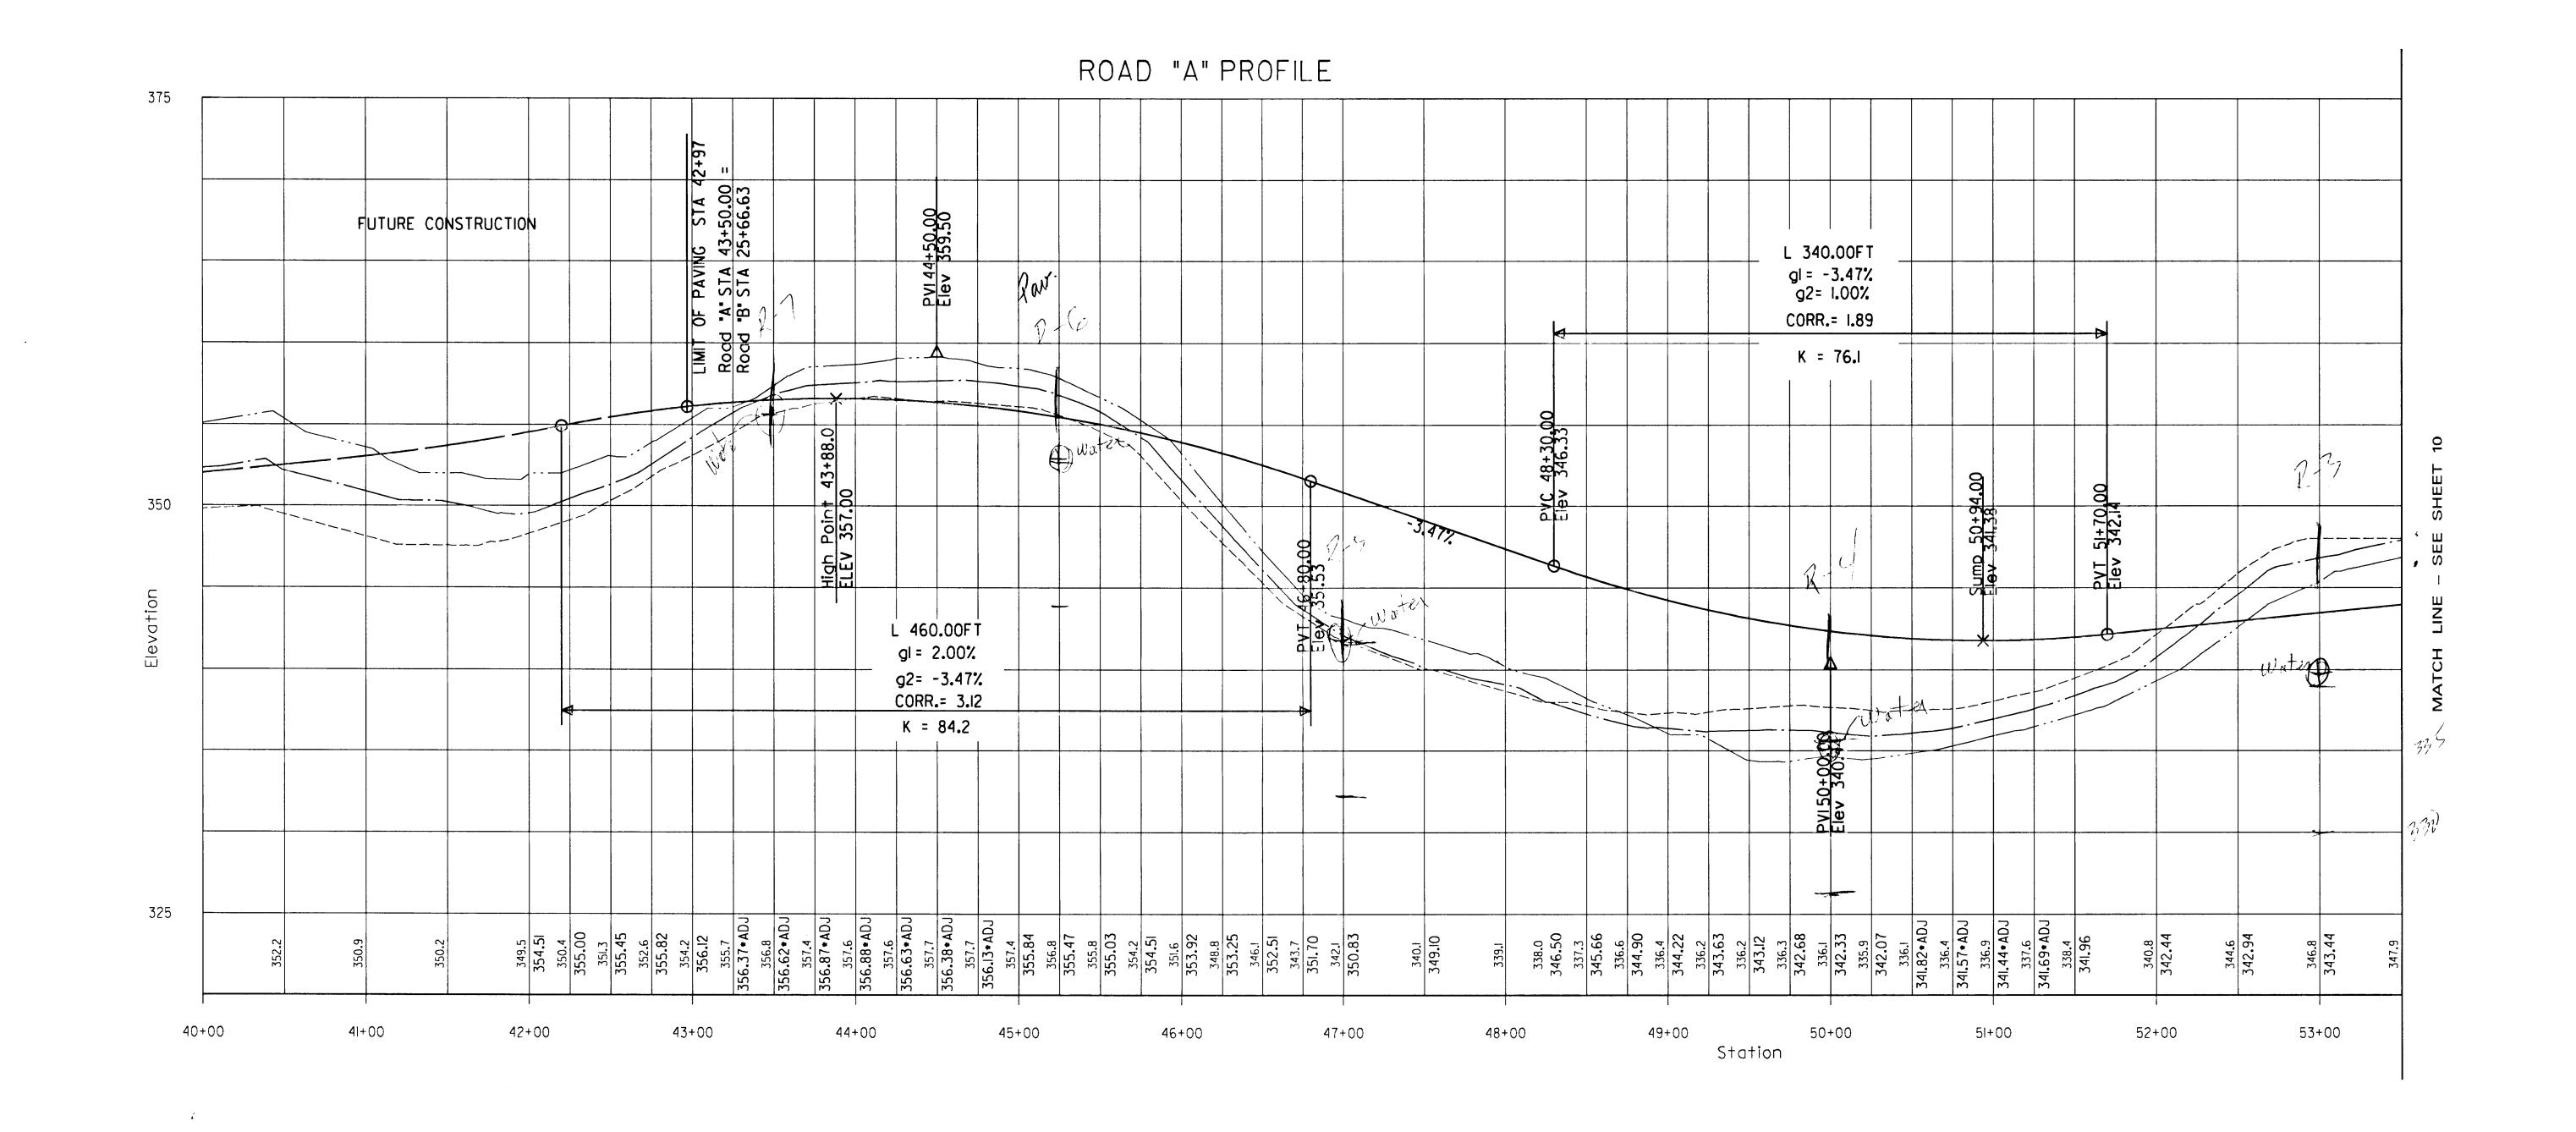



	LEGEND	
LINE	SURFACE	OFFSET
	PROPOSED CENTE	ERLINE 0.00
	EXISTING CENTER EXISTING LEFT R EXISTING RIGHT I	R/W -30.00
	GROUND ELEVAT GELEVATION	TION 340.8 342.44
	/ERTICAL SCALE I RIZONTAL SCALE	-

DEPARTMENT	OF	PUBLIC	WORKS			
HOWARD COUNTY, MARYLAND						

DIRECTOR OF PUBLIC WORKS

DATE

CHIEF, BUREAU OF ENGINEERING


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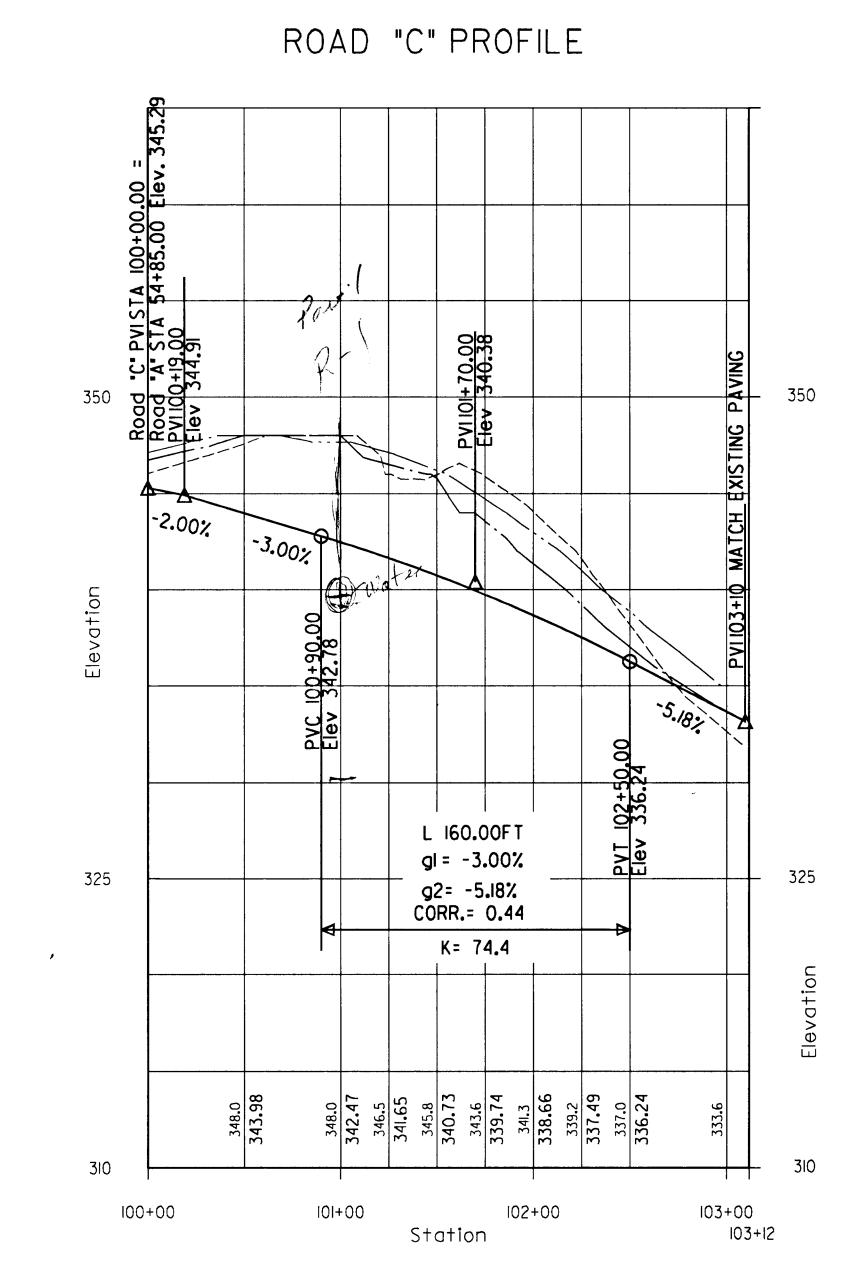
CHIEF, DIVISION OF TRANSPORTATION PROJECTS AND WATERSHED MANAGEMENT


Daft · McCun	e ·Walker, Inc.
A Team of Land Planners,	200 East Pennsylvania Avenue
Landscape Architects,	Towson, Maryland 21286
Engineers.Surveyors &	410 296 3333
Environmental Professionals	Fax 296 4705

ESIGN BY:							
JWS							
RAWN BY: JWS\PSN					ROADWAY PROFILES		
HECKED BY:					MOADWAT TROTILES		
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ATE:							
JAN. 18, 1996	BY	NO.	REVISION [DATE	600 SCALE MAP NO 47 BLOCK NO 2		
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SORMAN ROAD REALIGNMENT	SCALE AS
CAPITAL PROJECT E-0935	SHOWN
ELECTION DISTRICT NO. 6	SHEET
HOWARD COUNTY MARYLAND	9 OF 20






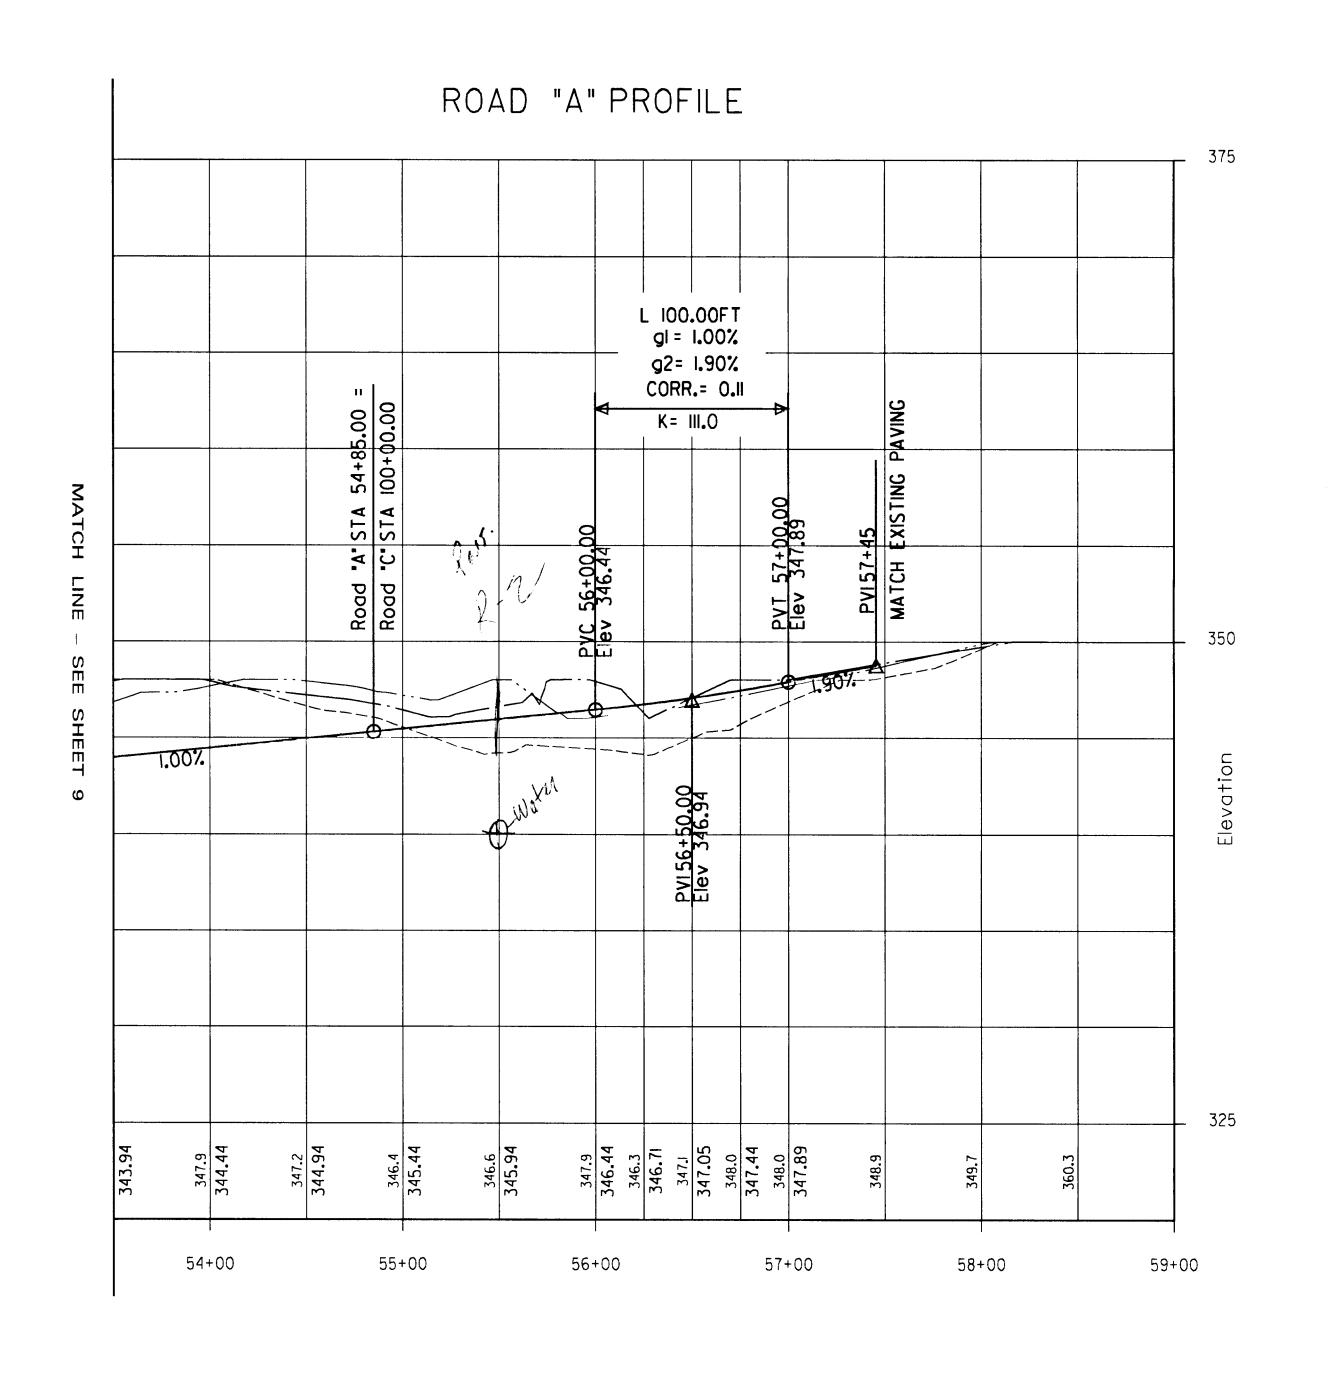

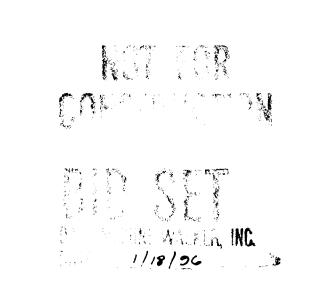
PENDING COUNTY APPROVAL


DEPARTMENT OF PUBLIC WORKS HOWARD COUNTY, MARYLAND	Daft · M ^c Cune · Walker, Inc.	DESIGN BY: JWS DRAWN BY: JWS\PSN	ROADWAY PROFILES	GORMAN ROAD REALIGNMENT CAPITAL PROJECT E-0935	SCALE AS SHOWN
DIRECTOR OF PUBLIC WORKS DATE CHIEF, BUREAU OF ENGINEERING DATE		CHECKED BY:		ELECTION DISTRICT NO. 6	SHEET
CHIEF, BUREAU OF HIGHWAYS DATE CHIEF, DIVISION OF TRANSPORTATION DA PROJECTS AND WATERSHED MANAGEMENT	Engineers. Surveyors & 410 296 3333 Environmental Professionals Fax 296 4705	DATE: JAN. 18, 1996 BY NO. REVISION DATE 600 SC	CALE MAP NO. 47 BLOCK NO. 2	HOWARD COUNTY MARYLAND	10 OF 20

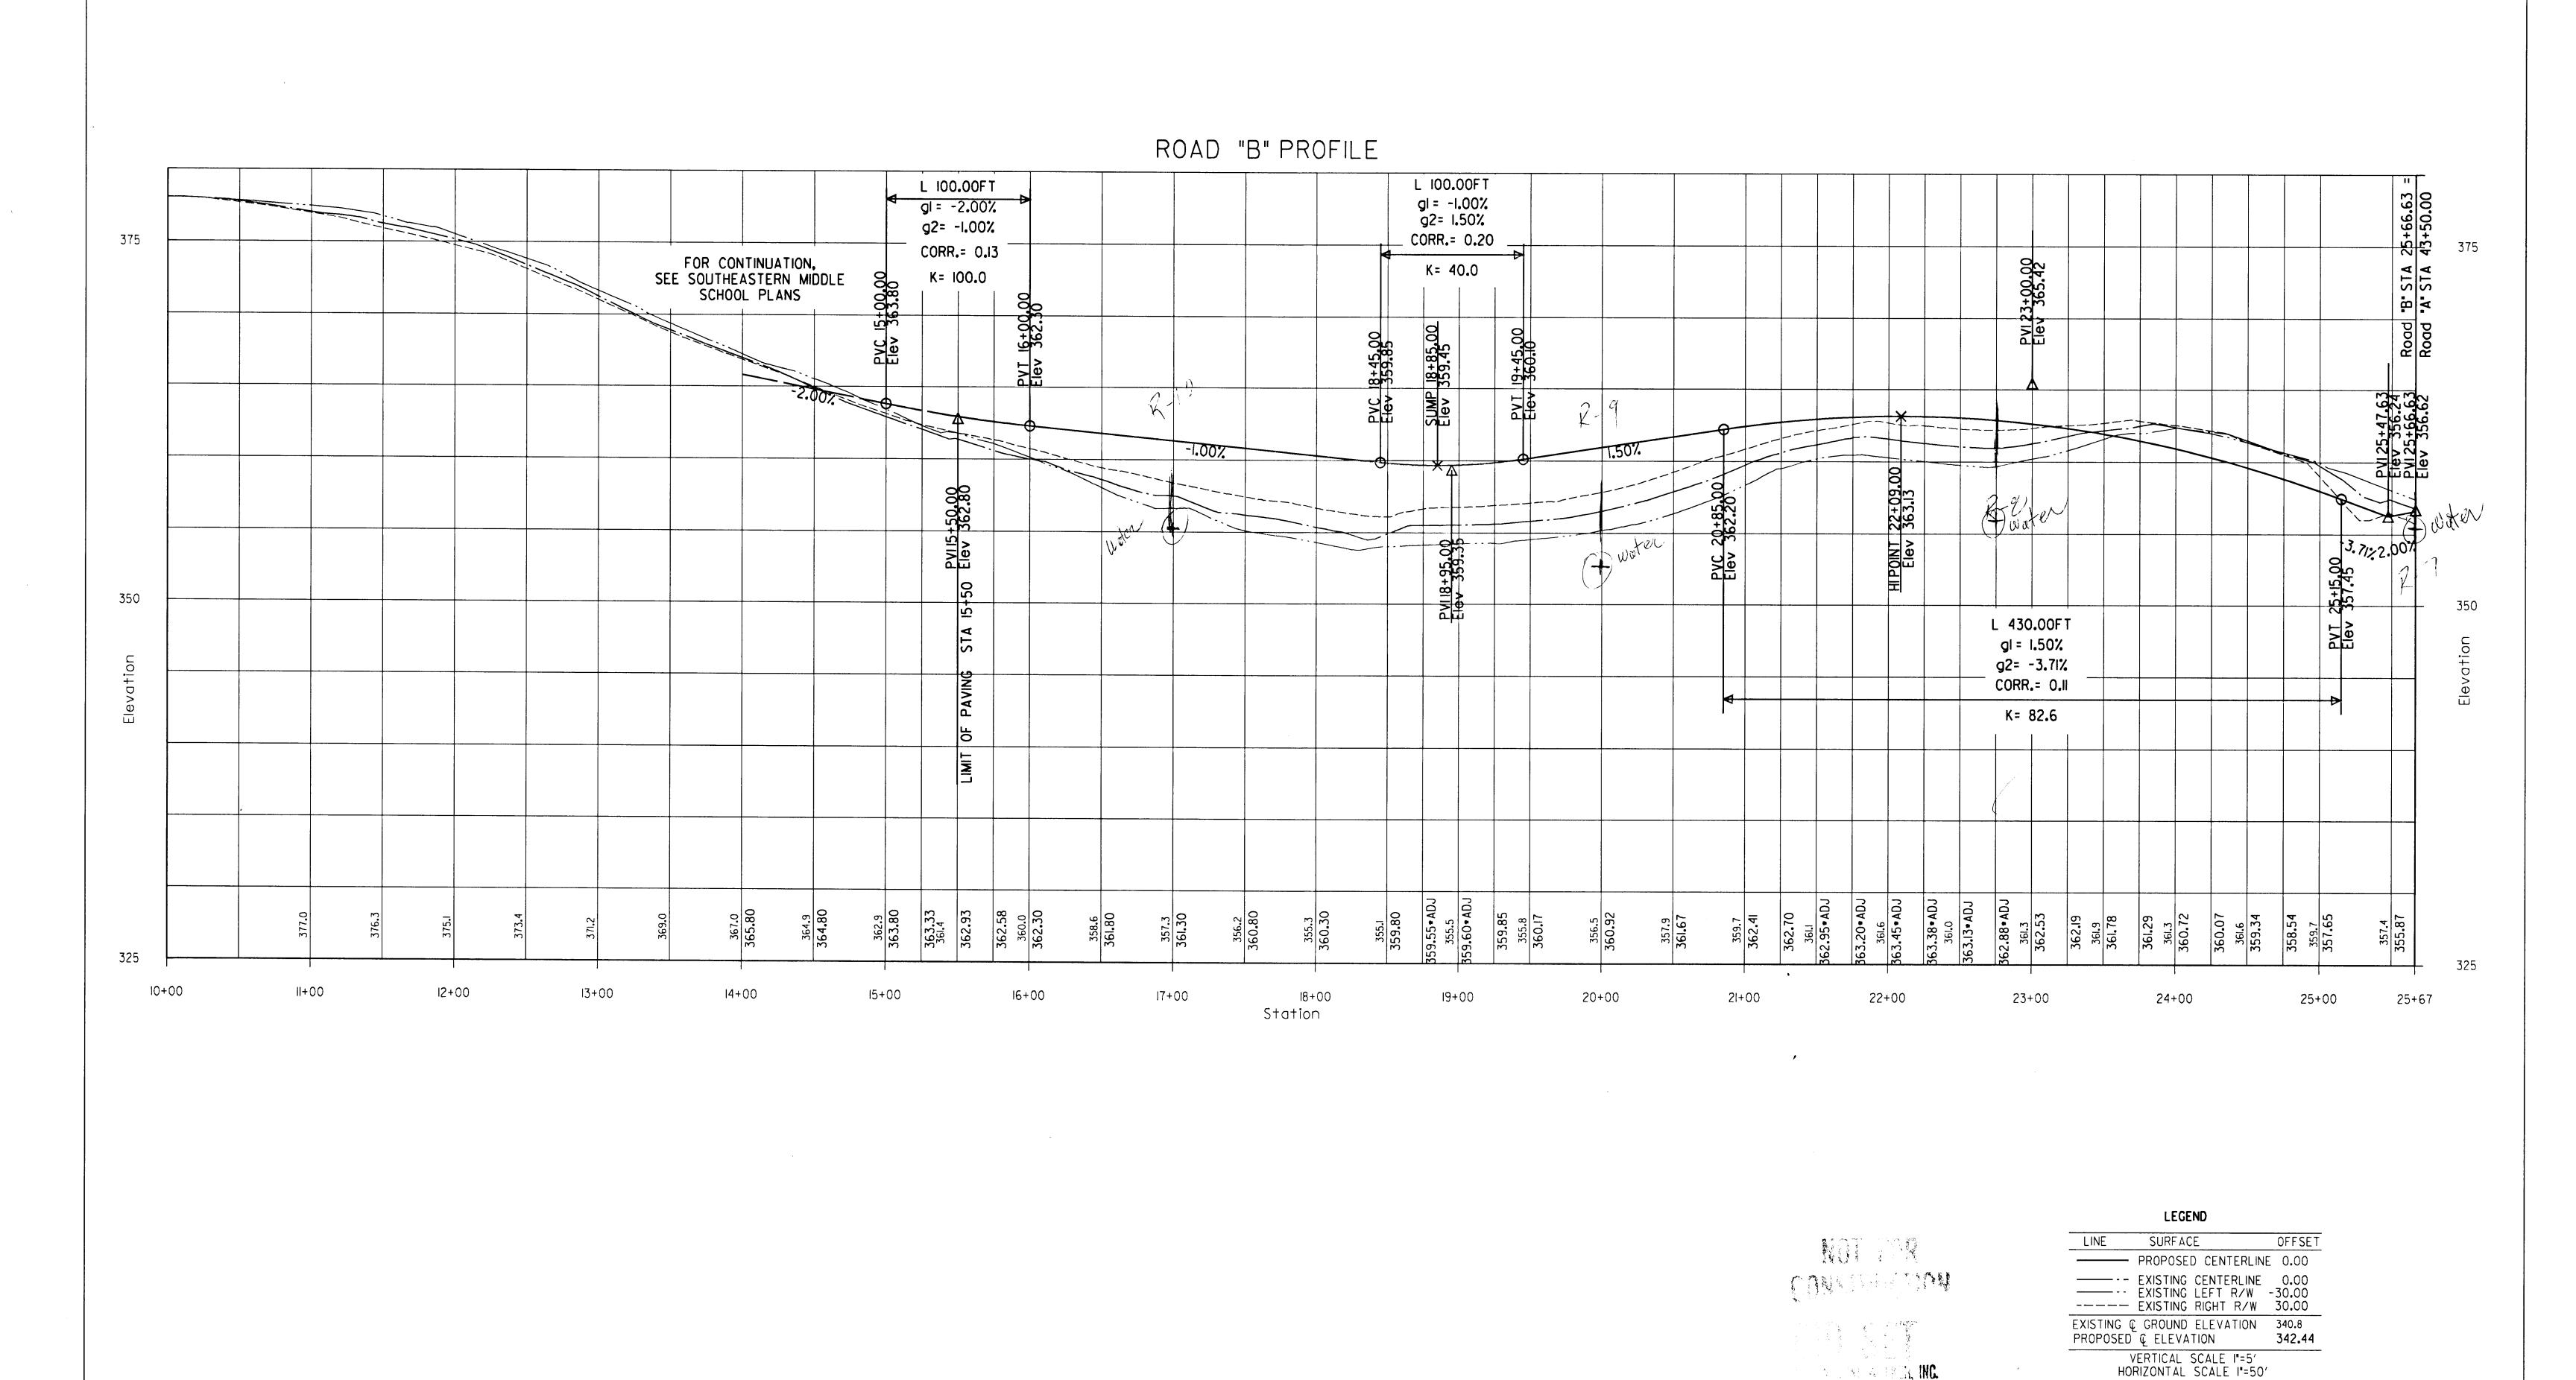


1/18/26

DESIGN BY: DEPARTMENT OF PUBLIC WORKS SCALE JWS GORMAN ROAD REALIGNMENT AS HOWARD COUNTY, MARYLAND DRAWN BY: SHOWN CAPITAL PROJECT E-0935 JWS\PSN ROADWAY PROFILES Daft · McCune · Walker, Inc. CHECKED BY: DIRECTOR OF PUBLIC WORKS CHIEF, BUREAU OF ENGINEERING DATE A Team of Land Planners, 200 East Pennsylvania Avenue Landscape Architects, Towson, Maryland 21286 Engineers, Surveyors & 410 296 3333 Environmental Professionals Fax 296 4705 ELECTION DISTRICT NO. 6 SHEET CHIEF, BUREAU OF HIGHWAYS CHIEF, DIVISION OF TRANSPORTATION PROJECTS AND WATERSHED MANAGEMENT HOWARD COUNTY MARYLAND 11 OF 20 JAN. 18, 1996 BY NO. REVISION DATE 600 SCALE MAP NO. 47 BLOCK NO. 2

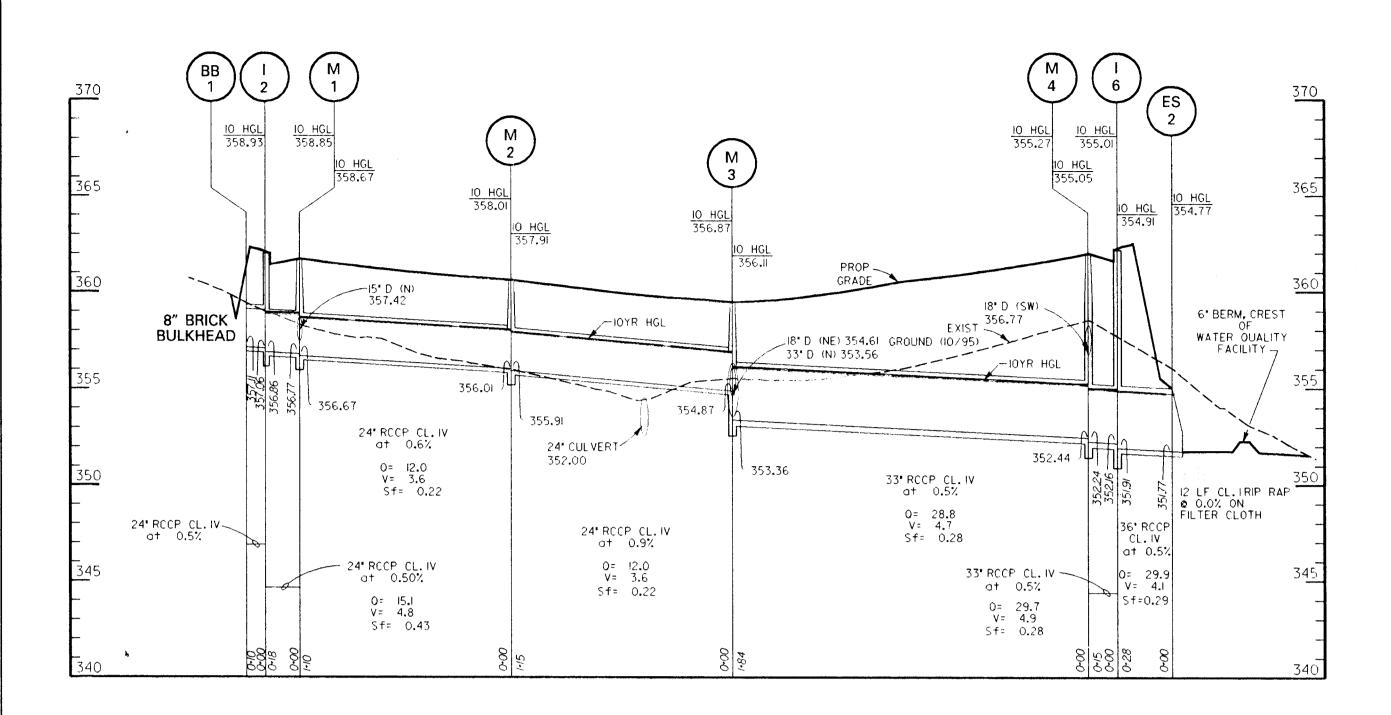

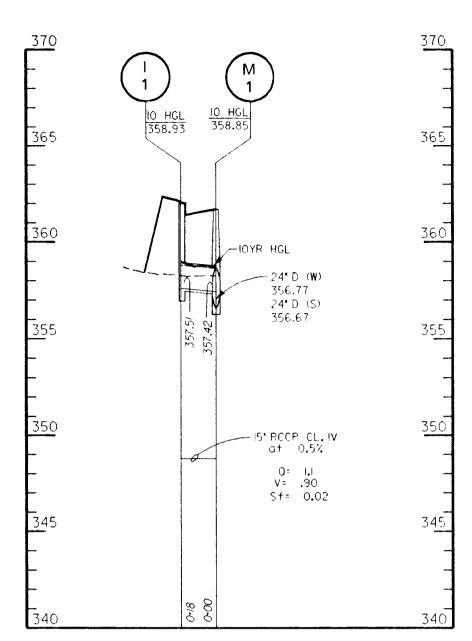

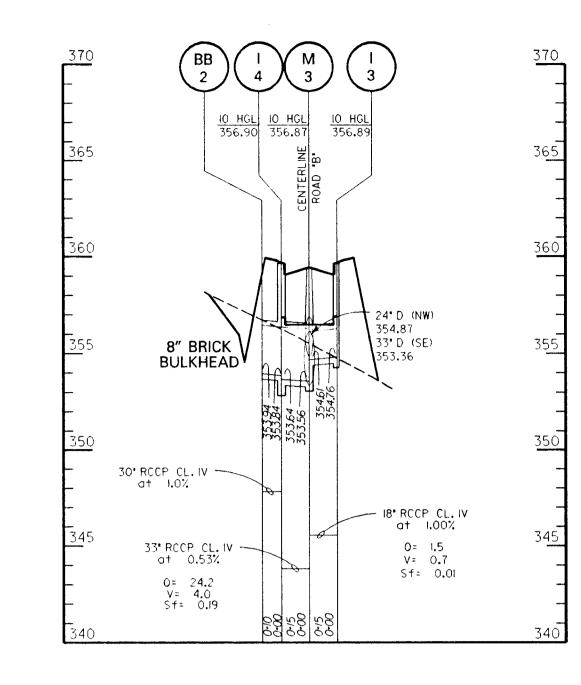

INLET SCHEDULE

NO.	TYPE	Q(2 yr)	INV. OUT	TOP ELEV. →	DETAIL	WIDTH	STATION	OFFSET
1-1	A-5	0,8	357.51	362.00	S.D. 4.01	2′-6"	16+50.00	13 R
1-2	A-5	0.5	356.86	362.00	S.D. 4.01	2′-6 "	16+50.00	13′ L
1-3	A-5	0.9	354.76	359.65	S.D. 4.01	2′-6*	18+85.00	13′ L
1-4	A-5	1.0	353.64	359.65	S.D. 4.01	2′-6 '	18+85.00	13′ R
1-5	A-5	1.4	357.07	362.17	S.D. 4.01	2'-6"	20+70.00	13′ R
1-6	A-5	0.2	351.91	362.17	S.D. 4.01	2'-6"	20+70.00	13′ L
1-7	A-5	0.6	351.57	357 .7 7	S.D. 4.01	2′-6•	25+02.00	13′ R
1-8	A-5	0.5	353.42	357.77	S.D. 4.0I	2′-6•	25+02.00	13' L


* NOTE: ELEVATIONS REPRESENT TOP OF CURB & & HEADPIECE FOR A-5 INLETS
NOTE: OFFSETS REPRESENT DISTANCE FROM ROADWAY CENTERLINE TO FACE OF CURB


STRUCTURE SCHEDULE


NO.	TYPE	SIZE	INV. OUT	DETAIL NO.	STATION	OFFSET
ESI	CONC END SECTION	24"	352.00	SD5.52	18+40.00	60. L
ES2	CONC END SECTION	36"	351.77	\$D5.52	20+70.00	43 . 5′ L
ES3	CONC END SECTION	18"	346.00	SD5.52	42+14.72	61′ R
ES4	CONC END SECTION	24"	334.20	SD5.52	50+35.00	36′ L
EWI	"C" END WALL	24"	352.47	SD5.2I	18+40.00	33′ R
EW2	"C" END WALL	24"	336.16	SD5.21	50+35.00	34′ R


MANHOLE SCHEDULE

NO.	TYPE	INV. OUT	TOP ELEV.	DETAIL NO.	STATION	OFFSET
ı	48" DIA	356.67	361.70	G 5.12	16+60.00	Ü
2	48" DIA	355.91	360.60	G 5.12	17+70.00	0
3	60" DIA	353.36	359.45	G 5.13	18+85.00	0
4	60" DIA	352.24	361.97	G 5.13	20+70.00	0

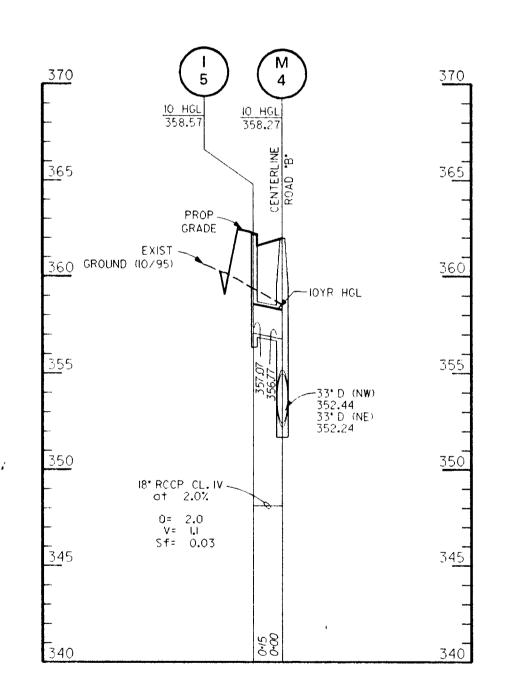

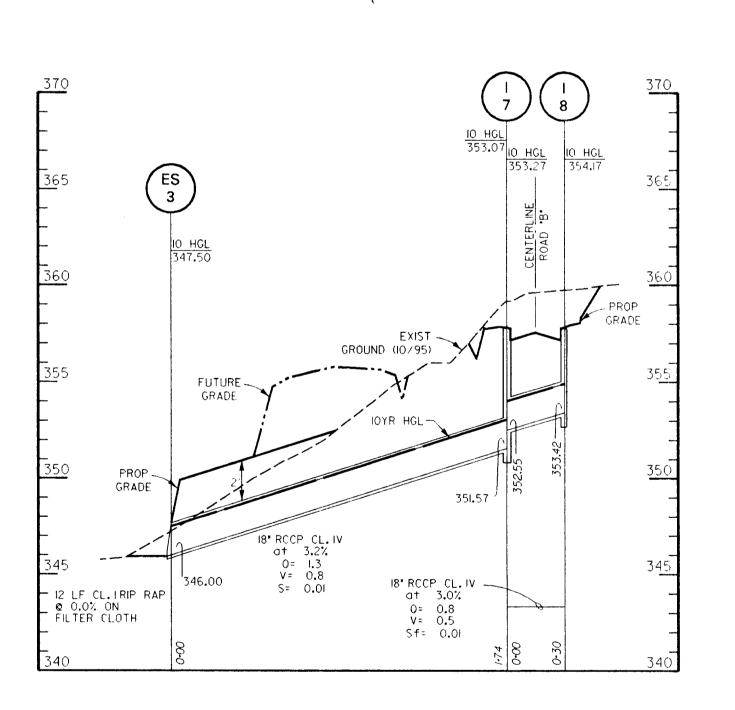

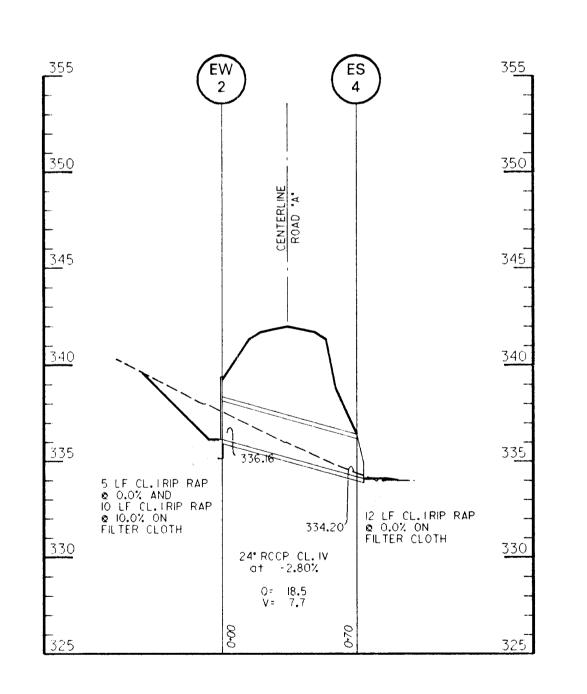

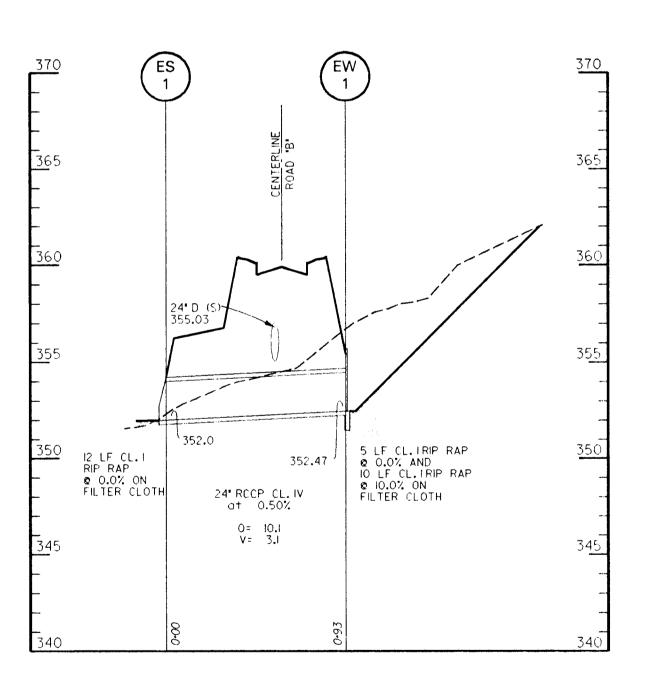

EXISTING GROUND -----

PROPOSED GRADE ----

DEPARTMENT OF PUBLIC WORKS
HOWARD COUNTY, MARYLAND

CHIEF, BUREAU OF ENGINEERING

CHIEF, DIVISION OF TRANSPORTATION PROJECTS AND WATERSHED MANAGEMENT

DIRECTOR OF PUBLIC WORKS

DATE

CHIEF, BUREAU OF HIGHWAYS

DATE

Daft · McCune · Walker, Inc.

A Team of Land Planners,
Landscape Architects,
Engineers, Surveyors &
Environmental Professionals

A Team of Land Planners,
Landscape Architects,
Engineers, Surveyors &
Environmental Professionals

DESIGN BY:

JWS

DRAWN BY:

JWS

CHECKED BY:

DATE:

JAN. 18, 1996 BY NO.

REVISION

DATE 600 SCALE MAP NO.

STORM DRAIN PROFILES


CAPITAL PROJECT E-0935
ELECTION DISTRICT NO. 6
HOWARD COUNTY MARYLAND


___BLOCK NO. ___2


SCALE
HOR. 1" = 50'
VERT 1" = 5'


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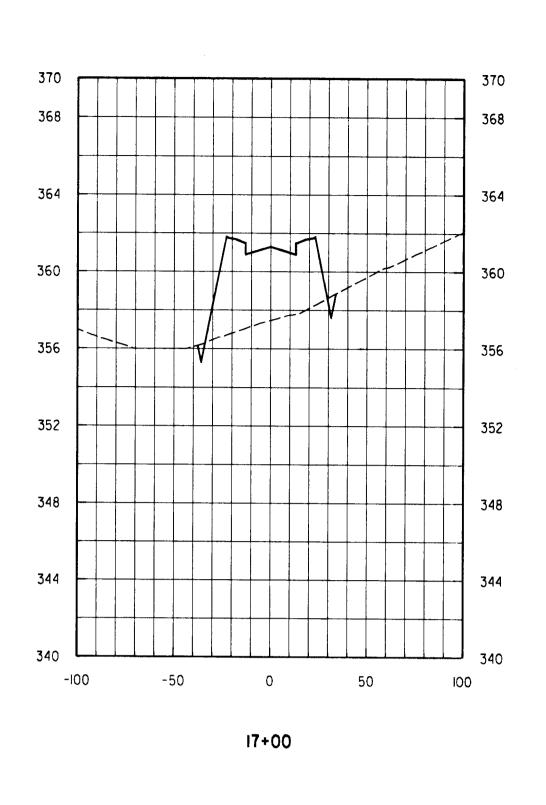
12 OF 20




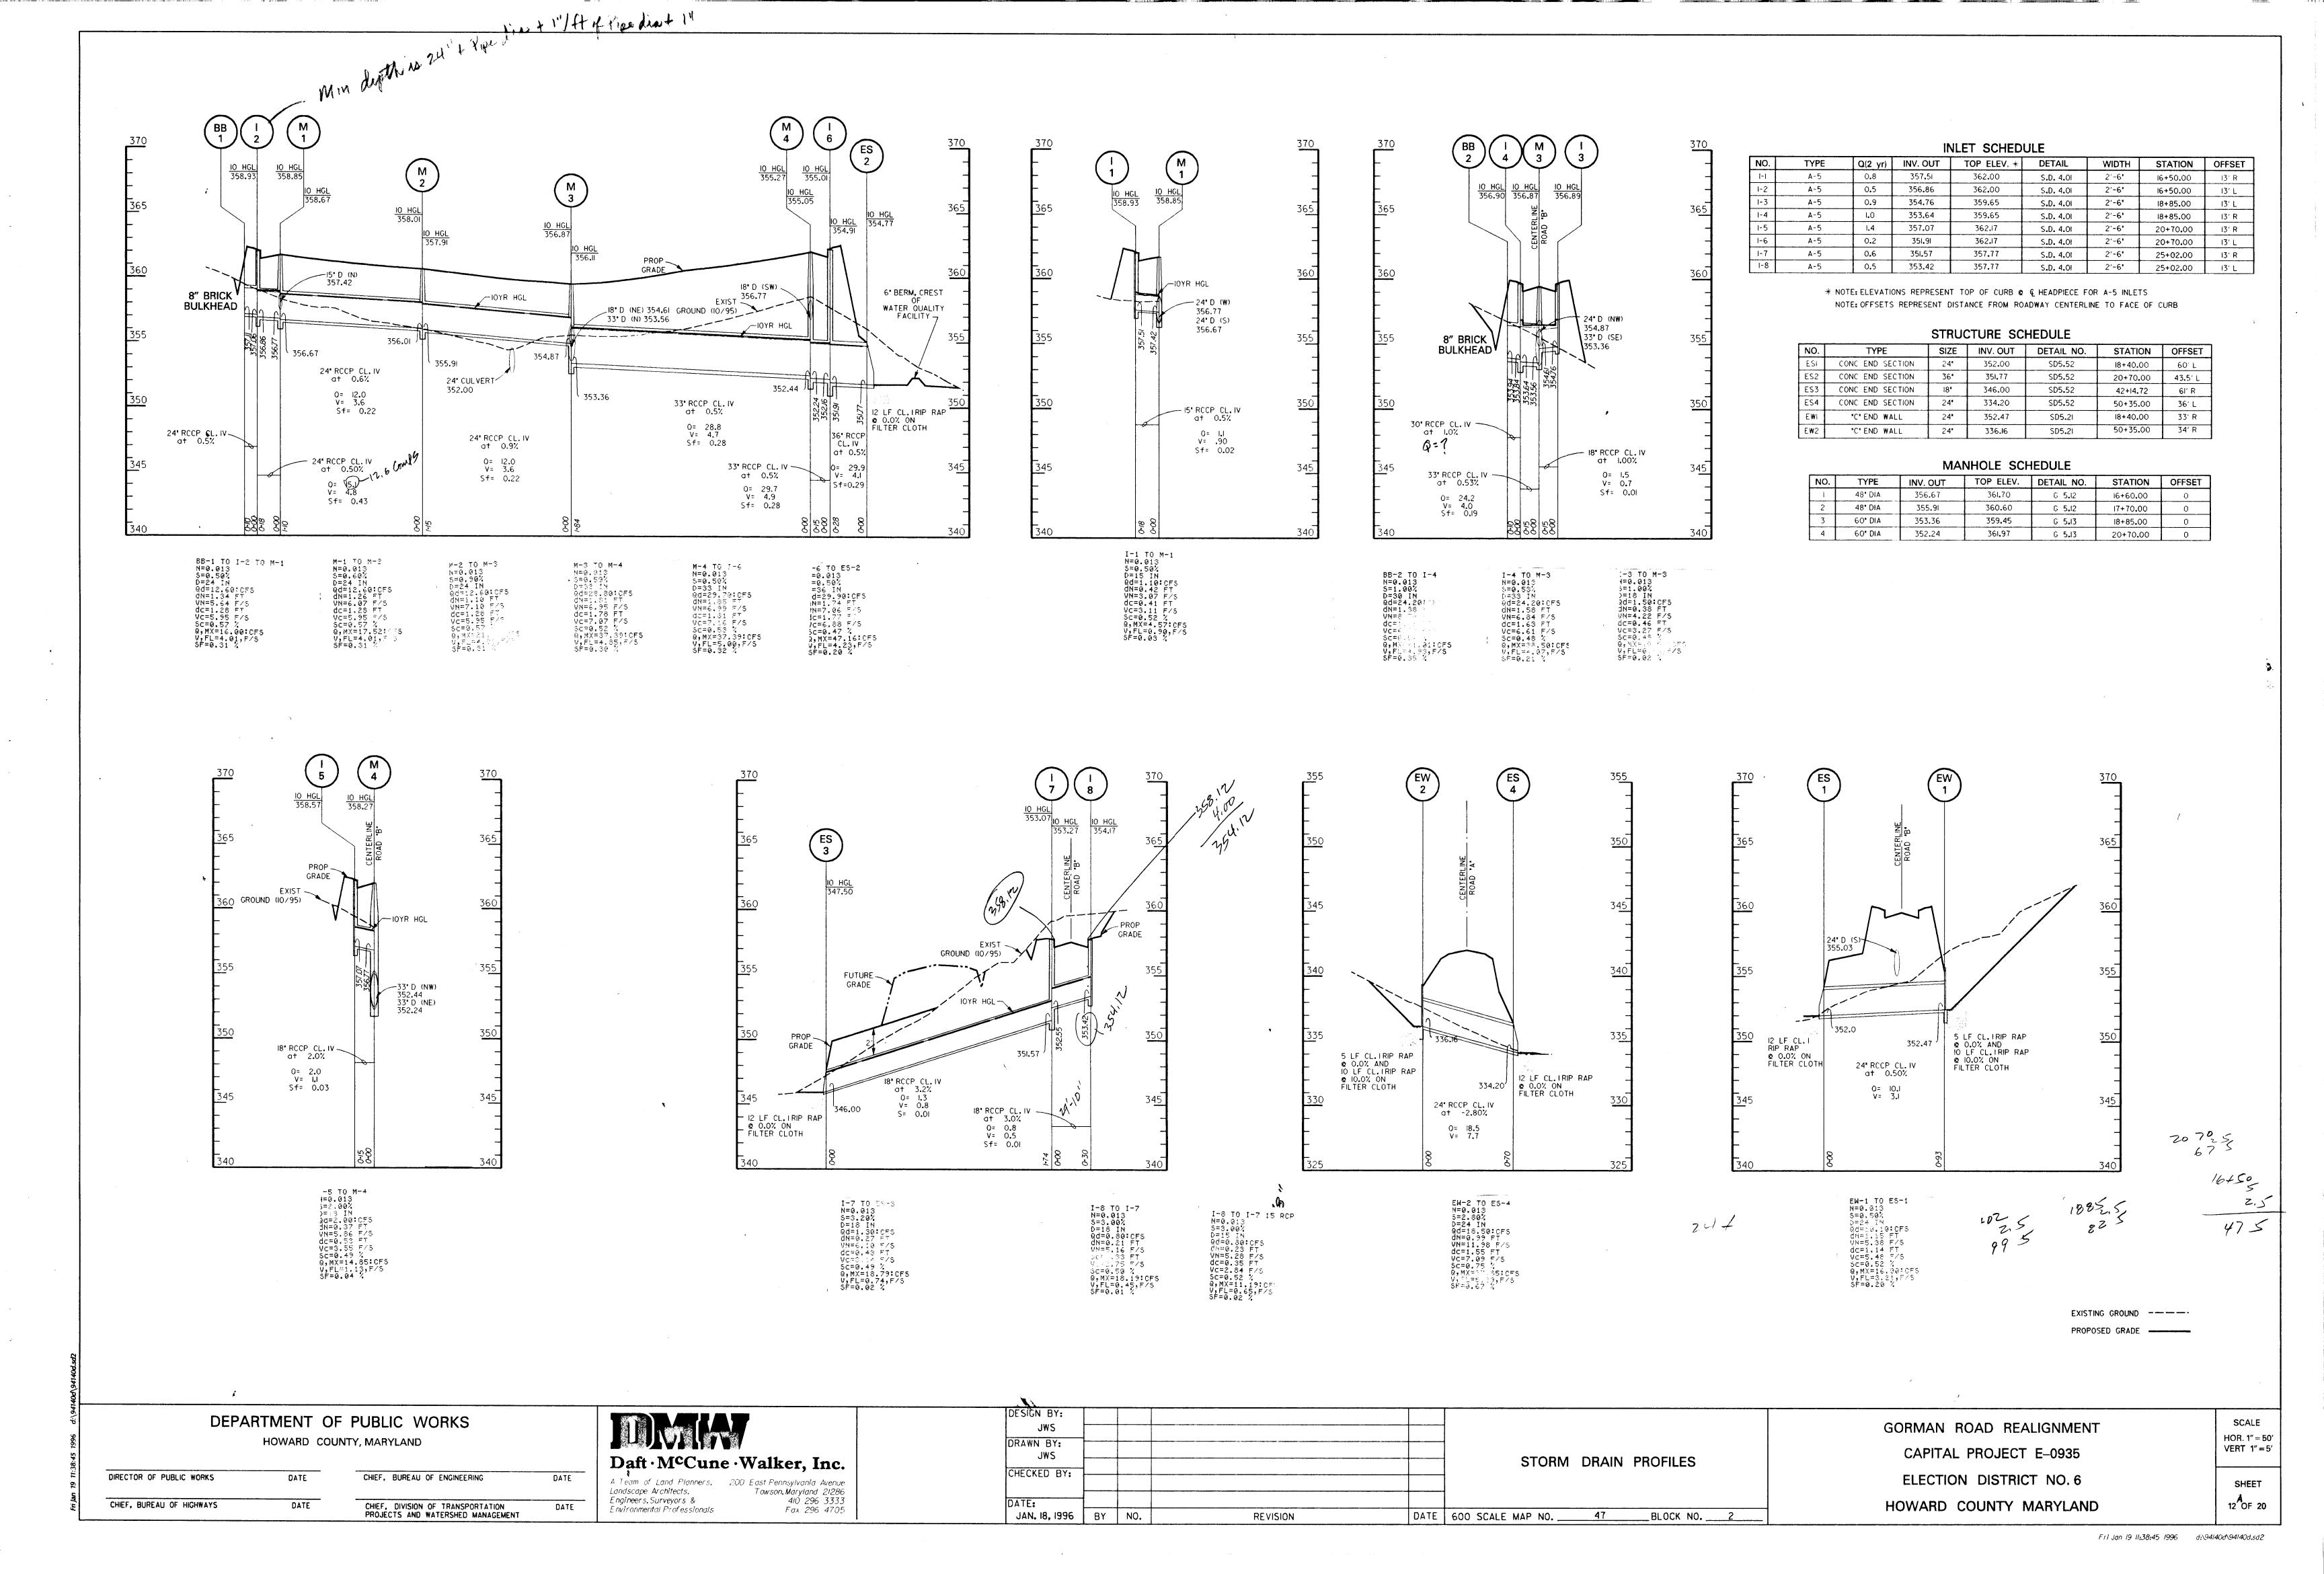


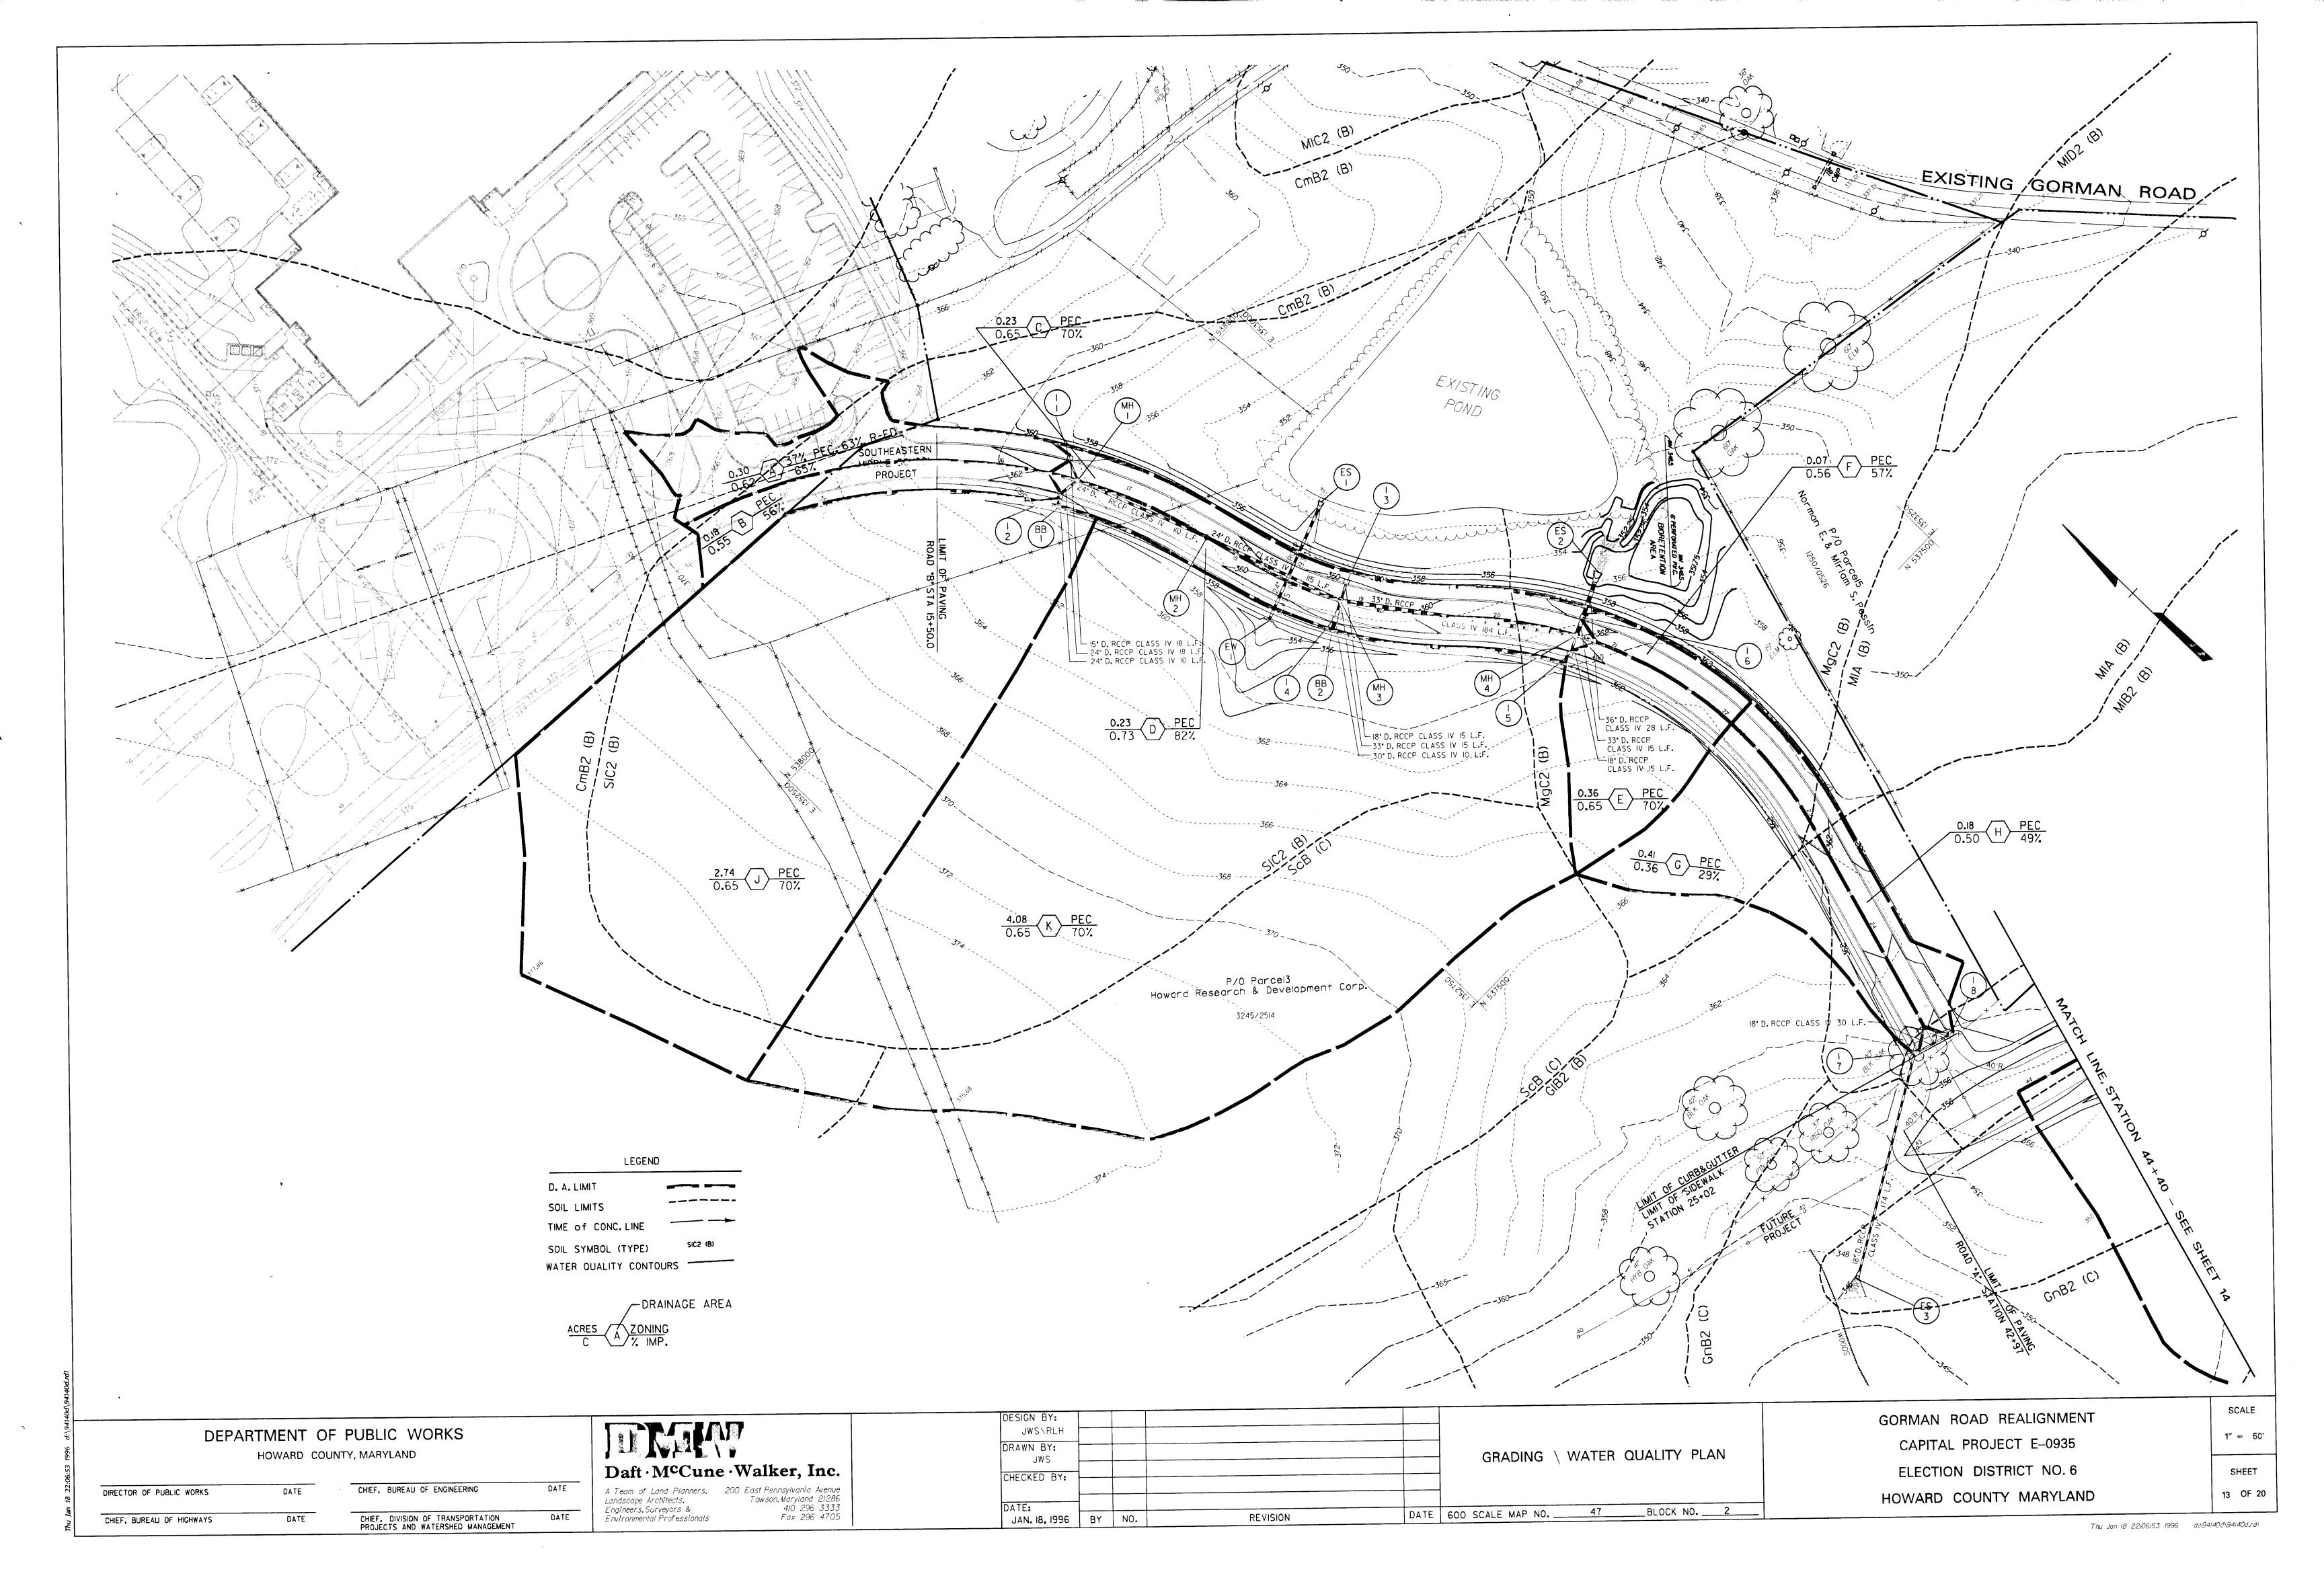


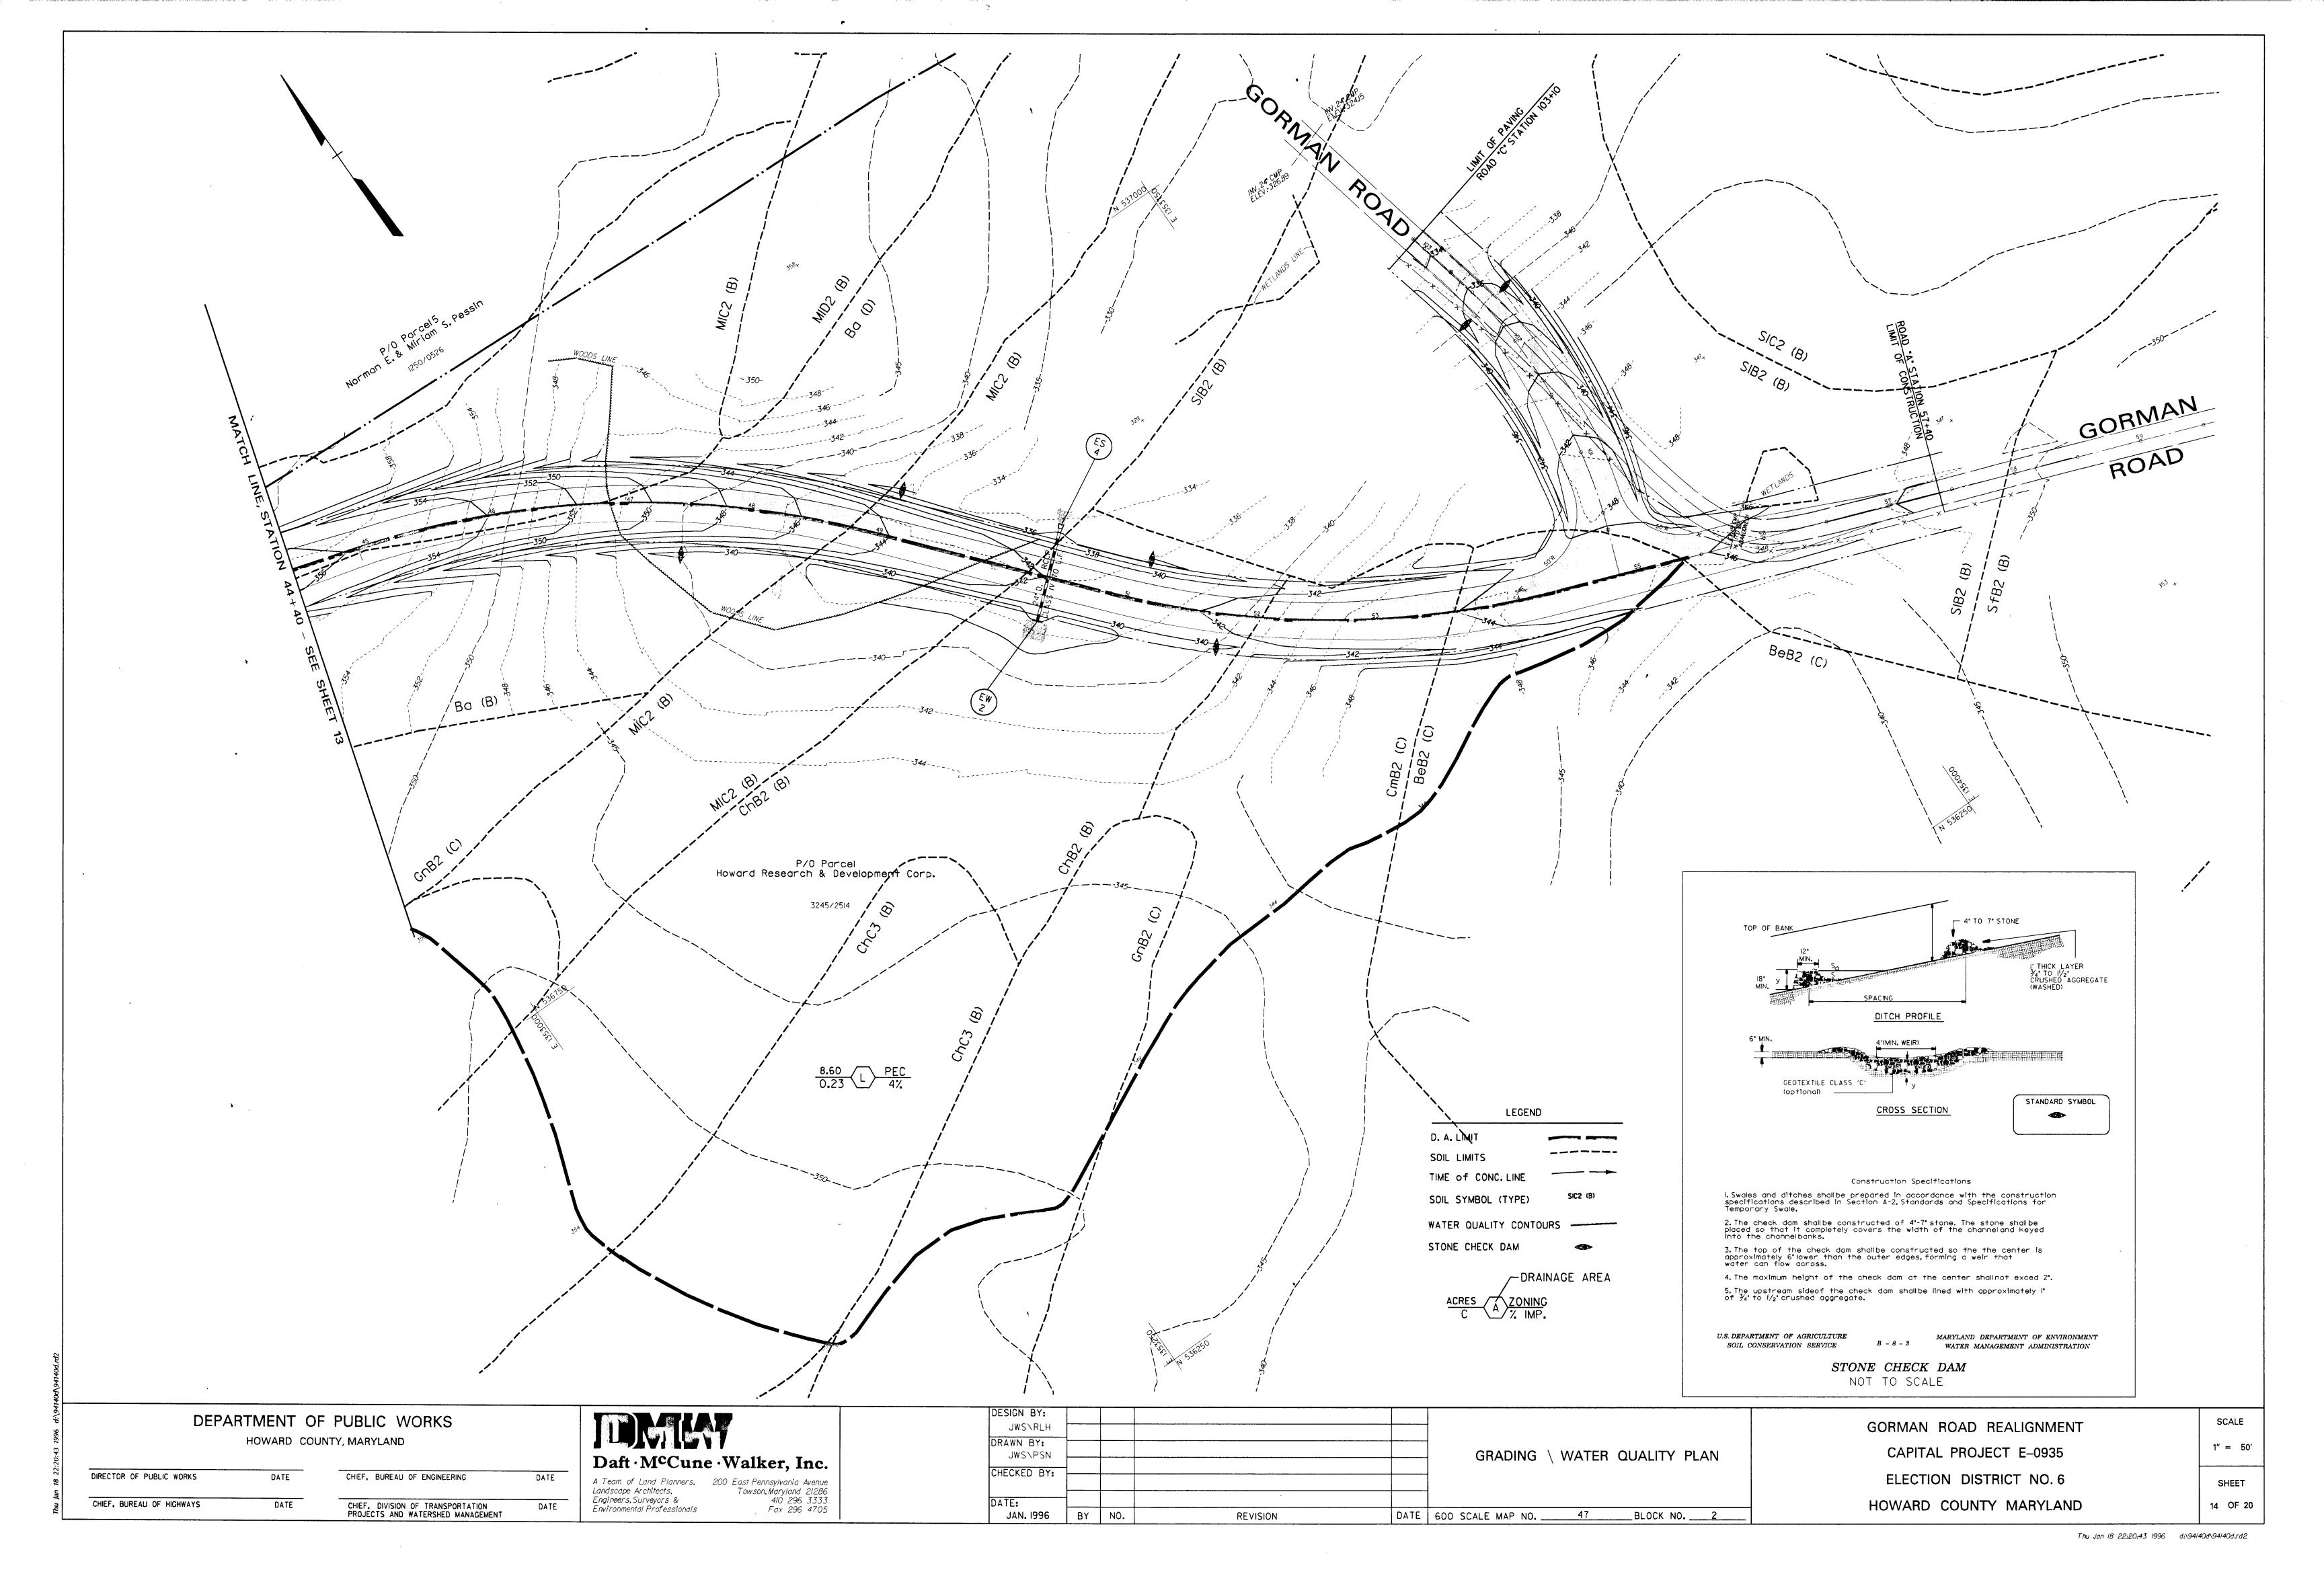


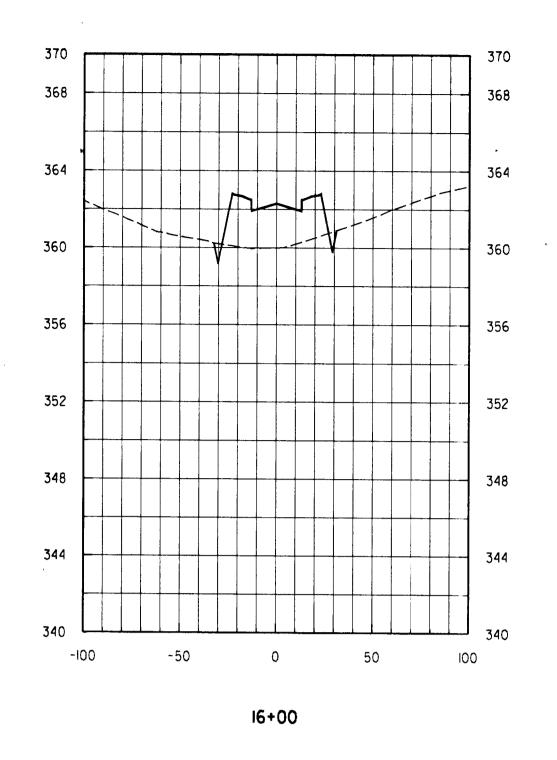


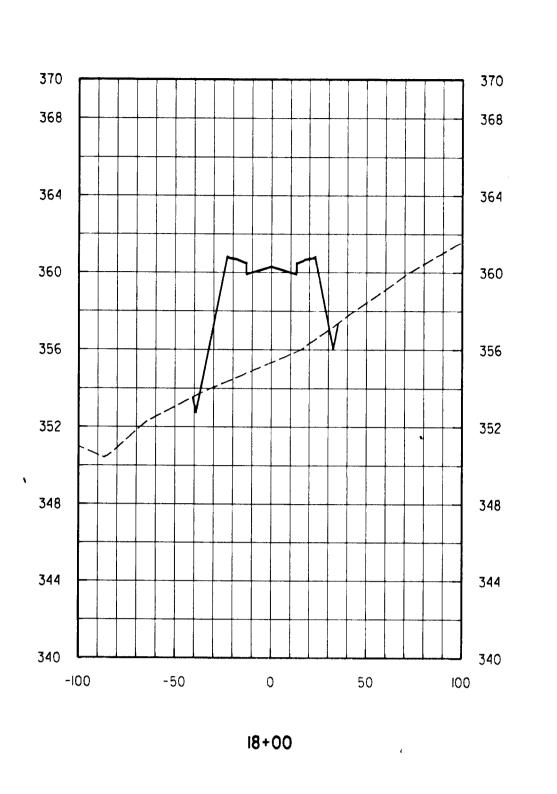


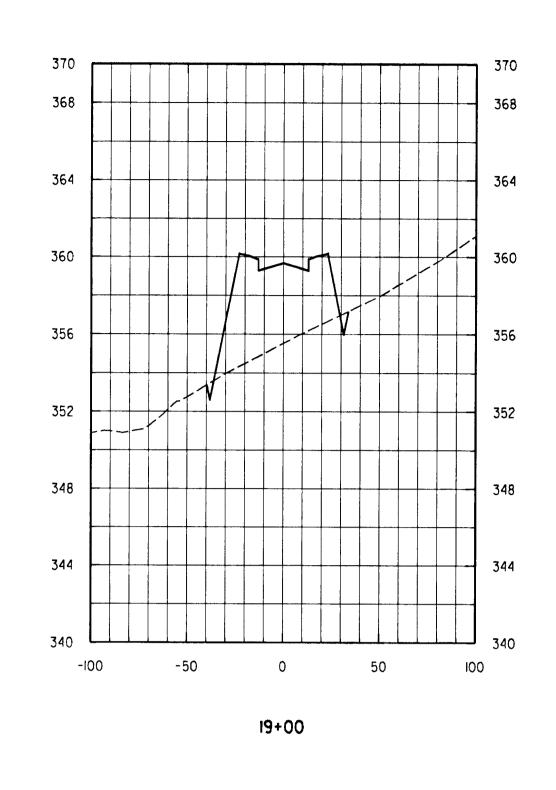


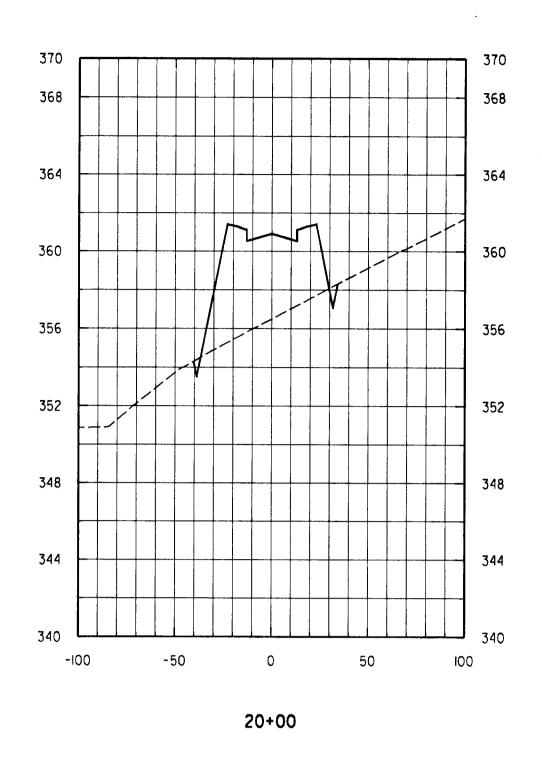


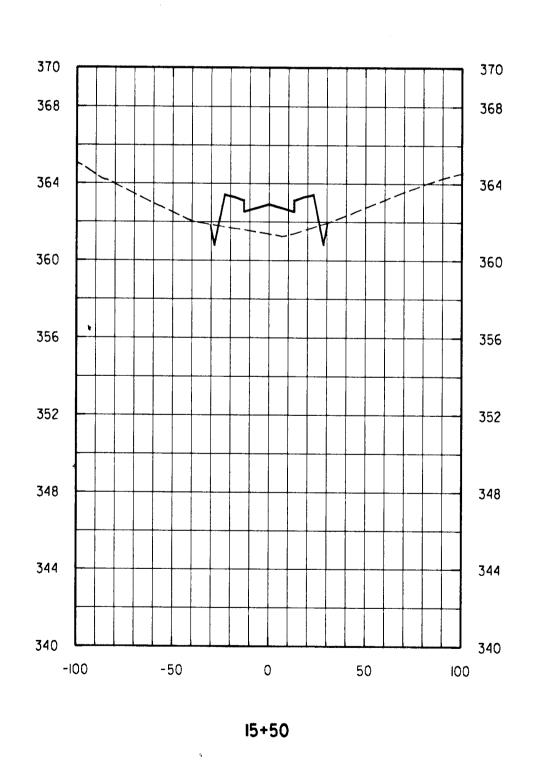


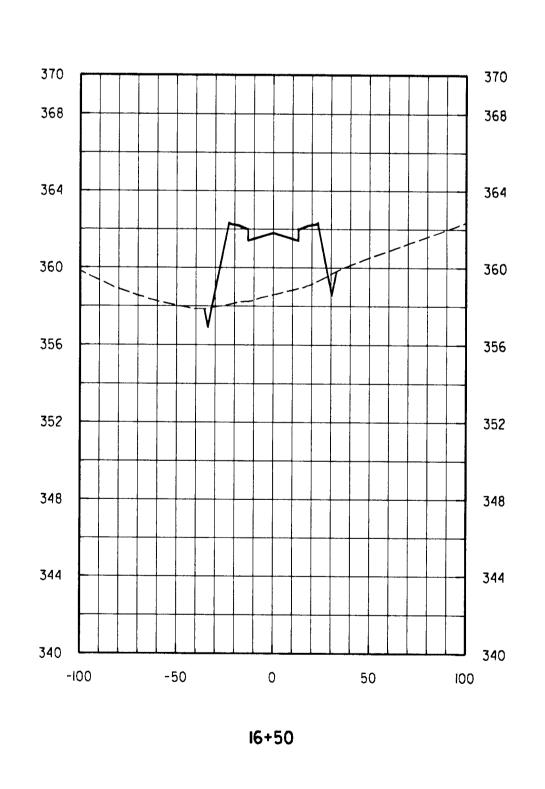

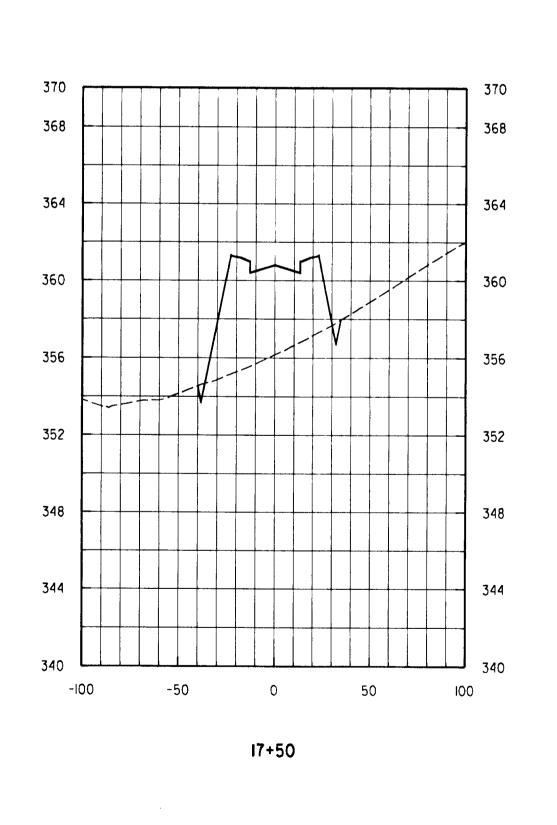


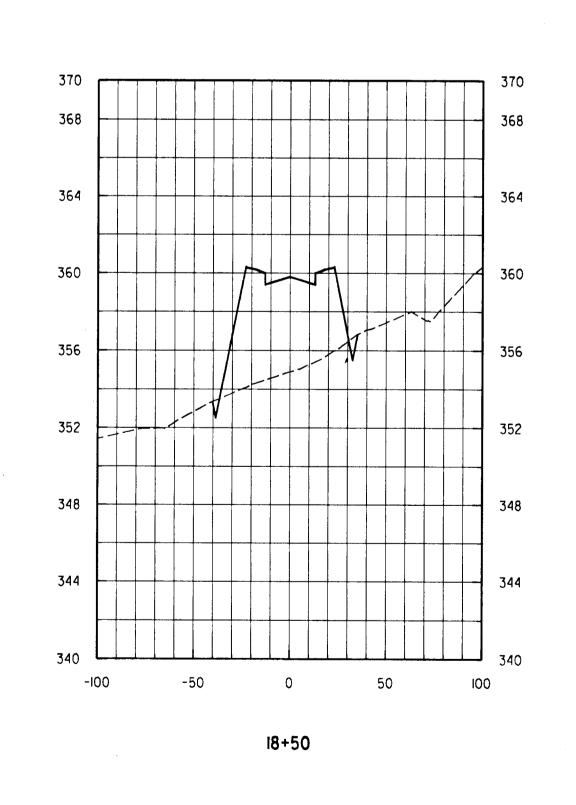

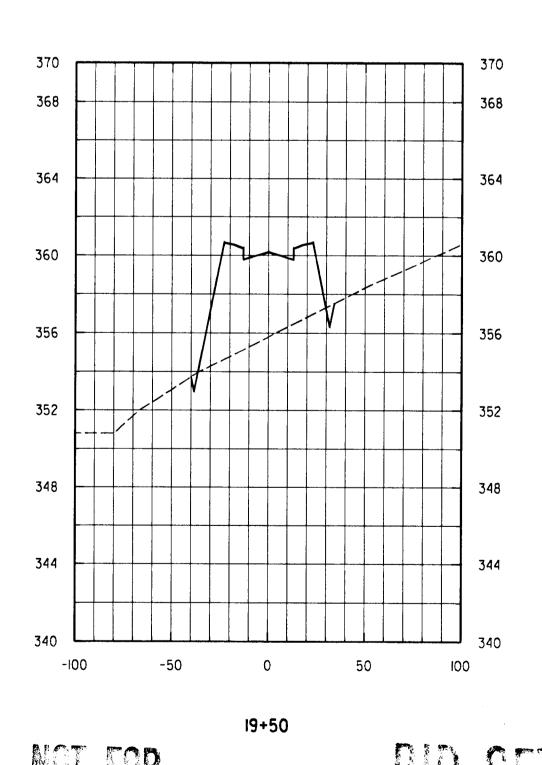

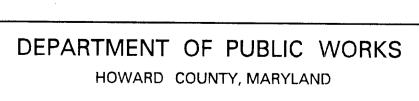

DIRECTOR OF PUBLIC WORKS	DATE	CHIEF, BUREAU OF ENGINEERING	DATE
CHIEF, BUREAU OF HIGHWAYS	DATE	CHIEF, DIVISION OF TRANSPORTATION PROJECTS AND WATERSHED MANAGEMENT	DATE

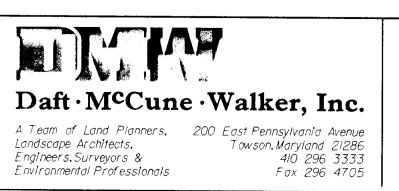

ESIGN BY:											
JWS		 									
AWN BY:				······································		<u> </u>					
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JAN. 18, 1996	BY	NO.	REVIS	SION		DATE	600 SCALE	MAP NO.	47	BLOCK NO	2


PENDING	COUN	ITY APPROVAL
GORMAN	ROAD	REALIGNMENT


GORMAN ROAD REALIGNMENT
CAPITAL PROJECT E-0935
ELECTION DISTRICT NO. 6
HOWARD COUNTY MARYLAND

SCALE
VERT 1"=5'
HOR 1"=50'
SHEET

15 OF 20

1/18/26

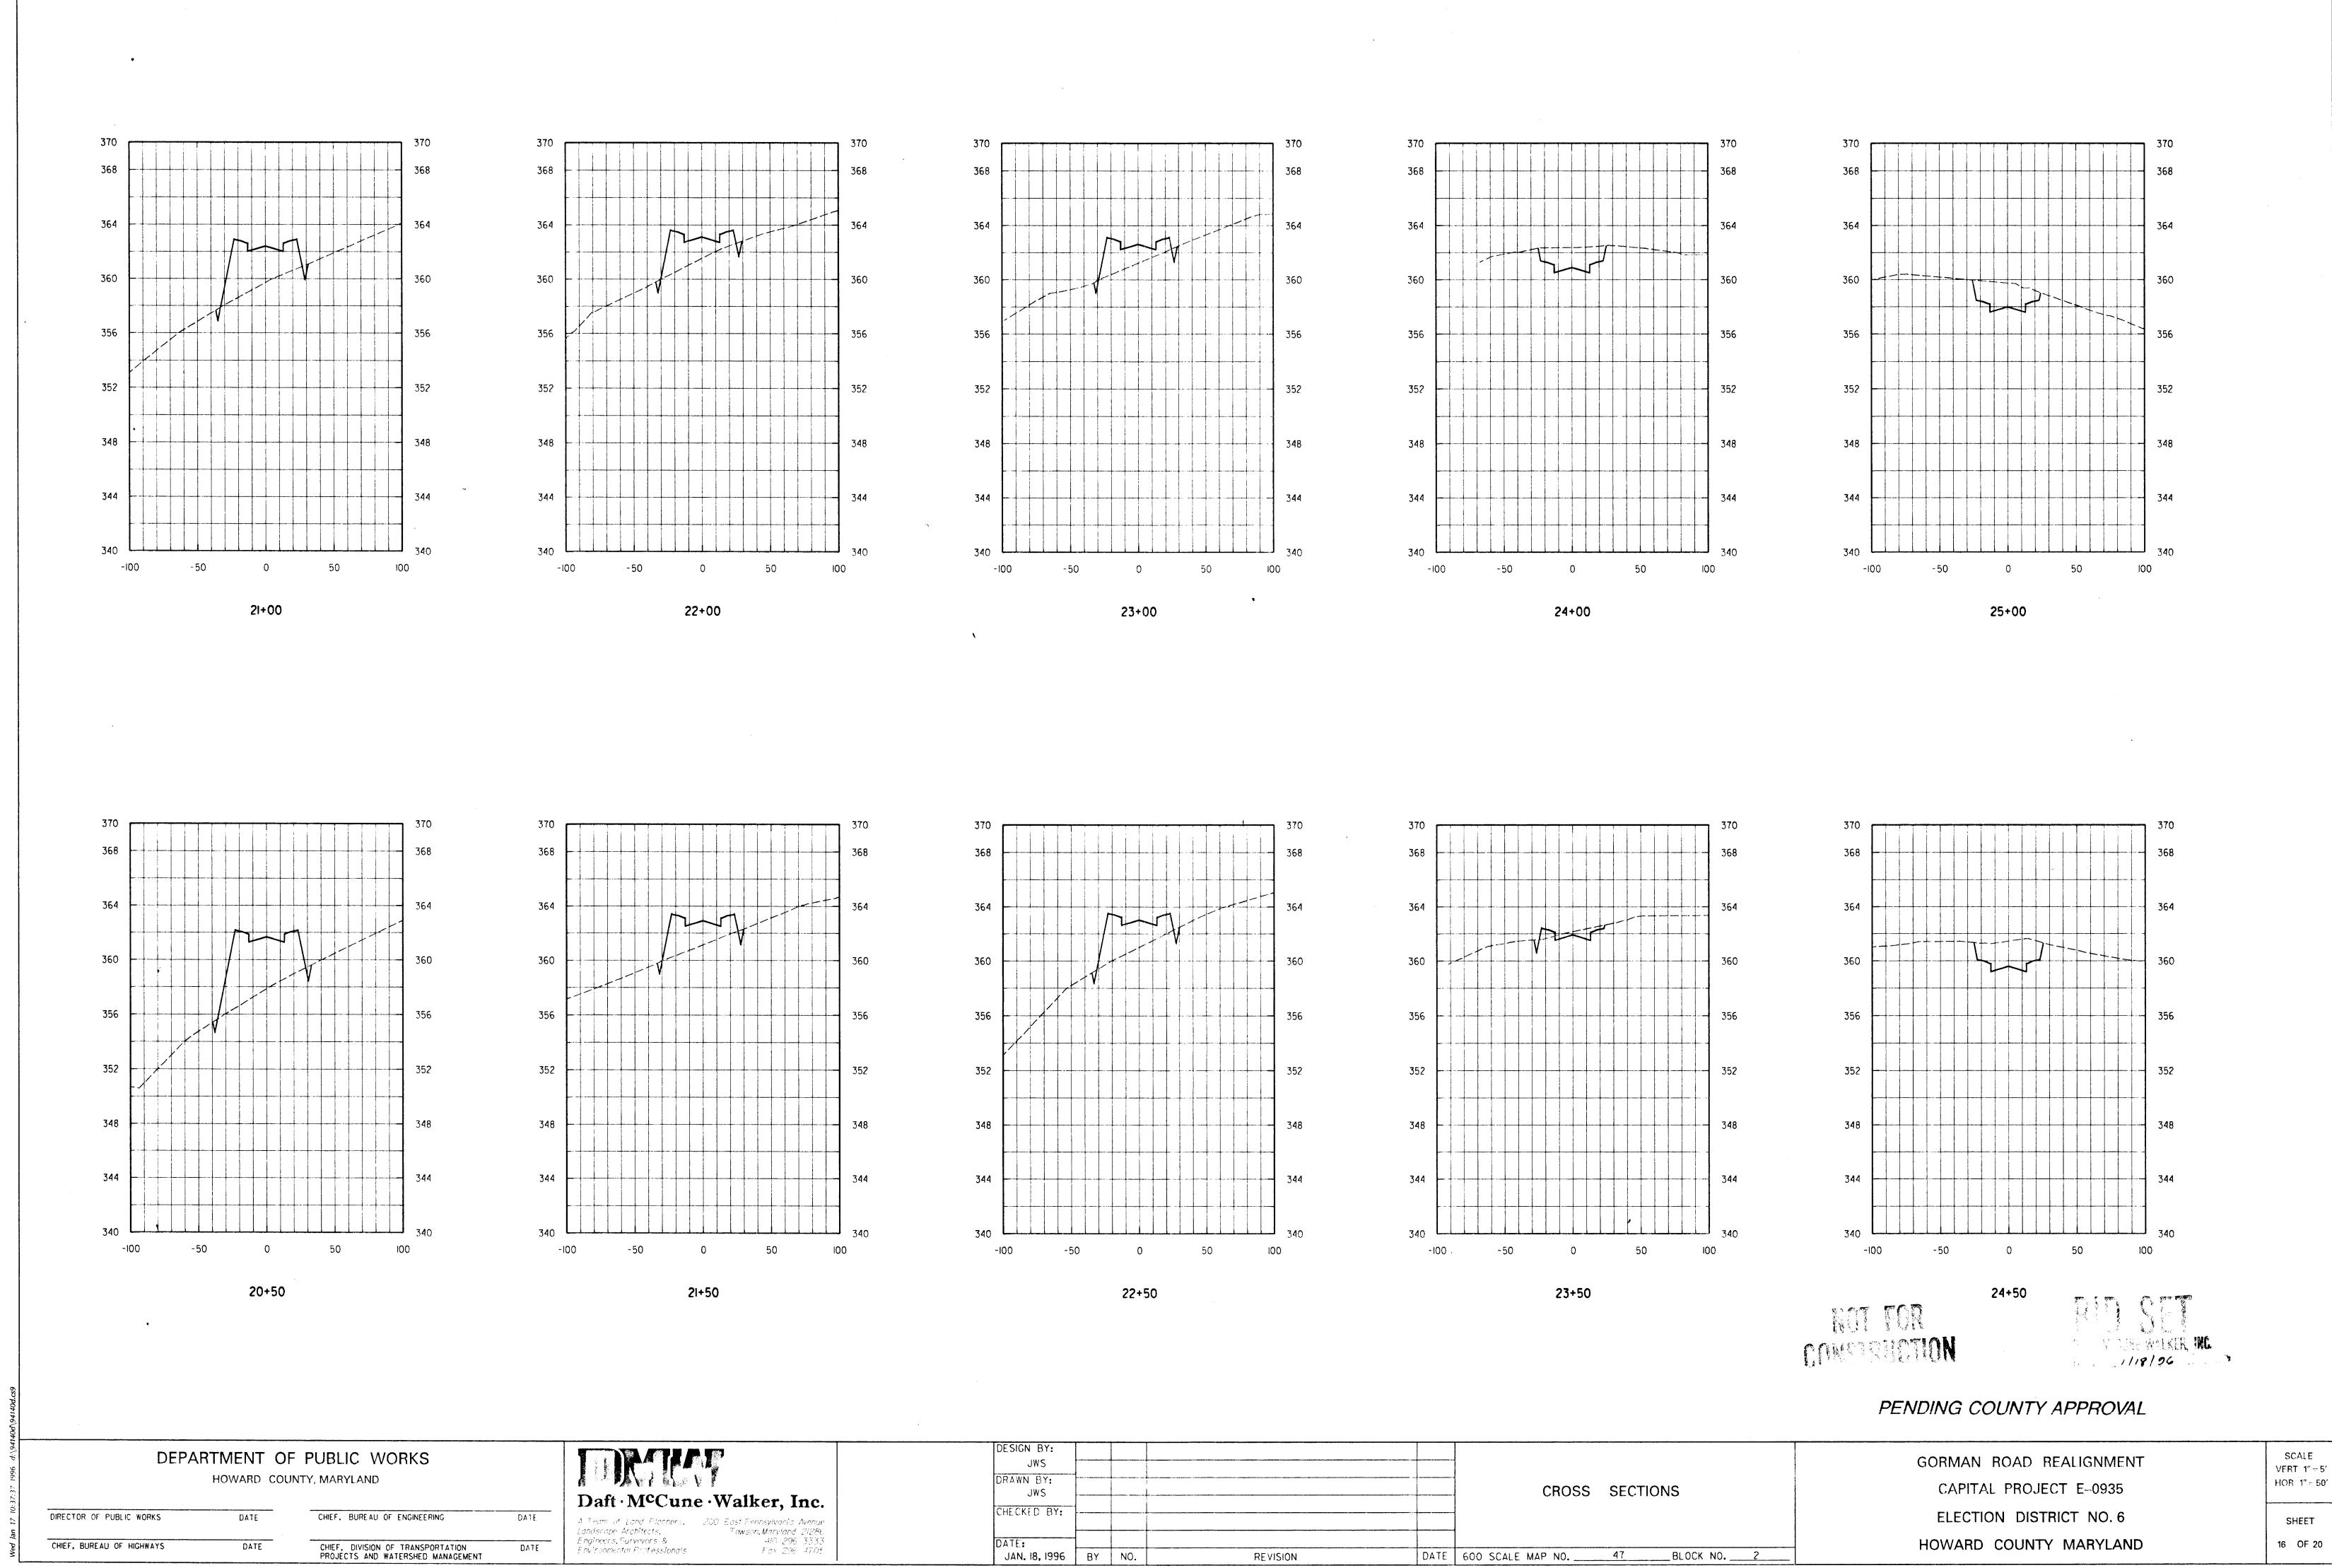

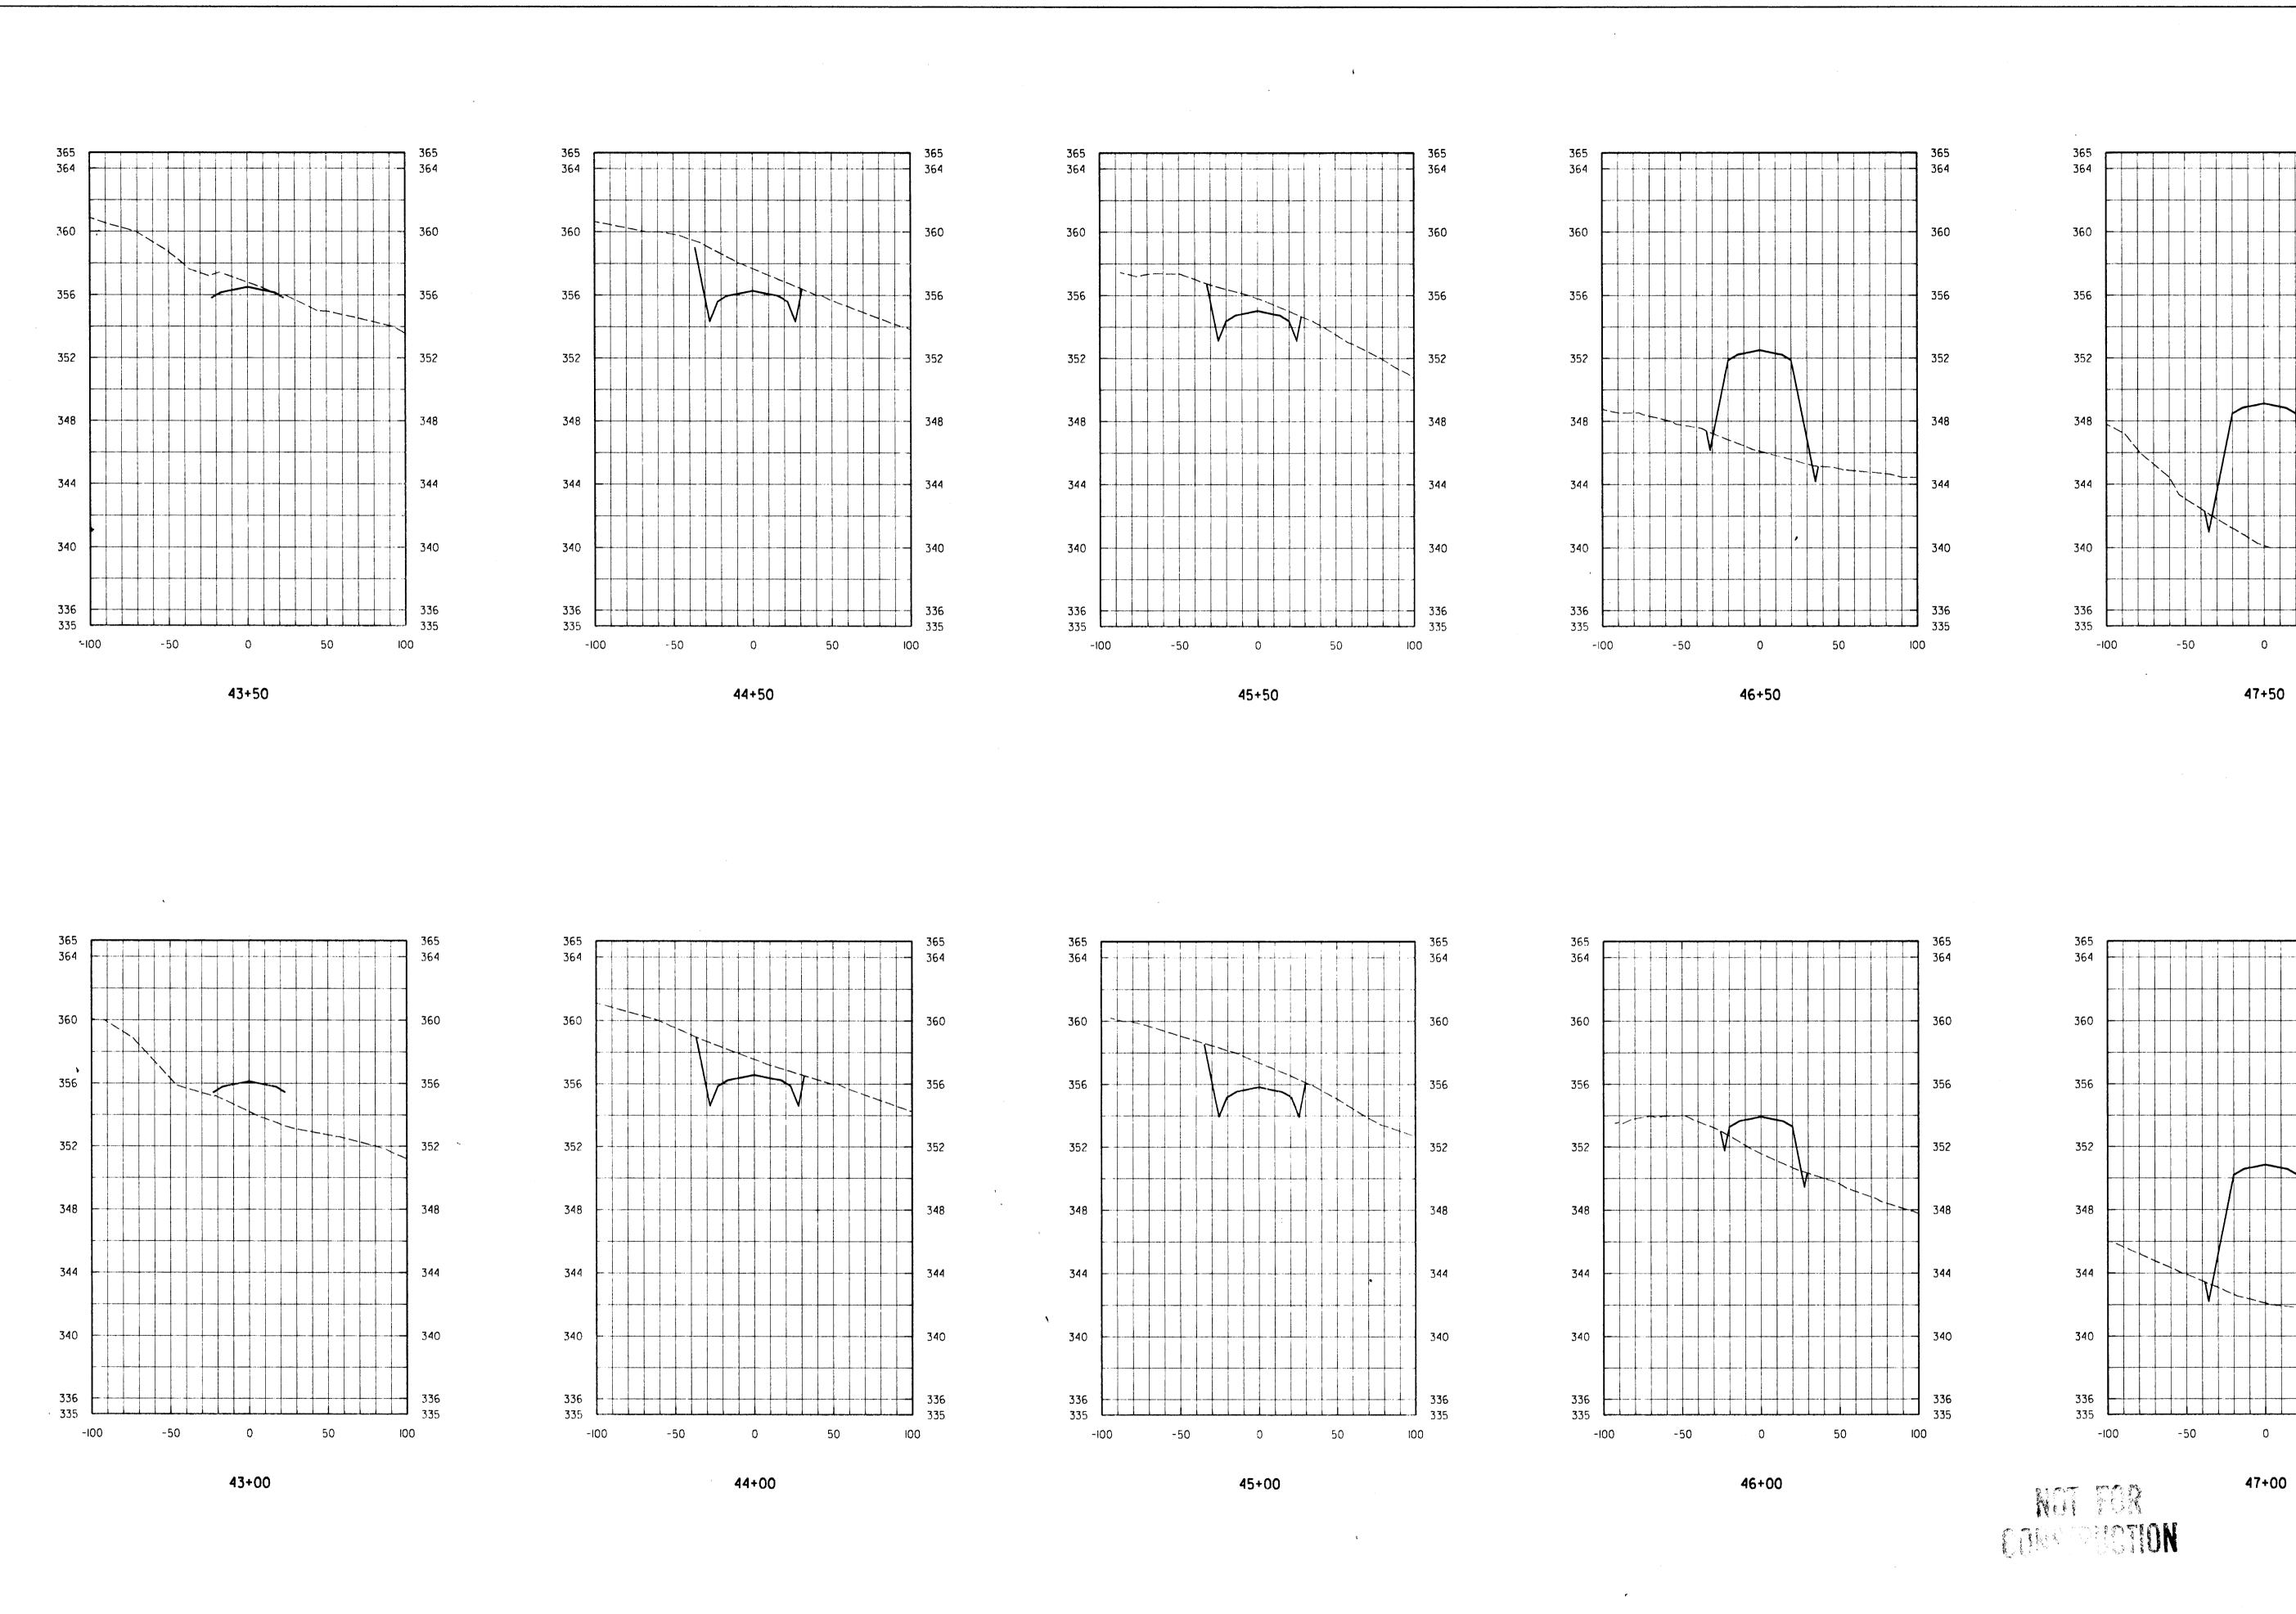

í	DEPARTMENT	OF PUBLI	C WORKS
	HOWARD	COUNTY, MARY	/LAND
DIRECTOR OF PUBLIC WOR	KS DATE	CHIEF,	BUREAU OF ENGINEERING

CHIEF, BUREAU OF HIGHWAYS

CHIEF, DIVISION OF TRANSPORTATION PROJECTS AND WATERSHED MANAGEMENT

	1
Daft McCun	e ·Walker, Inc.
Mart Wi Cull	e waikel, Ille
A Team of Land Planners, Landsnape Architects, Engineers.Surveyers &	200 Eost Pennsylvania Avenue Towson,Maryland 21286 410-296-333

DESIGN BY:									
JWS									
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JAN. 18, 1996	BY	NO.	RE VISION	DATE	600 SCALE MAP NO.	47	BLOCK NO.		<u></u>


GORMAN ROAD REALIGNMENT
CAPITAL PROJECT E-0935
ELECTION DISTRICT NO. 6
HOWARD COUNTY MARYLAND


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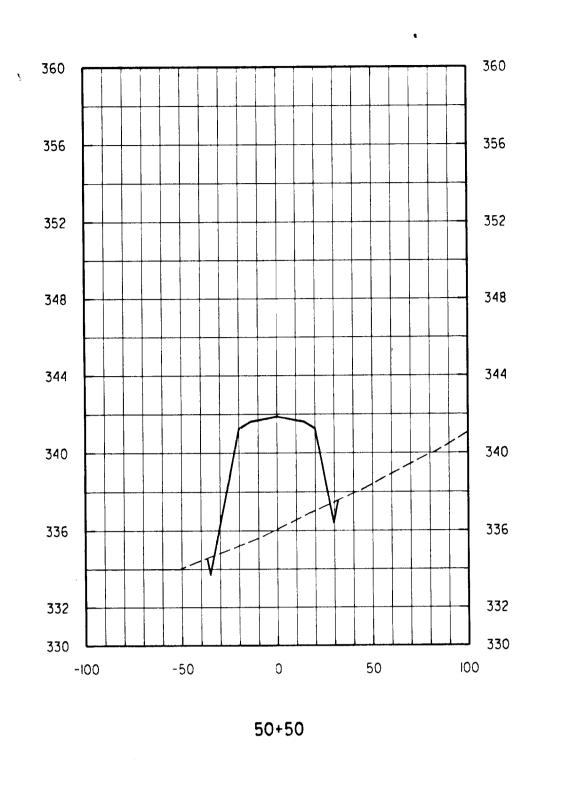
SCALE
VERT 1" = 5'
HOR 1" = 50'


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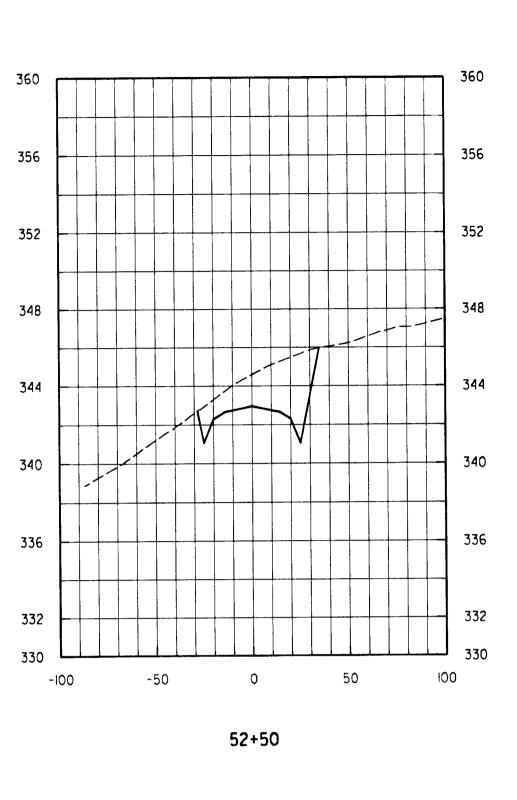
17 OF 20







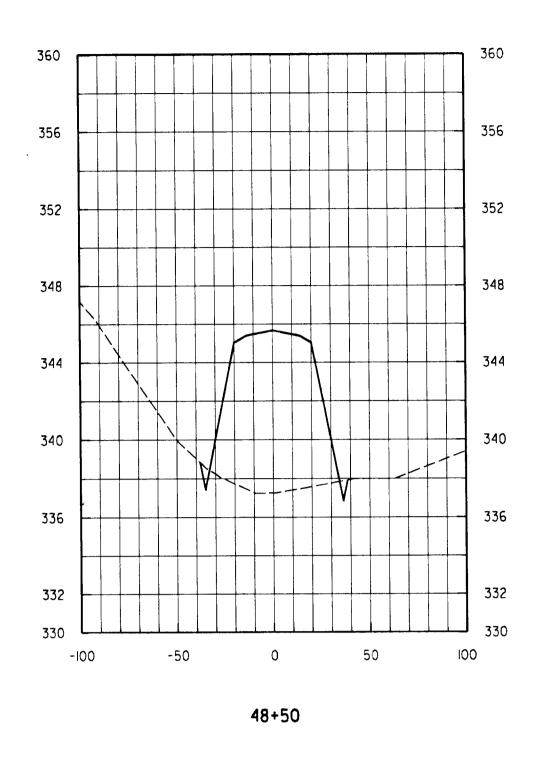


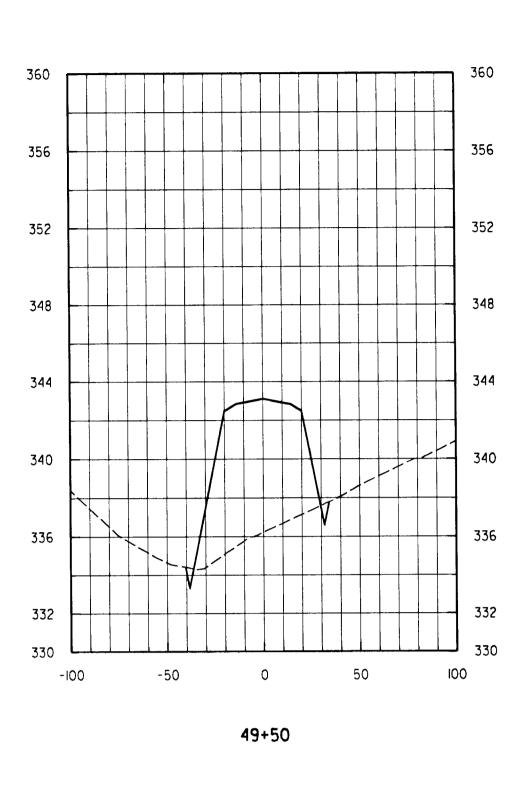


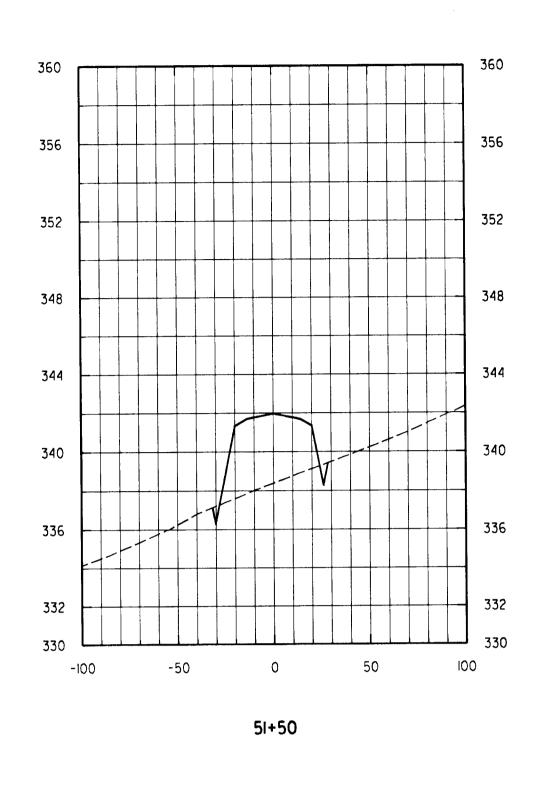

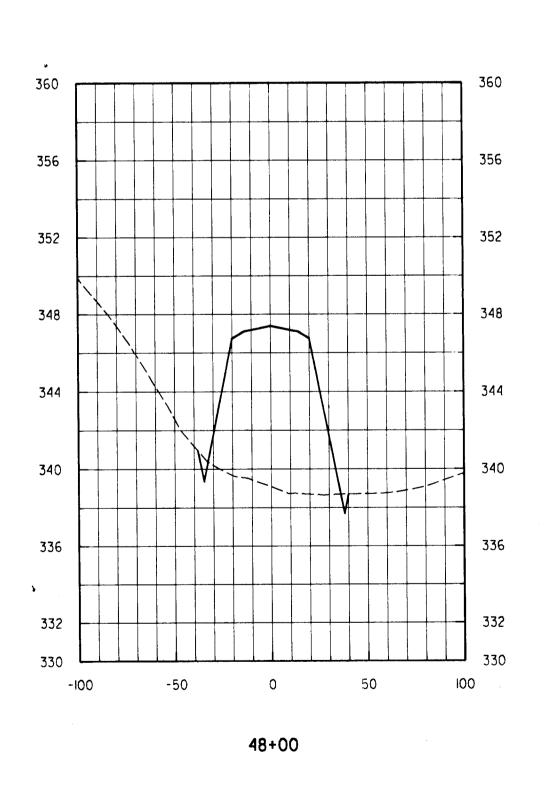


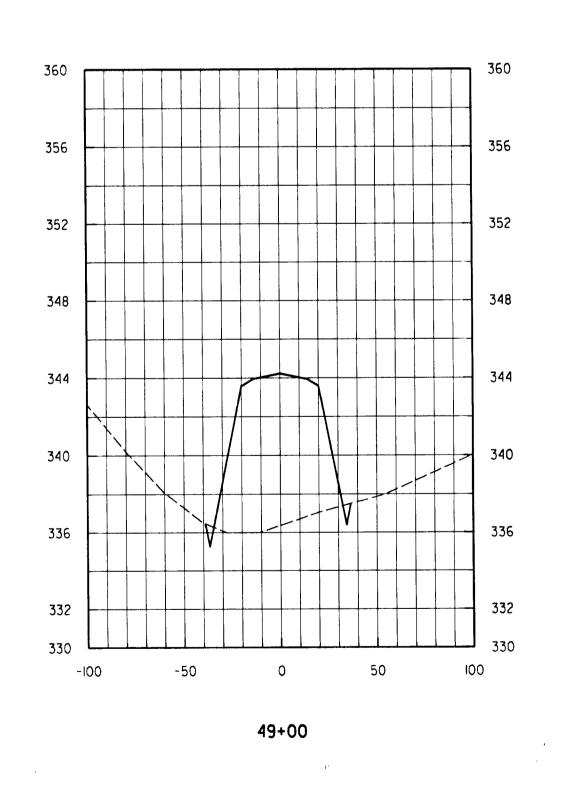

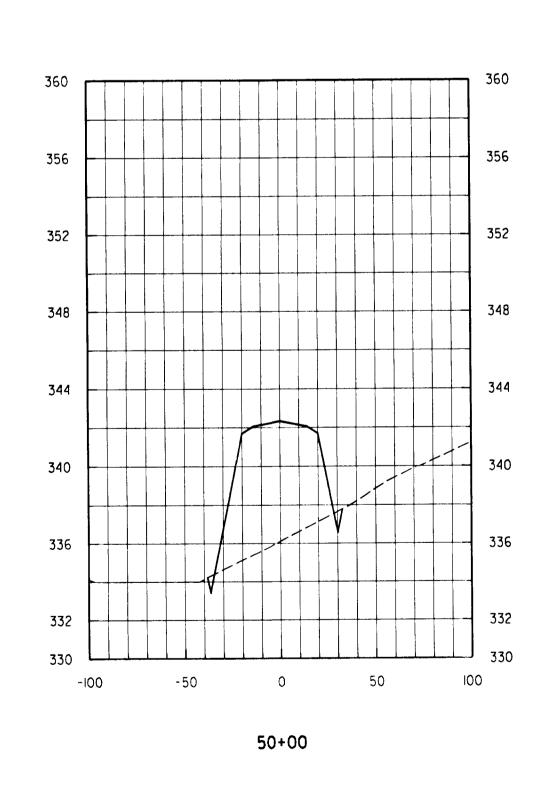

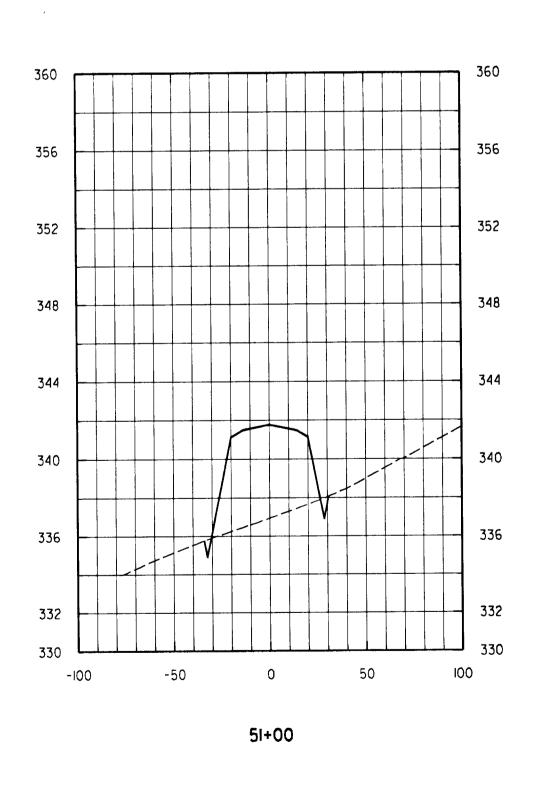

600 SCALE MAP NO.

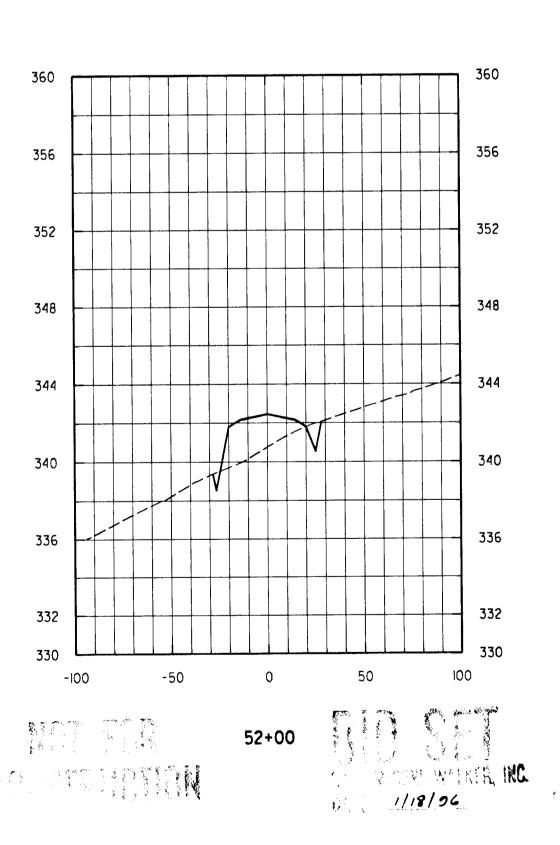

PENDING COUNTY APPROVAL

DEPARTMENT	OF	PUBLIC	WORKS
HOWARD	COUN	TY, MARYLAI	ND

DIRECTOR OF PUBLIC WORKS DATE CHIEF, BUREAU OF HIGHWAYS

CHIEF, BUREAU OF ENGINEERING CHIEF, DIVISION OF TRANSPORTATION DATE PROJECTS AND WATERSHED MANAGEMENT

Daft·McCune·Walker, Inc. A Team of Land Planners, 200 East Pennsylvania Avenue Landscape Architects, Towson, Maryland 21286 Engineers, Surveyors & 410 296 3333 Environmental Professionals Fax 296 4705

DESIGN BY:				
JWS				
CHECKED BY:				
DATE: JAN. 18, 1996	BY	NO.	REVISION	DATE
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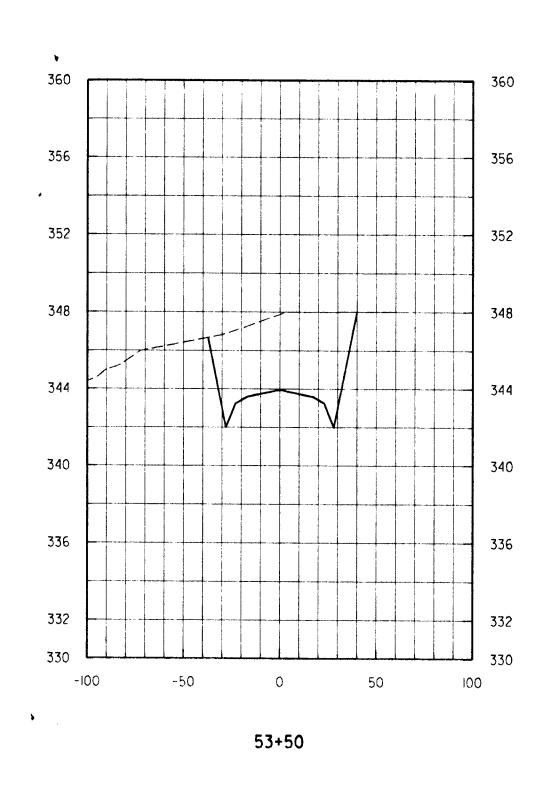
CROSS SECTIONS HOWARD COUNTY MARYLAND _BLOCK NO. ____2_


GORMAN ROAD REALIGNMENT CAPITAL PROJECT E-0935 ELECTION DISTRICT NO. 6


VERT 1" = 5' HOR 1'' = 50'SHEET


18 OF 20


SCALE




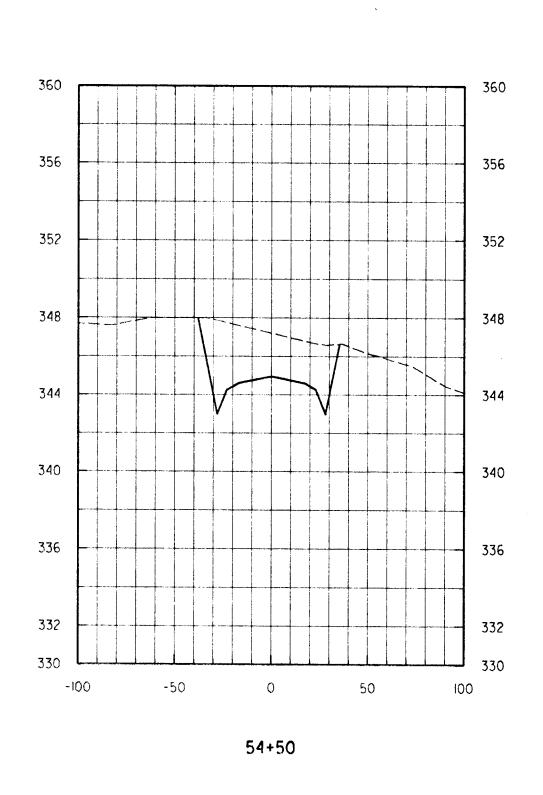


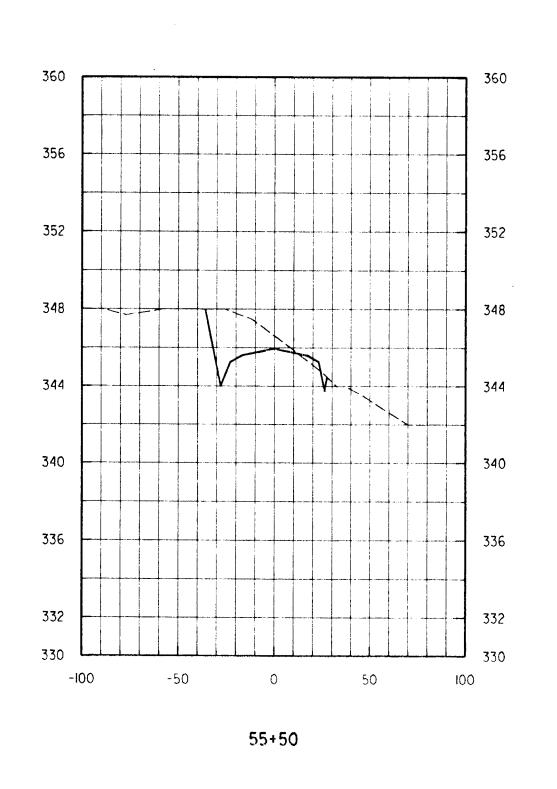


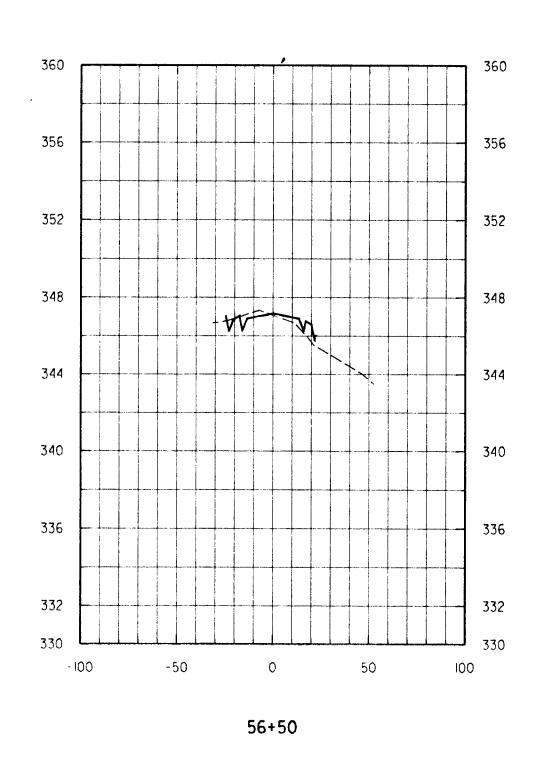


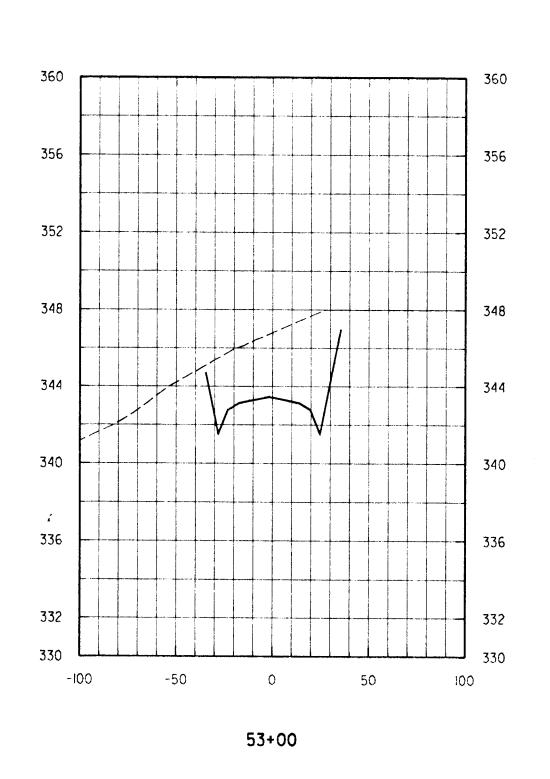

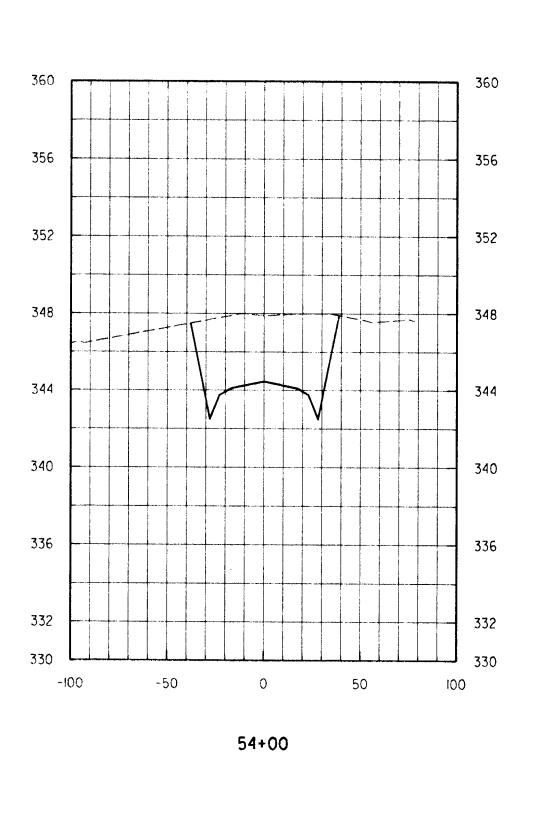

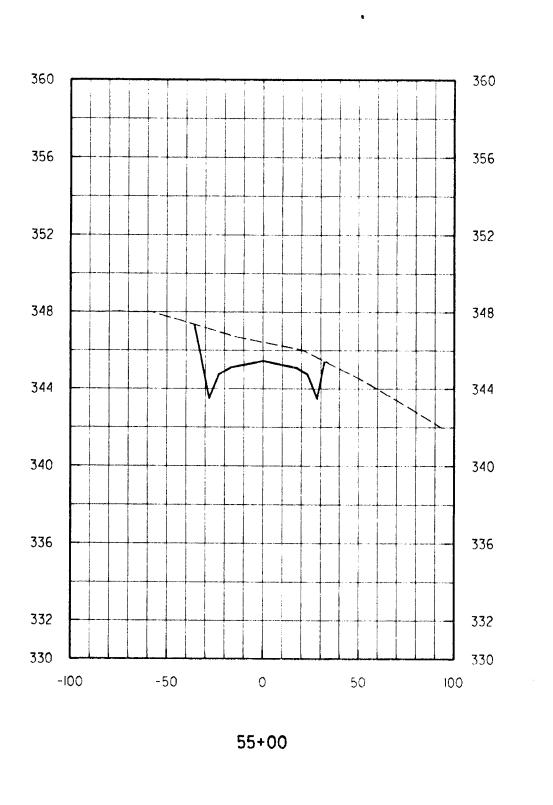

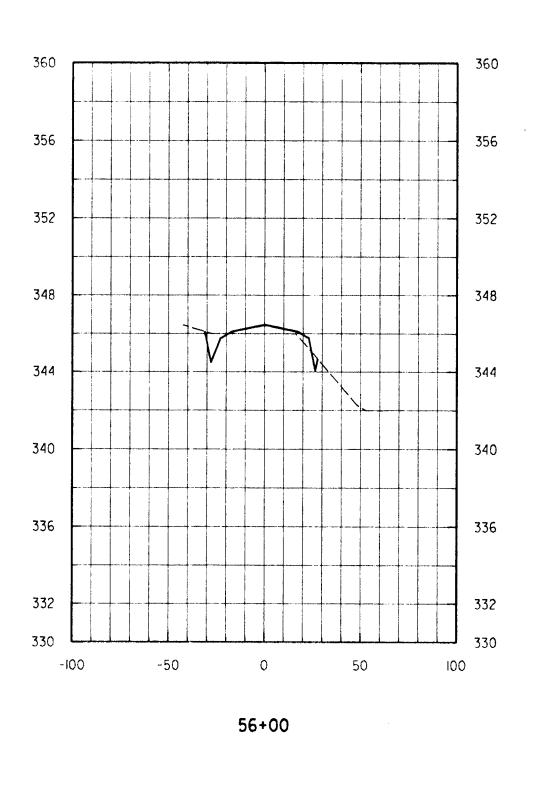

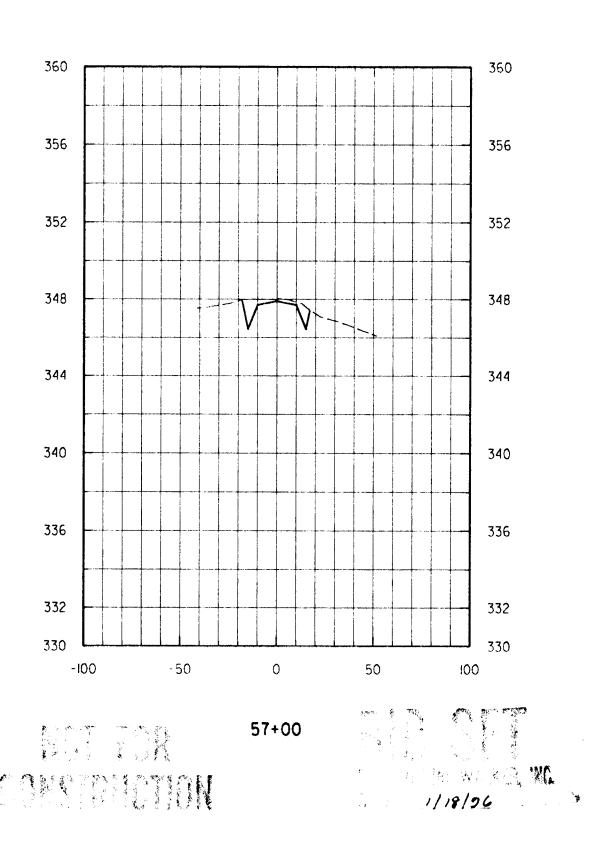

DEPARTMENT OF PUBLIC WORKS HOWARD COUNTY, MARYLAND

CHIEF, BUREAU OF HIGHWAYS

DATE

DATE

CHIEF, BUREAU OF ENGINEERING DATE

CHIEF, DIVISION OF TRANSPORTATION DATE
PROJECTS AND WATERSHED MANAGEMENT

Daft · McCune · Walker, Inc.

A learn of Land Planners, 200 East Pennsylvania Avenue Landscare Architects. Towson, Maryland 21286 Engineers, Surveyors & 410, 296, 3333 Environmental Professionals Fax 296, 4705

DESIGN BY:			
JWS		<u> </u>	
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JAN. 18, 1996	BY	NO.	REVISION

CROSS SECTIONS

DATE 600 SCALE MAP NO. 47 BLOCK NO. 2


GORMAN ROAD REALIGNMENT
CAPITAL PROJECT E-0935
ELECTION DISTRICT NO. 6
HOWARD COUNTY MARYLAND


PENDING COUNTY APPROVAL


SCALE VERT 1" - 5' HOR 1" = 50'


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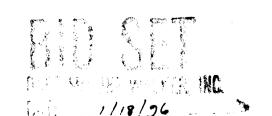
19 OF 20



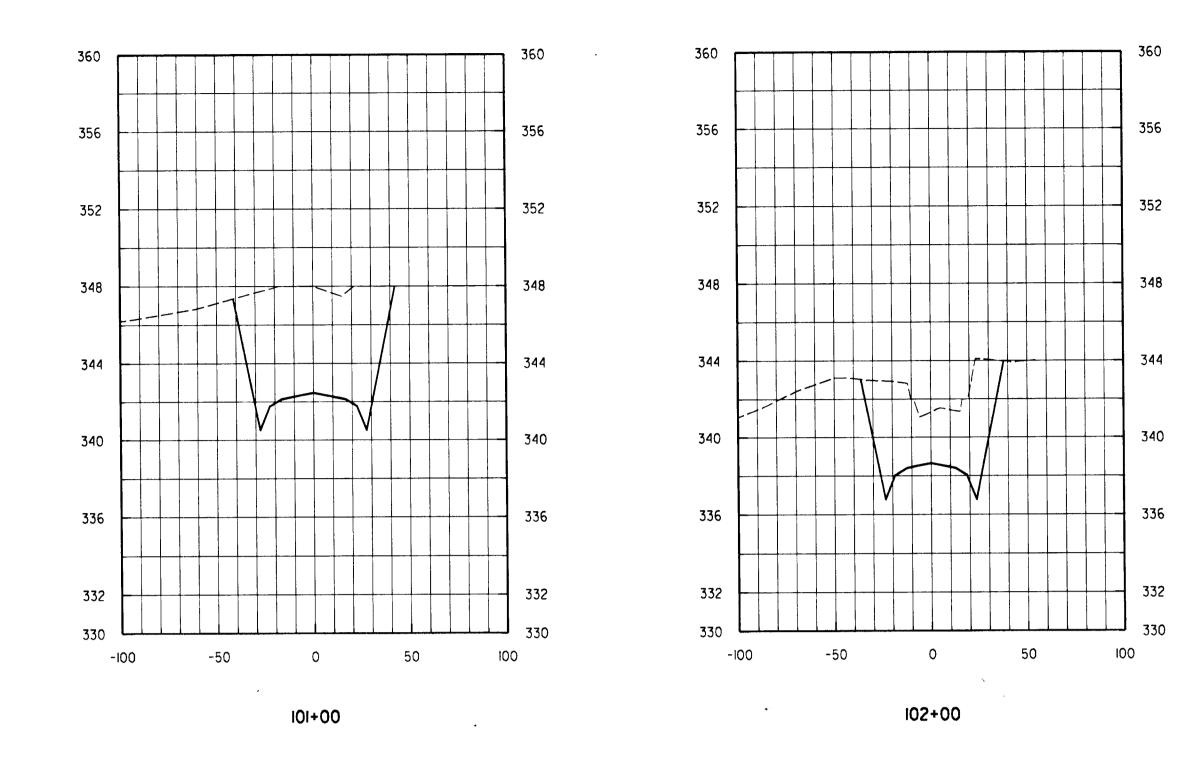

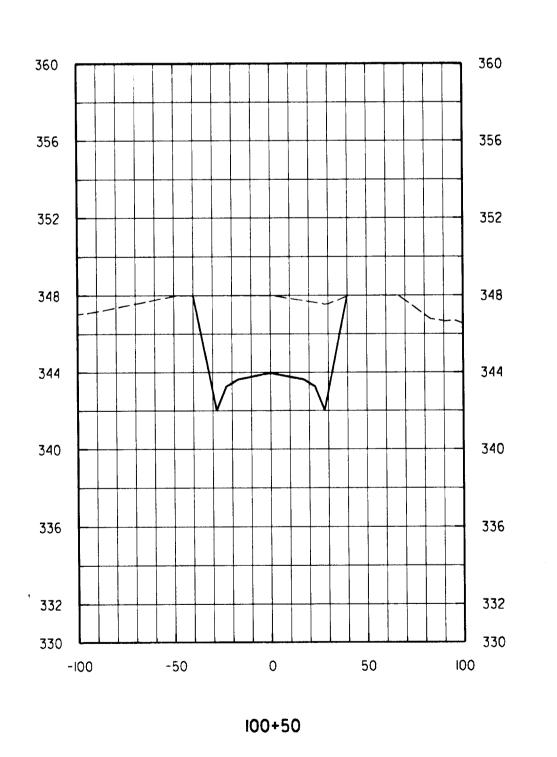

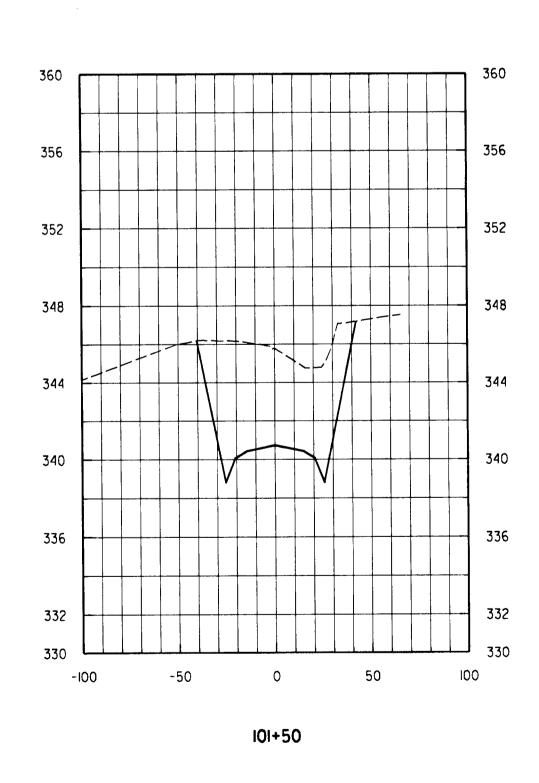

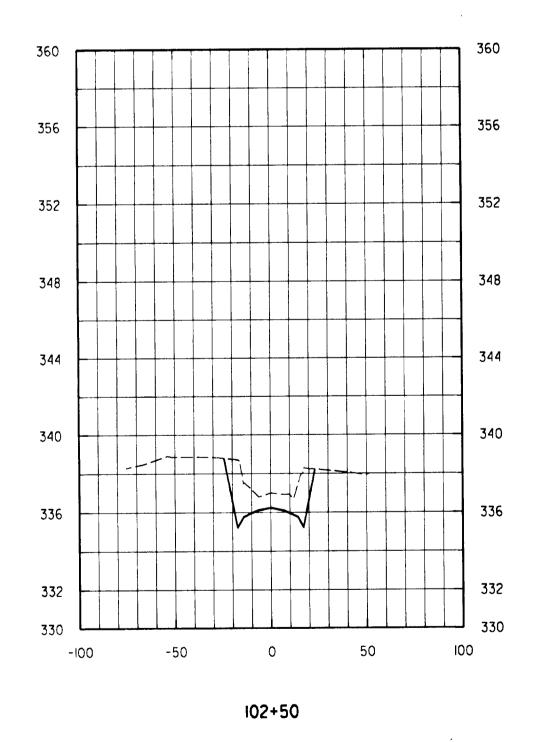

DEPARTMENT	OF	PUBLIC	WORKS	
HOWARD	COUNTY, MARYLAND			

CHIEF, BUREAU OF HIGHWAYS

DATE CHIEF, BURE

CHIEF, BUREAU OF ENGINEERING DATE

CHIEF, DIVISION OF TRANSPORTATION DATE
PROJECTS AND WATERSHED MANAGEMENT

Daft · McCune	e·Walker, Inc.
A Team of Land Planners,	200 East Pennsylvania Avenue
Landscape Architects,	Towson, Maryland 21286
Engineers, Surveyors &	410 296 3333
Environmental Professionals	Fax 296 4705

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AN. 18, 1996	BY	NO.	REVISION	DATE	600 SCALE MAP NO 47 BLOCK NO 2

GORMAN ROAD REALIGNMENT
CAPITAL PROJECT E-0935
ELECTION DISTRICT NO. 6
HOWARD COUNTY MARYLAND

VERT 1" = 5'
HOR 1" = 50'

SHEET

20 OF 20

SCALE

Wed Jan 17 11:00:05 1996 d:\94140d\94140d.cs9